Plan I Hearn

COMMERCIAL AND MAPLE STREET MIXED USE DEVELOPMENT

321 COMMERCIAL STREET PORTLAND, MAINE

PREPARED BY:



CONSTRUCTION CORPORATION

11 CORPORATE DRIVE, BELMONT NH 03220 PHONE (603) 527-9090 FAX (603) 527-9191

OCTOBER 22, 2012


OWNER/APPLICANT:


J B BROWN & SONS P.O. BOX 207 PORTLAND, ME 04112


AGENT:

OPECHEE CONSTRUCTION CORPORATION 11 CORPORATE DRIVE BELMONT, NH 03220

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GENERAL NOTES

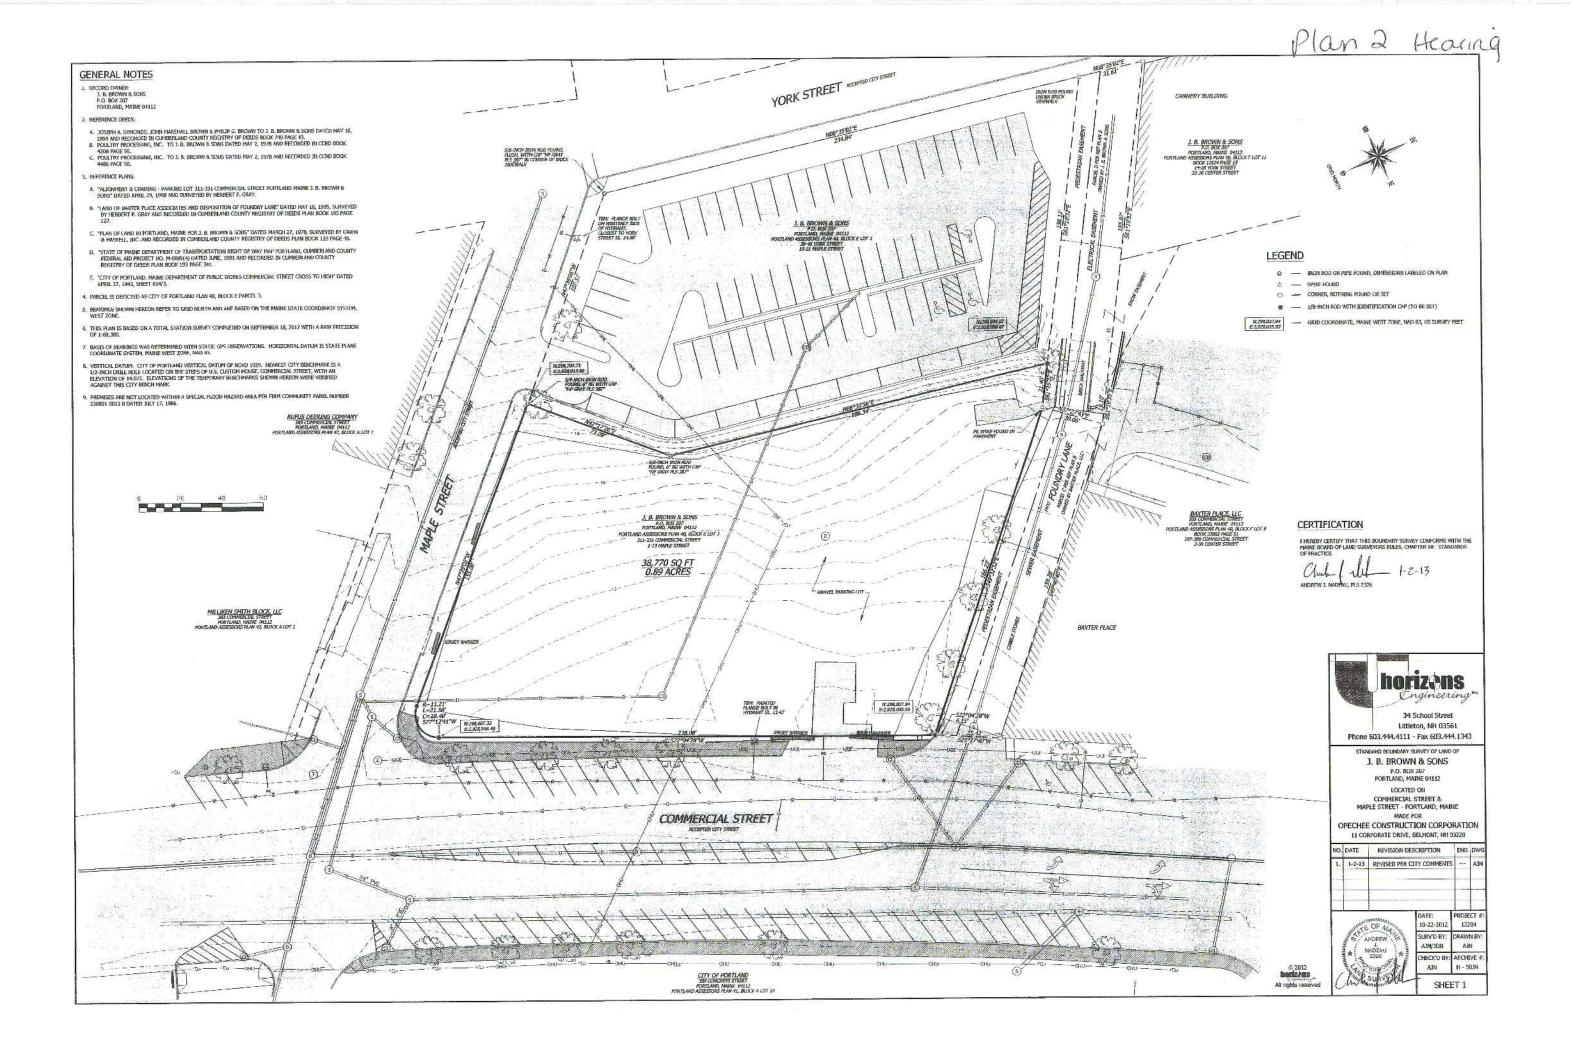
- 2. THE PROPERTY IS SHOWN AS LOT 3 OF BLOCK E ON THE CITY OF PORTLAND TAX MAP 40
- 4. LAND BOUNDARY AND TOPOGRAPHIC INFORMATION SHOWN HEREON IS BASED UPON AN ON-THE-GROUND SURVEY TILED "STANDARD BOUNDARY SURVEY OF LAND OF J. B. BROWN & SONS" BY HORIZONS ENGINEERING, INC. DATED COTOBER 22, 2015.
- 5. THE PROPERTY IS LOCATED WITHIN THE CITY OF PORTLAND 855 URBAN COMMERCIAL MIXED USE DISTRICT.
- 6. REFERENCE DEEDS:
 A. JOSEPH A. SYMONDS, JOHN MARSHALL BROWN & PHIUP C. BROWN TO J. B. BROWN & SONS BLATED MAY 16,
 1904 AND RECORDED IN CUMBERLAND COUNTY REGISTRY OF DEEDS BOOK 749 PAGE 43.
- 8. PCULTRY PROCESSING, INC. TO J. 8. BROWN & SONS DATED MAY 2, 1978 AND RECORDED IN CCRO BOOK 4208 PAGE 56.
- C. POULTRY PROCESSING, INC. TO J. B. BROWN & SONS DATED, MAY 2,1978. AND RECORDED IN, CORD. BOOK 4486 PAGE 50.
- VERTICAL DATUM: CITY OF PORTLAND VERTICAL DATUM OF NGVO 1929. NEAREST CITY BENCHMARK IS A 3 INCH DRILL HOLE LOCATED ON THE STEPS OF U.S. CUSTOM HOUSE. COMMERCIAL STREET, WITH AN ELEVATION OF 14CT LEVATIONS OF THE TEMPORARY BENCHMARKS SHOWN HEREOM KEEN VERTIED AGAINST TIME TO LITY BENCHMARK
- 9. PREMISES ARE NOT LOCATED WITHIN A SPECIAL FLOOD HAZARD AREA PER FIRM-COMMUNITY PANEL NUMBER 2300510013-B DATED JULY 17, 1985.

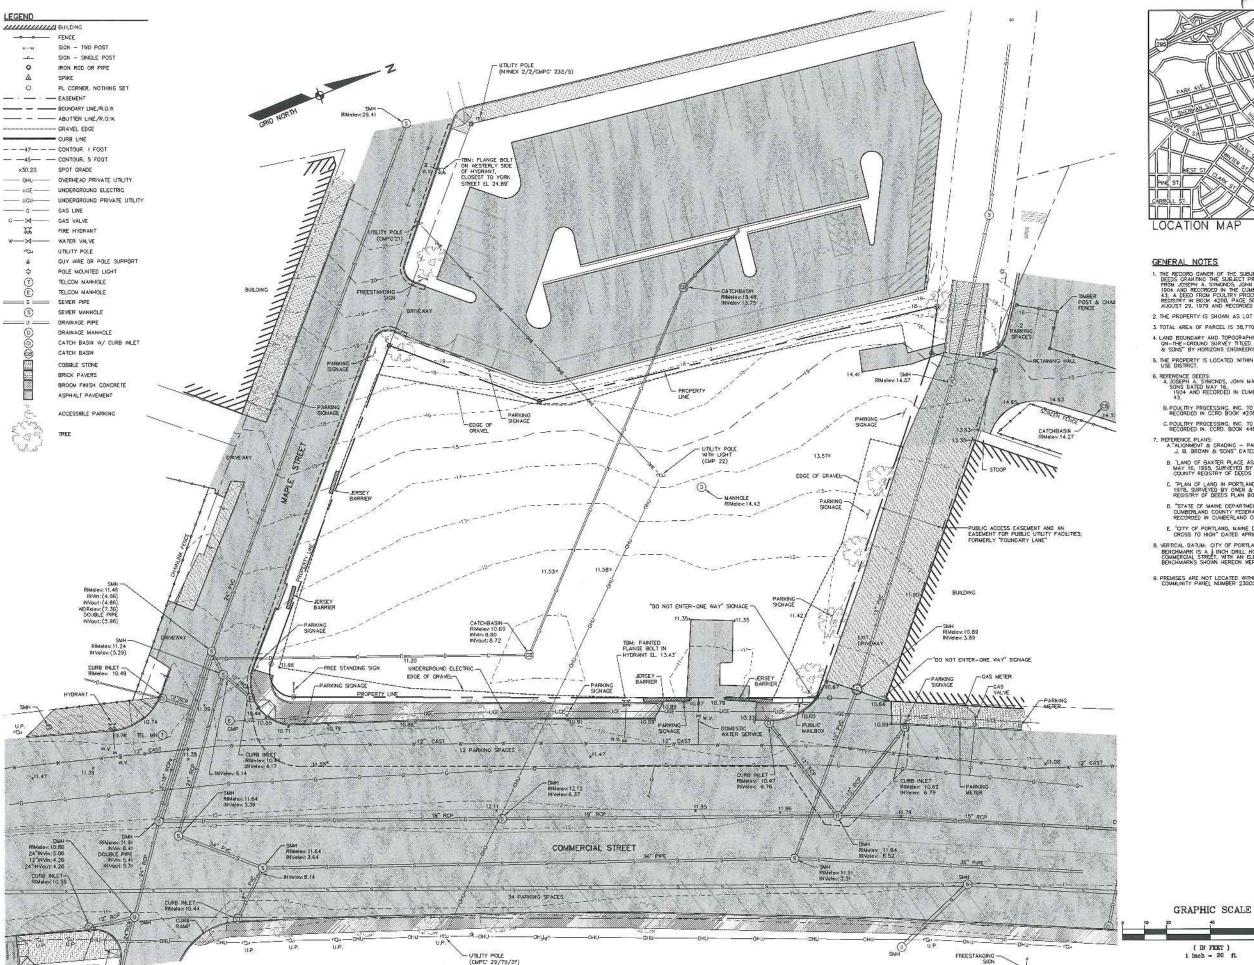

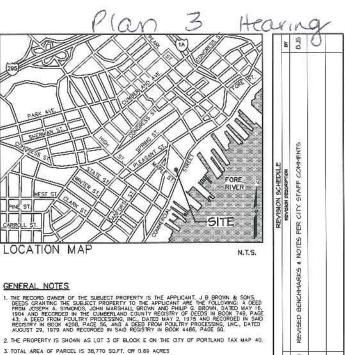EXISTING CONDITIONS

COMMERCIAL & MAPLE STREET MIXED USE DEVELOPMENT

DATE: 10-22-12 SCALE: 1'=20' DRAWN BY: BJS

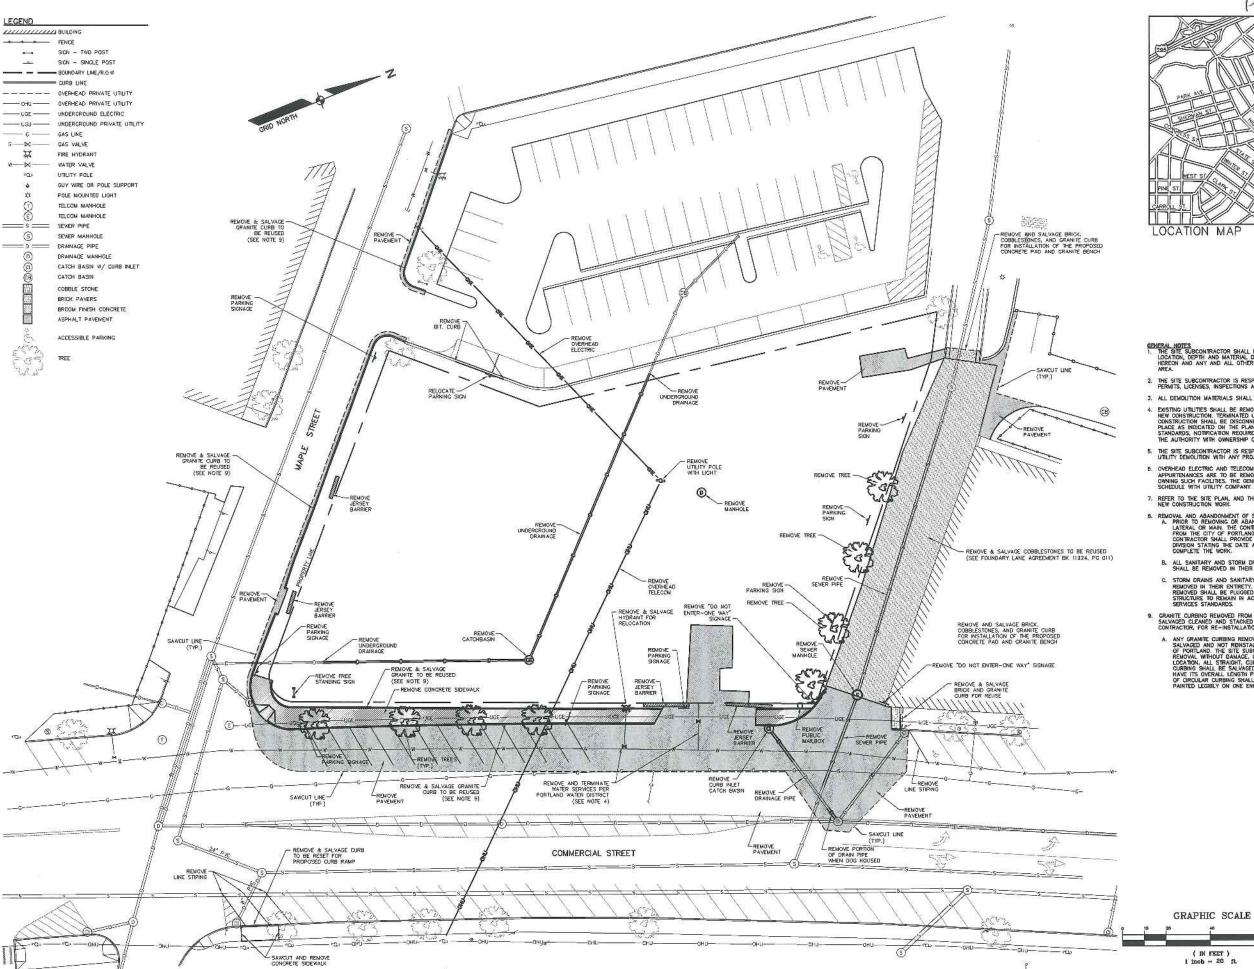

Plan 4 Hearing LOCATION MAP

- 3. ALL DEMOLITION MATERIALS SHALL BE DISPOSED OF BY APPROVED LEGAL MEANS.
- 4. EXISTING UTILITIES SHALL BE REMOVED WITHIN THE LIMITS OF WORK REQUIRED FOR NEW CONSTRUCTION. TEXHINATED UTILITIES LOCATED DUTSIDE THE LIMITS OF CONSTRUCTION SHALL BE DISCONNECTED, SEALED, REMOVED OR ABANDONED IN PLACE AS INDICATED ON THE PLANS AND IN ACCORDANCE WITH THE APPLICABLE STANDARDS, NOTIFICATION REQUIREMENTS AND DISCURPENTATION REQUIREMENTS OF THE AUTHORITY WITH OWNERSHIP OF AND/OR JURISDICTION OVER THOSE UTILITIES.
- 5. THE SITE SUBCONTRACTOR IS RESPONSIBLE FOR COORDINATING ALL SITE AND UTILITY DEMOLITION WITH ANY PROJECT PHASING AND LOGISTIC PLANS.
- 6. OVERHEAD ELECTRIC AND TELECOMMUNICATIONS CABLES AND UTILITY POLES AND APPLIETBHANCES ARE TO BE REMOVED/RELOCATED BY THE UTILITY COMPANIES OWNING SUCH FACILITIES. THE GENERAL CONTRACTOR IS TO COORDINATE SCHEDULE WITH UTILITY COMPANY AND OWNER.
- 7. REFER TO THE SITE PLAN, AND THE GRADING AND UTILITY PLAN FOR LIMITS OF NEW CONSTRUCTION WORK.
- 8. REMOVAL AND ABANDONMENT OF SANITARY SEWERS AND STORM DRAINS:
 A. PRIOR TO REMOVING OR ABANDONING ANY STORMWATER OF SANITARY SEWER
 LATERAL OR MAIN. THE CONTRACTOR SHALL DETAIN A SEAL DRAIN PERMIT
 FROM THE CITY OF PORTLA
- B. ALL SANITARY AND STORM DRAIN MANHOLES INDICATED TO BE REMOVED SHALL BE REMOVED IN THEIR ENTIRETY.
- C. STORM DRAINS AND SANITARY SEWER INDICATED TO BE REMOVED SHALL BE REMOVED IN THEIR ENTIRETY. THE EXISTING SEWER/DRAIN LATERALS TO BE REMOVED SHALL BE PLUGGED AT THE MAIN OR AT THE CONNECTION STRUCTURE TO REMAIN IN ACCORDANCE WITH CITY OF PORTLAND PUBLIC SERVICES STANDARDS.
- GRANITE CURBING REMOVED FROM THE PUBLIC RIGHT OF WAY SHALL BE SALVAGED CLEANED AND STACKED ON SITE, AS DIRECTED BY THE GENERAL CONTRACTOR, FOR RE-INSTALLATION.
 - ANY GRANTE CURBING REMOVED FROM THE PUBLIC RIGHT OF WAY THAT IS SALVAGED AND NOT REINSTALLED SHALL REMAIN THE PROPERTY OF THE CITY OF PORTLAND. THE SITE SUBCONTRACTOR SHALL BE RESPONSIBLE FOR THE REMOVAL WITHOUT DAMAGE, CLEANING AND STACKING IN A CITY DESIGNATED LOCATION, ALL STRAIGHT, CURPED, TERNINAL, AND CORNER SECTIONS FOR CURBING SHALL BE SALVAGED. EACH SECTION OF STRAIGHT CURBING SHALL HAVE ITS OVERALL LARGH PAINTED LEGBLY ON ONE END. EACH SECTION OF GROULAR CURBING SHALL HAVE ITS OVERALL LARGH PAINTED LEGBLY ON ONE END. EACH SECTION OF GROULAR CURBING SHALL HAVE ITS OVERALL CARD THE STRAIGHT CURBING SHALL HAVE THE OFFICE ALL CARD THE STRAIGHT CURBING SHALL HAVE THE OFFICE AND THE STRAIGHT OF THE STRAIGHT CURBING SHALL HAVE ITS OVERALL ARC LENGTH AND RADIUS PAINTED LEGBLY ON ONE END.


COMMERCIAL &
MIXED USE


DEMOLITION PLAN

OPECHEE

CORFORAT BELMONT NH 0 FAX (603)527-91

DATE: 10-22-12 SCALE: I"=20' DRAWN BY: BJS

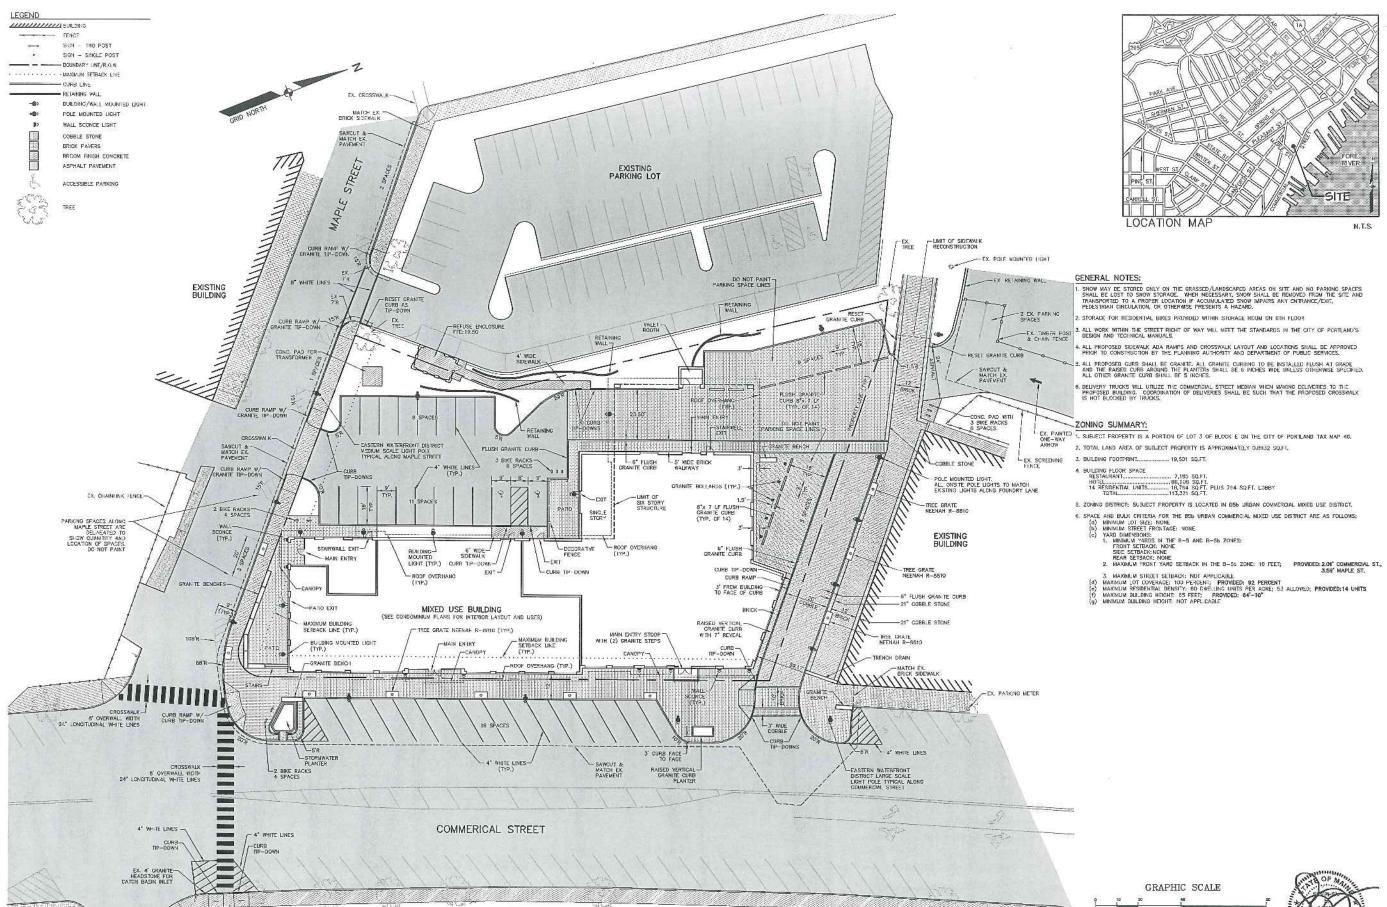

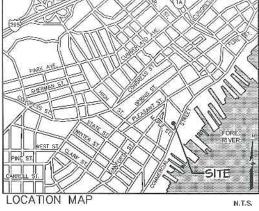

SNOW MAY BE STORED ONLY ON THE GRASSED/LANDSCAPED AREAS ON SHT AND NO PARKING SPACES SHALL BE LOST TO SNOW STORAGE. WHEN NECESSARY, SNOW SHALL BE REMOVED FROM THE SHT AND TRANSPORTED TO A PROPER LOCATION IF ACQUINULATED SNOW IMPAIRS ANY ENTRANCE/EXIT, PEDESTRIAN CIRCULATION, OR OTHER

S. ALL PROPOSED CURB SHALL BE GRANITE. ALL GRANITE CURBING TO BE INSTALLED FLUSH AT GRADE AND THE RAISED CURB AROUND THE PLANTERS SHALL BE 6 INCHES MIDE UNLESS OTHERWISE SPECIFIED. ALL OTHER GRANITE CURB STILL IE 5 INCHES

2. TOTAL LAND AREA OF SUBJECT PROPERTY IS APPROXIMATELY 0.8932 SQ.FT.

5. ZONING DISTRICT: SUBJECT PROPERTY IS LOCATED IN 856 URBAN COMMERCIAL MIXED USE DISTRICT.


(IN FEET) 1 inch = 20 ft.


ONSTRUCTION CORPORATION II CORPORATE DELVE, DELMONT NII 03120 PHONE (603) 527-8090 FAX (603)321-8191 OPECHEE

COMMERCIAL & MAPLE STREET
MIXED USE DEVELOPMENT

PLAN

SITE

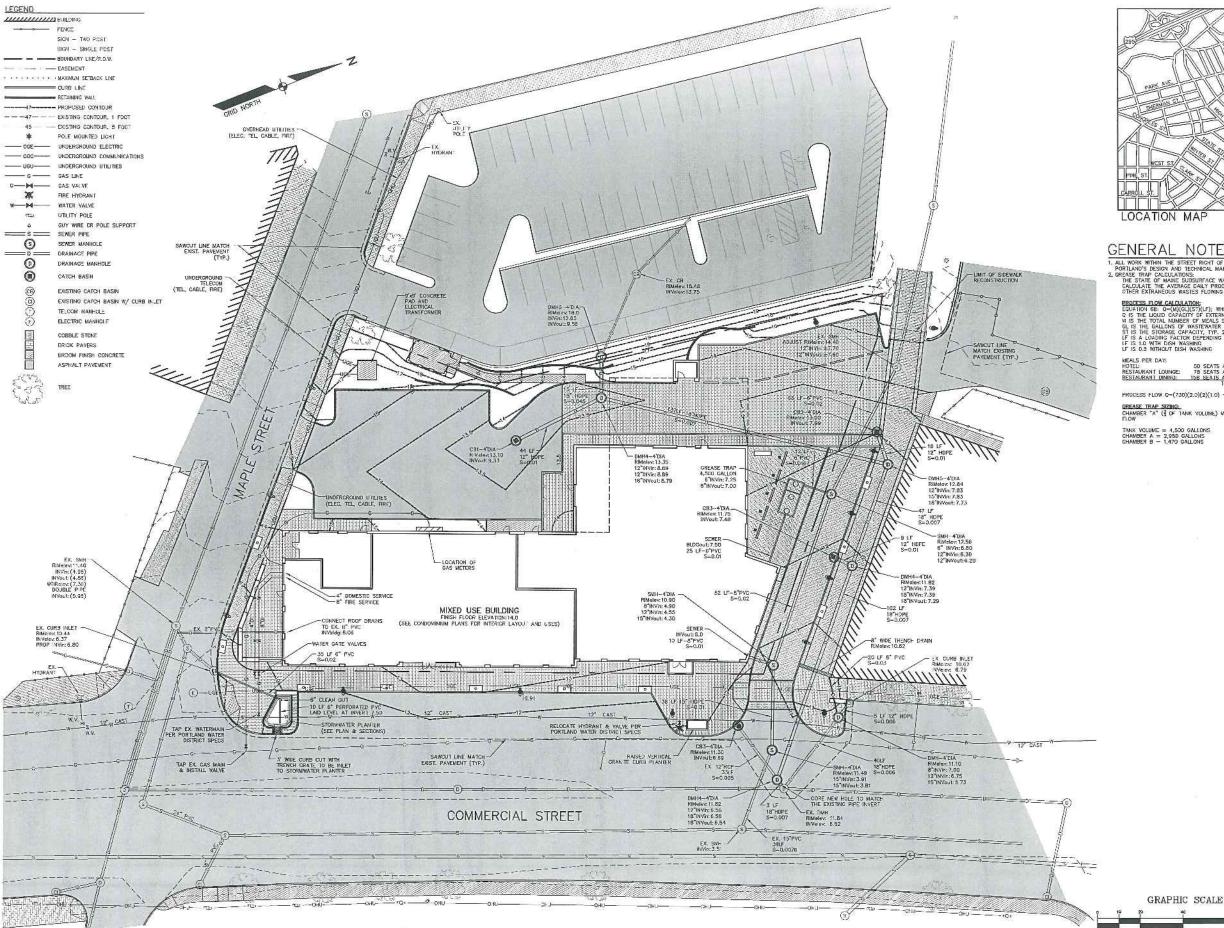

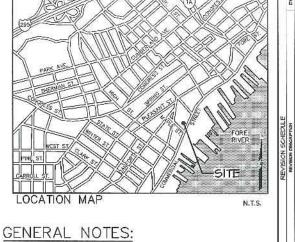

- I. ALL WORK WITHIN THE STREET RIGHT OF WAY WILL MEET THE STANDARUS IN THE CITY OF PORTLAND'S DESIGN AND TECHNICAL MANUALS.

 2. GREAGE TRAP CACULLAMORT OF WASTEWAYER DISPOSAL RULES ARE LITILIZED TO CALULANE THE AVERAGE DAILY PROCESS FLOW FROM THE TACILITY WITH NO SANITARY OR OTHER EXTRANEOUS WASTES FLOWING THROUGH THE TRAP.

- PROCESS FLOW CALCULATION:

 EQUATION 58: O-(M)(CL)(ST)(LF): WHERE

 CIS THE LOQUID CAPACITY OF EXTERNAL CREASE INTERCEPTOR IN CALLONS

 M IS THE TOTAL NUMBER OF MEALS SERVED PER DAY

 OLI SI HE GALLONS CF WASTEWATER PER MEAL., TYP. 2.0 GALLONS

 ST IS THE STORAGE CAPACITY, TYP. 2.

 IF IS A LOANING FACTION DEPENDING ON TYPE OF FACILITIES PRESENT

 IF IS 1.0 WITH DIST WASHING.

 UF IS 0.3 WITHOUT DIST WASHING.

MEALS PER DAY:
HOTEL:
5D SEATS AT 2 MEALS PER DAY = 100 MEALS
RESTAURANT LOUNGE:
7B SEATS AT 2 MEALS PER DAY = 156 MEALS
RESTAURANT LOUNGE:
108 SEATS AT 3 MEALS PER DAY = 474 MEALS
TOTAL MEALS PER DAY = 730 MEALS

PROCESS FLOW O=(730)(2.0)(2)(1.0) = 2,920 GALLONS

CHEASE TRAP SIZING: CHAMBER "A" (\$ OF TANK YOLUME) MUST BE EQUIVALENT TO THE AVERAGE DAILY PROCESS FLOW


TANK VOLUME = 4,500 GALLONS CHAMBER A = 2,950 GALLONS CHAMBER B = 1,470 GALLONS



PLAN UTILITY

COMMERCIAL & MAPLE STREET MIXED USE DEVELOPMENT

(IN FEET) 1 inch = 20 ft.

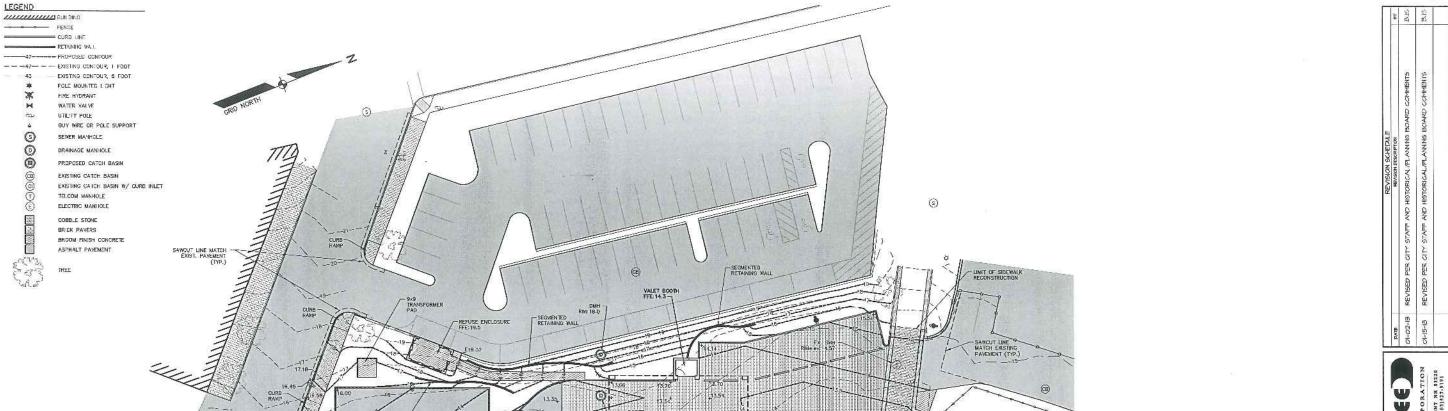

E11.35x

MIXED USE BUILDING SINSH FLOOR ELEVATION: 14.0 (SEE FLOOR PLANS FOR INTERIOR LAYOUT AND USES)

E12. 10

3

0

10.60 F11.46

DMH EX CB RIM:11,10 RIMeter 10,52

0

MATCH BOTTOM OF TOP RISER APPROX, ELEV: ±14.36

CONSTRUCTION CORPORATION HICKNEY HELMONT NH 03210 PHONE (603) 227-3990 FAX (603) 337-9191 COPECHEE


> PLAN GRADING

COMMERCIAL & MAPLE STREET MIXED USE DEVELOPMENT

GRAPHIC SCALE

0

(11)

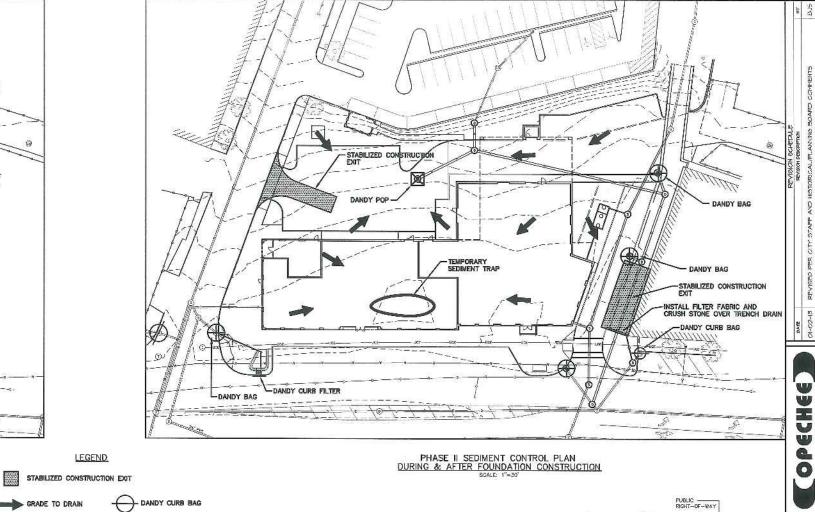

GRAPHIC SCALE (IN FEET) 1 inch = 20 fL

EROSION AND SEDIMENT CONTROL NOTES:

- ENUSION AND SEDIMENT CONTROL NOTES:

 1. THE EROSION IPAN DEPICTS THE REQUIRED SOIL EROSION AND SEDIMENT CONTROL MEASURES THAT THE SITE SUBCONTRACTOR IS RESPONSIBLE FOR MAINTAINING DURAND EMECTION/CONSTRUCTION IN SUCH A MANNER THAT TO A MINIMAL.

 2. SOIL EROSION IS REFT TO A MINIMAL.

 3. ALL POSSIBLE MEASURES AND EMPLOYED TO PREVENT SEDMENT FROM ENTERING DRAINAGE COURSES EVEN BEYOND THE OFFILE SHOWN ON THIS PLAN IS NECESSARY.

 2. SOIL DISTURBING ACTIVITIES WILL INCLUDE MINIMAL CLEARING & GRUBBING, DEVOLUTION, EXCAVATION FOR SEMER, STORM BRAINAGE, UNDERGROUNG LOUTLITES, BUILDING FOUNDATIONS, AND RETAINING WALLS. A SHALL BE CONSIDERED STABLE IF ONE OR MORE OF THE PLAYER.

 3. AND AND SECOND SECOND SECOND STABLE OF THE PAYER.

 4. MINIMUM OF 85% VEGETATED GROWTH HAS BEEN ESTABLISHED.

 4. A MINIMUM OF 85% ON HON-EROSIVE MATERIAL SUCH AS STONE SEARCH.

- BE PARIEL.

 A MINIMUM OF 57 ON NON-ERGISTE MATERIAL SUCH AS STONE OR RIPERAL SUCH AS STONE AS STONE EXPENSION OR RIPERAL SUCH AS STONE EXECUTIVE OR RESIDENCE OF REAL SUCH AS STONE AS SUCH AS
- ALL DITCHES OR SWALES WHICH DO NOT EXCIBIT A MINIMUM OF B3X VEGETATIVE GROWIH BY OCCUEER 15TH, OR WHICH ARE DISTURBED AFTER OCTOBER 15TH, SHALL BE STABILIZED WITH STONE OR EROSION CONTROL BLANKETS APPROPRIATE FOR THE DESIGN FLOW CONDITIONS.
- AFTER NOVEMBER 15TH, INCOMPLETE ROAD OR PARKING SURFACES SHALL BE PROTECTED WITH A MINNBURM OF 3-HICHES OF CRUSHED GRAVEL OR IT CONSTRUCTION IS TO CONTINUE THROUGH THE WINNER SEASON, BE CLEARED OF ANY ACCUMULATED SKOM AFTER EACH STORM EVENT.

EROSION AND SEDIMENT CONTROL NOTES (CONT.):

PHASE I SEDIMENT CONTROL PLAN

PRIOR TO AND DURING FOUNDATION CONSTRUCTION
SCALE 17-30'

- EROSION AND SEDIMENT CONTROL NOTES (CONT.):

 O DANDY SACKS ARE SEDIMENT TRAP DEVICES TO BE USED WITH CATCH BASIN GRACES TO FILER OUT ALL THE SEDIMENT—LABEN STORMMATER. THE OWN AND ARE CAPTURED BY THE SACK AFEE ENTERING THE CATCH BASIN MILET. TO CLOW THE DANDY SACK SEDIMENT TRAP MANUFACTURES SHEETING THE CATCH ADDIT OF THE SACK AFEE ENTERING THE CATCH BASIN MILET. TO CLOW THE DANDY SACK SEDIMENT TRAP MANUFACTURES S SPECIFICATIONS AND RECOMMENDATIONS FOR INSTALLATION OF THE DANDY SACK. THE SACK SHALL BE EXPIRED WHEN THE CONTAINING THE ARMY SACK. THE SACK SHALL BE EXPIRED WHEN THE CONTAINING THE ARMY SACK. THE SACK SHALL BE EXPIRED WHEN THE CONTAINING THE ARMY SACK. THE SACK SHALL BE REPORTED THAT FILTERS THROUGH THE SILT SOCK, THIS MILL CREATE TEMPORARY POWDING OWNER HEAVY RAILS. THE SILT SOCK SHOULD BE INSPECTION ADDITIONAL OF THE SILT SOCK ADDITIONAL DEFINED THE PROCEDURE OF THE SILT SOCK ADDITIONAL TO SOCK SHOULD BE PLACED ON TOP OTHER EXISTING SOLT SHOULD BE PLACED ON TOP OTHER EXISTING SOLT SHOULD BE PLACED ON TOP OTHER EXISTING SOLT SHOULD BE PLACED ON TOP OTHER EXISTING SILT SOCK WITHOUT DISTURBANCE OF THE SOL OR COLLECTED SEDIMENT.


 THE SITE SUBCONTRACTOR IS RESPONSIBLE FOR ALL SILTATION RESULTING FROM THE SITE TO SURROUNDING FROM THE SI

GOOD HOUSEKEEPING NOTES:

- COOD. HOUSEKEEPING NOTES.

 I. THE PAYED STREET INTO AND FROM THE SITE WILL BE SWEPT AS NECESSARY (COULD BE AS FREQUENT AS DALLY DURING HEAVY EARTH HAULING CPERATIONS) TO PERIODE ANY EXCESS MUD, DIRT, OR ROCK TRACKED FROM THE SITE. DUMP TRUCKS HAULING MATERIAL FROM THE CONSTRUCTION SITE WAL BE COVERED WITH A TARFAULIN.

 ALL WASTE MATERIALS WILL BE COLLECTED AND STORED SECURELY IN A METAL DUMPSTER RENTED FROM A LOCAL SOLD WASTE MANAGEMENT AS THE THE ARTHER FROM THE STATE SOLD WASTE MANAGEMENT REGULATIONS. THE FUNDER OF STATE SOLD WASTE MANAGEMENT REGULATIONS. THE FUNDER OF THE STATE SOLD WASTE MANAGEMENT REGULATIONS. THE FUNDER OF THE STATE SOLD WASTE MANAGEMENT REGULATIONS. THE FUNDER OF THE TRUCKS OF THE STATE OF THE STATE OF THE TRUCKS OF THE MANAGEMENT OF THE STATE OF THE STATE OF THE MANAGEMENT OF THE MANAGEMENT STATE OF THE STATE PRACTICES AND THE STATE PRACTICES AND THE STATE PRACTICES AND THE STATE PRACTICES AND THE STATE STATE PRACTICES AND THE STATE PRACTICES AND THE STATE PRACTICES AND THE STATE PRACTICES AND THE STATE STATE PRACTICES AND THE STATE PRACTICES AND THE STATE STATE PRACTICES AND THE STAT

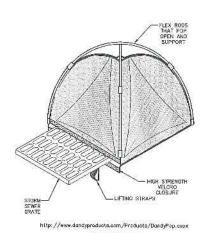


LEGEND

DANDY POP

GRADE TO DRAIN


- DANDY CURB FILTER

DANDY BAG

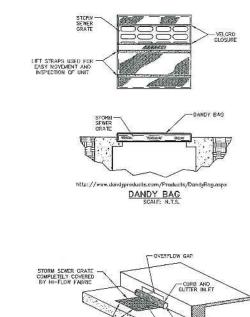

LOW PROFILE WITH GUTTER FOR SAFETY AND CURB APPEAL

http://www.dondyproducts.com/Products/DancyCu-bBag.aspx DANDY CURB BAG

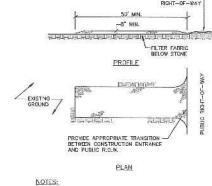

1. SIGNE SIZE- AASHTO DESIGNATION M43, SIZE NO. 2 (2 1/2° TO 1 1/2°). USE CRUSHED STONE.

- 2. LENGTH- AS SHOWN ON PLANS, MIN. 50 FEET.
- 3. THICKNESS- NOT LESS THAN EIGHT (8) INCHES.
- WOTH- NO" LESS THAN FULL WIDTH OF ALL POINT OF INGRESS OR EGRESS.
- S. MAINTENANCE—THE ENTRANCE SHALL BE MAINTAINED IN A CONDITION WHICH WILL PREVENT TRACKING OR FLOWING OF SEIMENT ONTO PUBLIC RIGHT-TOF-WAY, THIS MAY REQUIRE PERIODIC ID D'ERESING WITH ADDITIONAL STONE AS CONDITIONS DEMAND AND REPAIR AND CLEM-GUT OF ANY MEASURES USED TO TRANS SEMILIARY. ALL SEDMENT SHILLED, DYOFFED, WASHED OR TRACKED ONTO PUBLIC RIGHT-OF-WAY MUST BE REMOVED IMMODIATELY.

STABILIZED CONSTRUCTION EXIT



Plan & Hearing

COMMERCIAL & MAPLE MIXED USE DEVELOP

TEMPORARY
EROSION & SEDIMENT
CONTROL PLAN

STREET



PLANT SCHEDULE

GRAPHIC SCALE

(IN FEET) 1 inch = 20 ft.

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	94000						
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н	Vlavon cartesa Corpostá	Duar Mayburs Vision	5-1 E45	REVISION SCHEDULE	2 3	PLAN CHANGES	PLAN CHANGES
	PENEMALS & CROUNDY COVERS			199	1	<u> </u>	SITE
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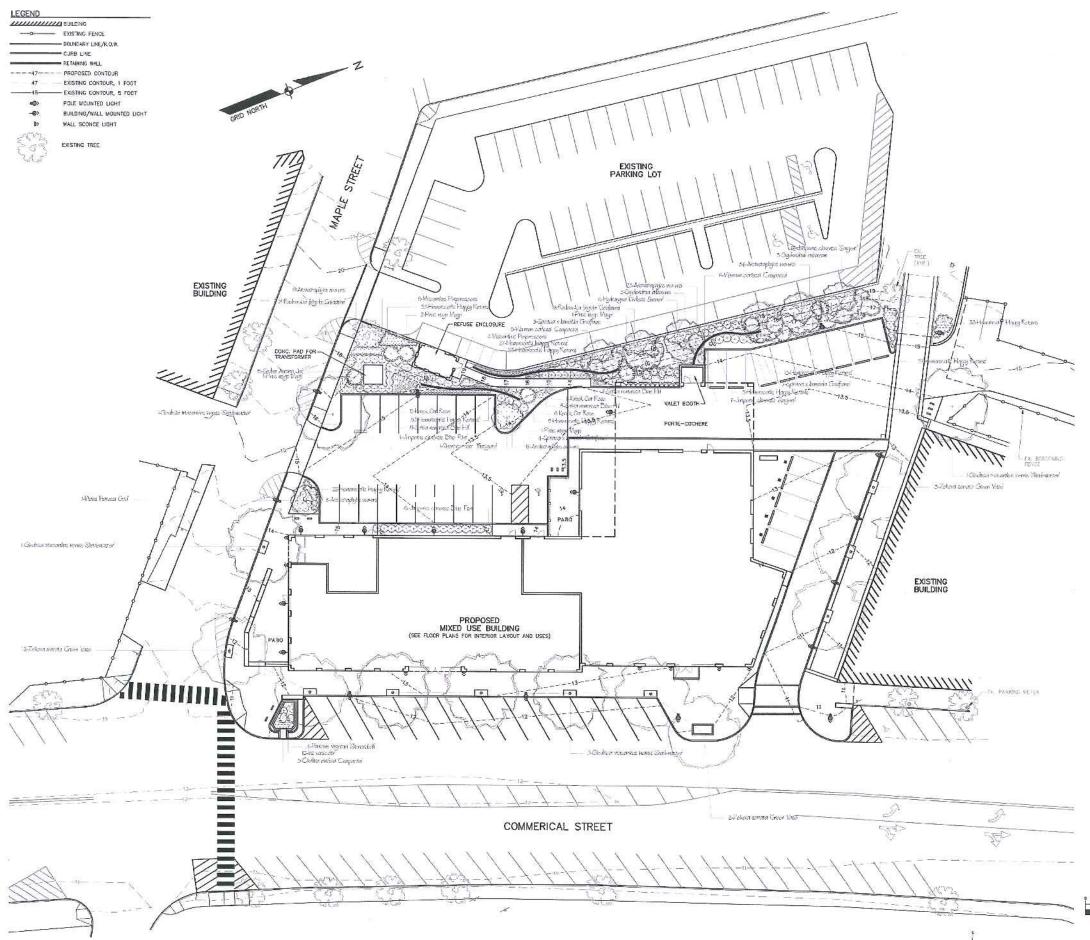


CONSTRUCTION CORPORATION
LICOMODATE BRING BELIEVEN NI 02220
HIGGEORGISTAND BRINGS STATE

LANDSCAPING PLAN

COMMERCIAL & MAPLE STREET
MIXED USE DEVELOPMENT

DATE: R	2-22-12
SCALE	l'=20'
DRAIN BY	ri BJS
MI	10
(()
SHEET, 8	OF 14



TYPE	DESCRIPTION	MANUFACTURER/ CATALOG NO.	LAMPS	MOUNTING
S1	CITY OF PORILAND EASTERN WATERFRONT DISTRICT LARGE POLE MOUNTED LIGHT	HOLOPHANE LICHTING ESU 175PM MA CMC 45-64319	ONE 175—WATT CLEAR METAL HALIDE LAMP, VERTICAL MOUNTED.	POLE MOUNTED 20" HEIGHT
S2	CITY OF PORTLAND EASTERN WATERFRONT DISTRICT MEDIUM POLE MOUNTED LIGHT	HOLOPHANE LIGHTING ESU 175PM MA CMC 45-64319	ONE 175-WATT CLEAR METAL HALIDE LAMP, VERTICAL MOUNTED.	POLE MOUNTED 15' HEIGHT
\$3	UNIVERSE MEDIUM HOUSING SCALE WITH 4 LUMINOUS WINDOWS AND FLARED HOOD	ARCHITECTURAL AREA LIGHTING UCM-WND-FLR-OAL-100MH	ONE 100 WATT MEDIUM BASE CLEAR ED-17 MH LAMP LUMENS=9300	POLE MOUNTED 15' HEIGHT
54	UNIVERSE MEDIUM HOUSING SCALE WITH 4 LUMINOUS WINDOWS AND FLARED HOOD	ARCHITECTURAL AREA LIGHTING UCM-WND-FLR-OAL-100MH	ONE 100 WATT MEDIUM BASE CLEAR ED-17 MH LAMP LUMENS-9300	BUILDING MOUNTED 12' HEIGHT
5C	CAMBER WALL SCONCE	U.S. ARCHITECTURAL LIGHTING CBRS-100MH-CP	100W ED17 CLR METAL HALIDE	BUILDING MOUNTED 7' HEIGHT

	LIGHT FIXTURE SCHEDULE				
TYPE	DESCRIPTION	MANUFACTURER/ CATALOG NO.	LAMPS	MOUNTING	
S1	CITY OF PORTLAND EASTERN WATERFRONT DISTRICT LARGE POLE MOUNTED LIGHT	HOLOPHANE LIGHTING ESU 173PM MA CMC 45-64319	ONE 175—WATT CLEAR METAL HALDE LAMP, VERTICAL MOUNTED.	POLE MOUNTED 20' HEIGHT	
S2.	CIEY OF PORTLAND EASTERN WATERFRONT DISTRICT MEDIUM POLE MOUNTED LIGHT	HOLOPHANE LIGHTING ESU: 175PM MA CMC 45-64318	ONE 175-WATT CLEAR METAL HALIDE LAMP, VERTICAL MOUNTED.	POLE MOUNTED 15' HEIGHT	
\$3	UNIVERSE MEDIUM HOUSING SCALE WITH 4 LUMINOUS WINDOWS AND FLARED HOCO	ARCHITECTURAL AREA LIGHTING UCM-WND-FLR-OAL-100MH	ONE 100 WATT MEDIUM BASE CLEAR ED-17 MH LAMP LUMENS=9300	POLE MOUNTED 15' HEIGHT	
54	UNIVERSE MEDIUM HOUSING SCALE WITH 4 LUMINOUS WINDOWS AND FLARED HOOD	ARCHITECTURAL AREA LIGHTING UCM-WND-FLR-OAL-100MH	ONE 100 WATT MEDIUM BASE CLEAR ED-17 MH LAMP LUMENS-9300	BUILDING MOUNTED 12' HEIGHT	
5C	CAMBER WALL SCONCE	U.S. ARCHITECTURAL LIGHTING CBRS-100MH-CP	100W ED17 CLR METAL HALIDE	BUILDING MOUNTED 7' HEICHT	

- NOTES:

 1. LIGHTING CALCULATIONS REPRESENT HORIZONTAL MAINTAINED ILLUMINANCE LEVELS (FCOTCANDLES) MEASURED AT GRADE IN A 5'40' GRID. CITY STREET LIGHTS ARE NOT INCLUDED IN THE LIGHTING CALCULATIONS.

 2. CALCULATED GRID STATISTICS FOR ZONE 1 ARE AS FOLLOWS:

 AVE 1.66 MR-0.26 MAX-0.47 MAX/MIR-0.21 AVD/MIR-0.21

 3. CALCULATED GRID STATISTICS FOR ZONE 2 ARE AS FOLLOWS:

 AVE 1.56 MR-0.26 MAX-0.47 MAX/MIR-0.21 AVD/MIR-0.21

 4. STATISTICAL CALCULATION FORITS ARE DELINEATED WITH X

 5. MAINTAINED ILLUMINANCE LEVELS ARE BASED UPON THE FOLLOWING LIGHT LOSS FACTORS:


 0.60 TYPES S3, 54, SC

OPECHEE

PHOTOMETRIC PLAN

COMMERCIAL & MAPLE STREET MIXED USE DEVELOPMENT



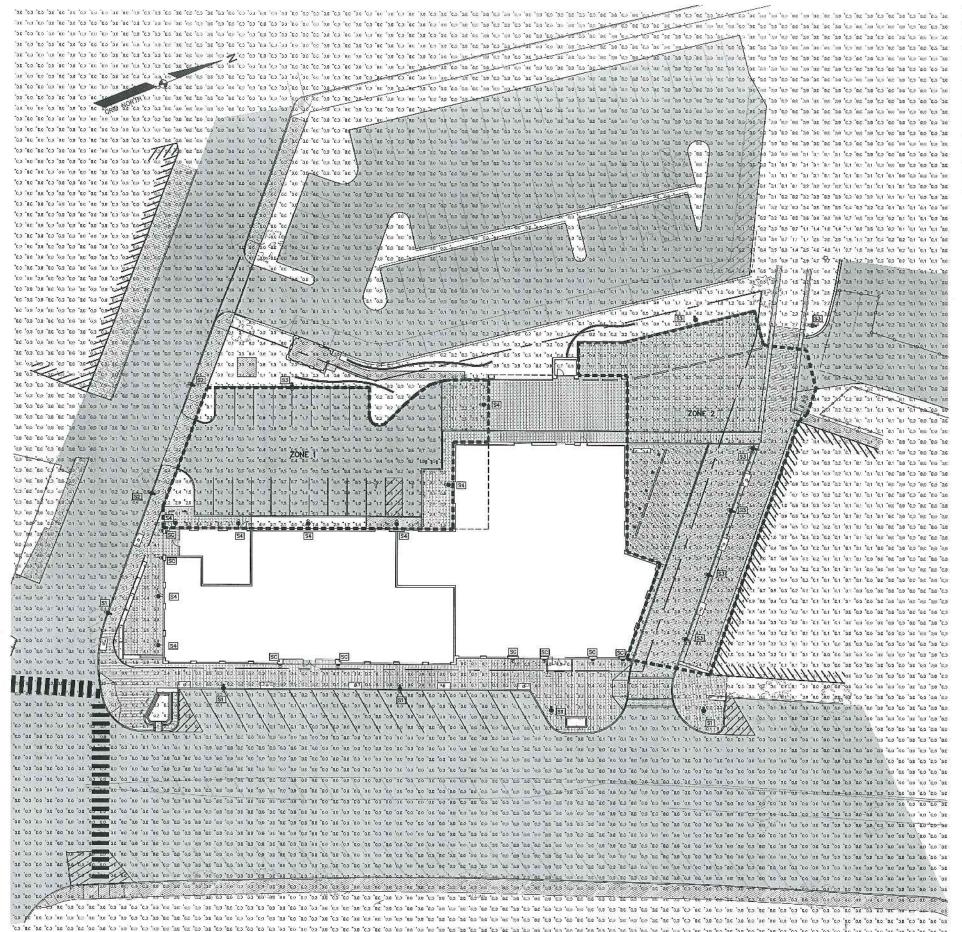

GRAPHIC SCALE (D) FEET) 1 inch = 20 ft


-UNDISTURBED EARTH —IF CONCRETE PAYING, DOWEL SLAB TO FOUNDATION 12" O.C. CNLY AT DOOR OPENING. 4"-0" I SECTION

SUBBASE AND BASE GRAVEL (SEE PAVING DETAILS)

GEOTEXTILE EQUAL TO MIRAFI 140N

- 6" PERF. FOUNDATION DRAIN EXTEND TO POSITIVE OUTLET SHOWN ON GRADING PLAN

5' GRANULAR BASE @ DOOR THRESHOLD

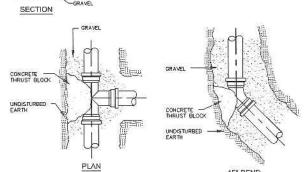

CONCRETE THRUST BLOCK SIZE REQUIREMENTS SQ. FT. OF BEARING ON UNDISTURBED SOIL PITTINGS 90" BENDS 45" BENDS TEES AND PLUGS

45° BEND

PIPE 8" 8.0 4.0

TEE AND BEND DETAIL NOT TO SCALE

& MAPLE STREET DEVELOPMENT COMMERCIAL &
MIXED USE

> DATE: 10-22-12 SCALE: 1"=20" DRAWN BY B. B. SHEET: 10 OF 14

NOTES:

1. BORDER COURSE OF BRICK SHALL BE MORTARED TO PAVEMENT BASE, REMAINING BRICKS TO HAVE
OLEAN SAMD SMEPT INTO JOINTS.

2. BRICKS TO BE USED!
(4) NEW CONSTRUCTION: 4"-8" FINE HALL PATHWAY PAVER BRICK, MFG, BY PINE HALL BRICK CO.,
(5) NEW CONSTRUCTION: 1"5-8" FINE HALL PATHWAY PAVER BRICK.
(6) NEW CONSTRUCTION: 1"5-8" FINE HALL PATHWAY PAVER BRICK.
(6) REPAIR MAINTENANCE TO EXESTING BRICK SDEWALKS: VERMONT PAVER, SUPPLIED BY GAGNE AND
SOMS, SPEC. NO. "VERMONT BACKER BRICK", ITEM MYGRO.

LI* SAND-CEMENT BASE (6:1 MIX)

2" BITUMINOUS PAVEMENT-CRADING "B" (19 mm)

10" AGGREGATE BASE-CRUSHED, TYPE "B"

PAVEMENT SAW CUT DETAIL

- BRICKS LAID FLAT

LI PRESENTATION DE LA CONTRACTION DEL CONTRACTION DE LA CONTRACTIO

-MORTAR, TYP. TYPE I VERTICAL

HOT BITUMINOUS PAWING SURFACE COURSE -

4" LOAM AND SEED/SOD

HOT BITUMINOUS PAYING BASE COURSE

AGGREGATE BASE AND SUBBASE

- VARIES -

TO MATCH EXISTING GRADE

EXISTING PAVEMENT STRUCTURE

MILL EXISTING PAVEMENT TO A DEPTH OF 2" AND APPLY TACK COAT PRICE TO PLACEMENT OF PAVEMENT OVERLAY.

BURY DEPTH (VARIES PER DESIGN)

LEVELING PAD (VARIES PER DESIGN)

BRICK SIDEWALK WITH GRANITE CURB

IOTES:

BLOCK SETBACK = %* PER COURSE = 5* BATTER

CONSTRUCTION ADMESTMES SHALL BE SPECIFICALLY FORWILLIED FOR SECMENTAL BLOCK WALL CONSTRUCTION AND
SHALL BE INSTALLED ACCORDING TO THE MANUFACTURER'S RECOMMENDATIONS.

THIS DRAWING IS FOR REFERENCE ONLY.
FINAL DESIGNS FOR CONSTRUCTION MASS BE PROPARED BY A REGISTERED PROFESSIONAL ENGINEER USING THE ACTUAL
CONDITIONS OF THE PROPOSED SITE.
FINAL MELL DESIGN MUST ADDRESS BOTH INTERNAL AND EXTERNAL DRAWINGE AND SHALL BE EVALUATED BY THE
PROFESSIONAL ENGINEER WHO IS RESPONSIBLE FOR THE WALL DESIGN.

BLOCKS ARE PRODUCED WITH DIFFERENT FACE TEXTURES. EXPOSED BLOCK FACES WILL VARY THROUGHOUT THE WALL
DEPENDING ON INSTALLATION PATTERN.

LENGTH OF GEOGRID LAYER

RETAINED SOIL


VERTICAL PLACEMENT OF GEOGRID LAYER

FUNDING (SEE ARCHITECTURAL PLANS)


. . . .

COMPACT SUBGRADE 95%


RETAINING WALL DETAIL

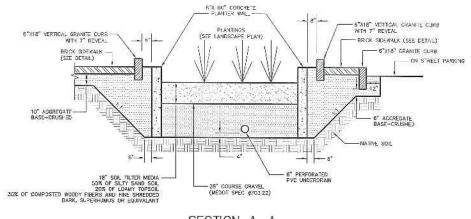


SECTION A-A SCALE: 1 INCH = 3 FEET

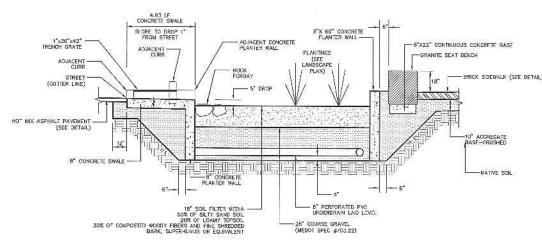

SECTION B-B

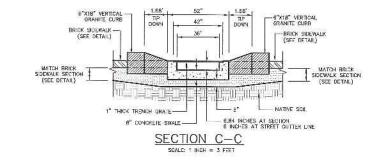

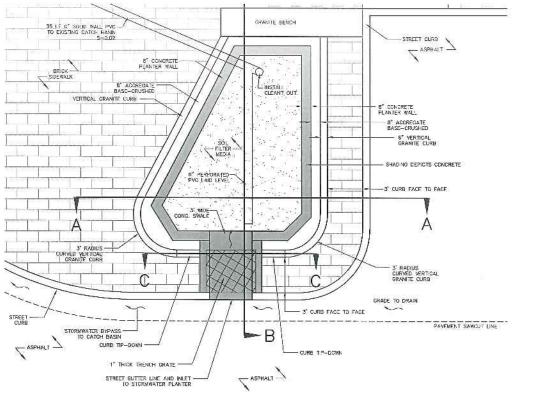

T OURB REVEAL

TERMINAL CURB PROFILE


MERTICAL GRANITE CURB PLAN VIEW

VERTICAL GRANITE CLIEB CROSS SECTION VERTICAL GRANITE CURB INSTALLATION IN EXISTING STREETS

4" X 8 1/2" FILTER FABRIC (FIP.) FOR ALL CRANITE CLAB INSTALLATI

ESPLANADE AND OR SIDEWALK -

1/4"# TO 1/8" MAX, JONT LENGTH MARKE, 4' MIN

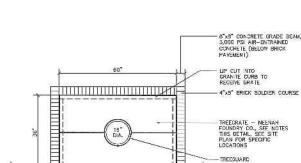



STREET CURB

NOTES: 16"# EXPANDABLE TREE OFENING 0.25" SLOT OPENINGS.

PLAN MEW EXPANDABLE TREE GRATE NEENAH MODEL R-8810



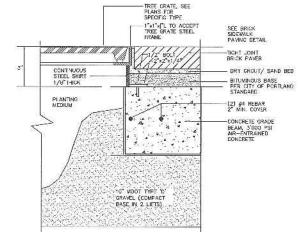

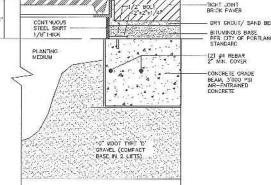

TYPICAL SECTION TREE GRATE FRAME




A A

CONSTRUCTION DETAILS

COMMERCIAL & MAPLE STREET MIXED USE DEVELOPMENT

DRAWN BY: BJ5


STORMWATER PLANTER PLAN 4" X 8 1/2" FILTER FASSIC (TIP.) FOR ALL GRANITE CURE INSTALLATION

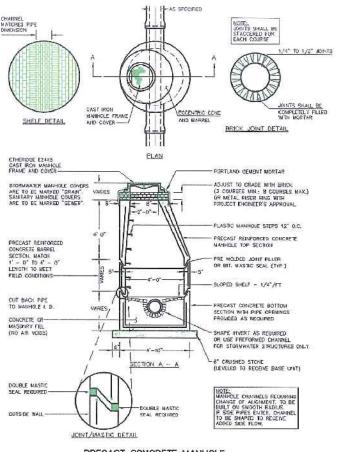

PRECAST CONCRETE MANHOLE

NOTE: ALL MANHOLS COVERS SHALL BE SOUD AND SHALL HAVE ONE $7/8^\circ$ DIAMETER DRILLED PICK HOLE, LOCATED 5° FROM THE CENTER OF THE COVER.

ALL SANITARY MANHOLE COVERS SHALL HAVE "SEWER" CAST INTO THE COVER. ALL STORMWATER/DRAIN MANHOLE COVERS SHALL HAVE "DRAIN" CAST INTO THE COVER.

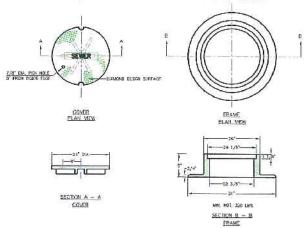


CAST IRON MANHOLE COVER AND FRAME


GENERAL NOTES FOR MANHOLES AND CATCH BASINS


- ALL CONCRETE SHALL HAVE A MINIMUM ULTIMATE COMPRESSIVE STRENGTH OF 4000 Iba. PER SO, INCH AT THE END OF 28 DAYS, UNLESS OTHERWISE NOTED
- MANHOLES WAY BE CONSTRUCTED OF PRECAST REINFORCED CONCRETE, OR CAST IN PLACE.
- PRECAST REINFORCED CONE BARREL MANUFACTURED PER ASTM SPEC. C-478.
- ALL STORM AND SEWER MANHOLE COVERS SHALL BE SOLID AND SHALL HAVE ONE 7/8" DIAMETER DRILED PICK HOLE LOCATED 8" FROM THE CENTER OF THE COVER.
- 5. ALL SANITARY MANHOLE COVERS SHALL HAVE "SEMER" CAST INTO THE COVER, ALL STORMMATER (DRAIN MANHOLE COVERS SHALL HAVE "GRAIN" CAST INTO THE COVER.
- ALL MANHOLE RISERS SHALL BE ETHERIDGE 24" OR AFPROVED FOUND.
- SEWER BRICK SHALL CONFORM TO ASTM SPEC, DESIGNATE ON C-32-63, CRAOF MA 4ND SA.

- 8. ALL SANITARY MANHOLES SHALL HAVE A WATERPROOFING COATING APPLIED TO THE EXTERIOR SUPFACE
- CATCH BASIN FRAMES FOR TYPE A4 CATCH BASIN CURB PUETS SHAUL BE CTHERIDGE DROA OR APPROVED FOULAL
- 10 CASTINGS SHALL CONFORM TO ASTM DESIGNATION A48-CLASS 35.
- EXISTING MANHOLES, CATCH BASINS, FRAMES, AND COVERS SHALL BE SALVACED BY THE CONTRACTOR, AND SHALL BEMAIN THE PROPERTY OF THE CITY OF POBILAND
- 12 ALL CATCH BASIN OUTLETS SHALL BE INSTALLED WITH A CASCO TRAP, SEE FIGURE II-09.

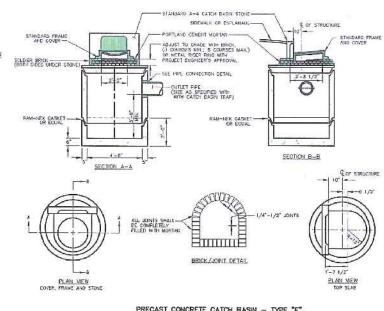



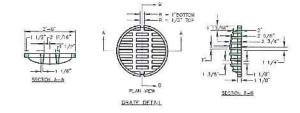

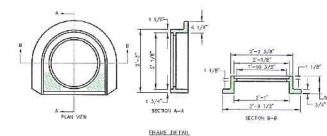

CATCH BASIN FRAME & GRATE

PLAN VIEW


SECTION A-A

24 3 1 1/8 28 1/4 72




4' GRANITE HEADSTONE FOR CATCH BASIN INLET

FROM L. MEW

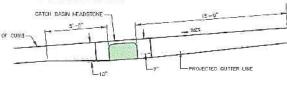


TYPICAL PAVEMENT GRADING ON SLOPES FOR CATCH BASIN AND INLET

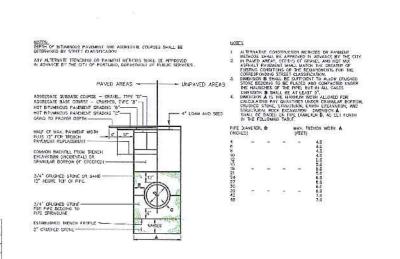


SECTION A-A





TYPICAL PIPE INSTALLATION - NOTES

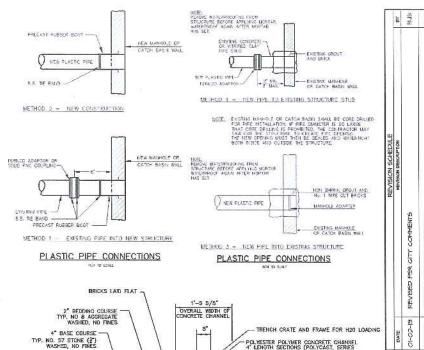

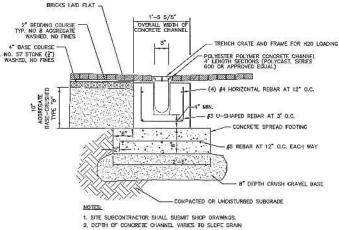


TRENCH DRAIN

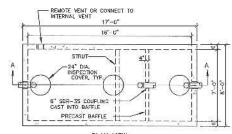

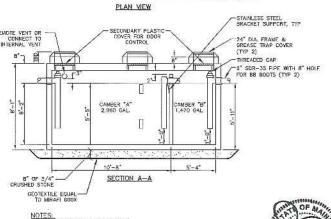

NOT TO SCALE

NOTES: 1. 5,000 PSI CONCRETE AT 28 DAYS. I. H. 20 LOADING.
S. JOHN'S SCALED BUTYL RUBBER JOINT SEALANT (ASSHTO M-19)
LAIL TERS/BAFFLES TO BE PROVIDED BY PRECAST.
I. HIS STRUCTURE MUST DISCHARGE TO A CITY OF PORTLAND
STANDARD MARHELE (CONTROL/SAMPLINE MIT) GREASE TRAP DETAIL - 4,500 GALLON TANK

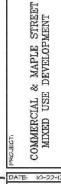

CONSTRUCTION CORPORATION CORPORATION OF USER PROVIDER 1922 OF THE PROVIDER OF THE PROVIDER OF THE PROVIDER OF THE OFFICE OF THE OFFICE OF THE OFFICE OF THE OFFICE OFFICE

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SANITARY SEWER & STORM DRAIN DETAILS







MAPLE STREET ELEVATION







CONSTRUCTION CORPORATION
11 CORPORATE DRIVE, BELMONT NH 02220
PHONE (603) 227-9090 PAX (603) 227-911

EXTERIOR BUILDING ELEVATIONS

COMMERCIAL & MAPLE STREET
MIXED USE DEVELOPMENT

DATE: 12-10-12
SCALE: SEE PLAN
DRAWN BY:

SHEET



[OPECHEE]

EXTERIOR BUILDING ELEVATIONS


COMMERCIAL & MAPLE STREET MIXED USE DEVELOPMENT


DATE: 12-10-12 SCALE: SEE PLAN DRAWN BY.

SHEET:

EXISTING BAXTER PLACE BLDG. METAL EDGE—— TRIM-SLATE GREY FIBER CEMENT — BD, FASCIA & SOFFIT-SLATE GREY 8888888 FIXED/CASEMEN ALUMINUM WINDOWS FIXED ALUMINUM -FACE BRICK -FOUNDRY LANE FENCE @ COURTYARD GAS METERS YORK STREET ELEVATION



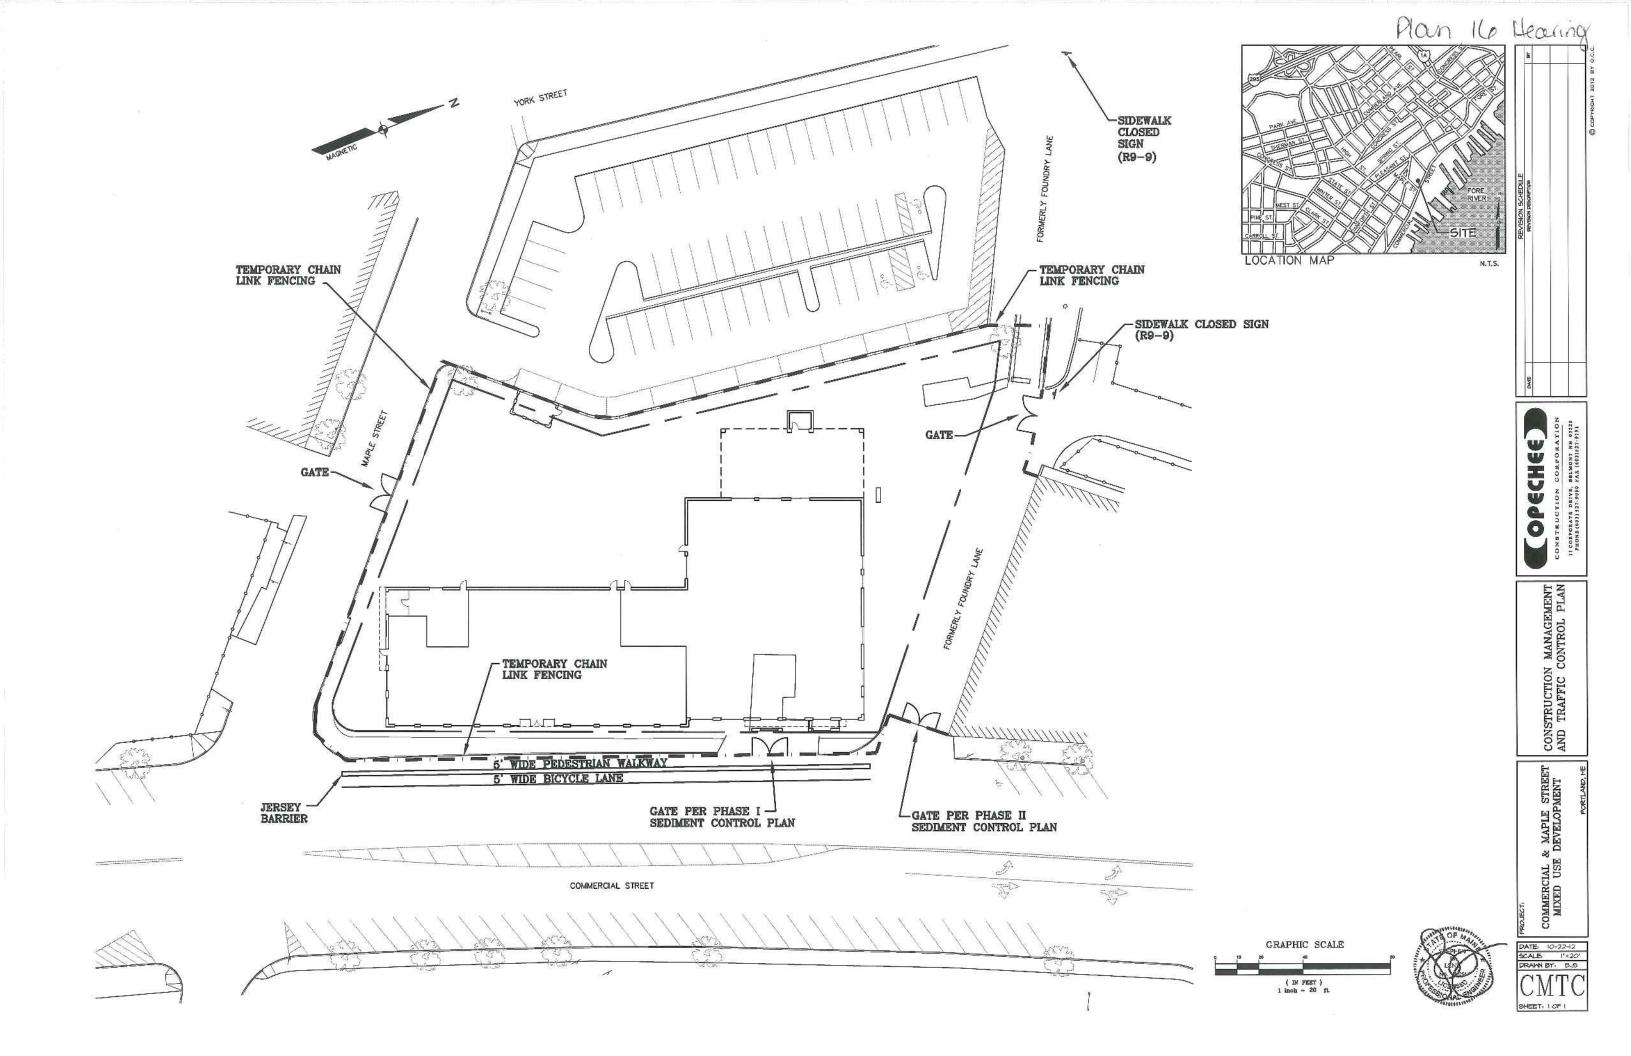

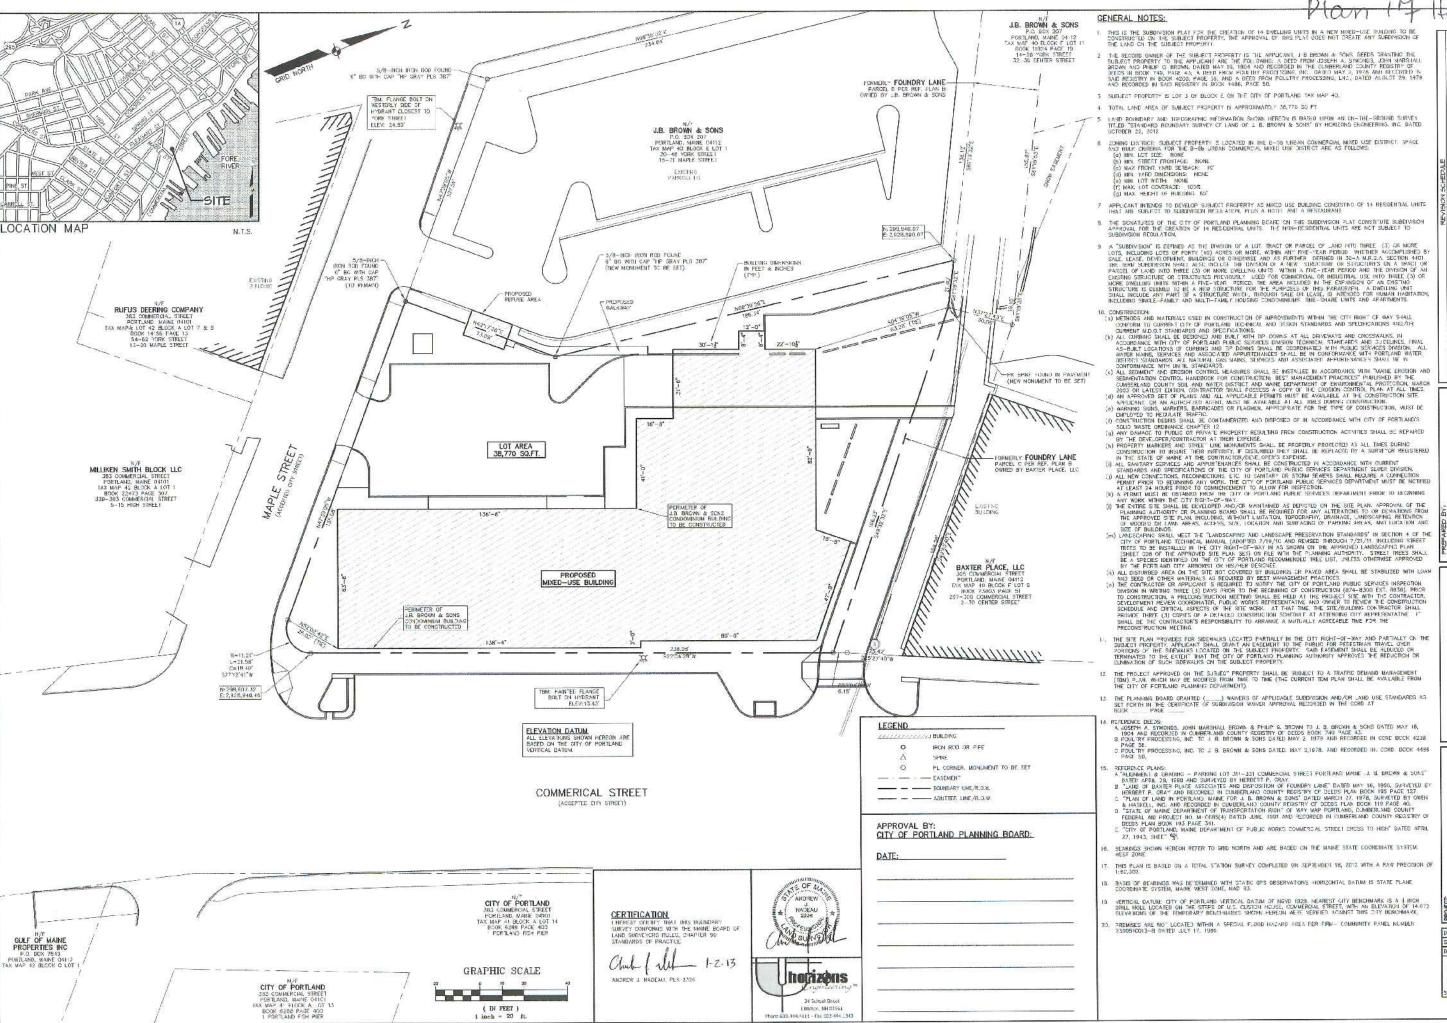

THIS IS THE SUBDIVISION PLATEDS THE CREATION OF 14 DYPLING UNITS IN A NEW MINED-USE BUILDING TO BE CONSTRUCTED ON THE SUBJECT PROPERTY. THE APPROVAL OF THIS PLAT DUES NOT CAFATE ANY SUBDIVISION OF THE LAND ON THE SUBJECT PROPERTY.

2 THE RECORD DINNER OF THE SHRIPET PROPERTY IS THE APPLICANT, J.B. BROWN & SONS DEEDS TRANSHID THE SUBJECT PROPERTY TO THE APPLICANT ARE THE FOLLOWING: A DEED FROM JOSEPH & SMOOLIS, JOHN MARSHILL BROWN AND PHILIP OF BROWN, DALED HAY TIS, ISBN MICHOSED IN THE COMPRETAND COUNTY FORCESTEY OF PHILIPS IN BROKE THE, PRACE S, REED HAY B, THE CONTROL HAY B, 1978 AND RECORDED IN SAME RECORDED IN SOME PROPERTY OF BROWN THE PROPERTY OF T

7 APPLICANT INTENDS TO DEVELOP SUBJECT PROPERTY AS MIXED USE BUILDING CONSISTING OF 14 RESIDENTIAL UNITS THAT ME SUBJECT TO SUBDIMISEN REGULATION, PLUS A HOTEL AND A RESTAURANT.

8 THE SCNATURES OF THE CITY OF PORTLAND PLANNING BOARD ON THIS SUBDIVISION PLAT CONSTITUTE SUBDIVISION APPROVAL FOR THE CREATION OF 14 RESCENTIAL UNITS. THE MON-RESIDENTIAL UNITS ARE NOT SUBJECT TO SUBJURISH REGULATION.

SUBDIVISION REGULATION.

A "SUBDIVISION" IS CEFINED AS THE DIVISION OF A LOT. TRACT OR PARCEL OF AND INTO THREE (3) OR MORE LOTS, INCLIDING LOTS OF FORTY (40) ACRES OR MORE, WITHIN ANY FIVE-TEAR PERIOD. WHETHER ACCOMPLISHED BY SALE, LEAST, DEVELOPMENT, BULDINGS OR COHERWISE AND AS FURTHER OFFINED IN 30-A MELSA. SECTION AND THE LEAST, DEVELOPMENT, BULDINGS OR COHERWISE AND AS FURTHER OFFINED IN 30-A MELSA. SECTION AND PARCEL OF LAWN SHIPLING OR SHIPLING OR HEAD AND THE CONTROL OF THE PARCEL OF LAWN SHIPLING OR SHIPLING OR HEAD AND THE CONTROL OF THE CONTROL OF THE PARCEL OF THE ORDINARY OF THE CONTROL OF THE ORDINARY OF THE PARCELS OF THE PARCENCES OF THE PARCENCES OF THE PARCENCES OF THE PARCENCES OF THE PARCENCES.

INCLUDING SHAPE AND AND THE THE ARM SHIPLING OF THE PARCENCES OF THE PARCENCES OF THE PARCENCES.

THE SITE PLAN PROVIDES FOR SIDEWALKS LOCATED PARTIALLY IN THE CITY RIGHT-OF-WAY AND PARTIALLY ON THE SUBJECT PROPERTY. APPLICANT SHALL GRANT AN EXEMENT TO THE PUBLIC FOR PEDESTRIAN TRAVEL OYELL PROPRIOUS OF THE SIDEWALKS LOCATED ON THE SIDEWALKS LOCATED ON THE SIDEWALT SHALL CHE PRODUCTION OF TERMINATED TO THE EXITE! THAT THE CITY OF PORTLAND PLANNING AUTHORITY APPROVES THE REDUCTION OF ELIMINATION OF SUCH SIDEWALKS ON THE SUBJECT PROPERTY.

12 THE PROJECT APPROVED ON THE SUBJECT PROPERTY SHALL BE SUBJECT TO A TRAFFIC DEHAND MARAGEMENT (TOLL) PLAN, WHICH MAY BE ROOFIED FROM TIME TO TIME (THE CURRENT TOM PLAN SHALL BE AVAILABLE FROM THE CITY OF FORTLAND PLANNING SEPARTMENT).

13. THE PLANNING BOARD GRANTED (____) WAIVERS OF APPLICABLE SURDIVISION AND/OR LAND USE STANDARDS AS SET FORM IN THE CERTIFICATE OF SURDIVISION WAIVER APPROVAL RECORDED IN THE CORD AT BOOK. PAGE

4. RETERRINE DEDS:

A RETERRINE DEDS:

LOSEPH A SYMCHOS, JOHN MARSHALL BROWN & PHILIP G. BROWN TO J. B. BROWN & SCINS DATED MAY 16, 1804 AND RECORDED IN CLIMBERLAND COUNTY REGISTRY OF DEDS BOOK 749 PAGE 41.

B POLITY PROCESSING, INC. TO J. B. BROWN & SONS DATED MAY 2, 1878, AND RECORDED IN CORD. BOOK 4208 PAGE 58.

DOULTRY PROCESSING, INC. TO J. B. BROWN & SONS DATED. MAY 2,1878, AND RECORDED IN. CORD. BOOK 4435 PAGE 50.

SEARINGS SHOWN HEREON REFER TO GRID NORTH AND ARE BASED ON THE MAINE STATE COORDINATE SYSTEM.

THIS PLAN IS BASED ON A TOTAL STATION SURVEY COMPLETED OR SEPTEMBER 18, 2012 WITH A RAW PRECISION OF 1-62-300.

BASIS DE BEARINGS WAS DETERMINED WITH STATIC GPS OBSERVATIONS HORIZONTAL DARIM IS STATE PLANE COORDINATE SYSTEM, MAINE WEST TONE, MAD 83.


PREMISES ARE NOT LOCATED WITHIN A SPECIAL FLOOD HAZARD AREA PER FRIM—"COMMUNITY PANEL NUMBER 2500510013—B DATED JULY 17- 1096


ECH C O


> ON SUBDIVISI PLAN

MENED USE OF LAND (COMMERCIA PORTLAND)

16-22-12 DRAWN BY: UJS

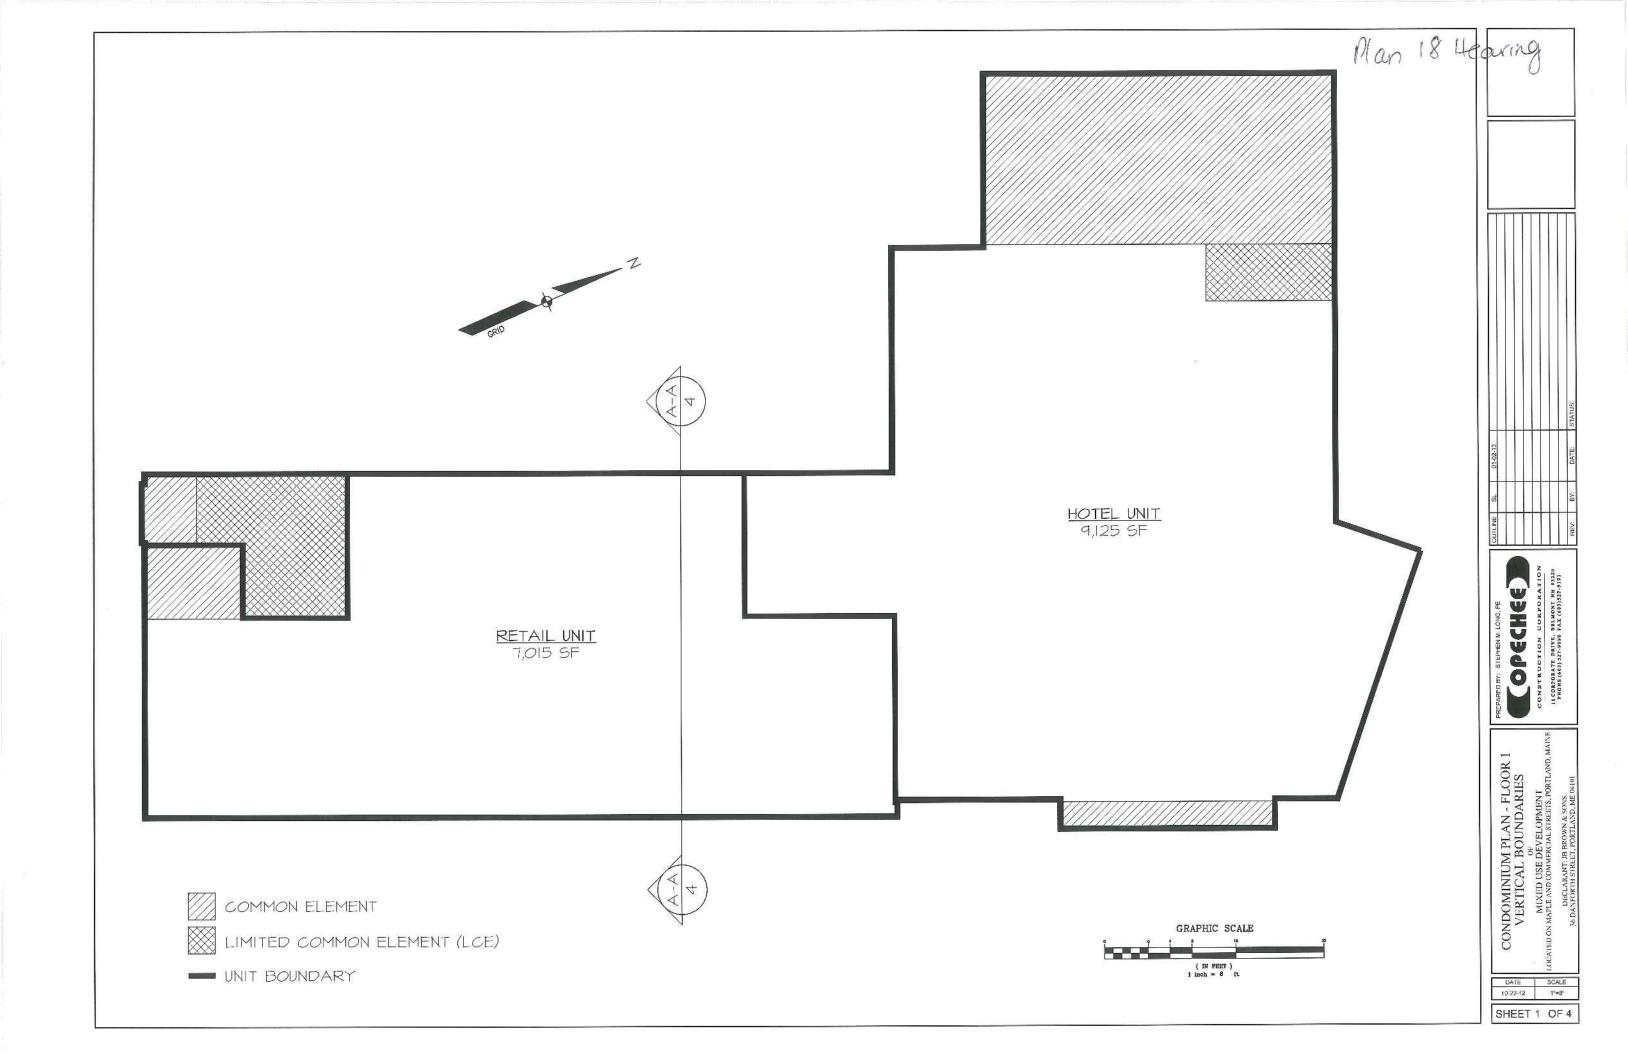

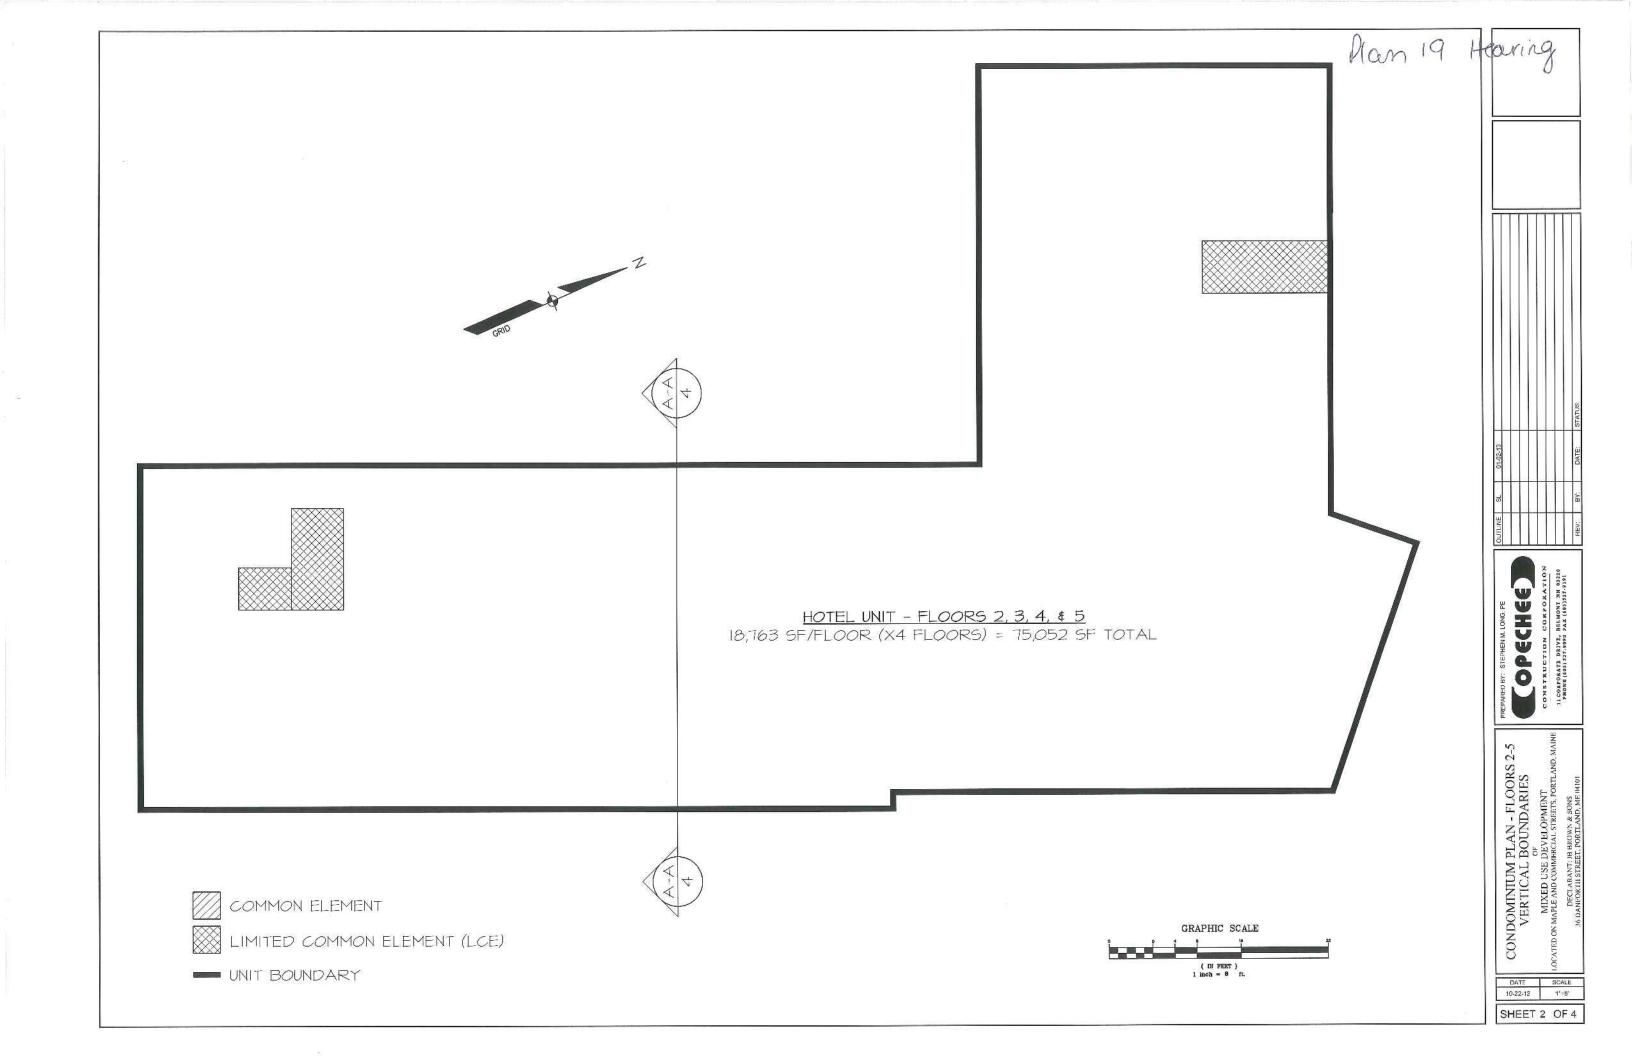

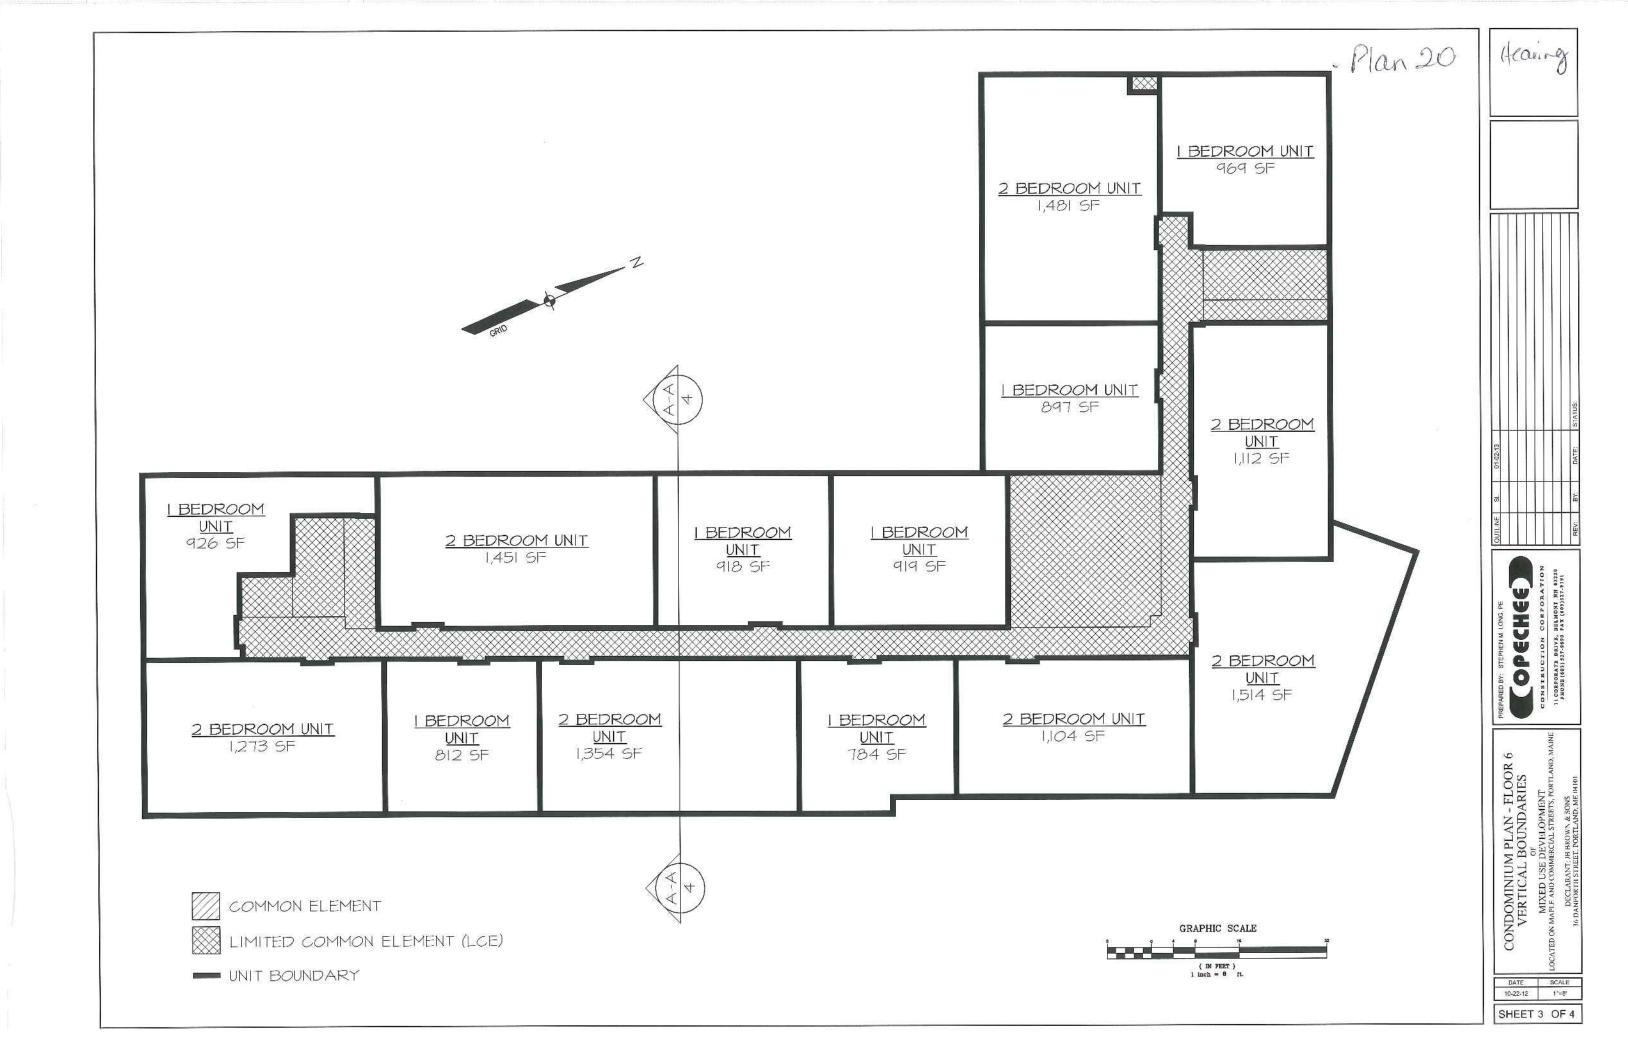

Plan 21


TOP OF RESIDENCE CEILING ELEV. = 76.0' RESIDENCE UNITS RESIDENCE - 6TH FLOOR ELEV. = 68.0' HOTEL UNIT HOTEL UNIT - 5TH FLOOR ELEV. = 58.0' HOTEL UNIT HOTEL UNIT - 4TH FLOOR ELEV. = 48.0' HOTEL UNIT HOTEL UNIT - 3RD FLOOR ELEV. = 38.0' HOTEL UNIT HOTEL UNIT - 2ND FLOOR ELEV. = 28.0' RETAIL UNIT RETAIL UNIT - IST FLOOR ELEV. = 14.0' SECTION A-A

4 4 4

KEY PLAN

NOT TO SCALE

1" = 8'

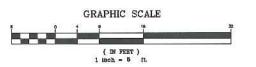

Hearing

OUILINE SI. 01-02-13

REV. BY. DATE: STATUS:



CONDOMINIUM PLAN HORIZONTAL BOUNDARIES

OF
MIXED USE DEVELOPMENT

DECLARAND COMMERCIAL STREETS, PORTLAND, MAIN

DATE SCALE 10:22-12 1"=8"

SHEET 4 OF 4

H **医** Plan 22 Hearing



EXTERIOR BUILDING ELEVATIONS

COMMERCIAL & MAPLE STREET MIXED USE DEVELOPMENT

DATE: 12-10-12 SCALE: SEE PLAN DRAWN BY:





YORK STREET ELEVATION



FOUNDRY LANE ELEVATION

CONSTRUCTION CORPORATION
II CORPORATE DRIVE, BELNONT 3H 53238
PHONE (603)527-9949 FAX (603)527-9949 OPECHEE

EXTERIOR BUILDING ELEVATIONS

COMMERCIAL & MAPLE STREET MIXED USE DEVELOPMENT

DATE: 12-10-12 SCALE: SEE PLAN DRAWN BY:



View Toward Foundry Lane

January 2, 2013







View From South

January 2, 2013








View From East

January 2, 2013

Courtyard by Marriott



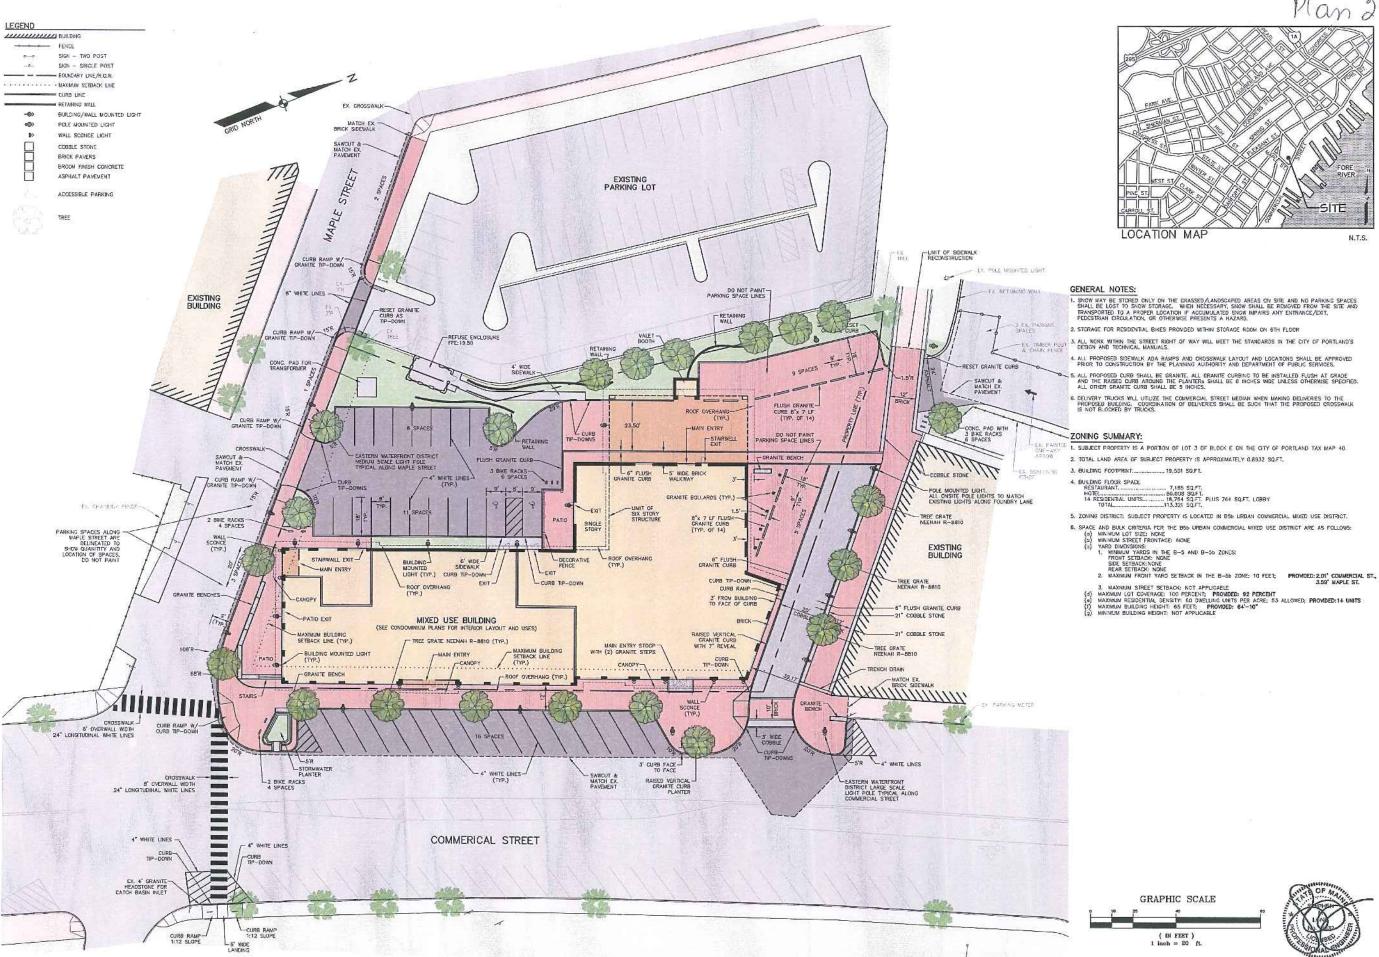


Plan 27 Hearing N.T.S.

COMMERCIAL & MAPLE STREET MIXED USE DEVELOPMENT

DATE: 10-22-12 SCALE: 1"=20" DRAMN BY: BJS

ONSTRUCTION CORFORATION ILCORPORATE DRIVE, BELMONT NII 03220 PHONE (603) 527-9990 PAX (603)527-9191 GE. OPECH

PLAN SITE

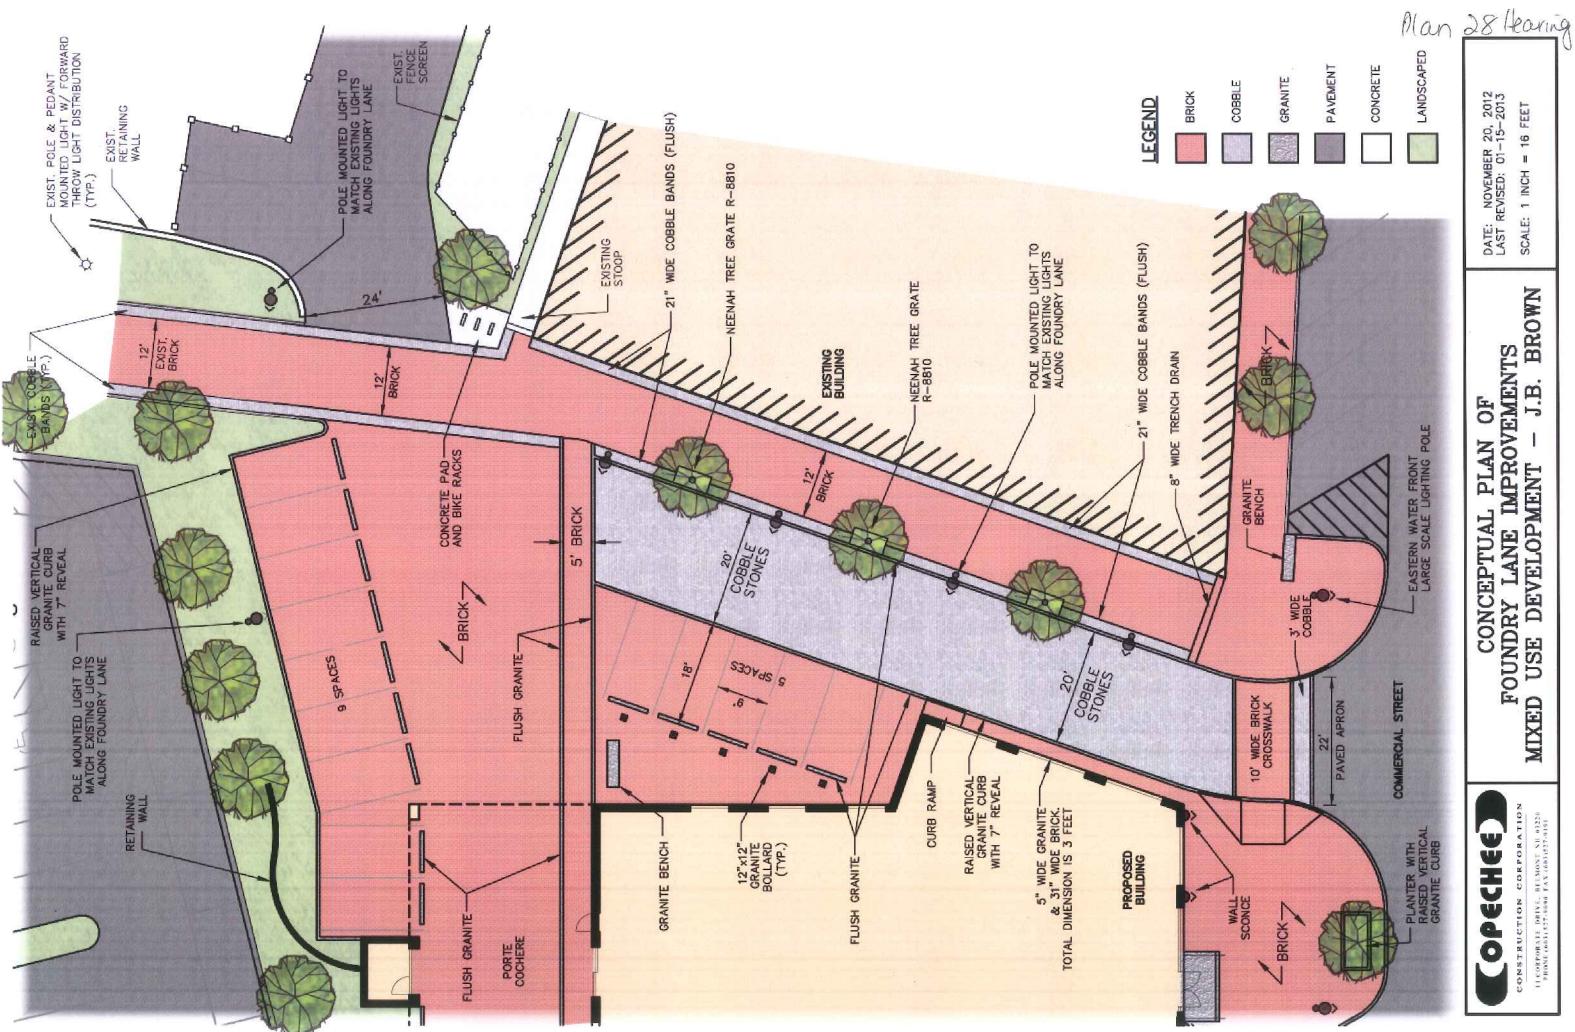

OPECHEE

BROWN CONCEPTUAL PLAN OF FOUNDRY LANE IMPROVEMENTS MIXED USE DEVELOPMENT - J.B. BF

DATE: NOVEMBER 20, 2012 LAST REVISED: 01-15-2013 SCALE: 1 INCH = 16 FEET