DISPLAY THIS CARD ON PRINCIPAL FRONTAGE OF WORK



CITY OF PORTLAND BUILDING PERMIT



This is to certify that J.B. BROWN & SONS

Job ID: 2012-04-3692-ALTCOMM

Located At 20 DANFORTH ST

CBL: 040- D-001-001

has permission to Renovate 3rd floor office space for tenant fit up

provided that the person or persons, firm or corporation accepting this permit shall comply with all of the provisions of the Statues of Maine and of the Ordinances of the City of Portland regulating the construction, maintenance and use of the buildings and structures, and of the application on file in the department.

Notification of inspection and written permission procured before this building or part thereof is lathed or otherwise closed-in. 48 HOUR NOTICE IS REQUIRED. A final inspection must be completed by owner before this building or part thereof is occupied. If a certificate of occupancy is required, it must be

Fire Prevention Officer

Code Enforcement Officer / Plan Reviewer

THIS CARD MUST BE POSTED ON THE STREET SIDE OF THE PROPERTY PENALTY FOR REMOVING THIS CARD



Certificate of Occupancy



CITY OF PORTLAND, MAINE

Department of Planning and Urban Development
Building Inspections Division

Location: 20 DANFORTH ST

CBL: 040- D-001-001

Issued to: BROWN J B & SONS

Date Issued: 6/15/2012

This is to tertify that the building, premises, or part thereof, at the above location, built-altered-changed as to use under Building Permit No. 2012-04-3692-ALTCOMM, has had a final inspection, has been found to conform substantially to the requirements of the Building Code and the Land Use Code of the City of Portland, and is hereby approved for occupancy or use, limited or otherwise, as indicated below.

PORTION OF BUILDING OR PREMISES

APPROVED OCCUPANCY

SUITE 304

USE GROUP B, OFFICE TYPE 2-B IBC 2009

Limiting Conditions; This Temporary Certificate of Occupancy expires on, July 13 2012

Approved:

June 15, 2012

(Date)

Inspector

Inspections Division Director

Notice: This certificate identifies the legal use of the building or premises, and ought to be transferred from owner to owner upon the sale of the property.

City of Portland, Maine - Building or Use Permit Application

389 Congress Street, 04101 Tel: (207) 874-8703, FAX: (207) 8716

Job No: 2012-04-3692-ALTCOMM	Date Applied: 4/4/2012		CBL: 040- D-001-001				
Location of Construction: 20 DANFORTH ST – suite 304	Owner Name: J.B.BROWN & SONS			Owner Address: 36 DANFORTH STREET PORTLAND, ME 04101			
Business Name:	Contractor Name: PC CONSTRUCTION			Contractor Address: 131 PRESUMPSCOT STREET, PORTLAND, ME 04103			
Lessee/Buyer's Name: Big Room Studios – suite 304	Phone:		Permit Type: BLDG ALT			Zone: B-3	
Past Use: Offices	Proposed Use: Same: Offices – tenant fit-up with alterations as per plans 3rd FLOOR		Cost of Work: \$25,000.00 Fire Dept: Approved \(\omega / \conditions \) Denied N/A Signature: \(\omega A \omega \omega / \omega \omega \omega / \omega \omeg			CEO District: Inspection; Use Group: Type: 2 B DA - 2009 Signature:	
Proposed Project Description construct 2 offices	1:		Pedestrian Activ	ities District (P.A.I		4/25/12	
Permit Taken By: Gayle		Special 7	one or Reviews	Zoning Appro		reservation	
 This permit application does not preclude the Applicant(s) from meeting applicable State and Federal Rules. Building Permits do not include plumbing, septic or electrial work. Building permits are void if work is not started within six (6) months of the date of issuance. False informatin may invalidate a building permit and stop all work. 		Special Zone or Reviews Shoreland Wetlands Flood Zone Subdivision Site Plan Maj _Min _MM Date: Whith Conde		Variance Miscellaneous Conditional Use Interpretation Approved Denied Date:	Not in Do	Not in Dist or Landmark Does not Require Review Requires Review Approved Approved w/Conditions	
ereby certify that I am the owner of r owner to make this application as hi application is issued, I certify that the enforce the provision of the code(s) a	is authorized agent and I agree the code official's authorized rep	to conform to	all applicable laws of the	his jurisdiction. In addi	tion, if a permit for wo	ork described in	

5-15-12 DWM/BKL Eric G15-4974 close-in

6-6-12 DWM/BKL/LTWAllace Eric Final Elect. Fail

Fire fall Seal: Thr mech An, Exit stair enclosure; Sprinkler complancelt.

Blds Sail Fire stop plumbing, Plans + Report for structural work

combastion air to Mech Rm.

6-13-12 DWA/BKL/VOhn Marsell Joel Bldg, Fire, + Elec Fall. Bldg Fireston flumbing. Fire Sprinkler compliance br.

BUILDING PERMIT INSPECTION PROCEDURES

Please call 874-8703 or 874-8693 (ONLY)

or email: buildinginspections@portlandmaine.gov

With the issuance of this permit, the owner, builder or their designee is required to provide adequate notice to the city of Portland Inspections Services for the following inspections. Appointments must be requested 48 to 72 hours in advance of the required inspection. The inspection date will need to be confirmed by this office.

- Please read the conditions of approval that is attached to this permit!! Contact this office if you have any questions.
- Permits expire in 6 months. If the project is not started or ceases for 6 months.
- If the inspection requirements are not followed as stated below additional fees may be incurred due to the issuance of a "Stop Work Order" and subsequent release to continue.

Close In Elec/Plmb/Frame prior to insulate or gyp

Final Inspection

The project cannot move to the next phase prior to the required inspection and approval to continue, REGARDLESS OF THE NOTICE OF CIRCUMSTANCES.

IF THE PERMIT REQUIRES A CERTIFICATE OF OCCUPANCY, IT MUST BE PAID FOR AND ISSUED TO THE OWNER OR DESIGNEE BEFORE THE SPACE MAY BE OCCUPIED.



PORTLAND MAINE

Strengthening a Remarkable City, Building a Community for Life . www.portlandmaine.gov

Acting Director of Planning and Urban Development Gregory Mitchell

Job ID: 2012-04-3692-ALTCOMM

Located At: 20 DANFORTH ST

CBL: 040- D-001-001

Conditions of Approval:

Zoning

1. Separate permits shall be required for any new signage.

2. This permit is being approved on the basis of plans submitted. Any deviations shall require a separate approval before starting that work.

3. ANY exterior work requires a separate review and approval thru Historic Preservation. This property is located within an Historic District.

Fire

- 1. All construction shall comply with City Code Chapter 10.
- 2. This permit is being approved on the basis of the plans submitted. Any deviation from the plans would require amendments and approval.
- 3. Any Fire alarm or Sprinkler systems shall be reviewed by a licensed contractor(s) for code compliance. Compliance letters are required.
- 4. A separate Fire Alarm Permit is required for new systems; or for work effecting more than 5 fire alarm devices; or replacement of a fire alarm panel with a different model. This review does not include approval of fire alarm system design or installation.
- A separate Suppression System Permit is required for all new suppression systems or sprinkler work effecting more than 20 heads. This review does not include approval of sprinkler system design or installation.
- Emergency lights and exit signs are required. Emergency lights and exit signs are required to be labeled in relation to the panel and circuit and on the same circuit as the lighting for the area they serve.
- 7. Any cutting and welding done will require a Hot Work Permit from Fire Department.

Building

- Application approval based upon information provided by applicant. Any deviation from approved plans requires separate review and approval prior to work.
- 2. All penetrations through rated assemblies must be protected by an approved firestop system installed in accordance with ASTM E 814 or UL 1479, per IBC 2009 Section 713.
- Separate permits are required for any electrical, plumbing, sprinkler, fire alarm, HVAC systems, heating appliances, including pellet/wood stoves, commercial hood exhaust systems and fuel tanks. Separate plans may need to be submitted for approval as a part of this process.

2012 04 3692

General Building Permit Application

If you or the property owner owes real estate or personal property taxes or user charges on any property within the City, payment arrangements must be made before permits of any kind are accepted.

		15-5
Location/Address of Construction: 20	Danforth Street Sui	te 304 11 1
Total Square Footage of Proposed Structure/A	rea Square Footage of Lot 22086 S	+ HISTO
Tax Assessor's Chart, Block & Lot	Applicant *must be owner, Lessee or Buyer	* Telephone:
Chart# 40 Block# D Lot#	Name J. B. Brown ? Sons	774-5908
	Address 36 Danforth St.	
	City, State & Zip Portland, Me 04	101
Lessee/DBA (If Applicable)	Owner (if different free Captize)	Cost Of
Big Room Studios	Name	Work: \$ 25,000
2.9	Address APR 0 4 2012	C of O Fee: \$
	City, State & Dept. of Building Inspections	Total Fee: \$ 270
	City of Portland Maine	
Current legal use (i.e. single family)	ffice	
If vacant what was the previous use?	TT i CL	
Proposed Specific use:	TAILE	
Is property part of a subdivision?	If yes, please name	- Flore
Project description: remove one 1	Merror well (32 +F), cons	trust 2 strus,
Project description: remove one 1 one conference room, 3 c	losets, and Krchenette are	~ .
Contractor's name: PC Co.	astruction	
Address: 131 Presumpscot		
City, State & Zip Portland, Me	04(33 T	elephone: 874 - 2323
Who should we contact when the permit is read	dy: Vin Veroneau Te	elephone: 774-5408
Mailing address: Some : Som		
Please submit all of the information	outlined on the applicable Checkli	st Failure to

Please submit all of the information outlined on the applicable Checklist. Failure to do so will result in the automatic denial of your permit.

In order to be sure the City fully understands the full scope of the project, the Planning and Development Department may request additional information prior to the issuance of a permit. For further information or to download copies of this form and other applications visit the Inspections Division on-line at www.portlandmaine.gov, or stop by the Inspections Division office, room 315 City Hall or call 874-8703.

I hereby certify that I am the Owner of record of the named property, or that the owner of record authorizes the proposed work and that I have been authorized by the owner to make this application as his/her authorized agent. I agree to conform to all applicable laws of this jurisdiction. In addition, if a permit for work described in this application is issued, I certify that the Code Official's authorized representative shall have the authority to enter all areas covered by this permit at any reasonable hour to enforce the provisions of the codes applicable to this permit.

Signature: 🗸	one	Date:	4/4	/2012	

Suite 304

TENANT SPACE 30 DANFORTH STREET PORTLAND ME 04101

OWNER: J.B. BROWN & SONS 36 DANFORTH ST. PORTLAND ME 04101


LIST OF DRAWINGS:

A0.0 TITLE, KEY PLAN

A0.1 GENERAL NOTES

A0.2 DOORS, PARTITIONS, ETC.

A1.3 THIRD FLOOR PARTIAL PLAN

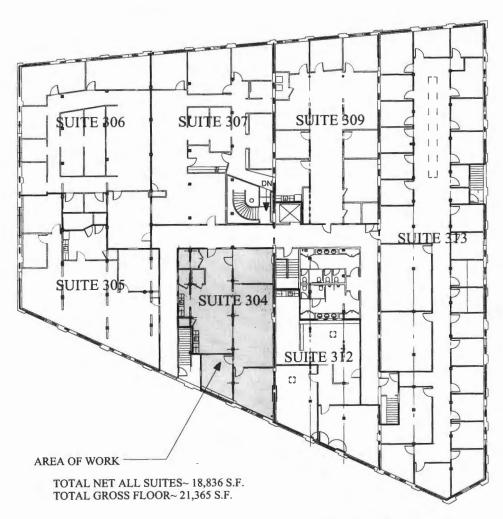



THIRD FLOOR KEY PLAN

SCALE: 1/32" = 1'-0"

BUILDING PERMIT SET

Project Title Suite 304	Tenant Space	J.B. Brown & Sons, Inc. 36 Danforth Street Portland ME 04101	Drawing Title TITLE	E, KEY P	LAN		Drawing Number
hell	Copyright 2012 Michae	l Belleau Architect	Date:	4/02/12	Scale:	1/32"= 1'-0"	AU.U
bell	61 Pleasant Street Portland www.michaelbelleau.com	ME 04101 (207)874-7668	Project Number:	12.02	Reference:	NONE	

GENERAL NOTES:

- These drawings are property of Michael Belleau Architect and not to be copied or reproduced in part or whole. Copyright 2012 Michael Belleau Architect
- Do not scale these drawings; these drawings are approximate; contractor to verify all dimensions in field; all dimensions shown are clear dimensions- not to studs.
- Codes

7.

Zone: B3

Construction: existing 4 story building Type II B (brick exterior bearing walls with heavy timber posts, beams, joists) from IBC table 601 so no fire resistance rating requirements for building elements.

Occupancy: Business

Adjacent Occupancies: Business; no fire separation required from table NFPA 6.1.14.4.1(b) Above Occupancies: Business; no fire separation required from table NFPA 6.1.14.4.1(b)

Below Occupancies: Business; no fire separation required from table NFPA 6.1.14.4.1(b)

Hallway fire separation: NFPA 38.3.6.1(3) no requirement because building is sprinkled. Also follows 7.1.3.1 exceptions both (1) and (2). Also, IBC table 1016.1 says 0 rating corridor if sprinkled. Existing condition appears to be smoke barrier only between tenants and halls with some 20 min. rated doors. Doors to hall to be smokeproof. Occupant load: 100 s.f./person from NFPA table 7.3.1.2 & ~1,640 s.f. so less than 50 person occupancy (17).

Therefore doors from tenant space swing in per 7.2.1.4.2.

Accessibility requirements: This project should meet ADAAG requirements for access. Electrician responsible for all ADAAG requirements for signage, alarms, etc.

 These drawings are for obtaining building permit. Architect not liable for any structural, mechanical, plumbing, electrical, etc. work.

6. Electrician to wire per tenant needs and to do so per all local, state, and national relevant codes including life safety (egress lighting and signs, etc.).

All elec., plumbing, sprinkler, fire alarm, hvac systems of any kind, etc. to be per all local, state, and federal laws and

codes, etc. and each trade to submit to city for any and all permits.

8. Demolition: contractor to shore and brace all relevant areas prior to any demolition and is responsible for all safety issues. All materials to be disposed of according to all applicable laws local, state and federal. Contractor to verify with owner regarding saving any removed items.

9. See owner for base, floor, paint, etc. finishes.

BUILDING PERMIT SET

J.B. Brown & Sons, Inc. Drawing Title Project Title 36 Danforth Stree Suite 304 Tenant Space Portland ME 04101 GENERAL NOTES AS NOTED Copyright 2012 Michael Belleau Architect 4/02/12 Date: 61 Pleasant Street Portland ME 04101 (207)874-7668 www.michaelbelleau.com Reference: Project Number: 12.02 NONE

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Receipts Details:

Tender Information: Check, BusinessName: JB Brown & Sons, Check Number: 4584

Tender Amount: 270.00

Receipt Header:

Cashier Id: gguertin Receipt Date: 4/4/2012 Receipt Number: 42559

Receipt Details:

Referance ID:	5948	Fee Type:	BP-Constr
Receipt Number:	0	Payment Date:	
Transaction Amount:	270.00	Charge Amount:	270.00

Job ID: Job ID: 2012-04-3692-ALTCOMM - construct 2 offices

Additional Comments: 20 Danfort

Thank You for your Payment!

GENERAL NOTES:

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 Copyright 2012 Michael Belleau Architect
- 2. Do not scale these drawings; these drawings are approximate; contractor to verify all dimensions in field; all dimensions shown are clear dimensions- not to studs.
- Codes

Zone: B3

Construction: existing 4 story building Type II B (brick exterior bearing walls with heavy timber posts, beams, joists) from IBC table 601 so no fire resistance rating requirements for building elements.

Occupancy: Business

Adjacent Occupancies: Business; no fire separation required from table NFPA 6.1.14.4.1(b) Above Occupancies: Business; no fire separation required from table NFPA 6.1.14.4.1(b)

Below Occupancies: Business; no fire separation required from table NFPA 6.1.14.4.1(b)


Hallway fire separation: NFPA 38.3.6.1(3) no requirement because building is sprinkled. Also follows 7.1.3.1 exceptions both (1) and (2). Also, IBC table 1016.1 says 0 rating corridor if sprinkled. Existing condition appears to be smoke barrier only between tenants and halls with some 20 min. rated doors. Doors to hall to be smokeproof. Occupant load: 100 s.f./person from NFPA table 7.3.1.2 & ~1,640 s.f. so less than 50 person occupancy (17). Therefore doors from tenant space swing in per 7.2.1.4.2.

Accessibility requirements: This **project should meet ADAAG requirements** for access. Electrician responsible for all ADAAG requirements for signage, alarms, etc.

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- 6. Electrician to wire per tenant needs and to do so per all local, state, and national relevant codes including life safety (egress lighting and signs, etc.).
- 7. All elec., plumbing, sprinkler, fire alarm, hvac systems of any kind, etc. to be per all local, state, and federal laws and codes, etc. and each trade to submit to city for any and all permits.
- 8. Demolition: contractor to shore and brace all relevant areas prior to any demolition and is responsible for all safety issues. All materials to be disposed of according to all applicable laws local, state and federal. Contractor to verify with owner regarding saving any removed items.
- 9. See owner for base, floor, paint, etc. finishes.

BUILDING PERMIT SET

J.B. Brown & Sons, Inc. Drawing Title Drawing Number 36 Danforth Street Portland ME 04101 Suite 304 Tenant Space GENERAL NOTES Copyright 2012 Michael Belleau Architect Date: 4/02/12 Scale: AS NOTED 61 Pleasant Street Portland ME 04101 (207)874-7668 Project Number: Reference: www.michaelbelleau.com 12.02 **NONE**

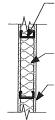

NEW 3 5/8" MTL STUDS SIZE GAUGE PER MANUF. RECOMM. AND SPACE 16" O.C.;


FILL WITH FULL WIDTH ACOUSTICAL BATTS.

1/2" PAINTED GPDW BOTH SIDES-LEAVE 1/4" GAP AT EDGES AT BRICK OR STRUCTURE AND SEAL WITH ACOUSTICAL SEALANT



ALL PARTITIONS U.O.N.

SOUND PROOF- STAGGER OUTLETS ON OPP. SIDES, ETC. AND TEST AFTER INSTALLATION FOR SOUND PROOF.

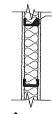


NEW 3 5/8" MTL STUDS SIZE GAUGE PER MANUF. RECOMM. AND SPACE 16" O.C.; 5/8" F.R. GPDW BOTH SIDES; FILL WITH FULL BATT INSUL.

1 HOUR FIRE RATED PARTION

(NOT USED UNLESS OWNER NEEDS TO PATCH MECHANICAL ROOM OR WALLS BETWEEN TENANT SPACES THEN USE THIS TYPE)

PARTITION TYPES:

NOTE: SEAL ALL WALLS AT COLUMNS, BEAMS & DECK TIGHT TO MAKE SMOKE PROOF. ALL WALLS TO GO UP TO DECK THEREFORE, INFILL BETWEEN JOISTS IF NECESSARY. USE ACOUSTICAL SEALANT IF NO FIRE RATING; USE FIRE RETARDANT SEALANT AT HALLS AND ANY RATED WALL.

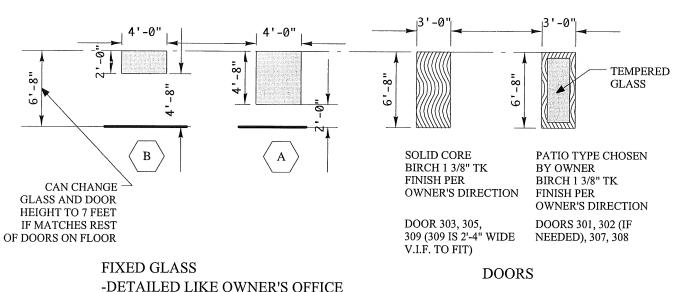


DOOR AND FIXED GLASS NOTES:

- 1. ALL DOORS IN HM FRAME (CHECK WITH OWNER FOR ENTRY DOOR 301 FRAME WHICH MAY BE WOOD FRAME & TRIM TO MATCH OTHERS IN HALLWAY).
- 2. DOOR 301 (ENTRY FROM HALL) MUST HAVE CLOSER.
- 3. ALL DOORS HARDWARE TO BE MATT SILVER FINISH; LEVER HANDLES; 3 BUTTS; LOCKSETS PER OWNERS DIRECTION; ALL DOORS CAN OPEN FROM INSIDE WITHOUT KEY EVEN WHEN LOCKED; ALL DOORS ARE 3' WIDE (EXCEPT 309- 2'-4" V.I.F.).
- 4. ALL DOORS TO HAVE SOUND SEAL STRIPPING ALL EDGES (SMOKEPROOF STRIPPING AT DOORS TO HALLWAYS).
- 5. ANY GLAZING IS TO MATCH OWNERS OFFICES WITH SAME TRIM, ETC.
- 6. ALL THRESHOLDS TO BE ACCESSIBLE (1/2" MAX.)
- 7. SEE OWNER FOR BASE, FLOOR, PAINT, ETC. FINISHES.

BUILDING PERMIT SET

Project Title		J.B. Brown & Sons, Inc. 36 Danforth Street	Drawing Title				Drawing Number
Suite 304	Fenant Space	Portland ME 04101	DOOF	RS, WIND	OWS,	ETC.	100
bell		el Belleau Architect	Date:	4/02/12	Scale:	AS NOTED	AU.Z
l ĕău	www.michaelbelleau.com	i ME 04101 (207)874-7668	Project Number:	12.02	Reference:	NONE	

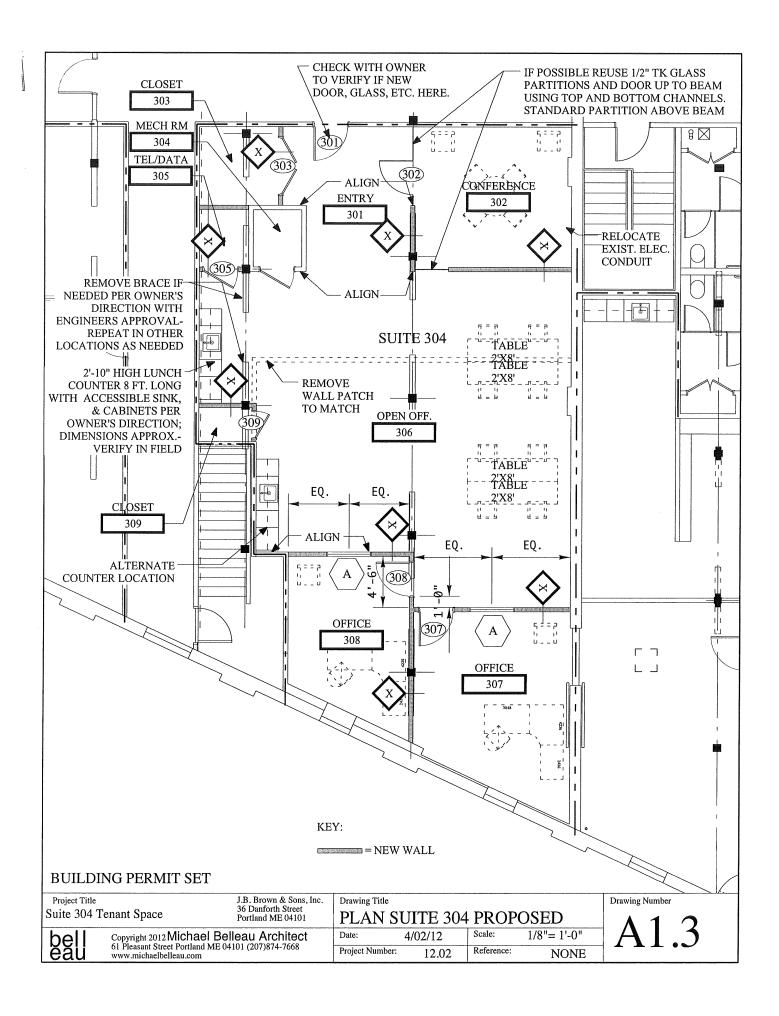



PORTLAND MAINE

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Receipts Details:

Tender Information: Check, BusinessName: JB Brown & Sons, Check Number: 4584

Tender Amount: 270.00

Receipt Header:

Cashier Id: gguertin Receipt Date: 4/4/2012 Receipt Number: 42559

Receipt Details:

Referance ID:	5948	Fee Type:	BP-Constr
Receipt Number:	0	Payment Date:	
Transaction Amount:	270.00	Charge Amount:	270.00

Job ID: Job ID: 2012-04-3692-ALTCOMM - construct 2 offices

Additional Comments: 20 Danfort

Thank You for your Payment!

FIRE ALARM AND EMERGENCY COMMUNICATION SYSTEM INSPECTION AND TESTING FORM

To be completed by the system inspector or tester at the time of the inspection or test. It shall be permitted to modify this form as needed to provide a more complete and/or clear record.

Insert N/A in all unused lines.

Attach additional sheets, data, or calculations as necessary to provide a complete record.

	Date of this inspection or test: June 7, 2012	Time	of inspection or test:	07:00 Hrs
1.	PROPERTY INFORMATION			
	Name of property: 26 - 30 Danforth Street			
	Address: 26 - 30 Danforth Street Portland,	Maine		
	Description of property: Three Story Brick			
	Occupancy type: Multiple business occupanc	y		
	Name of property representative: Trish Weim	er		
	Address: 36 Danforth Street			
	Phone: 207-774-5908 Fax:		E-mail:	
	Authority having jurisdiction over this property	r: Portland Fire Depart	ment	
	Phone: Fax:		E-mail:	
2.	INSTALLATION, SERVICE, AND TEST	ING CONTRACTOR I	NFORMATION	
	Service and/or testing organization for this equ	ipment: Norris Inc.		
	Address: 2257 West Broadway So. Port	land, Maine		
	Phone: 207-883-3473 Fax:	207-879-0540	E-mail: www.norri	sic.com
	Service technician or tester: Tim Johnson			
	Qualifications of technician or tester: Maste	r Electrician		
	A contract for test and inspection in accordance	with NFPA standards is	in effect as of:	
	The contract expires: Contr	act number:	Frequency of tes	ts and inspections:
	Monitoring organization for this equipment:	HSMC		
	A contract for test and inspection in accordance	with NFPA standards is	in effect as of:	
	Address:			
	Phone: Fax:		E-mail:	
	Entity to which alarms are retransmitted:		Phone	
3.	TYPE OF SYSTEM OR SERVICE			
	☑ Fire alarm system (nonvoice)			
	☐ Fire alarm with in-building fire emergency	voice alarm communication	on system (EVACS)	
	☐ Mass notification system (MNS)			
	☐ Combination system, with the following con	mponents:		
	☐ Fire alarm ☐ EVACS ☐ M	NS 🔲 Two-way, in	-building, emergency c	ommunication system
	☐ Other (specify):			

NEPA 72. Fig. 14 6 2 4 (p. 1 of 11)

3. TYPE OF SYSTEM OR SERVICE (continued) Additional description of system(s): NFPA 72 edition: 3.1 Control Unit Model number: Fire Warden 100 Manufacturer: Notifier □ This system does not incorporate an MNS 3.2 Mass Notification System 3.2.1 System Type: ☐ In-building MNS—combination ☐ In-building MNS—stand-alone ☐ Wide-area MNS ☐ Distributed recipient MNS ☐ Other (specify): 3.2.2 System Features: ☐ Wide-area MNS to regional national alerting interface ☐ MNS ACU only ☐ Combination fire alarm/MNS ☐ Wide-area MNS to DRMNS interface ☐ Direct recipient MNS (DRMNS) ☐ Local operating console (LOC) ☐ Wide-area MNS to high-power speaker array (HPSA) interface ☐ In-building MNS to wide-area MNS interface ☐ Other (specify): 3.3 System Documentation Man owner's manual, a copy of the manufacturer's instructions, a written sequence of operation, and a copy of the record Electrical Room at fire panel record drawings are stored on site. Location: ☐ This system does not have alterable site-specific software. 3.4 System Software Software last updated on: Software revision number: \square A copy of the site-specific software is stored on site. Location: 4. SYSTEM POWER 4.1 Control Unit 4.1.1 Primary Power Control panel amps: 3.0 amperes Input voltage of control panel: 120 Volts ☑ This system does not have a generator. 4.1.2 Engine-Driven Generator Location of generator: Type of fuel: Location of fuel storage: ☐ This system does not have UPS. 4.1.3 Uninterruptible Power System Equipment powered by a UPS system: Location of UPS system: Calculated capacity of UPS batteries to drive the system components connected to it:

In standby mode (hours):

In alarm mode (minutes):

4. SYSTEM POWER (continued)

4.1.4 Batteries					
Location: inside fire panel	Type: sealed	Nominal voltage:	12	Amp/hou	ur rating:
Calculated capacity of batteries	to drive the system:				
In standby mode (hours):		In alarm mode (r	minutes):		
☐ Batteries are marked with d					
4.2 In-Building Fire Emerge		nunication System or	Mass Notifica	tion Syster	n
☐ This system does not have a	in EVACS or MNS.				
4.2.1 Primary Power					
Input voltage of EVACS or M	NS panel:	EVACS	S or MNS pane		
4.2.2 Engine-Driven General	tor		☐ This	system does	s not have a generator.
Location of generator:					
Location of fuel storage:		Type of			
4.2.3 Uninterruptible Power	System		⊠ T	his system	does not have a UPS.
Equipment powered by a UPS	system:				
Location of UPS system:					
Calculated capacity of UPS ba	tteries to drive the system	m components connecte	ed to it:		
In standby mode (hours):		In alarm m	ode (minutes):		
4.2.4 Batteries					
Location:	Туре:	Nominal voltage:		Amp/ho	our rating:
Calculated capacity of batterie	es to drive the system:				
In standby mode (hours):		In alarm mode ((minutes):		
☐ Batteries are marked with	date of manufacture.				
4.3 Notification Appliance P	ower Extender Panels	Tì	nis system doe	s not have p	power extender panels.
4.3.1 Primary Power					
Input voltage of power extend	ler panel(s): 120 volts	Powe	r extender pan	el amps:	3.2 amps
4.3.2 Engine-Driven Genera	itor		⊠ This	system do	es not have a generator.
Location of generator:					
Location of fuel storage:		Type of	fuel:		
4.3.3 Uninterruptible Powe	r System		\boxtimes	This systen	n does not have a UPS.
Equipment powered by a UPS	S system:				
Location of UPS system:					
Calculated capacity of UPS b	atteries to drive the syste	em components connect	ted to it:		
In standby mode (hours):		In alarm r	mode (minutes)):	

4. SYSTEM POWER (continued)

	4.3.4 Batteries						
	Location:	Туре:		Nominal voltage:		Amp/hour	rating:
	Calculated capacity of batteries t	o drive the s	ystem:				
	In standby mode (hours):			In alarm mode (r	ninutes):		
	☐ Batteries are marked with date	e of manufac	cture.				
5.	ANNUNCIATORS				☐ This system	does not	have annunciators.
	5.1 Location and Description of	of Annuncia	tors				
	Annunciator 1: 30 Danforth S	treet Maine	entrance				
	Annunciator 2: York Street lo	wer level ent	rance				
	Annunciator 3:						
6.	NOTIFICATIONS MADE PR	RIOR TO T	ESTING				
	Monitoring organization	Contact:	HSMC			Time:	07:00
	Building management	Contact:	J.B. Brown	Assc.		Time:	07:00
	Building occupants	Contact:				Time:	
	Authority having jurisdiction	Contact:	Portland Fi	re Dept.		Time:	07:00
	Other, if required	Contact:				Time:	

7. TESTING RESULTS

7.1 Control Unit and Related Equipment

		1	
Description	Visual Inspection	Functional Test	Comments
Control unit			THIS TEST WAS FOR (2) HORN STROBE UNITS
Lamps/LEDs/LCDs			INSTALLED IN SUITE 304
Fuses			
Trouble signals			
Disconnect switches			
Ground-fault monitoring			
Supervision			
Local annunciator		×	
Remote annunciators		×	
Power extender panels			
Isolation modules			
Other (specify)			

7.2 Control Unit Power Supplies

7.2 Control Unit Power Suppli	Visual Inspection	Functional Test	Comments
120-volt power			
Generator or UPS			
Battery condition			
Load voltage			
Discharge test			
Charger test			
Other (specify)			

7.3 In-Building Fire Emergency Voice Alarm Communications Equipment

.3 In-Building Fire Emergency Vo			
Description	Visual Inspection	Functional Test	Comments
Control unit			
.amps/LEDs/LCDs			
Puses			
rimary power supply			
econdary power supply			,
Trouble signals			
Disconnect switches			
Ground-fault monitoring			
Panel supervision			
System performance			
Sound pressure levels			
Occupied Yes No			
Ambient dBA			
Alarm dBA			
(attach report with locations, values, and weather conditions)			
System intelligibility			
□ CSI □ STI			
(attach report with locations, values, and weather conditions)			
Other (specify)			

7.4 Notification Appliance Power Extender Panels

Description	Visual Inspection	Functional Test	Comments
Lamps/LEDs/LCDs			
Fuses			
Primary power supply			
Secondary power supply			
Trouble signals			
Ground-fault monitoring			
Panel supervision			
Other (specify)			

7.5 Mass Notification Equipment

	T	
Description	Visual Inspection	Functional Test
Functional test		
Reset/power down test		
Fuses		
Primary power supply		
UPS power test		
Trouble signals		
Disconnect switches		
Ground-fault monitoring		
CCU security mechanism		
Prerecorded message content		
Prerecorded message activation		
Software backup performed		
Test backup software		
Fire alarm to MNS interface		
MNS to fire alarm interface		
In-building MNS to wide-area MNS		

Other (specify)

7.5 Mass Notification Equipment (continued)

Description	Visual Inspection	Functional Test	Comments
MNS to direct recipient MNS			
Sound pressure levels			
Occupied Yes No			
Ambient dBA			
Alarm dBA			
(attach report with locations, values, and weather conditions)			
System intelligibility			
□ CSI □ STI			
(attach report with locations, values, and weather conditions)			
Other (specify)			
7.6 Two-Way Communications Eq	uipment		
Description	Visual Inspection	Functional Test	Comments
Phone handsets			
Phone jacks			
Off-hook indicator			
Call-in signal			
System performance			
System audibility			
System intelligibility			
Radio communications enhancement system			
Area of refuge communication system			
Elevator emergency communications system			

7.7 Combination Systems

Description	Visual Inspection	Functional Test	Comments
Fire extinguishing monitoring devices/system			
Carbon monoxide detector/system			
Combination fire/security system			
Other (specify)			
7.8 Special Hazard Systems			
Description (specify)	Visual Inspection	Functional Test	Comments
7.9 Emergency Communications S	System		
☐ Visual			
☐ Functional			
☐ Simulated operation			
☐ Ensure predischarge notification See <i>NFPA 72</i> , 24.4.1.7.1.	appliances of sp	ecial hazard syst	ems are not overridden by the MNS.
7.10 Monitored Systems			
Description (specify)	Visual Inspection	Functional Test	Comments

Description (specify)	Visual Inspection	Functional Test	Comments
Engine-driven generator			
Fire pump			
Special suppression systems			
Other (specify)			

7.11 Auxiliary Functions

Description	Visual Inspection	Functional Test	Comments
Door-releasing devices			
Fan shutdown			
Smoke management/smoke control			
Smoke damper operation			
Smoke shutter release			
Door unlocking			
Elevator recall			
Elevator shunt trip			
MNS override of FA signals			
Other (specify)			
7.12 Alarm Initiating Device ☐ Device test results sheet attached	listing all device	es tested and the	results of the testing
7.13 Supervisory Alarm Initiating	Device		
☐ Device test results sheet attached	listing all device	es tested and the	results of the testing
7.14 Alarm Notification Appliance ☐ Appliance test results sheet attack		pliances tested a	nd the results of the testing

7.15 Supervisory Station Monitoring

Description	Visual Inspection	Functional Test	Time	Comments
Alarm signal				
Alarm restoration				
Trouble signal				
Trouble restoration				
Supervisory signal				
Supervisory restoration				

8. NOTIFICATIONS THAT TESTING IS COMPLETE

Monitoring organization

Contact:

HSMC

Time:

07:21 07:20

07:22

Building management

Contact:

J.B. Brown Mngt Company

Time:

Building occupants

Contact:

Time:

Authority having jurisdiction

Contact:

Time:

Other, if required

Contact:

Time:

9. SYSTEM RESTORED TO NORMAL OPERATION

Date:

June 7, 2012

Time:

07:21

Portland Fire

10. CERTIFICATION

10.1 Inspector Certification:

This system, as specified herein, has been inspected and tested according to all NFPA standards cited herein.

Signed:

Printed name:

Tim Johnson

Date: 6-07-12

Organization:

Norris Inc

Title:

Technician

Phone:

207-883-3473

10.2 Acceptance by Owner or Owner's Representative:

The undersigned has a service contract for this system in effect as of the date shown below.

Signed:

Printed name:

Date:

Organization:


Title:


Phone:

DEVICE TEST RESULTS

(Attach additional sheets if required)

Device Type	Address	Location	Test Results
HORN/STROBE		SUITE 304 CONF. RM	ОК
HORN/STROBE		SUITE 304 LOBBY	ОК

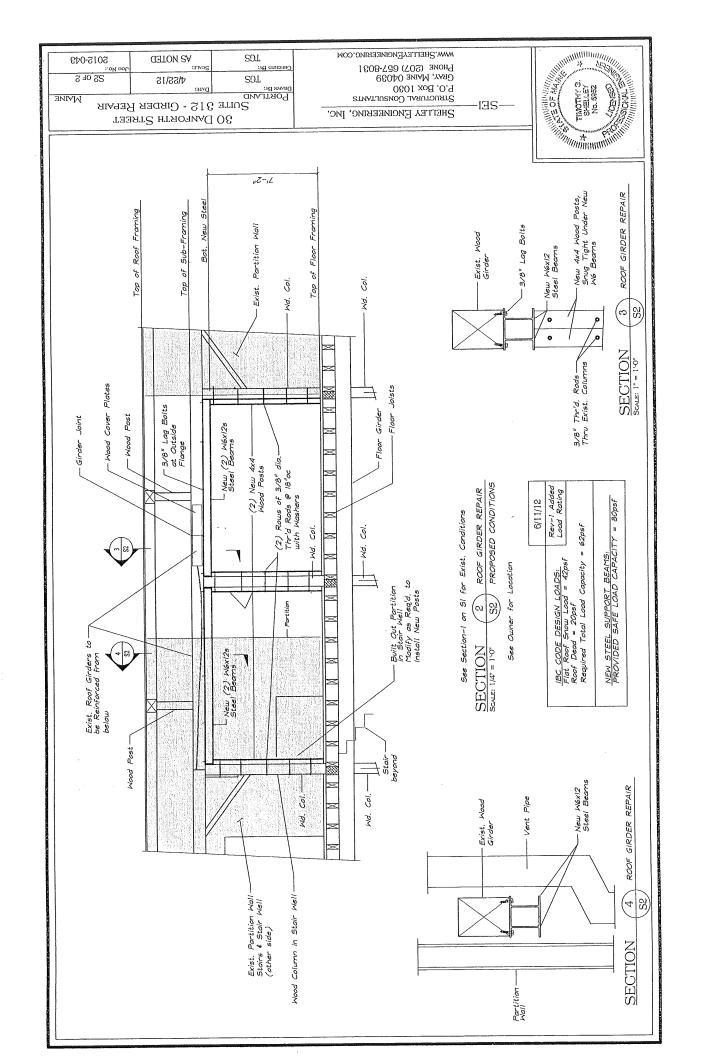

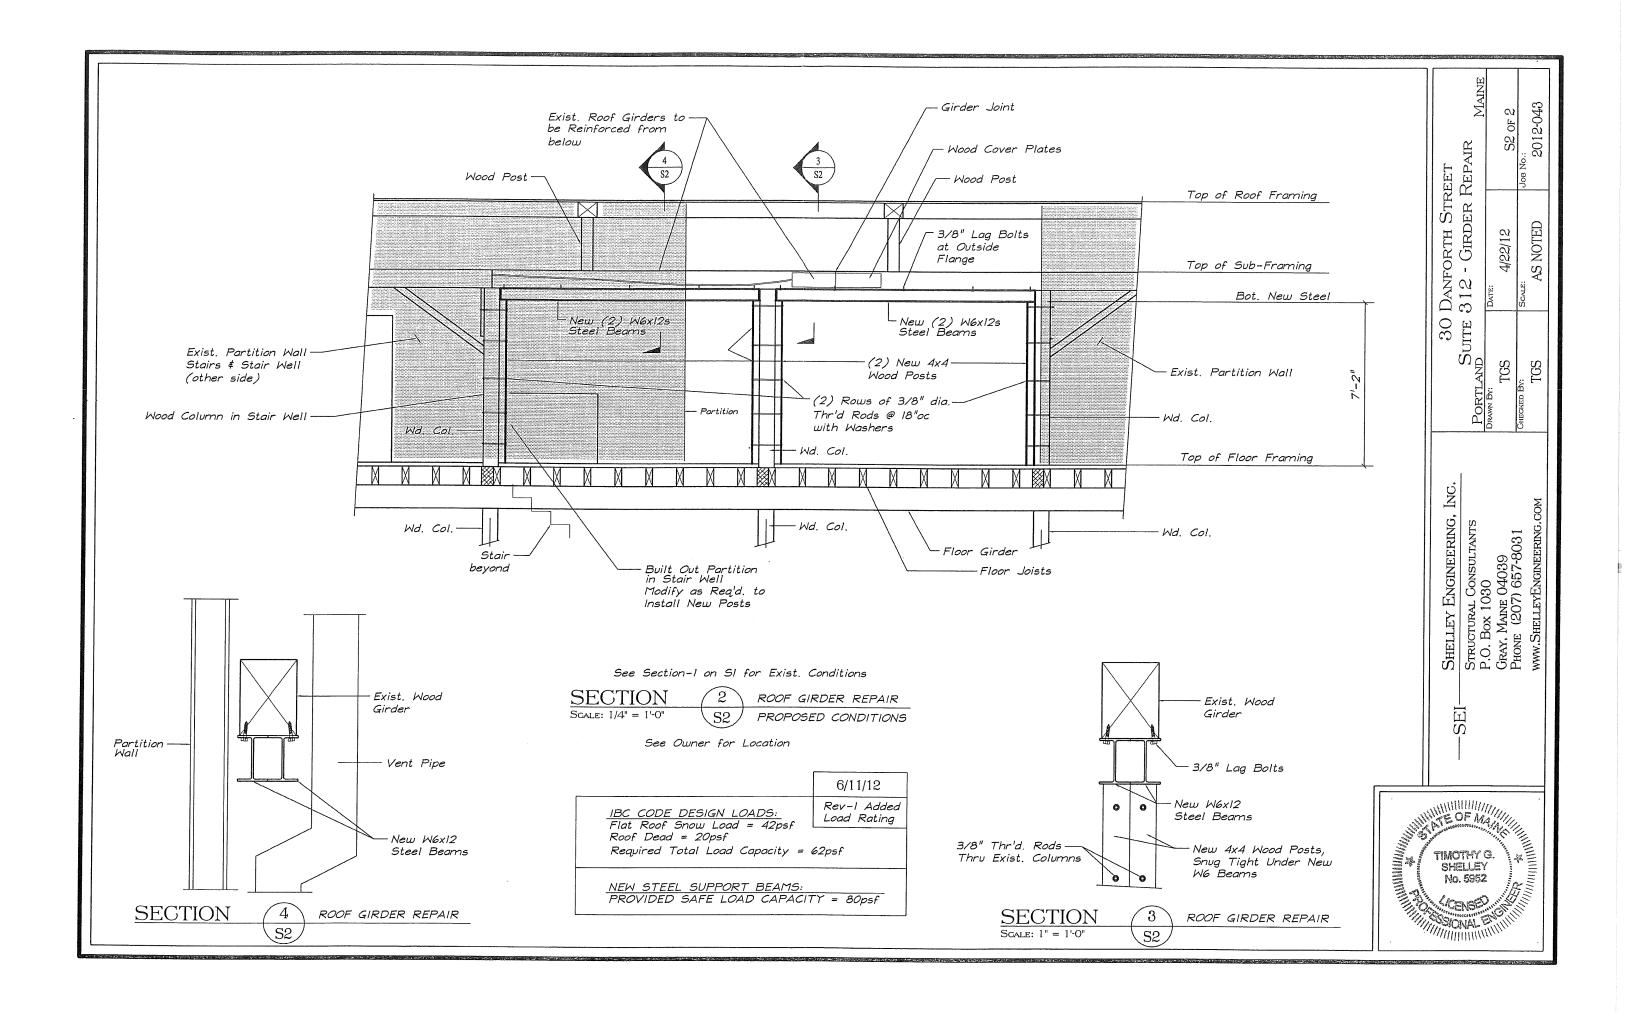

Suite 304

30 DANFORTH STREET PORTLAND ME 04101 TENANT SPACE


OWNER: J.B. BROWN & SONS 36 DANFORTH ST. PORTLAND ME 04101

LIST OF DRAWINGS:

TITLE, KEY PLAN A0.0

GENERAL NOTES

THIRD FLOOR PARTIAL PLAN DOORS, PARTITIONS, ETC. A0.1 A0.2 A1.3

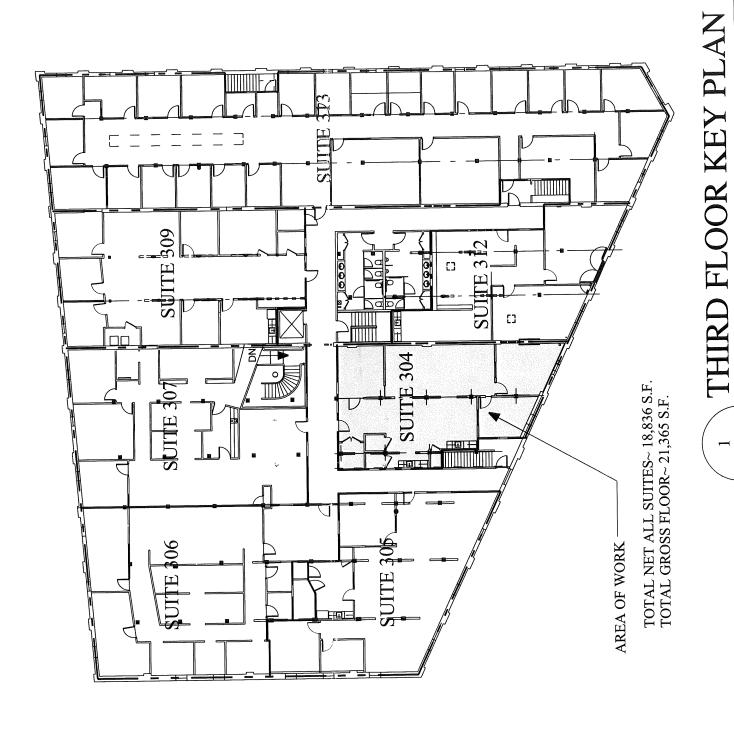


BUILDING PERMIT SET


SCALE: 1/32" = 1'-0"


A0.0

Project Title Suite 304 Tenant Sp	Fenant Space	J.B. Brown & Sons, Inc. 36 Danforth Street Portland ME 04101	Drawing Title TITLE	wing Title TITLE, KEY PLAN	AN	
-	Convright 2012 Micha	Converight 2012 Michael Belleau Architect	Date:	4/02/12 Scale:	Scale:	1/32"= 1'-0"
6 2	61 Pleasant Street Portland www.michaelbelleau.com	nd ME 04101 (207)874-7668 m	Project Number:	12.02	12.02 Reference:	NONE

rawing Number	A0

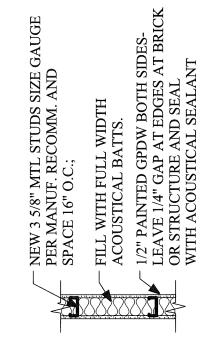

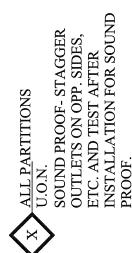


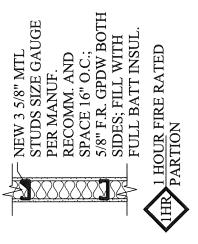

OWNER NEEDS TO PATCH MECHANICAL ROOM OR WALLS BETWEEN TENANT SPACES THEN USE THIS TYPE) (NOT USED UNLESS

PARTITION TYPES:

NOTE: SEAL ALL WALLS AT COLUMNS, BEAMS & DECK TIGHT TO MAKE SMOKE PROOF. ALL WALLS TO GO UP TO DECK THEREFORE, INFILL BETWEEN JOISTS IF NECESSARY. USE ACOUSTICAL SEALANT IF NO FIRE RATING; USE FIRE RETARDANT SEALANT AT HALLS AND ANY RATED WALL.

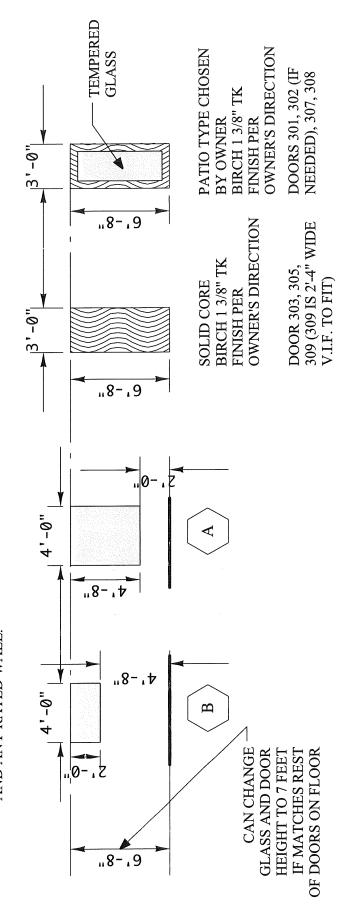

-DETAILED LIKE OWNER'S OFFICE FIXED GLASS

DOORS

- DOOR AND FIXED GLASS NOTES:

 1. ALL DOORS IN HM FRAME (CHECK WITH OWNER FOR ENTRY DOOR 301 FRAME WHICH MAY BE WOOD FRAME & TRIM TO MATCH OTHERS IN HALLWAY).

 2. DOOR 301 (ENTRY FROM HALL) MUST HAVE CLOSER.

 3. ALL DOORS HARDWARE TO BE MATT SILVER FINISH; LEVER HANDLES; 3 BUTTS; LOCKSETS PER OWNERS DIRECTION; ALL DOORS CAN OPEN FROM INSIDE WITHOUT KEY EVEN WHEN LOCKED; ALL DOORS ARE 3' WIDE (EXCEPT 309- 2'-4" V.I.F.).

 4. ALL DOORS TO HAVE SOUND SEAL STRIPPING ALL EDGES (SMOKEPROOF STRIPPING AT DOORS TO HALLWAYS).

 5. ANY GLAZING IS TO MATCH OWNERS OFFICES WITH SAME TRIM, ETC.

 6. ALL THRESHOLDS TO BE ACCESSIBLE (1/2" MAX.)

 7. SEE OWNER FOR BASE, FLOOR, PAINT, ETC. FINISHES.

BUILDING PERMIT SET

Dr			•
	ETC.	AS NOTED	NONE
	SOWS,	Scale:	Reference:
	DOORS, WINDOWS, ETC.	4/02/12 Scale:	12.00
Drawing Title	DOOR	Date:	Project Number: 100 Project Number:
J.B. Brown & Sons, Inc. Drawing Title	36 Danforth Street Portland ME 04101	Copyright 2012 Michael Belleau Architect	tland ME 04101 (207)8/4-7668
ə	Suite 304 Tenant Space	Copyright 2012 Mic	61 Pleasant Street Por
Project Title	Suite 304	4)()(

