
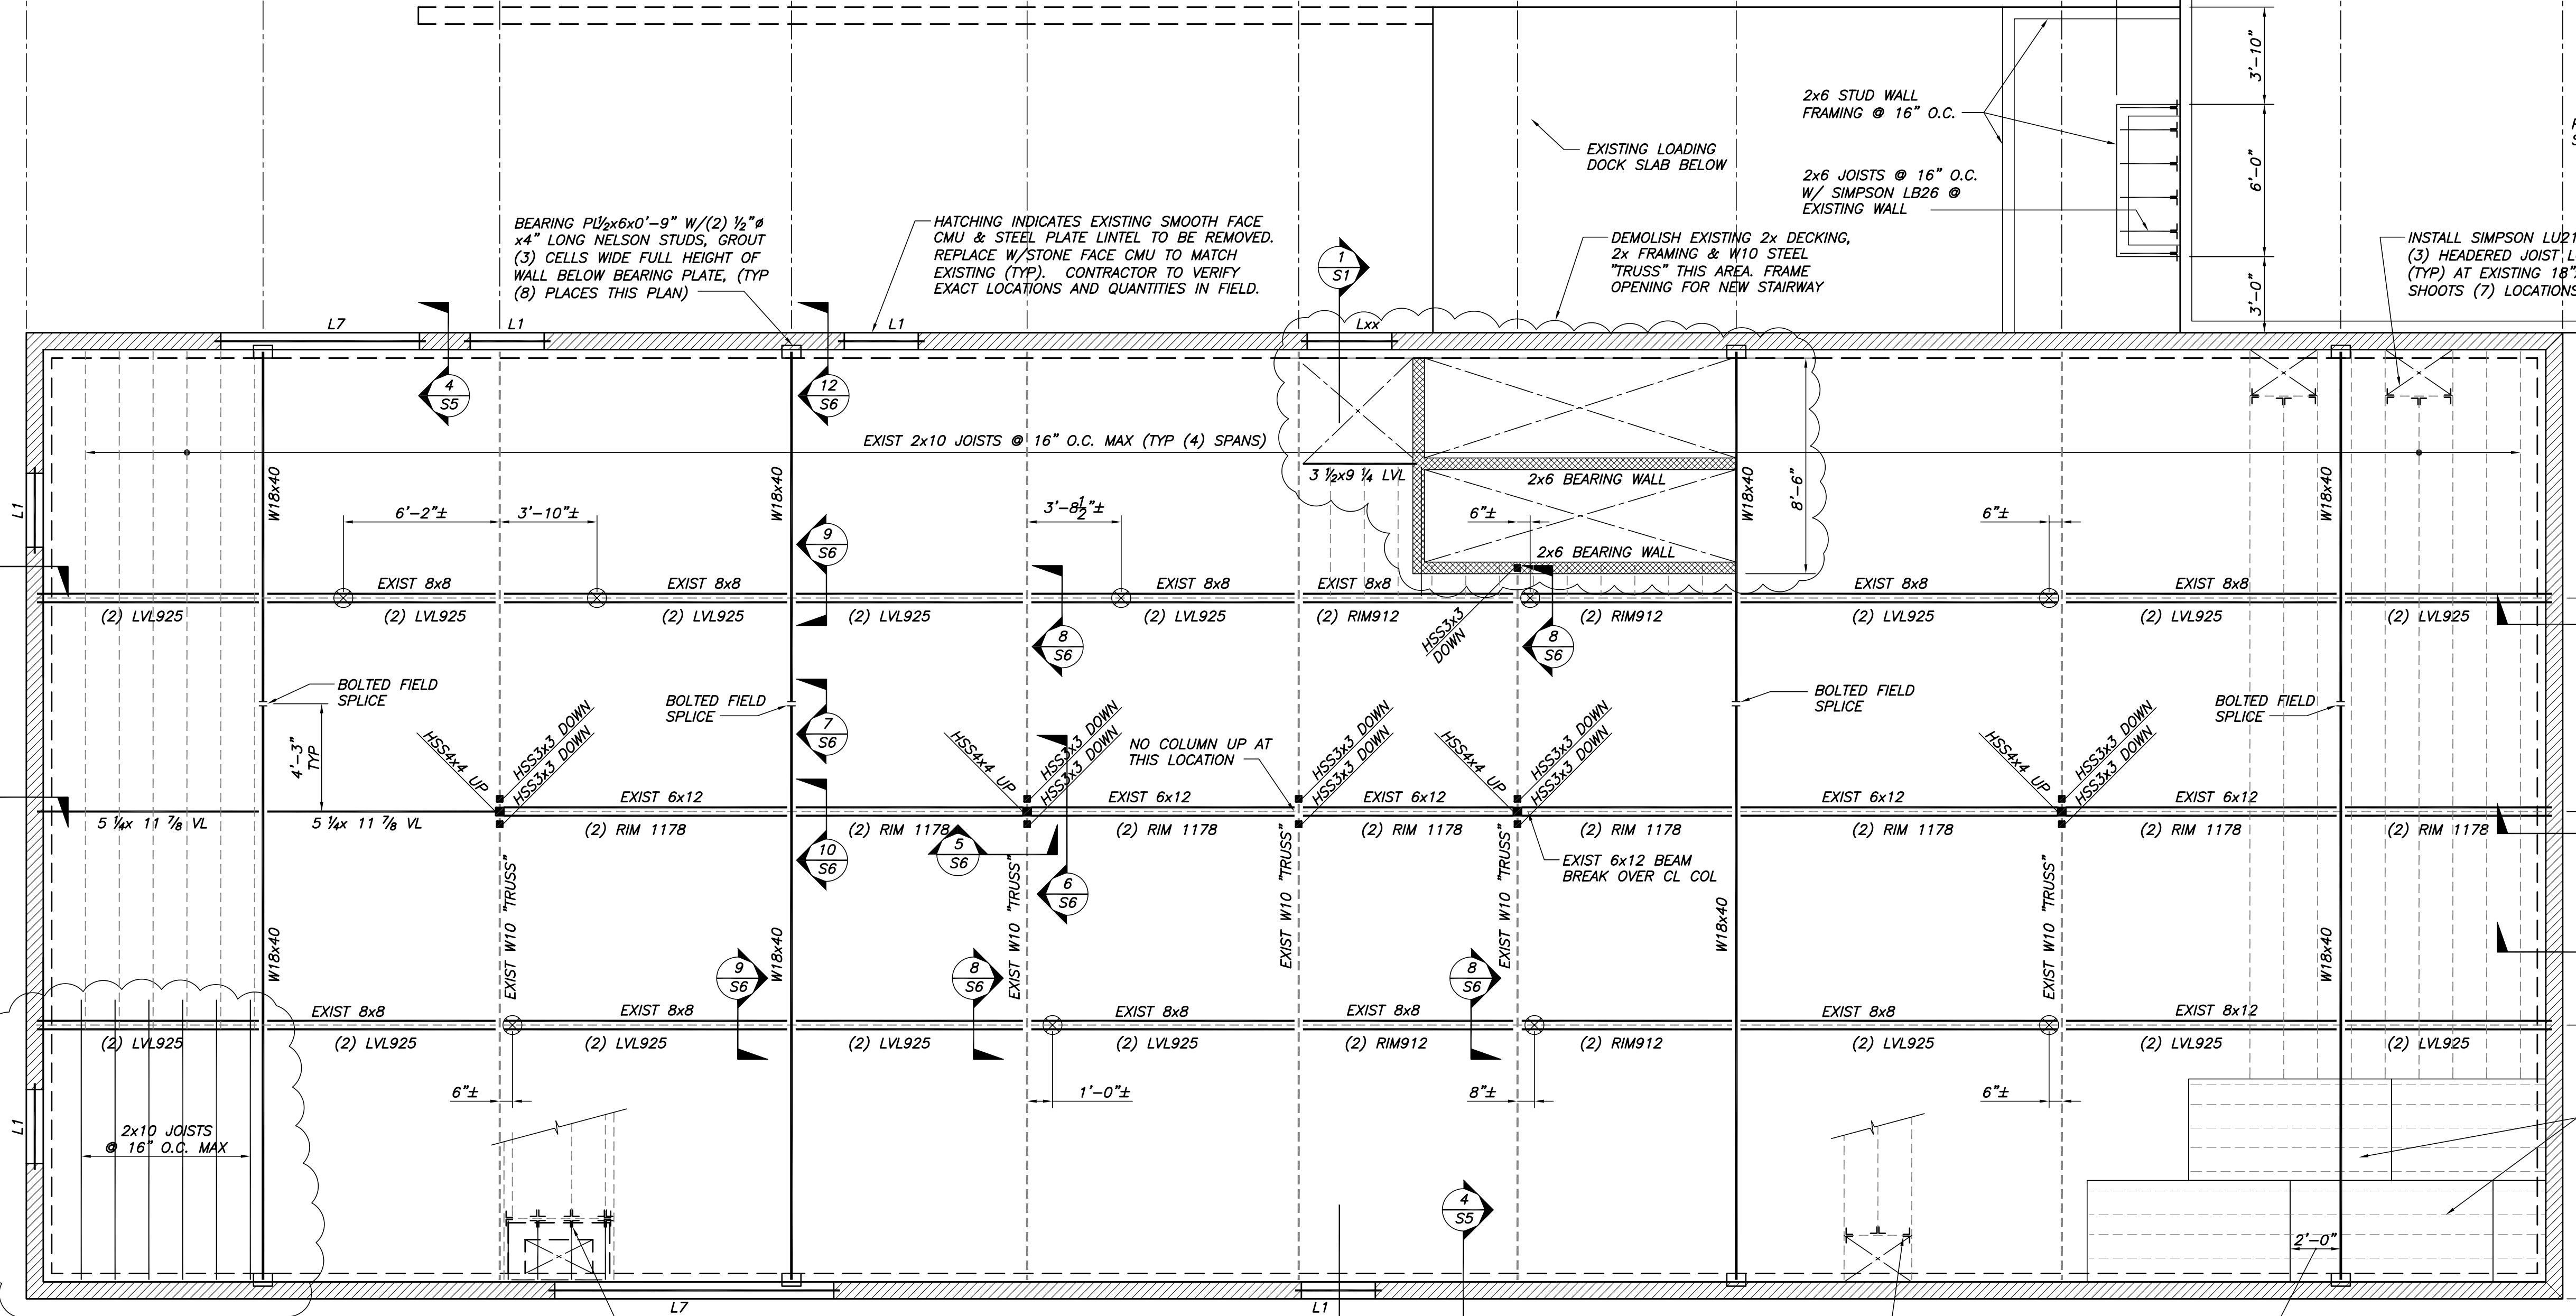


A B C D E F G H K L M N O
 9'-4" 9'-4" 11'-6" 9'-3 1/2" 10'-8 1/2" 8'-7 1/2" 8'-7 1/2" 12'-10" 4'-8" 6'-4" 8'-9" 5'-0"

| LINTEL SCHEDULE | | |
|-----------------|----------------|---------|
| MARK | CLEAR SPAN | LINTEL |
| L1 | < 6'-0" | (2)WXXX |
| L2 | 6'-0" - 7'-0" | |
| L3 | 7'-0" - 12'-0" | |

NOTE: LINTEL SCHEDULE TO FOLLOW AFTER FINAL CONFIGURATION OF WALL OPENINGS IS DETERMINED

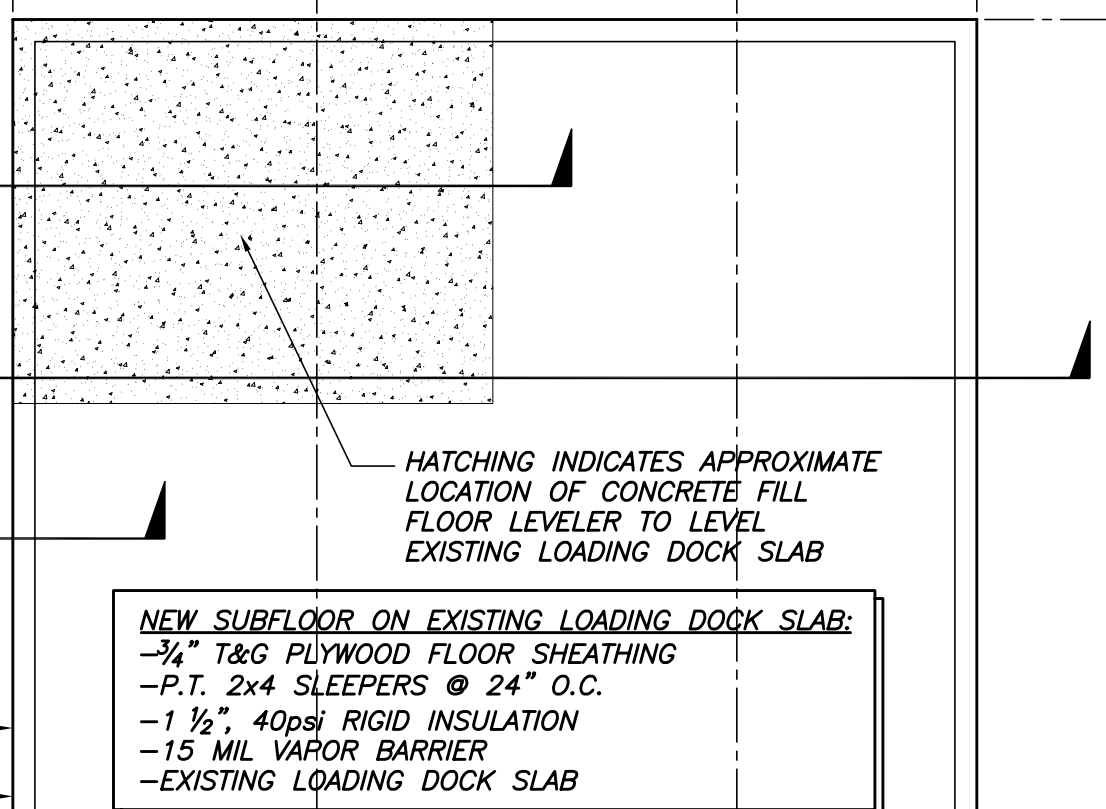

- PLAN NOTES:
- FLOOR IS TO BE LEVELLED AS PART OF CONSTRUCTION.
 - EXISTING W10 BEAMS ARE TO BE PLUMBED & SHIMMED TO BOT. OF NEW FLOOR SHEATHING. ATTACH EXISTING W10 BEAM TO NEW FLOOR SHEATHING W/ WAFFER HEAD TEK SCREWS. SEE SECTIONS FOR ADDITIONAL INFORMATION.
 - "LVL925" INDICATES 1 3/4"x9 1/4" LVL TO BE SISTERED, GLUED & NAILED TO EXISTING WOOD BEAMS. SEE SECTION FOR ADDITIONAL INFORMATION.
 - "RIM1178" INDICATED 1 1/2"x11 7/8" RIM BOARD (VERSA RIM) TO BE SISTERED TO EXIST WOOD BEAMS. SEE SECTIONS FOR ADD'L INFORMATION.
 - ⊗ INDICATES SPLICE POINTS IN EXIST FLOOR BEAM.
 - "RIM912" INDICATED 1 1/2"x9 1/2" RIM BOARD (VERSA RIM) TO BE SISTERED TO EXIST WOOD BEAMS. SEE SECTIONS FOR ADD'L INFORMATION.

SECOND FLOOR FRAMING PLAN
 1/4"=1'-0"



NOT FOR CONSTRUCTION
 ISSUED FOR PRICING
 3/26/2003

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| APPROVED | DESCRIPTION | DATE |
|------------------|-------------|------|
| | | |
| DESIGNED BY: EAP | REV. NO. | |
| DRAWN BY: MC | | |
| CHECKED BY: PBB | | |
| SCALE: | NOTED | |
| DATE: | 03/26/03 | |

PROJECT: 75 YORK STREET
 PROFESSIONAL OFFICES
 PORTLAND, MAINE
 SECOND FLOOR FRAMING PLAN