


# YORK STREET MIXED USE DEVELOPMENT

## YORK STREET PORTLAND, MAINE

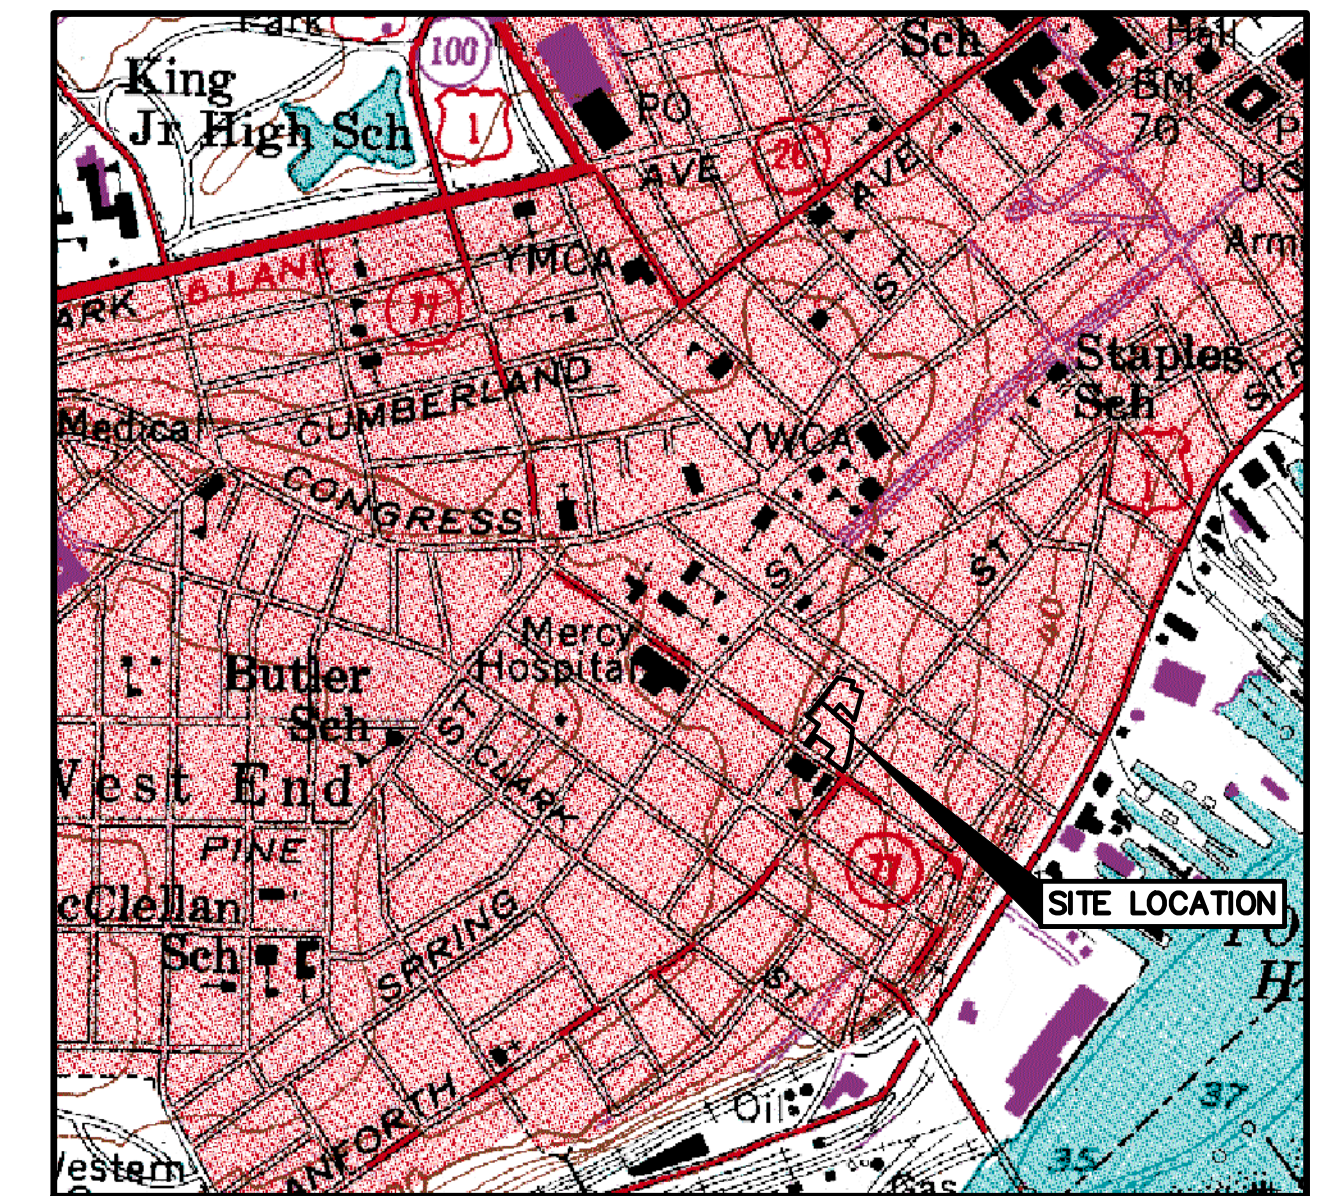

LOCATION MAP  
N.T.S.

PROJECT PARCEL SITE PORTLAND ASSESSOR'S MAP & LOT NUMBERS	
MAP	LOT
40	21
40	22
40	26

**Applicant:**  
101 YORK ST, LLC  
36 DANFORTH ST  
PORTLAND, ME 04101

### LEGEND

EXISTING	DESCRIPTION	PROPOSED
	BUILDING	
	RIGHT OF WAY	
	PROPERTY LINE	
	BUILDING SETBACK	
	ZONE LINE	
	WETLAND BOUNDARY	
	GUIDE RAIL	
	EDGE OF PAVEMENT	
	EDGE OF GRAVEL DRIVE	
	GRADING CONTOUR LINE	
	SPOT ELEVATION	
	TREELINE	
	TREES & HEDGES	
	POLE WITH LIGHT FIXTURE(S)	
	UTILITY POLE	
	FREESTANDING SIGN	
	PAINTED DIRECTIONAL TRAFFIC ARROW	
	OVERHEAD ELECTRIC/TELEPHONE	
	UNDERGROUND ELECTRIC/TELEPHONE	
	WATER LINE	
	STORM DRAIN LINE	
	CULVERT	
	HYDRANT	
	WATER GATE VALVE	
	WATER SHUT OFF VALVE	
	MANHOLE	
	CATCH BASIN	
	TEST PIT	
	IRON ROD (SET)	
	IRON ROD (FOUND)	
	MONUMENT	
	RIPRAP	
	SILT FENCE - PERIMETER	
	STONE SEDIMENT BARRIER	
	FENCE	

### GENERAL NOTES

1. TOPOGRAPHIC DATA AND EXISTING CONDITIONS WAS PREPARED BY OWEN HASKELL.
2. THE CONTRACTOR IS SPECIFICALLY CAUTIONED THAT THE LOCATION AND/OR THE ELEVATION OF THE EXISTING UTILITIES AS SHOWN ON THESE PLANS IS BASED ON RECORDS OF THE VARIOUS UTILITY COMPANIES AND WHERE POSSIBLE MEASUREMENTS TAKEN IN THE FIELD. THIS INFORMATION IS NOT TO BE RELIED ON AS BEING EXACT OR COMPLETE. THE CONTRACTOR MUST CALL THE APPROPRIATE UTILITY COMPANY AND DIG SAFE AT LEAST 72 HOURS PRIOR TO ANY EXCAVATION TO REQUEST EXACT FIELD LOCATION OF UTILITIES. IT SHALL BE THE RESPONSIBILITY OF THE CONTRACTOR TO RELOCATE ALL EXISTING UTILITIES WHICH CONFLICT WITH THE PROPOSED IMPROVEMENTS SHOWN ON THE PLANS.
3. MAINTENANCE OF EROSION CONTROL MEASURES IS OF PARAMOUNT IMPORTANCE TO THE OWNER AND THE CONTRACTOR IS RESPONSIBLE FOR COMPLYING WITH ALL EROSION CONTROL MEASURES SHOWN ON THE PLANS. ADDITIONAL EROSION CONTROL MEASURES SHALL BE INSTALLED IF DEEMED NECESSARY BY ON-SITE INSPECTIONS OF THE OWNER, THE CITY OF PORTLAND OR THEIR REPRESENTATIVES AT NO ADDITIONAL COST TO THE OWNER.
4. ALL MATERIAL SCHEDULES SHOWN ON THE PLANS ARE FOR GENERAL INFORMATION ONLY. THE CONTRACTOR SHALL PREPARE HIS OWN MATERIAL SCHEDULES BASED UPON HIS PLAN REVIEW. ALL SCHEDULES SHALL BE VERIFIED IN THE FIELD BY THE CONTRACTOR PRIOR TO ORDERING MATERIALS OR PERFORMING WORK.
5. ALL MATERIALS AND CONSTRUCTION METHODS SHALL CONFORM TO MAINE DEPARTMENT OF TRANSPORTATION SPECIFICATIONS, AND/OR CITY OF PORTLAND SPECIFICATIONS.

### PERMITTING NOTES

1. THIS PROJECT IS SUBJECT TO THE TERMS AND CONDITIONS OF A SITE PLAN APPROVAL FROM THE CITY OF PORTLAND. THE CONSTRUCTION WILL BE GOVERNED BY THE CITY OF PORTLAND ZONING ORDINANCE WHICH IS AVAILABLE FOR VIEWING AT THE OFFICE OF THE ENGINEER OR THE MUNICIPAL OFFICE.
2. THE CONTRACTOR SHALL REVIEW THE ABOVE REFERENCED PERMITS PRIOR TO SUBMITTING A BID FOR THIS PROJECT, AND INCLUDE COSTS AS NECESSARY TO COMPLY WITH THE CONDITIONS OF THESE PERMITS.

### LAYOUT NOTES

1. ALL DIMENSIONING, UNLESS NOTED OTHERWISE, IS TO THE FACE OF CURB.
2. OFFSETS TO CATCH BASINS AND MANHOLES ARE TO THE CENTER OF THE FRAME.
3. PIPE LENGTH EQUALS THE CENTER TO CENTER DISTANCES BETWEEN CATCH BASINS AND/OR MANHOLES MINUS ONE-HALF OF THE DIAMETER OF EACH CATCH BASIN OR MANHOLE.
4. PROPERTY LINE AND R.O.W. MONUMENTS SHALL NOT BE DISTURBED BY CONSTRUCTION. IF DISTURBED, THEY SHALL BE RESET TO THEIR ORIGINAL LOCATIONS AT THE CONTRACTOR'S EXPENSE, BY A MAINE LICENSED LAND SURVEYOR.
5. PROPOSED RIGHT OF WAY MONUMENTS AND PROPERTY LINE PINS SHALL BE INSTALLED UNDER THE DIRECTION OF A MAINE LICENSED LAND SURVEYOR.
6. CURB RADI UNLESS OTHERWISE NOTED ON THE PLAN SHALL BE A MINIMUM OF 3'.

### UTILITY NOTES

1. ALL WATER UTILITY MATERIALS AND INSTALLATION METHODS SHALL CONFORM TO PORTLAND WATER DISTRICT STANDARDS. ALL WATER DISTRIBUTION PIPING SHALL BE CLASS 52 DUCTILE IRON PIPE, DOUBLE CEMENT LINED AND BITUMINOUS COATED CONFORMING TO AWWA/ANSI C104/A21.4. DISINFECTION OF WATER LINES SHALL CONFORM TO AWWA STANDARD C651, LATEST REVISION.
2. THE LOCATION OF THE PROPOSED UNDERGROUND ELECTRICAL SERVICE IS APPROXIMATE AND THE CONTRACTOR SHALL COORDINATE THE EXACT LOCATION WITH CENTRAL MAINE POWER COMPANY.
3. THRUST BLOCKS OR LOCKING RETAINER GLANDS SHALL BE PLACED ON THE WATER DISTRIBUTION LINES AT ALL BENDS, TEES, VALVES, CHANGES IN DIRECTION, ETC. THE THRUST BLOCKS OR LOCKING RETAINER GLANDS SHALL MEET THE REQUIREMENTS OF THE PORTLAND WATER DISTRICT STANDARDS.
4. TEST PITS AT ALL UTILITY CROSSINGS SHALL BE COMPLETED TWO WEEKS IN ADVANCE OF THE START OF CONSTRUCTION OR ORDERING OF MATERIALS. TEST PIT INFORMATION SHALL BE PROMPTLY PROVIDED TO ENGINEER FOR REVIEW.

### GRADING AND DRAINAGE NOTES

1. UNLESS OTHERWISE NOTED, ALL STORM DRAIN PIPE SHALL BE IN ACCORDANCE WITH MDT SPECIFICATIONS SECTION 603-- PIPE CULVERTS AND STORM DRAINS, LATEST REVISION WITH THE EXCEPTION THAT THE ONLY ACCEPTABLE TYPES OF PIPE ARE AS FOLLOWS:  
REINFORCED CONCRETE PIPE, CLASS III  
POLYVINYL-CHLORIDE (PVC) PIPE  
SMOOTH BORE POLYETHYLENE - ADS OR HANCOR
2. TOPSOIL STRIPPED IN AREAS OF CONSTRUCTION THAT IS SUITABLE FOR REUSE AS LOAM SHALL BE STOCKPILED ON SITE AT A LOCATION TO BE DESIGNATED BY THE OWNER. UNSUITABLE SOIL SHALL BE SEPARATED, REMOVED AND DISPOSED OF AT AN APPROVED DISPOSAL LOCATION OFF SITE.
3. THE CONTRACTOR SHALL ANTICIPATE THAT GROUNDWATER WILL BE ENCOUNTERED DURING CONSTRUCTION AND SHALL INCLUDE SUFFICIENT COSTS WITHIN THEIR BID TO PROVIDE DEWATERING AS NECESSARY. NO SEPARATE PAYMENT SHALL BE MADE TO THE CONTRACTOR FOR DEWATERING.

### EROSION CONTROL NOTES

1. LAND DISTURBING ACTIVITIES SHALL BE ACCOMPLISHED IN A MANNER AND SEQUENCE THAT CAUSES THE LEAST PRACTICAL DISTURBANCE OF THE SITE.
2. PRIOR TO BEGINNING ANY CLEARING/LAND DISTURBING ACTIVITIES, THE CONTRACTOR SHALL INSTALL THE PERIMETER SILT FENCES AND THE CONSTRUCTION ENTRANCE.
3. ALL GROUND AREAS DISTURBED FOR CONSTRUCTION WILL BE GRADED, LOAMED AND SEEDED AS SOON AS POSSIBLE. PERMANENT SEED MIXTURE SHALL CONFORM TO THE SEEDING PLAN CONTAINED IN THE EROSION CONTROL NOTES INCLUDED ON SHEET C405.
4. PRIOR TO PAVING, THE CONTRACTOR SHALL FLUSH SEDIMENT FROM ALL STORM DRAIN LINES, REMOVE ACCUMULATED SEDIMENT FROM SUMPS AND INVERTS AND PROPERLY DISPOSE OF.
5. ALL CATCH BASINS WITH OUTLET PIPES 18" DIAMETER OR LESS SHALL BE PROVIDED WITH A "SNOOT" SEDIMENTATION HOOD PER DETAIL.
6. SILT FENCES SHALL BE INSPECTED, REPAIRED AND CLEANED AS NOTED IN THE EROSION CONTROL NOTES.
7. THE CONTRACTOR SHALL REPAIR AND ADD STONE TO THE CONSTRUCTION ENTRANCE AS IT BECOMES SATURATED WITH MUD TO ENSURE THAT IT WORKS AS PLANNED DURING CONSTRUCTION.
8. SILT REMOVED FROM AROUND INLETS AND BEHIND THE SILT FENCES SHALL BE PLACED ON A TOPSOIL STOCKPILE AND MIXED INTO IT FOR LATER USE IN LANDSCAPING OPERATIONS.
9. EROSION CONTROL NOTES ACCOMPANY THIS PLAN SET AND ARE CONTAINED ON DRAWING C405 OF THIS PLAN SET.
10. THE MAINTENANCE SCHEDULE FOR THE CATCH BASIN SEDIMENT SUMPS IS CONTAINED IN THE EROSION CONTROL NOTES INCLUDED ON SHEET C405.
11. THE CONTRACTOR IS CAUTIONED THAT FAILURE TO COMPLY WITH THE SEQUENCE OF CONSTRUCTION, EROSION/SEDIMENT CONTROL PLAN, AND OTHER PERMIT REQUIREMENTS BASED UPON ANY THIRD PARTY REVIEW (ie MDEP) MAY RESULT IN MONETARY PENALTIES. THE CONTRACTOR SHALL BE ASSESSED ALL SUCH PENALTIES AT NO COST TO THE OWNER OR PERMITTEE.
12. ALL NON-PAVED AREAS DISTURBED DURING CONSTRUCTION SHALL BE LOAMED AND SEEDED, UNLESS OTHERWISE DIRECTED BY THE OWNER.
13. ALL DISTURBED AREAS ARE TO RECEIVE A MINIMUM OF 4" OF TOPSOIL PRIOR TO PERMANENT SEEDING.

### UTILITIES

#### WATER:

PORTLAND WATER DISTRICT  
225 DOUGLASS STREET  
PORTLAND, MAINE 04102  
(207) 761-8300  
CONTACT: GLISSEN HAVU

#### SEWER:

DEPARTMENT OF PUBLIC SERVICES  
55 PORTLAND STREET  
PORTLAND, MAINE 04101-2991  
(207) 874-8832  
CONTACT: FRANK BRANCELLEY

#### ELECTRIC:

CENTRAL MAINE POWER  
162 CANCO ROAD  
PORTLAND, MAINE 04103  
(207) 828-2882  
CONTACT: JAMES COUGH

#### TELEPHONE:

VERIZON  
5 DAVIS FARM ROAD  
PORTLAND, MAINE 04103  
(207) 797-1842  
CONTACT: TROY MACDONALD

#### CABLE:

TIME WARNER CABLE  
118 JOHNSON ROAD  
PORTLAND, MAINE 04102  
(207) 253-2222

### INDEX

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C1.04	SUBDIVISION NOTES & DETAILS
C2.01	DEMOLITION PLAN
C3.01	OVERALL SITE AND UTILITY PLAN
C3.02	SITE PLAN AND UTILITY PLAN
C4.01	GRADING, DRAINAGE, AND EROSION CONTROL PLAN
C5.01	SITE & UTILITY DETAILS
C6.01	EROSION CONTROL NOTES
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C9.04*	SECOND LEVEL FLOOR PLAN
C9.05*	UPPER LEVEL FLOOR PLAN
C10.01*	CONSTRUCTION MANAGEMENT PLAN

\*DENOTES PLANS PROVIDED BY OTHERS:  
- OPECHEE CONSTRUCTION CORPORATION  
- OWEN HASKELL INC.  
- ELM GROVE PROPERTY SOLUTIONS, LLC

### PERMITS

#### TYPE OF PERMIT

LEVEL 3 SITE PLAN REVIEW

#### GOVERNING BODY

CITY OF PORTLAND  
PLANNING DEPARTMENT  
389 CONGRESS STREET  
PORTLAND, MAINE 04101  
(207) 874-8719


#### STATUS

SUBMITTED:  
8/11/2015

CALL BEFORE YOU DIG  
1-888-344-7233

NOTE: THIS PLAN SET IS ISSUED FOR  
PERMITTING PURPOSES AND SHALL  
NOT BE USED FOR CONSTRUCTION.

*Alton M. Palmer III*

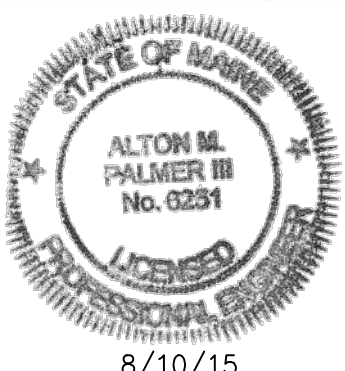

8/10/15

Rev.	Date	Revision

SITE PLAN REVIEW	8/14/15	AMP
Issued For	Date	By

Design: -	Draft: CG	Date: JUNE 2015
Checked: -	Scale: 1"=20'	Job No.: 3018
File Name: 3018-COVER.dwg		
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Drawing Name:	Cover Sheet
Project:	York Street - Mixed Use Development Portland, Maine
Client:	York Street, LLC 36 Danforth Street, Portland, ME 04101

Drawing No.	CO
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