


Kurt F.

igh Street Maine

project architect: KAK drawn by: KFM

LOWER LEVEL DUCTWORK


M.S.E. Proj. 1608

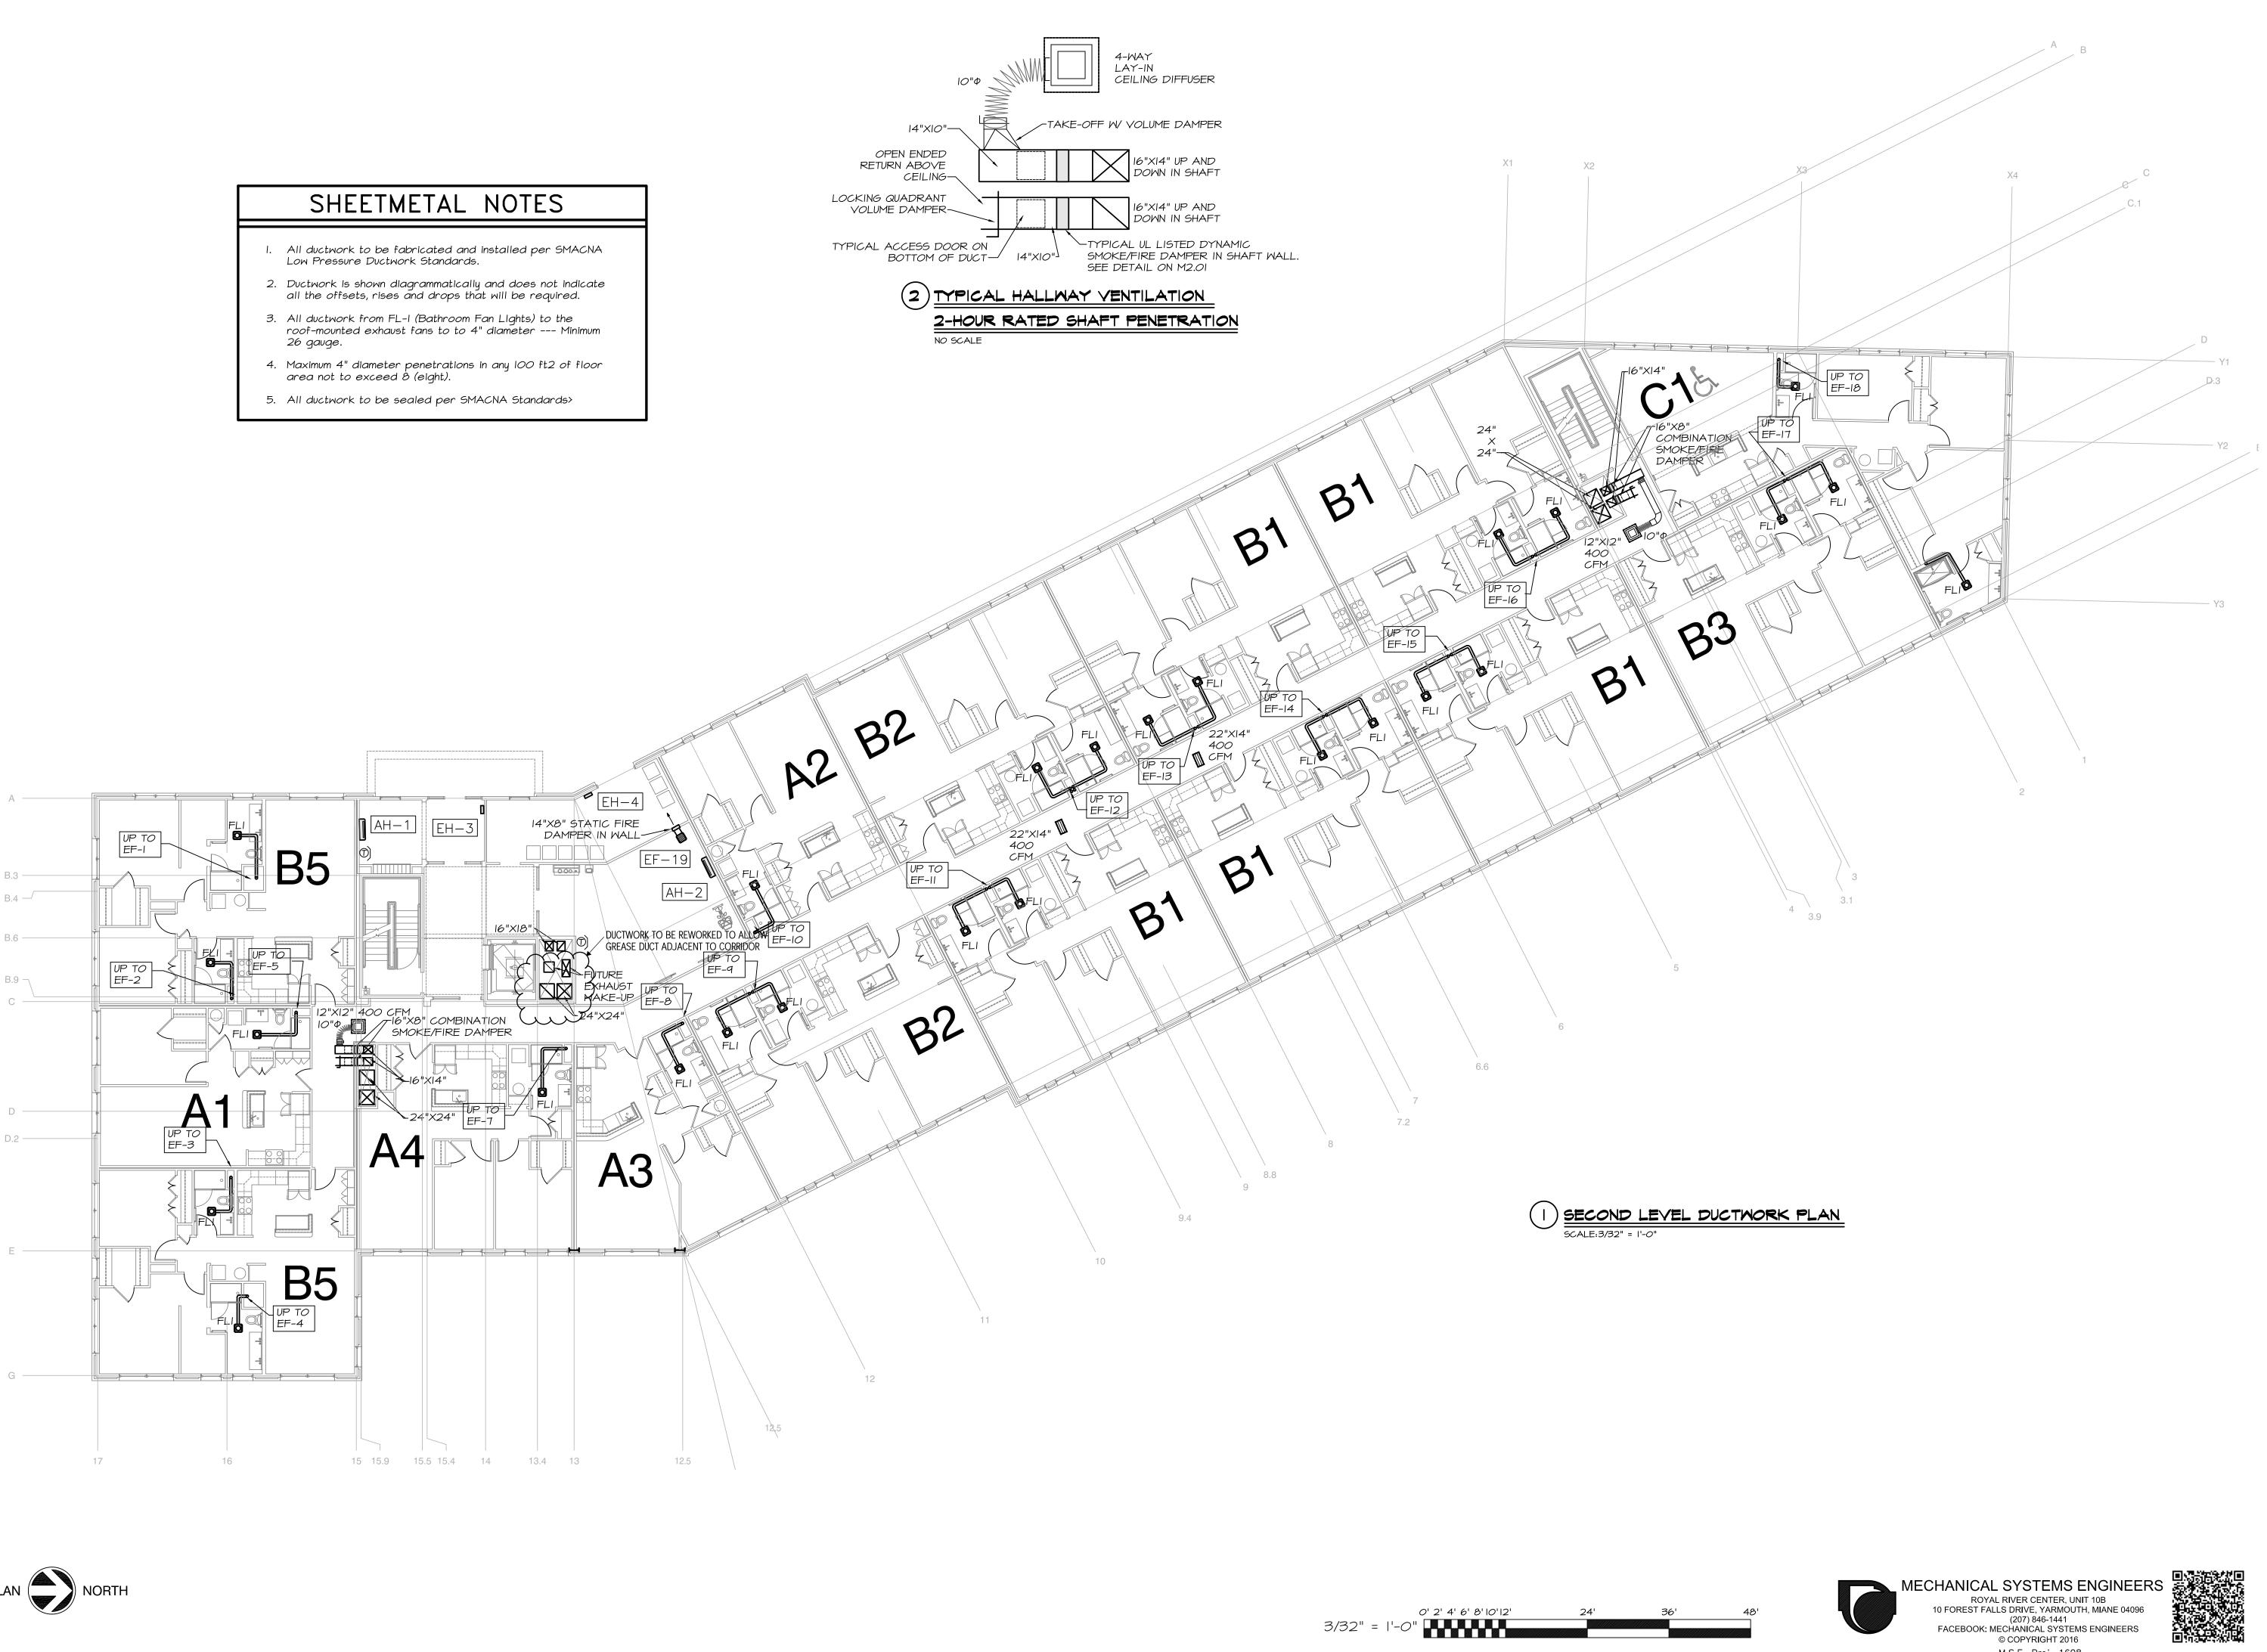

project architect: KAK


SECOND LEVEL DUCTWORK

M.S.E. Proj. 1608

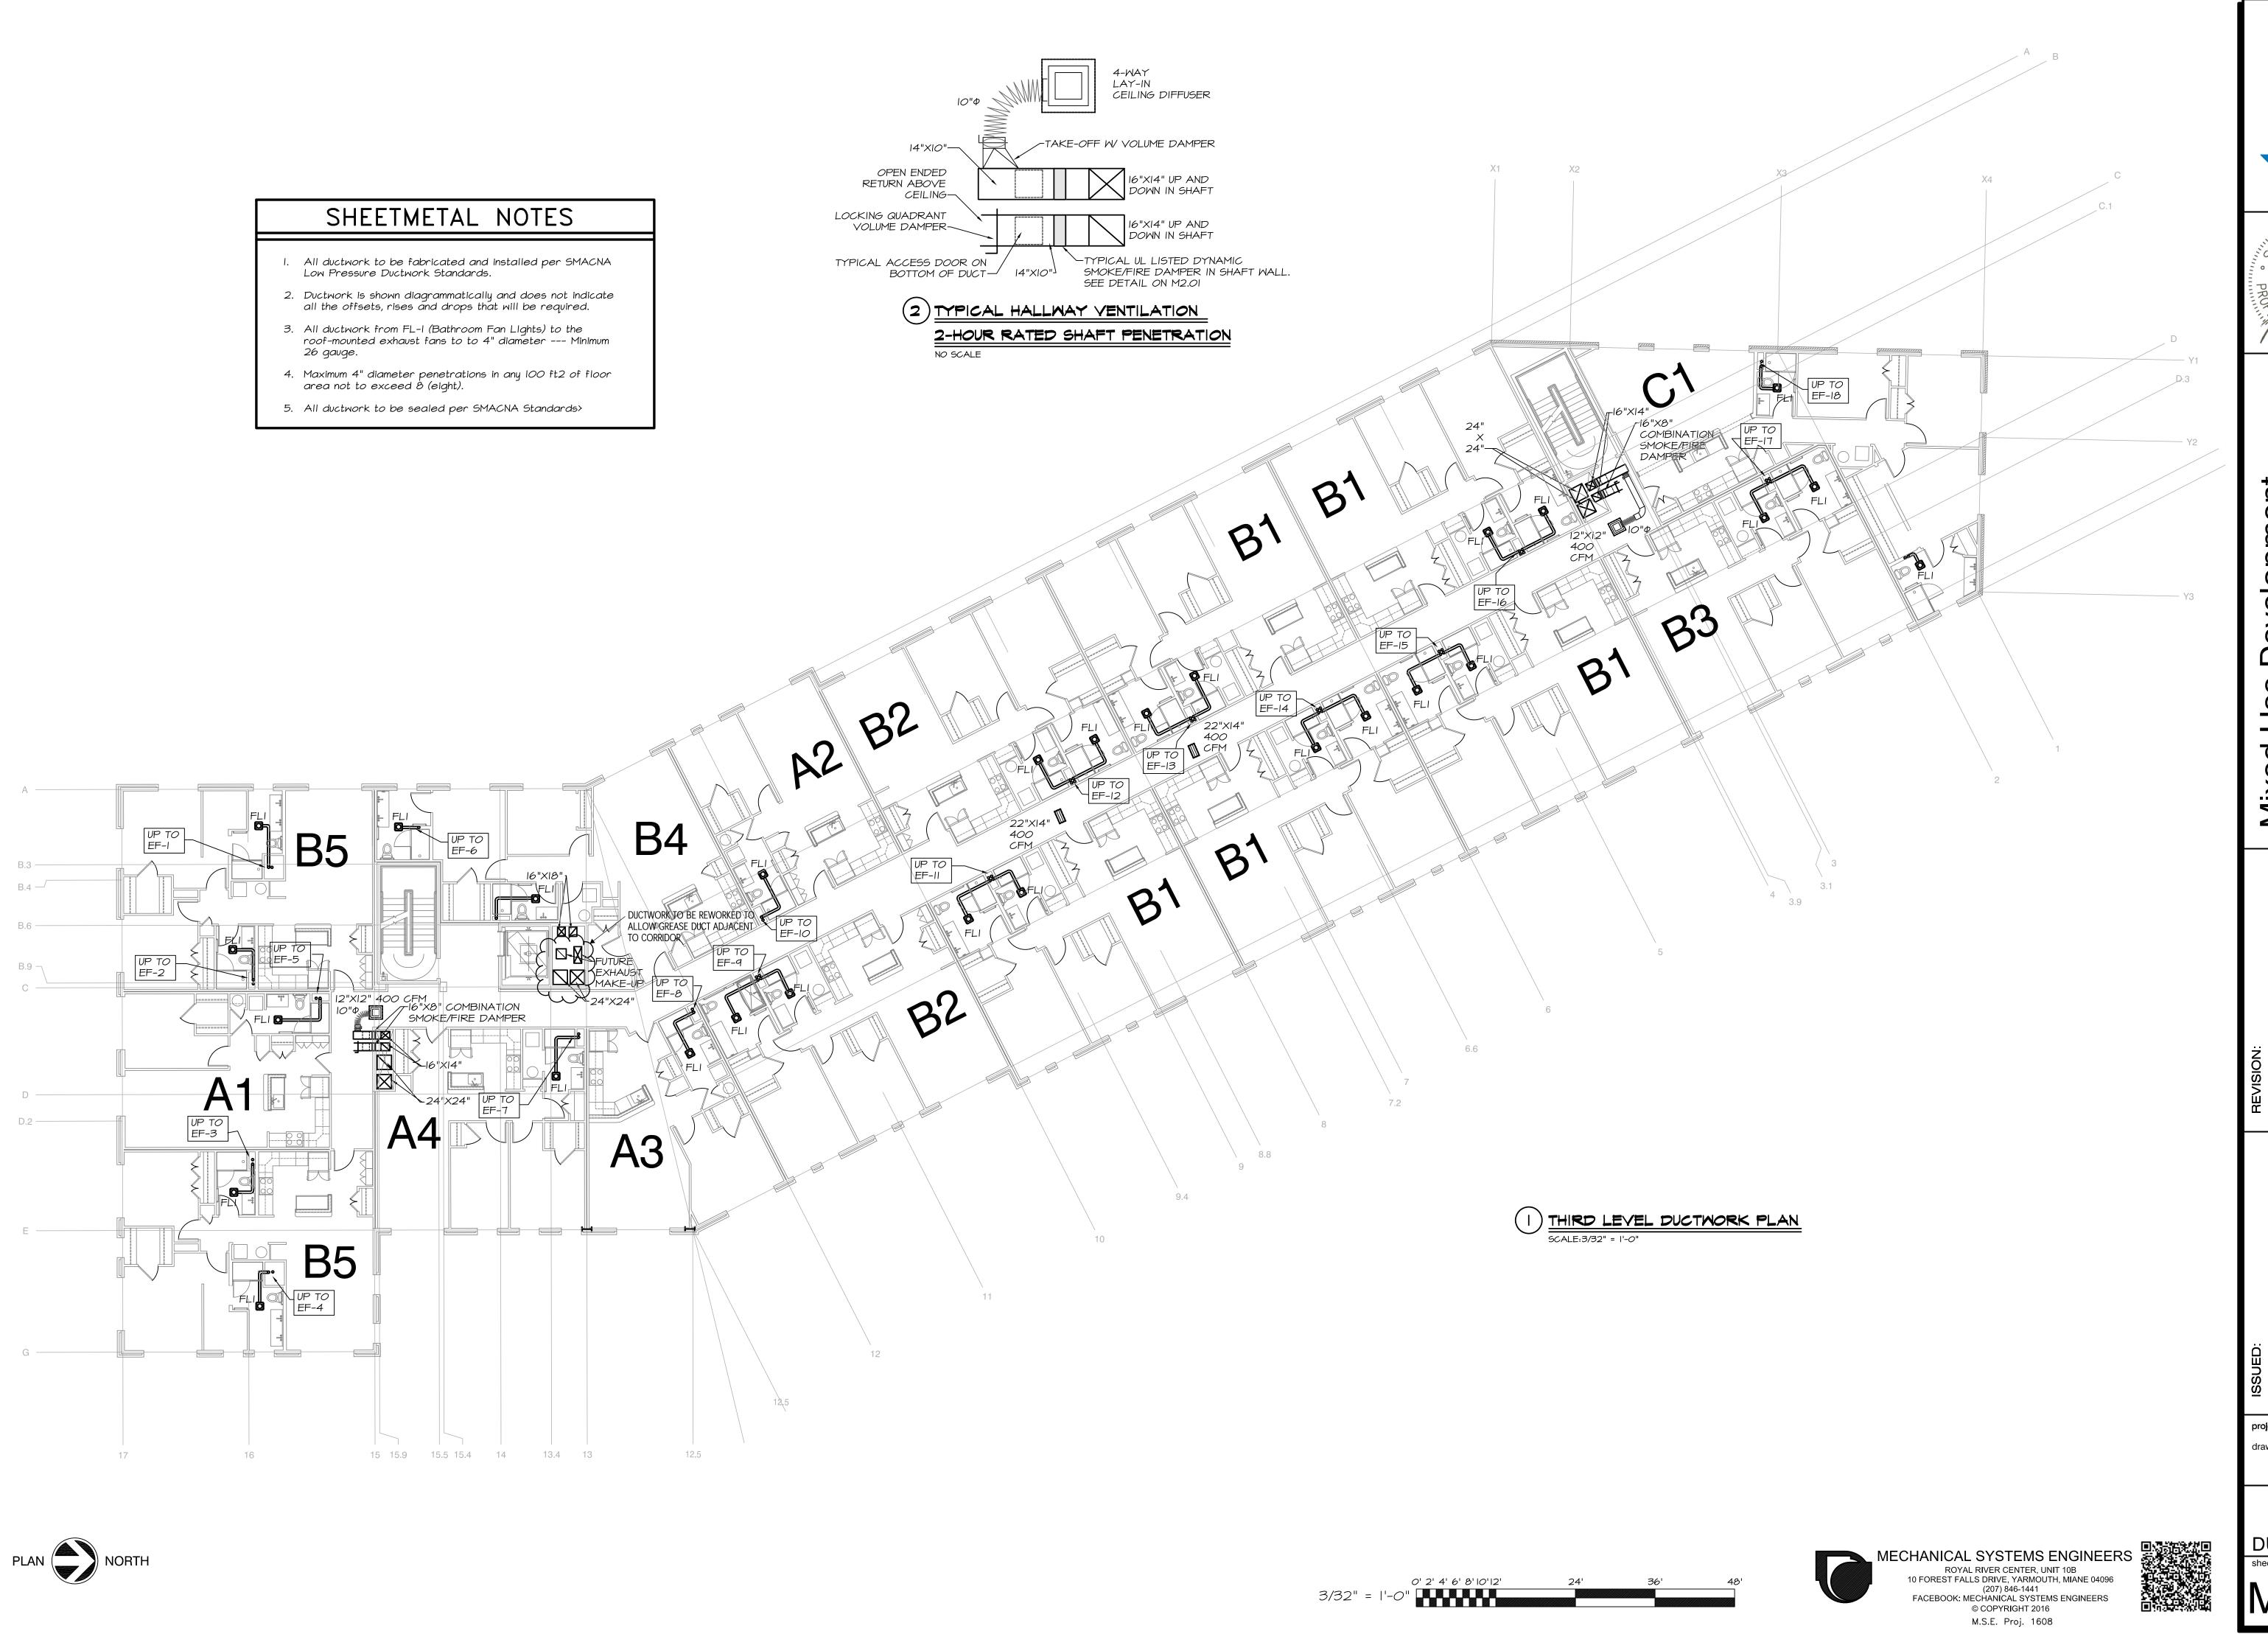

project architect: KAK drawn by: KFM

THIRD LEVEL DUCTWORK

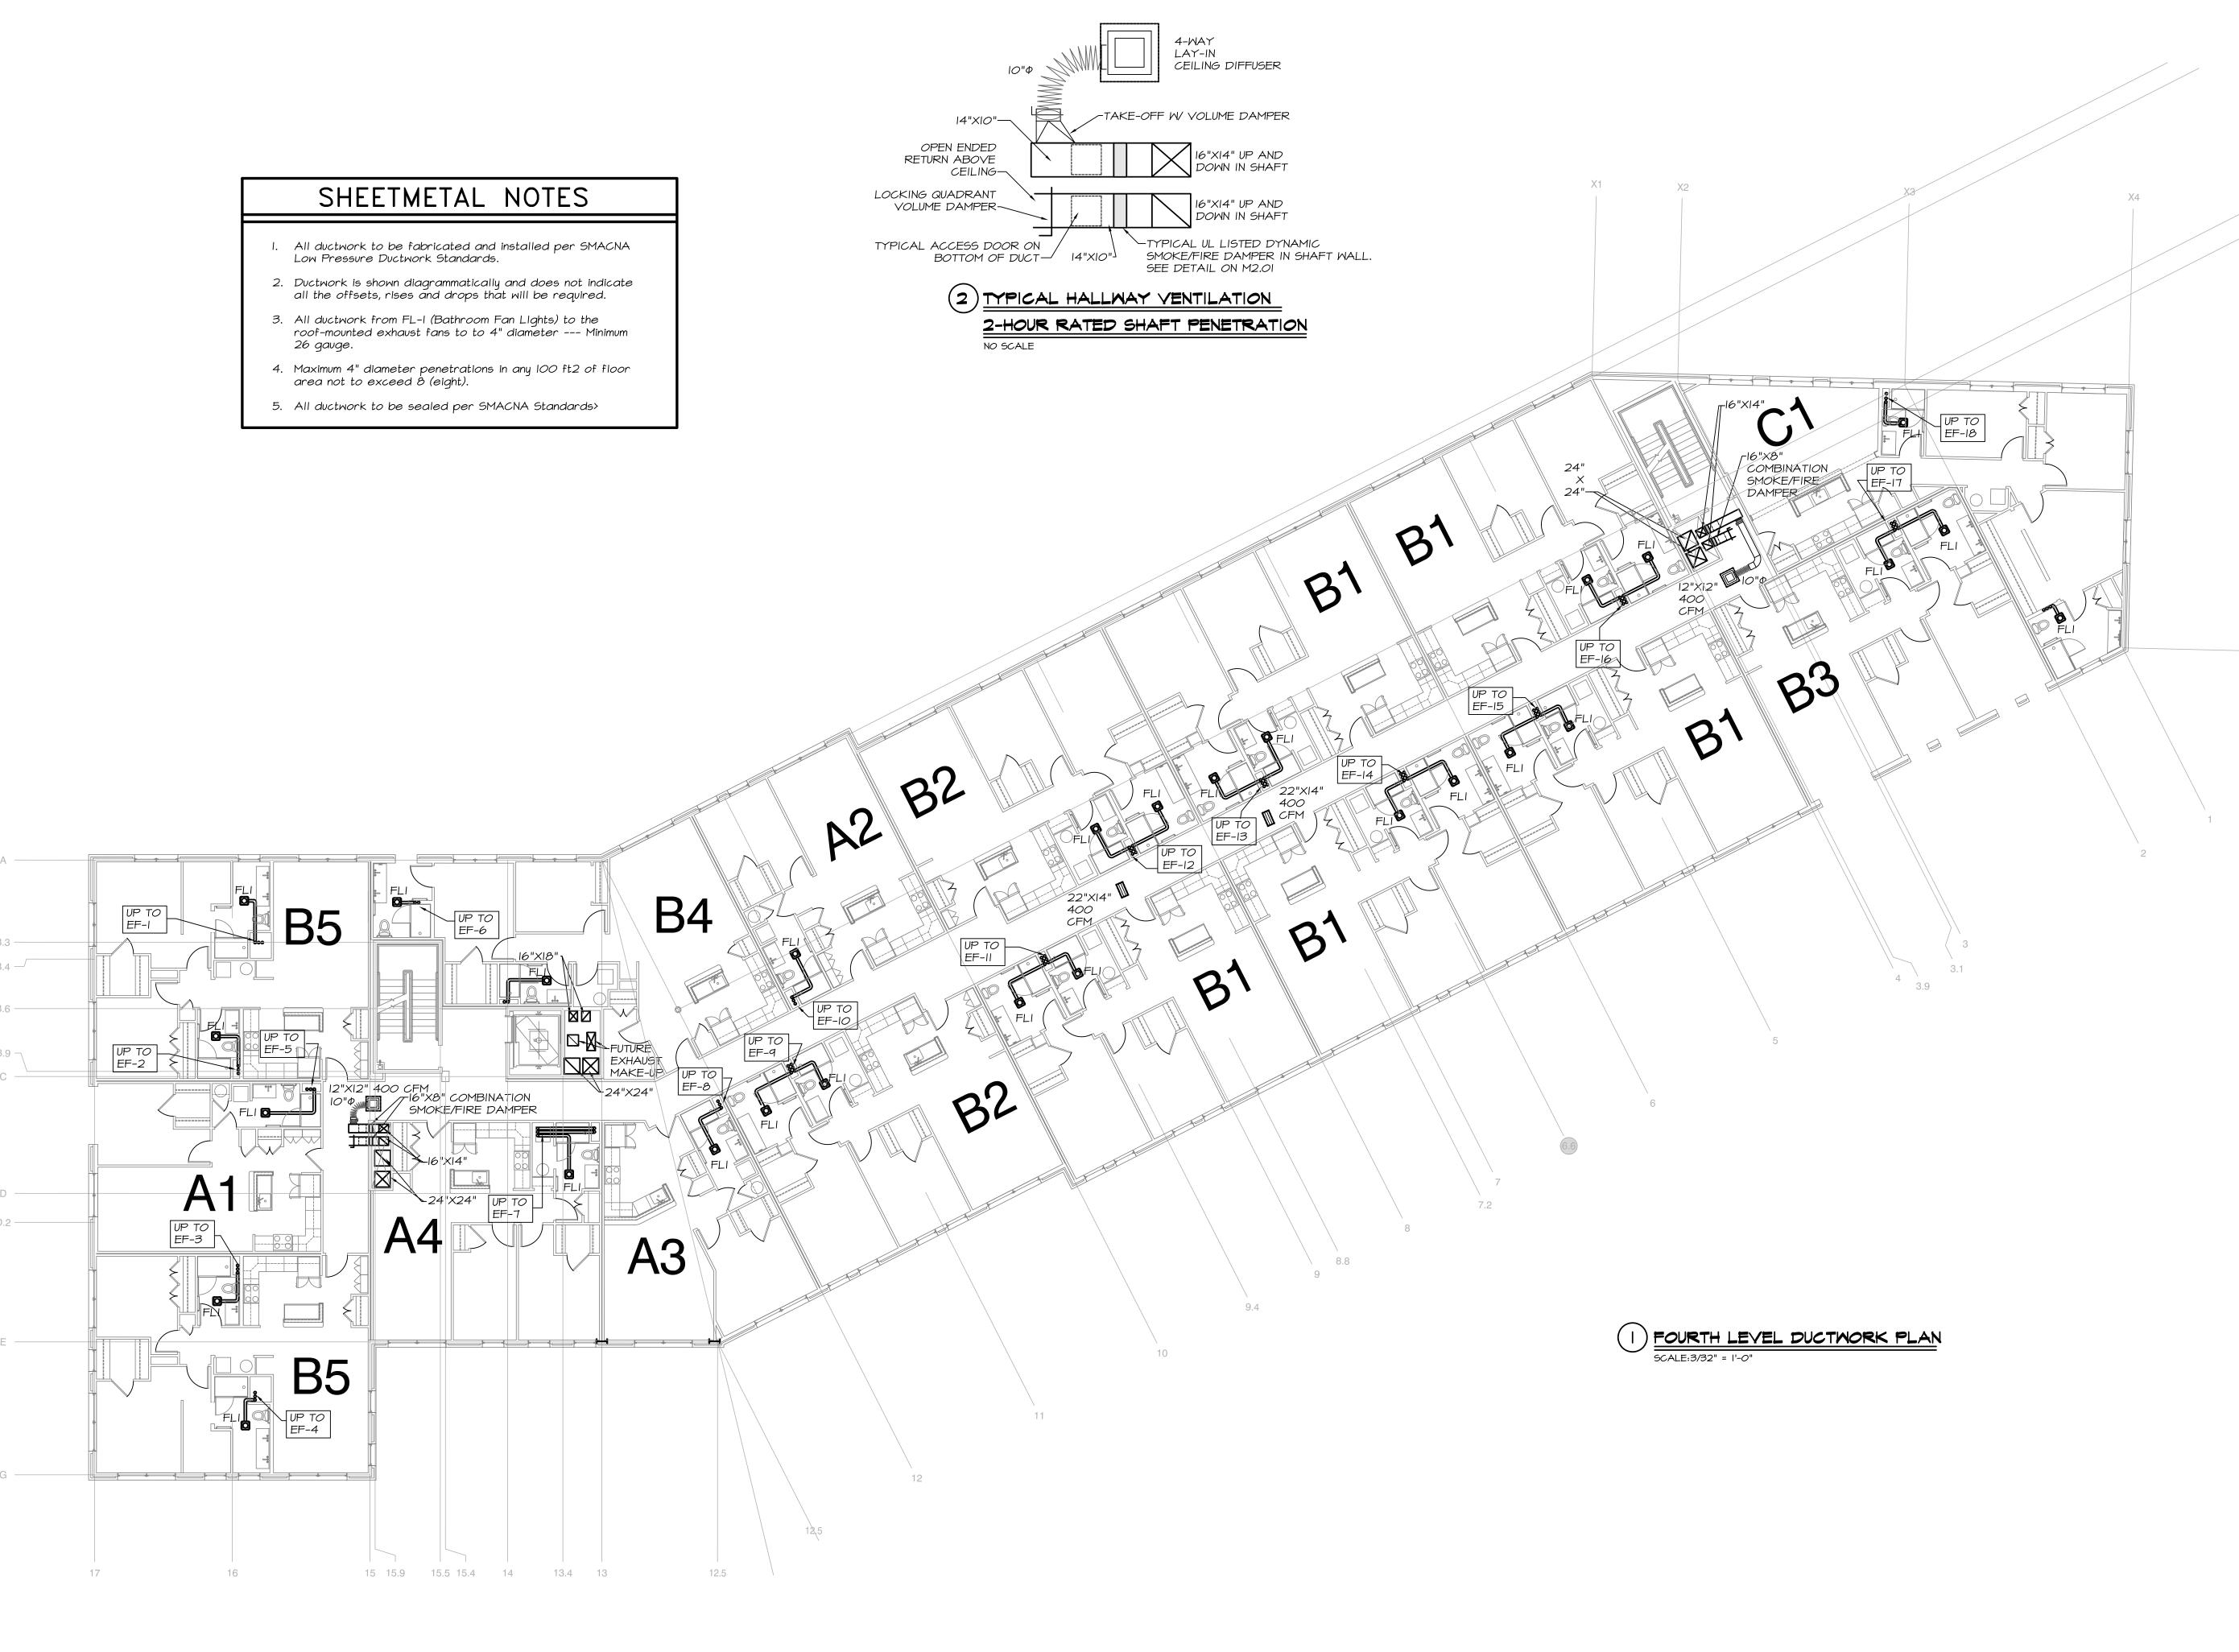

0' 2' 4' 6' 8' 10' 12' 3/32" = 1'-0"

MECHANICAL SYSTEMS ENGINEERS

ROYAL RIVER CENTER, UNIT 10B

10 FOREST FALLS DRIVE, YARMOUTH, MIANE 04096
(207) 846-1441


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project architect: KAK

FOURTH


LEVEL

DUCTWORK

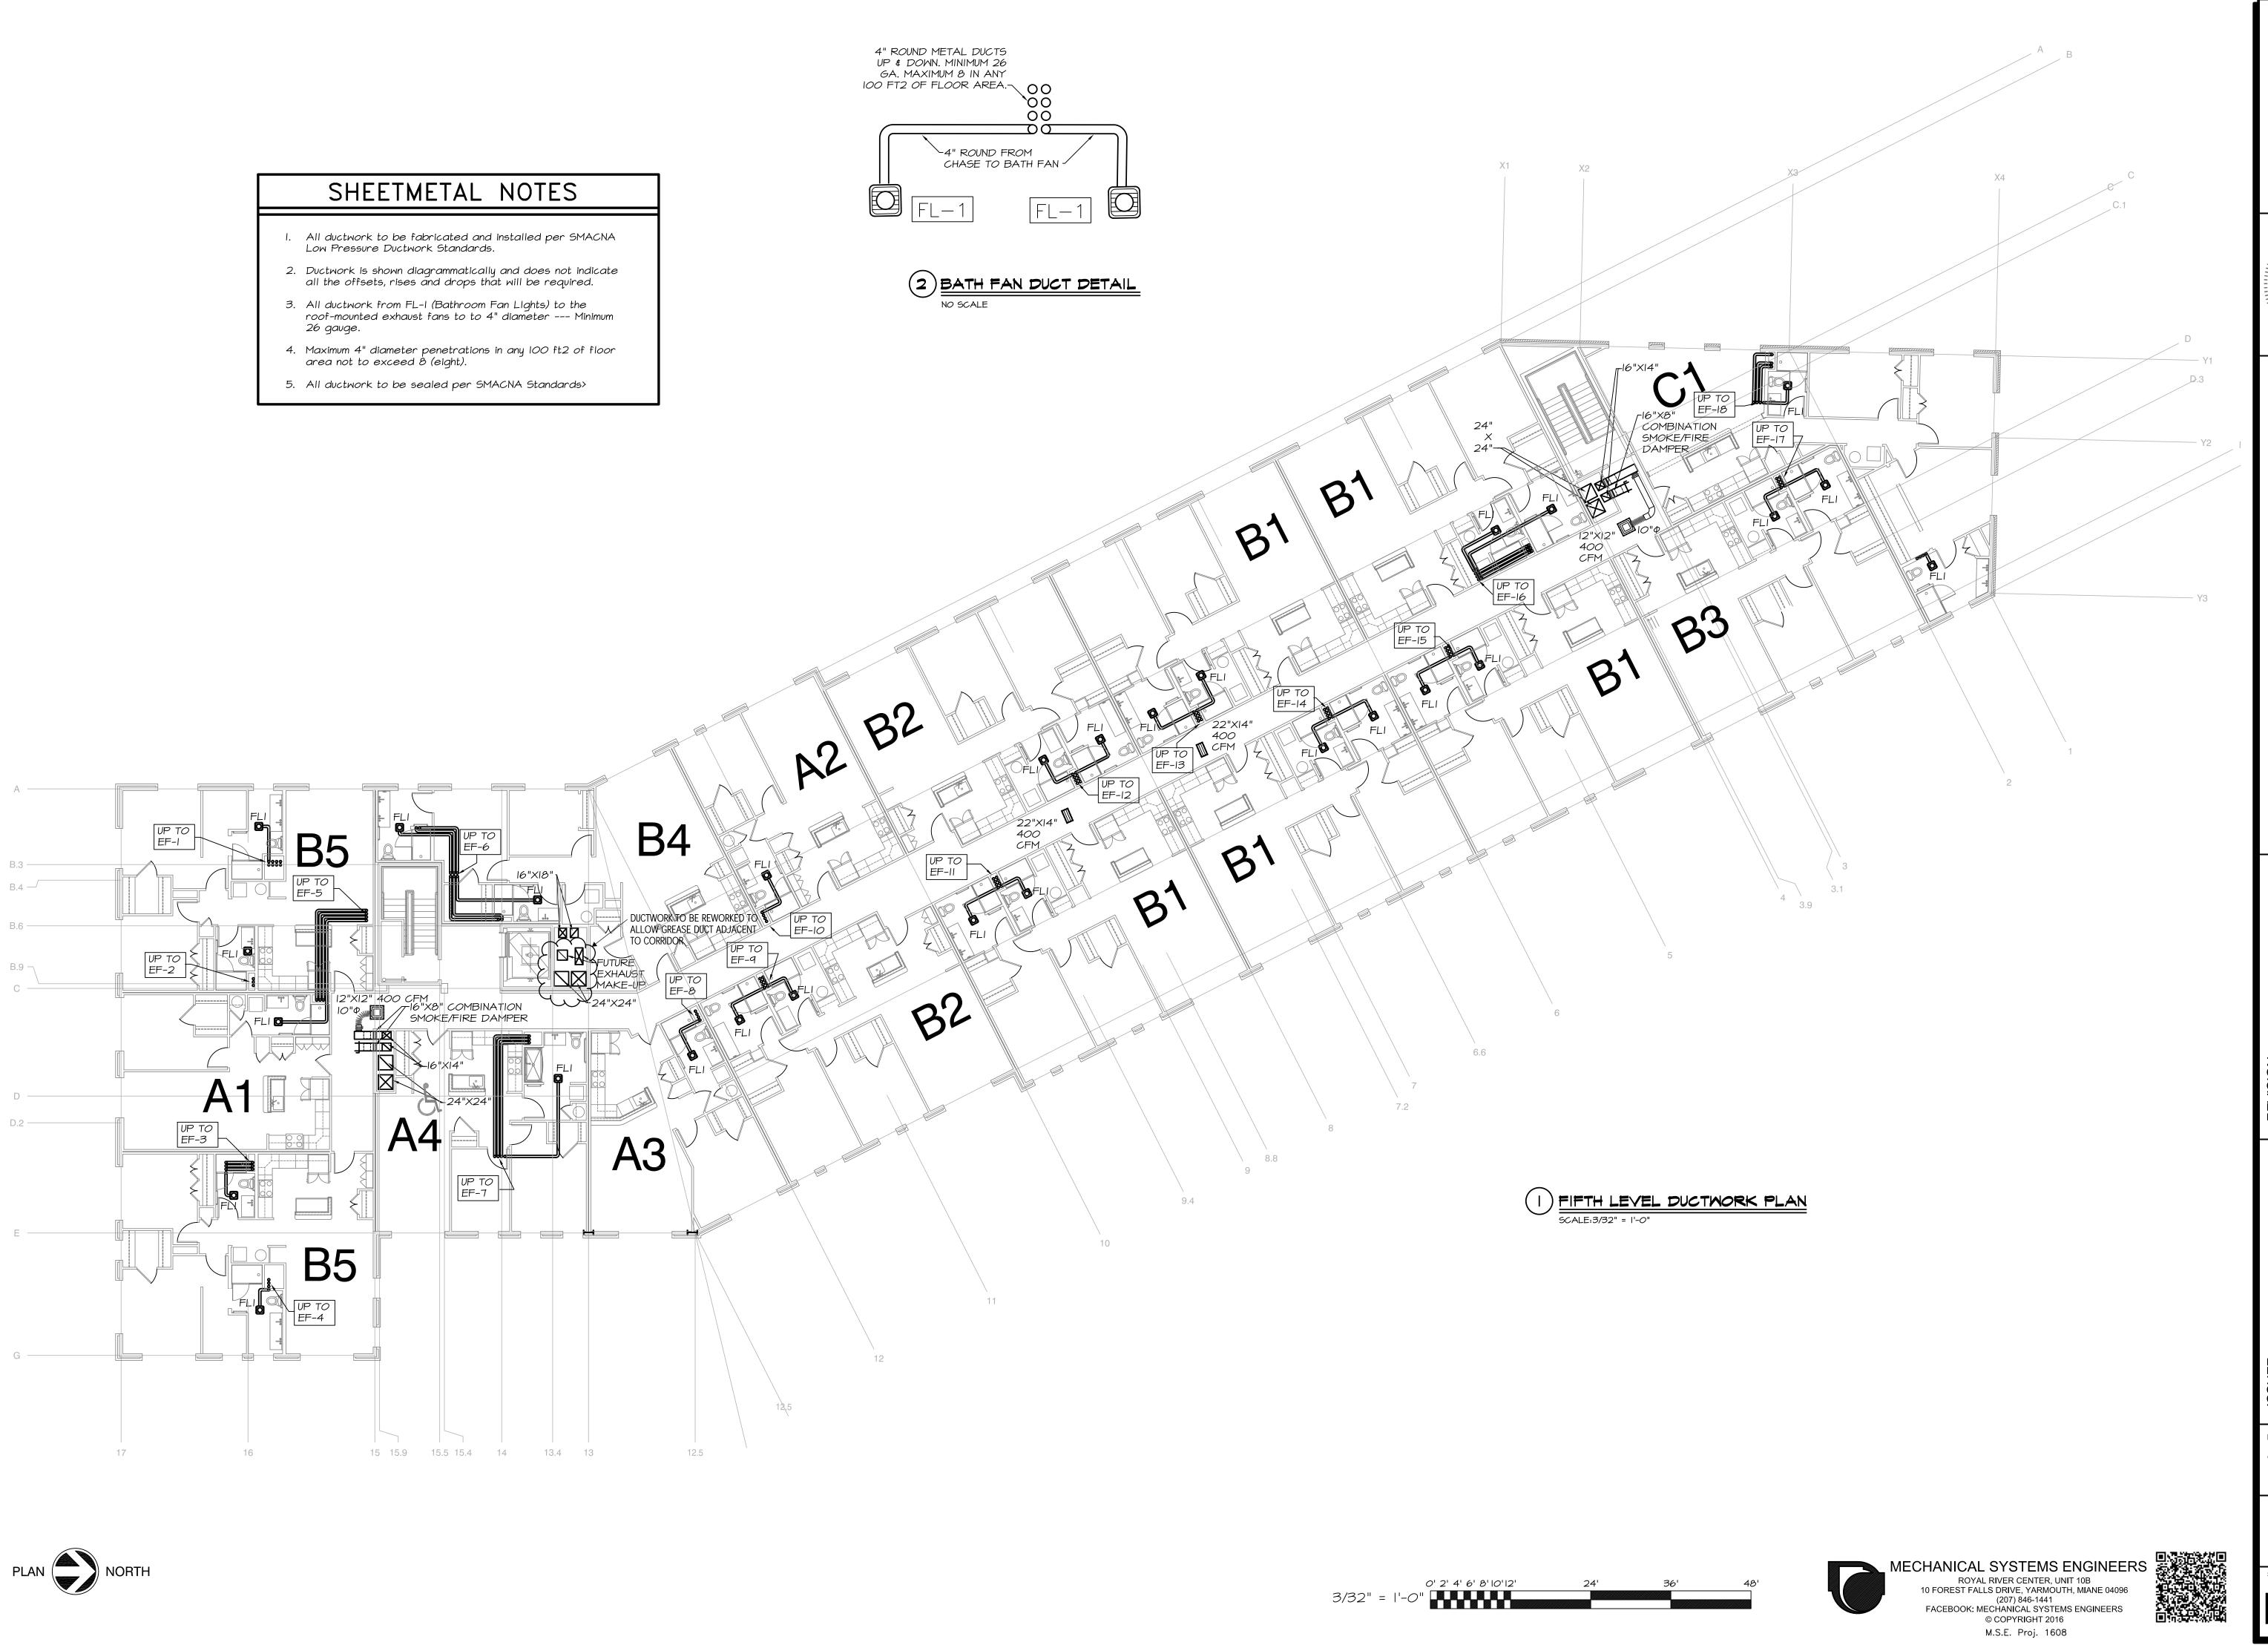

project architect: KAK

FIFTH LEVEL DUCTWORK

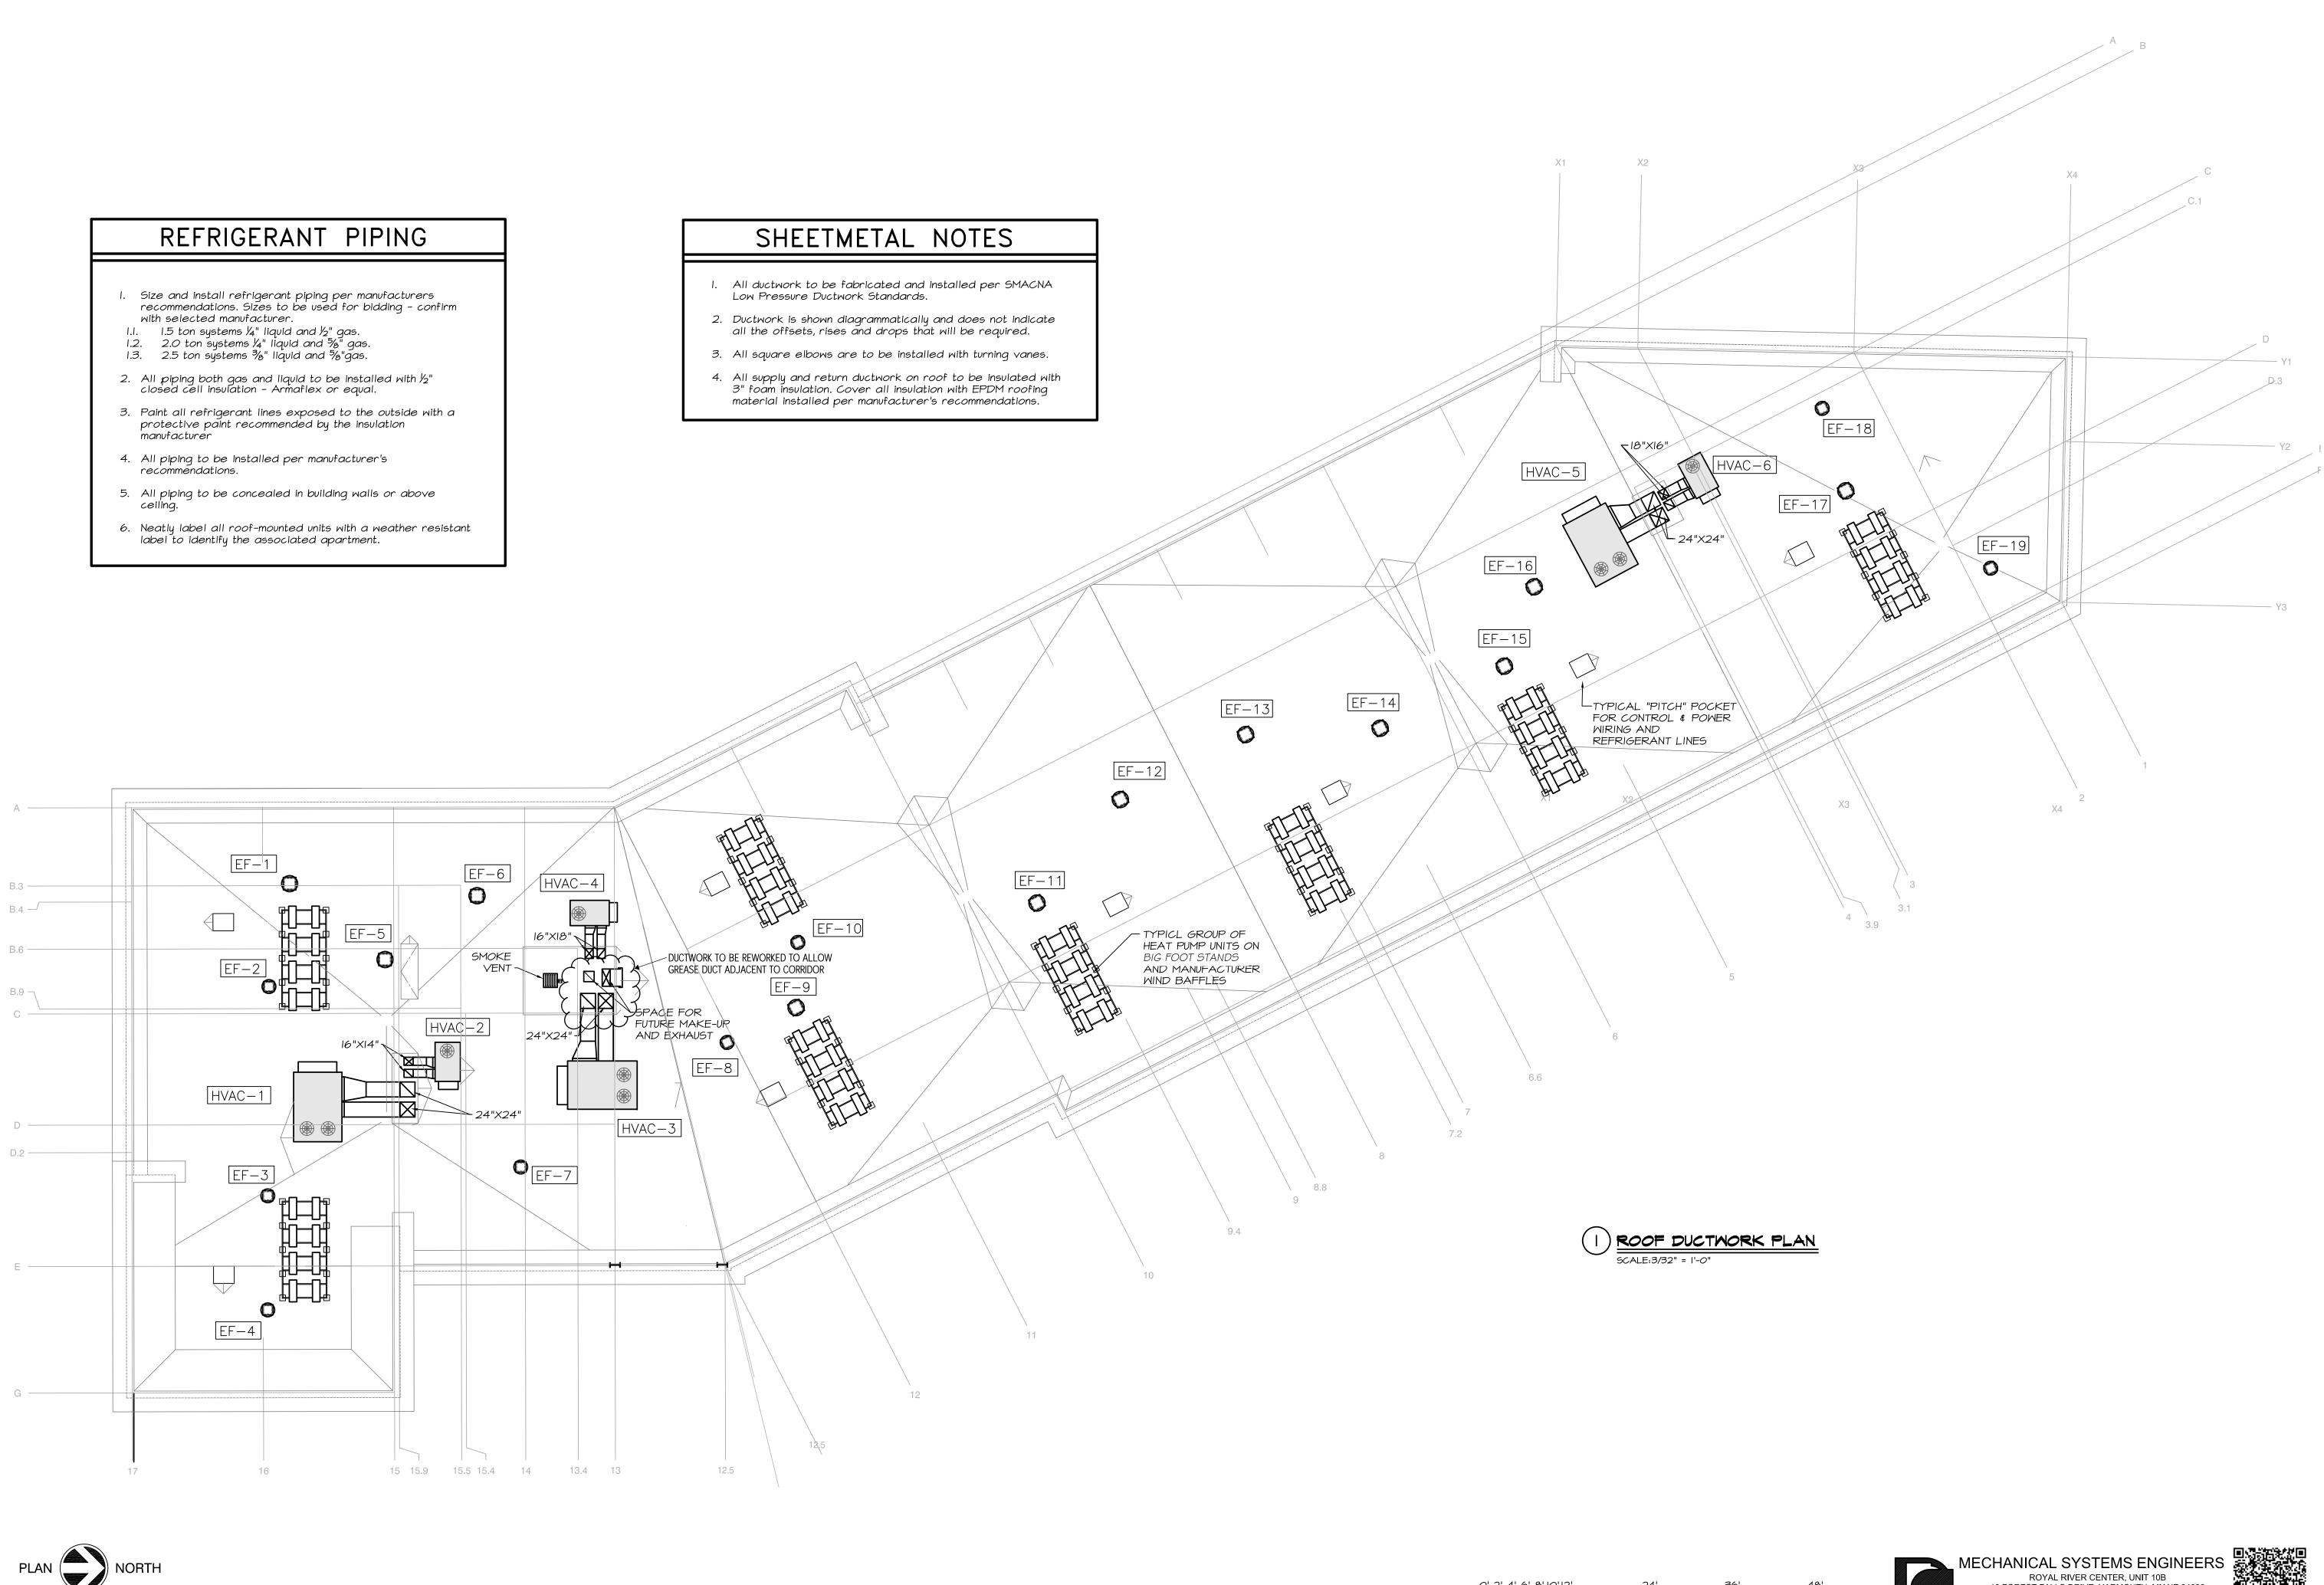

0' 2' 4' 6' 8' 10' 12' 3/32" = 1'-0"

Kurt F.

project architect: KAK


drawn by: KFM

ROOF DUCTWORK


10 FOREST FALLS DRIVE, YARMOUTH, MIANE 04096 (207) 846-1441


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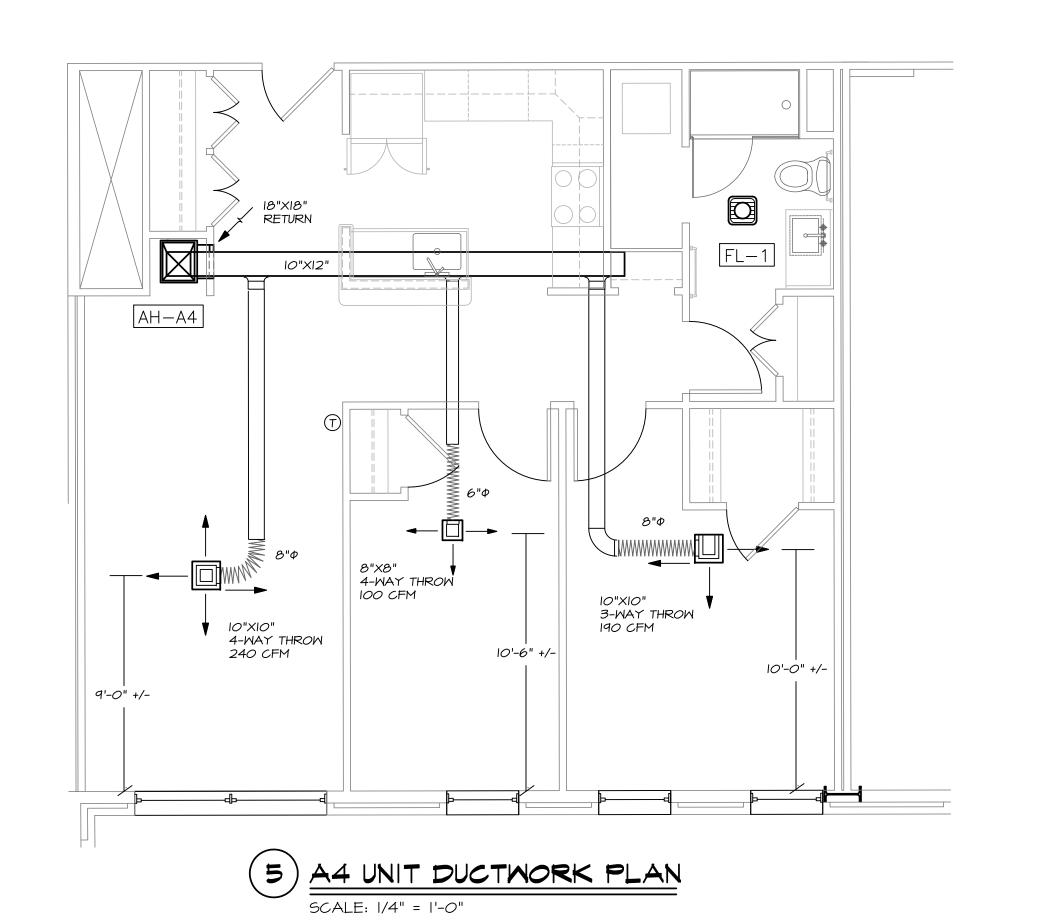


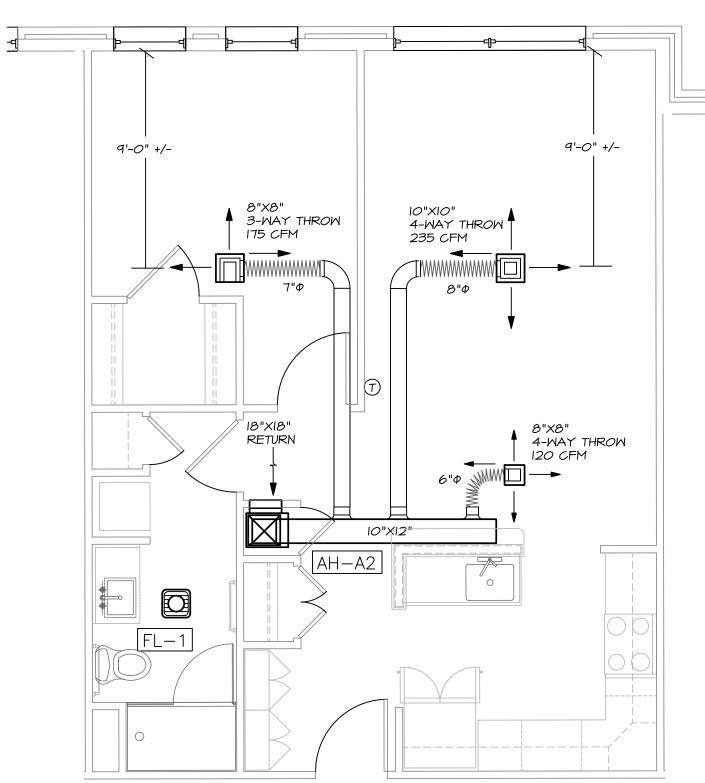


A2 UNIT DUCTWORK PLAN SCALE: 1/4" = 1'-0"



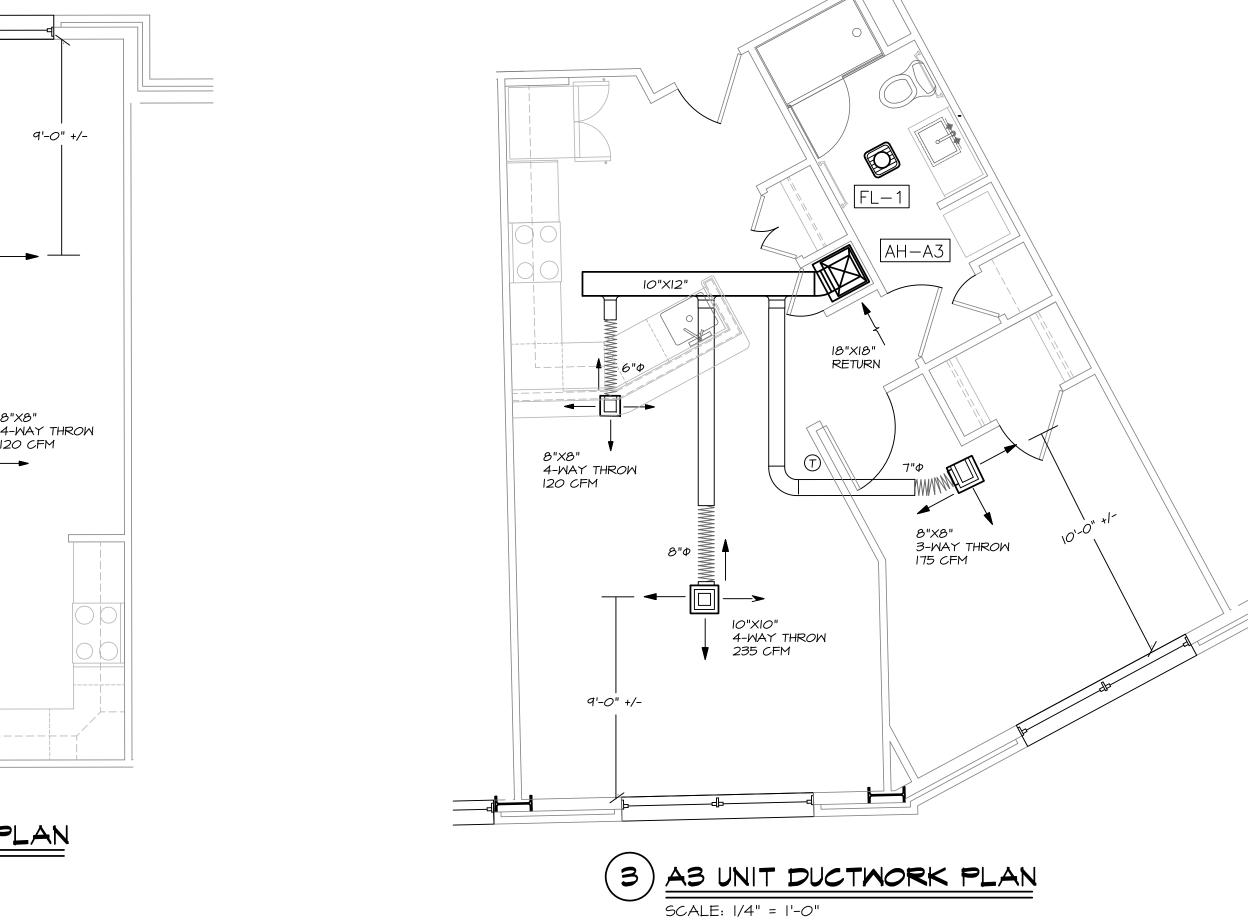

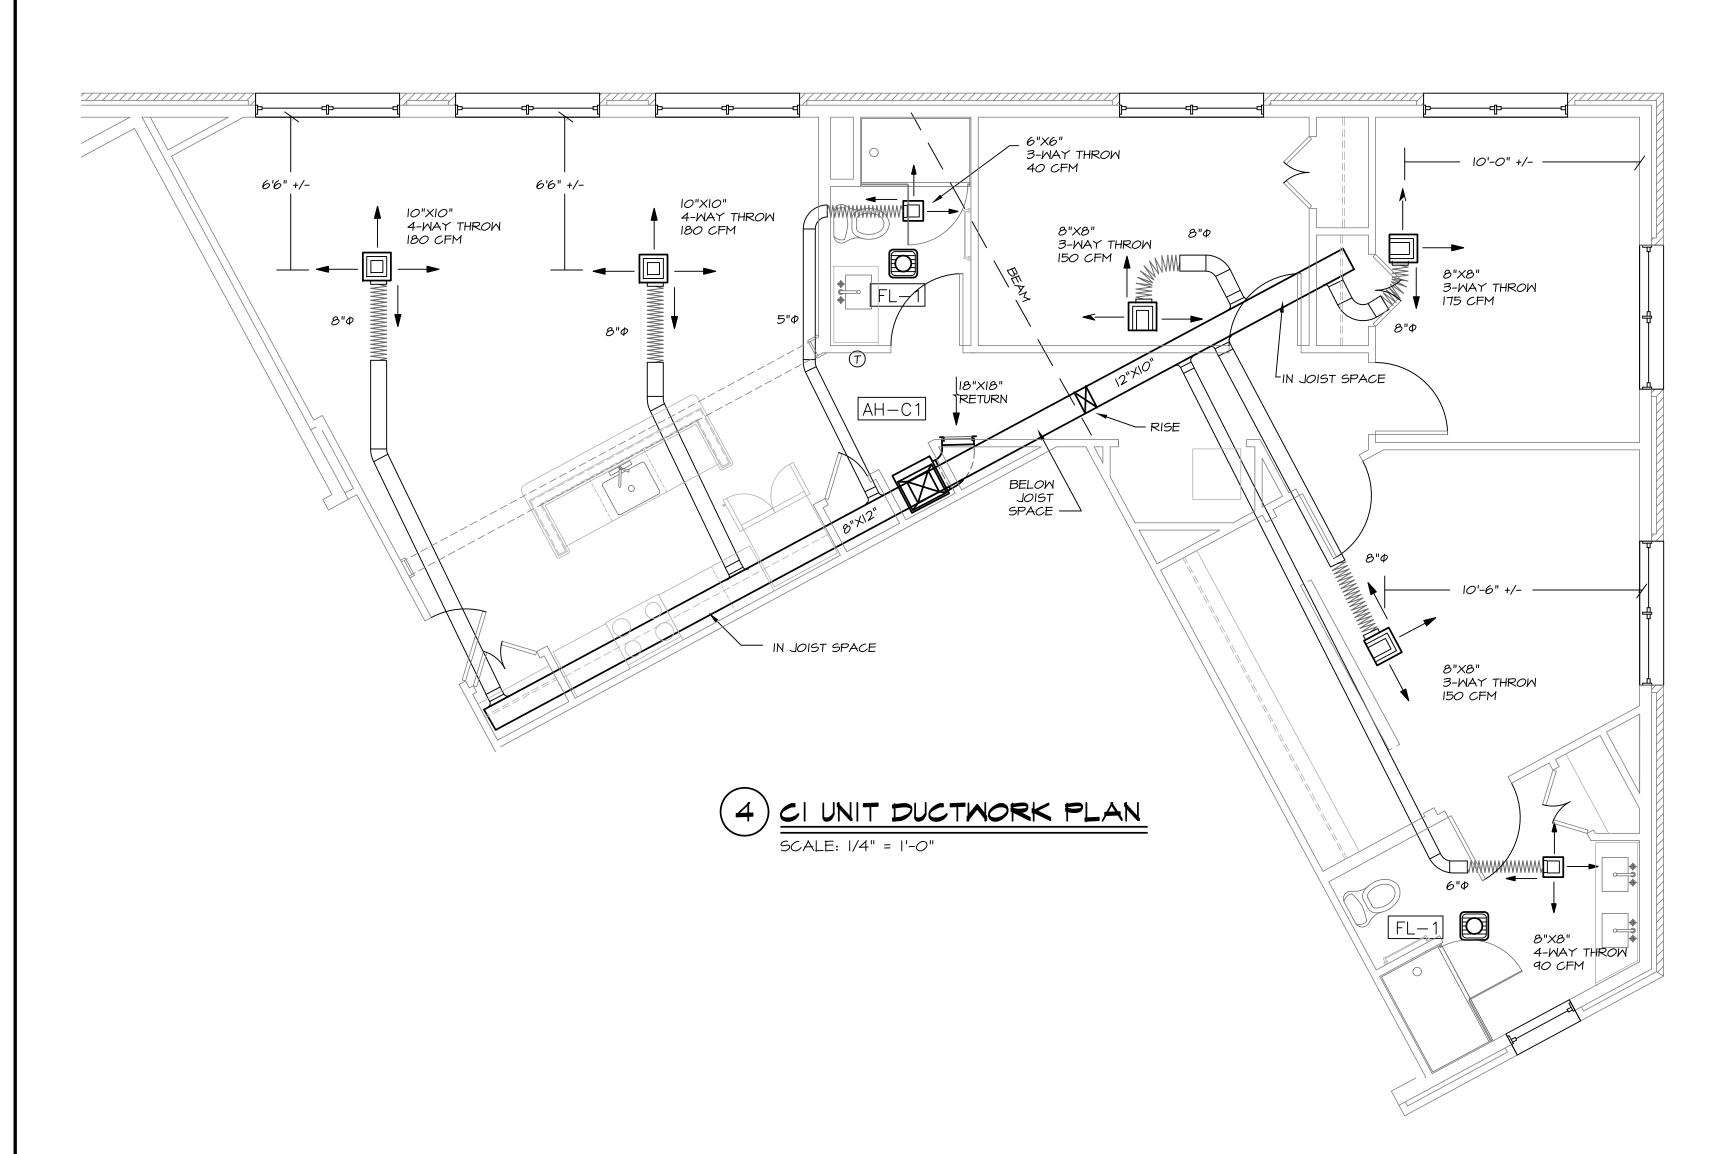

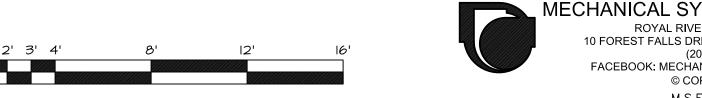






Development

Mixed


project architect: KAK drawn by: KFM

UNITS A &C DUCTWORK


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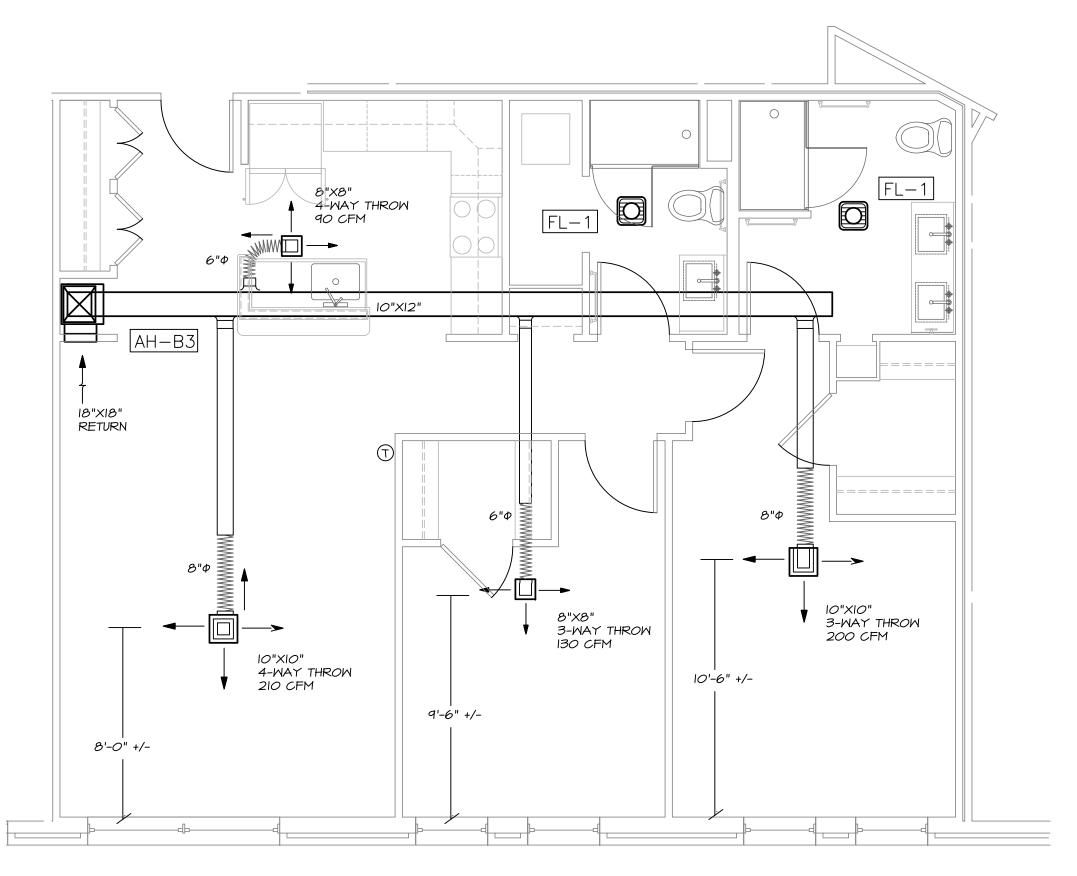
BI UNIT (STYLE I) DUCTWORK PLAN SCALE: 1/4" = 1'-0"

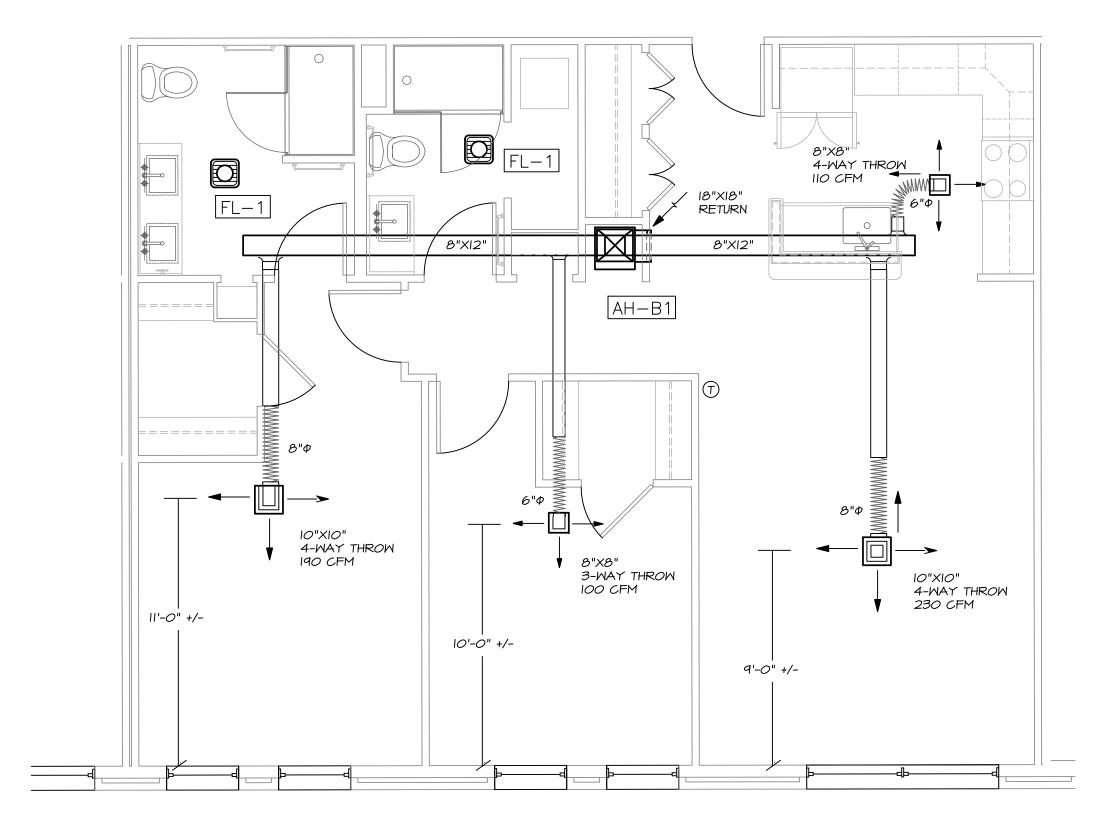


(3) B2 UNIT DUCTMORK PLAN SCALE: 1/4" = 1'-0"

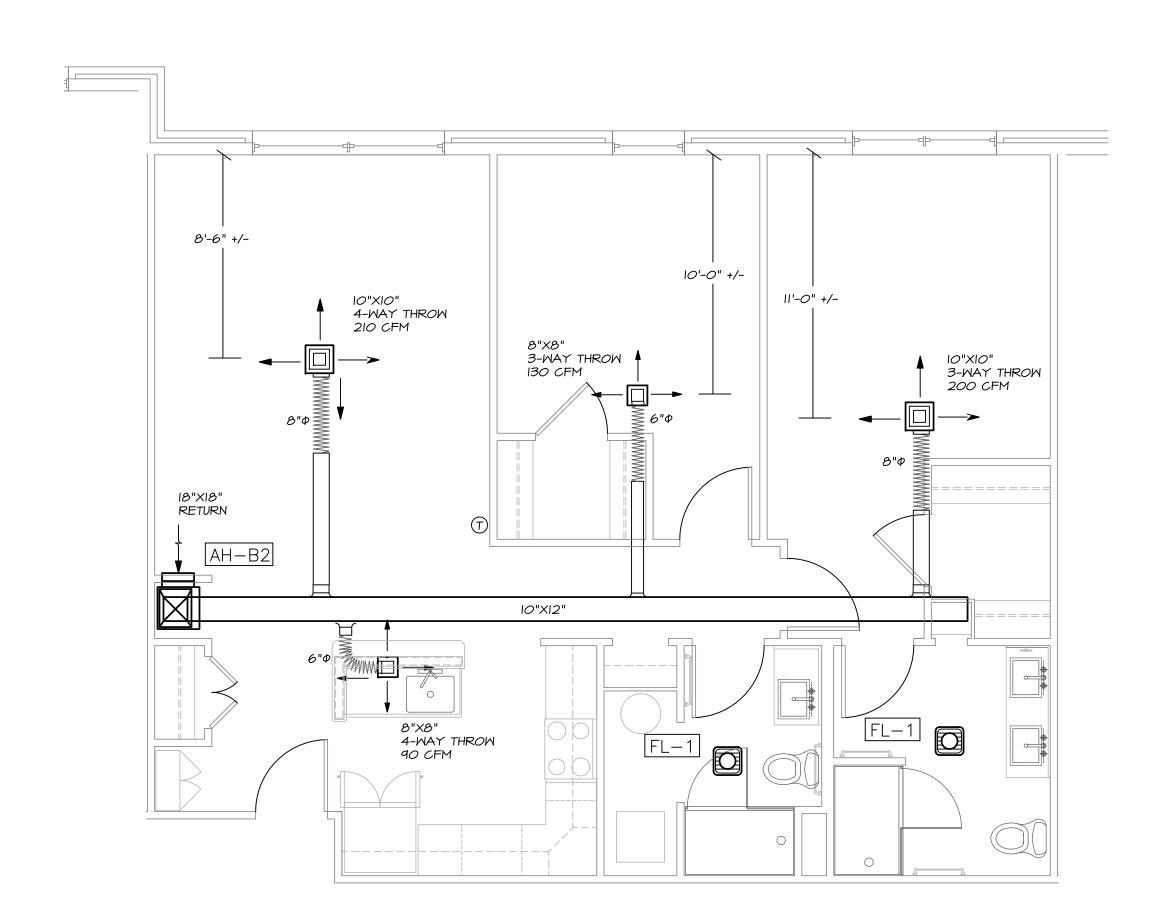

(2) BI UNIT (STYLE 2) DUCTMORK PLAN SCALE: 1/4" = 1'-0"

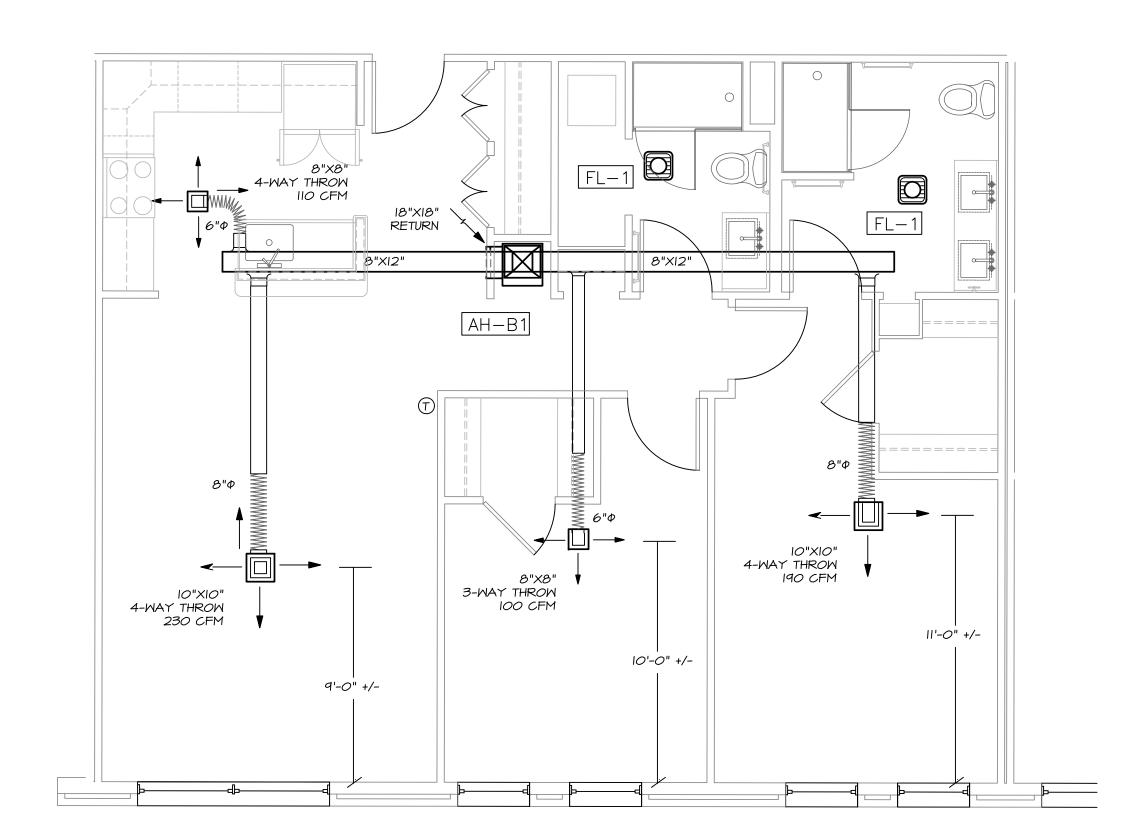

(4) B3 UNIT DUCTWORK PLAN SCALE: 1/4" = 1'-0"

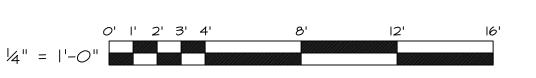







Development

Mixed


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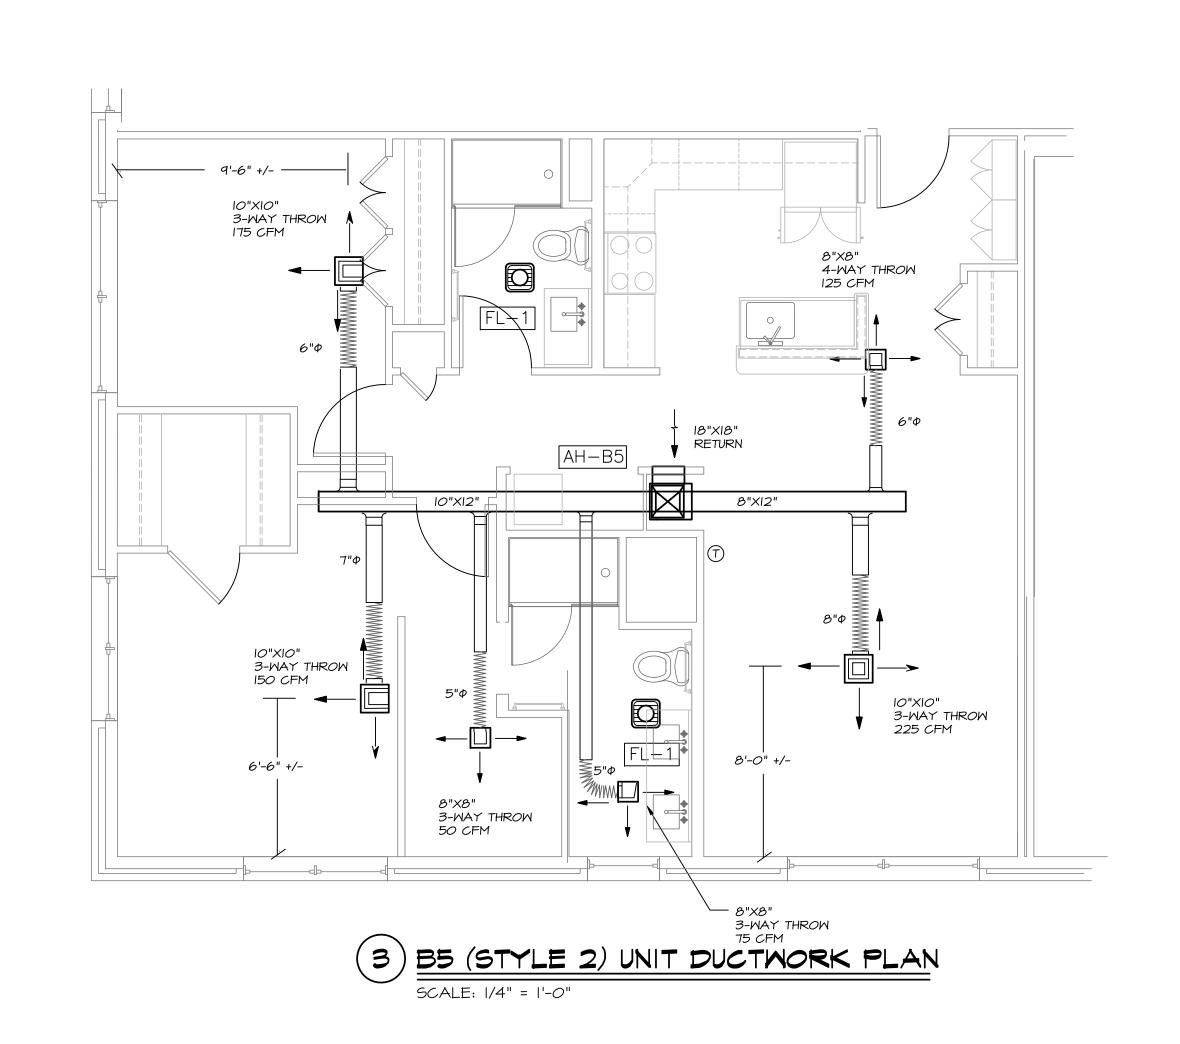
project architect: KAK

B1,2&3

DUCTWORK

drawn by: KFM



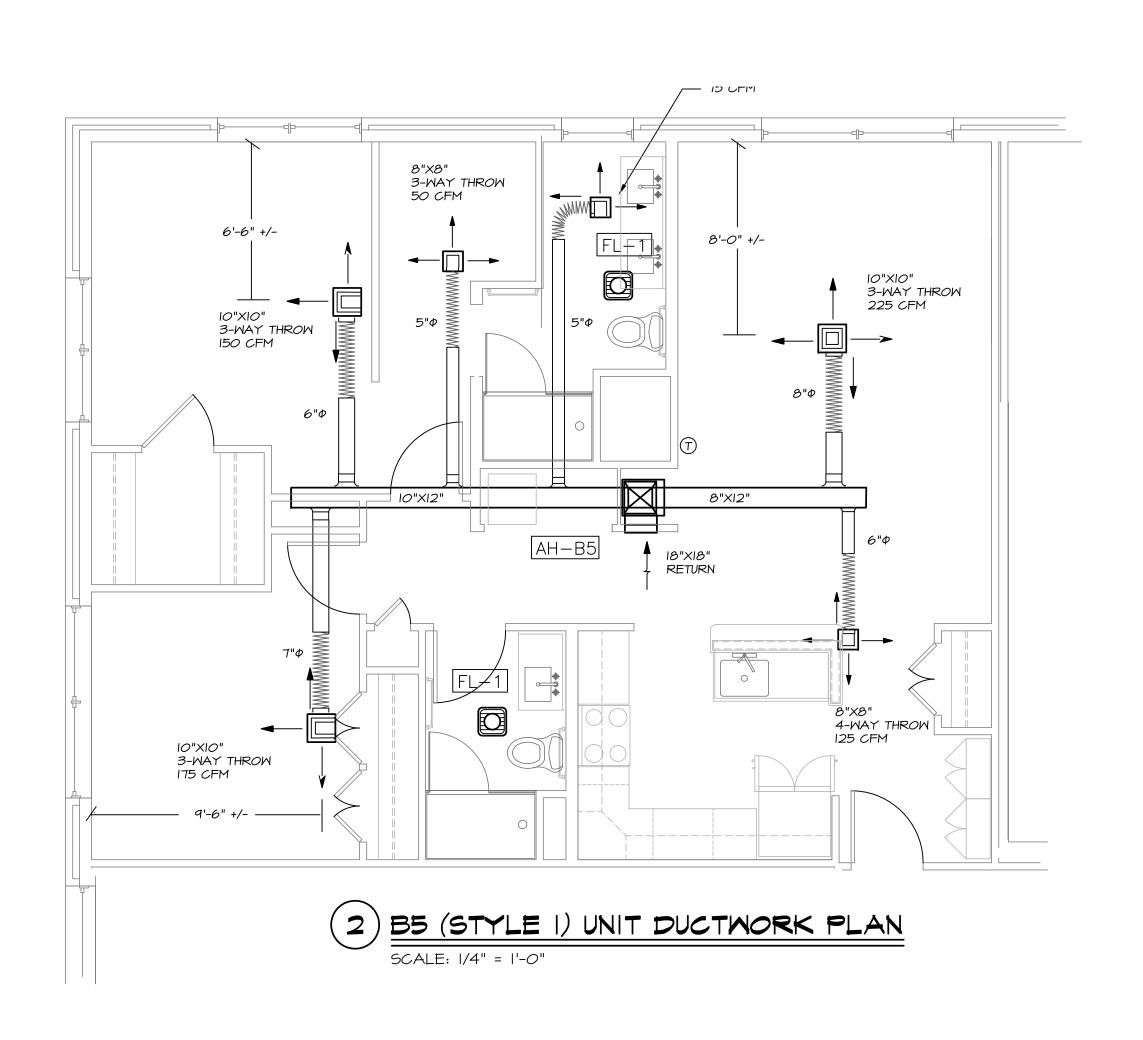







project architect: KAK

UNITS B4&5

DUCTWORK

drawn by: KFM

sheet number:


Kurt F.

Development

Mixed

Xref ..\Architectural\24x36 Border.dwg

NO SCALE

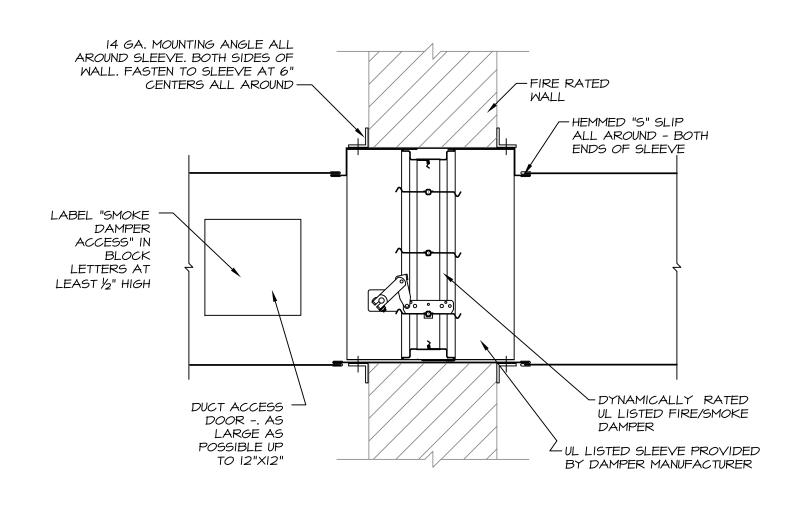


 $(\ 2\)$ wall smoke/fire damper style "b" NO SCALE


VARIABLE SPEED DIRECT DRIVE EXHAUST FAN INSULATED ADAPTOR CURB TO ADJUST TO 24"X24" ROOF CURB. ∕GASKET ALL AROUND TO BE PROVIDED BY FAN MANUFACTURER --PRESSURE SENSOR - SET @ -0.10" W.C. ∕GASKET ALL AROUND INSULATED 14" HIGH TYPICAL 4" EXHAUST VENT. FOUR 4" 24"X24" ROOF CURB BY IN SMALLER FANS AND TWO ROWS OF FOUR IN LARGER FANS. FAN MANUFACTURER -/ 20 GAUGE PLATE. SEAL PLATE TO ALL EXHAUST DUCTS - AIR TIGHT

BATHROOM EXHAUST TERMINATIONS TYPICAL EF-I THROUGH EF-18


NO SCALE

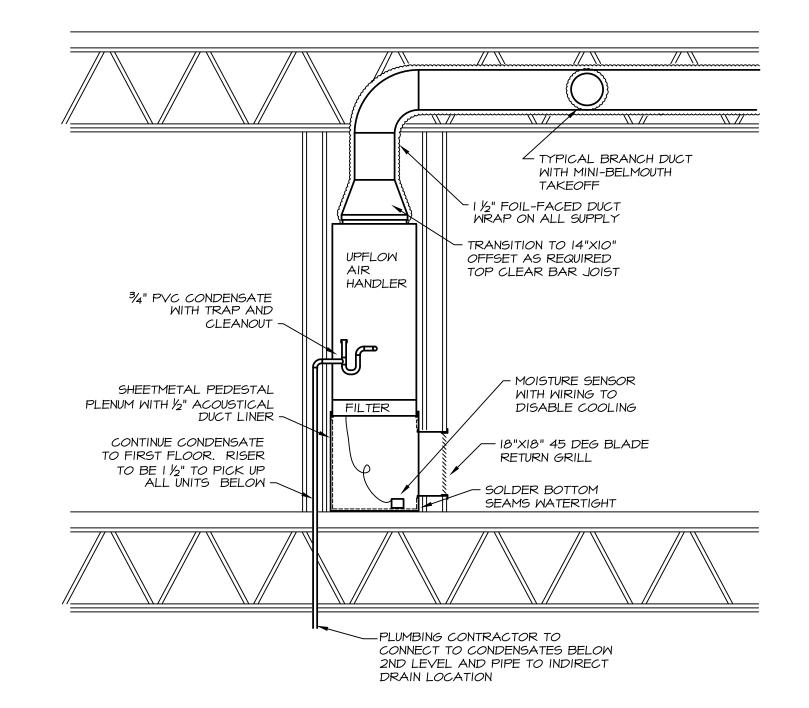

SECTION VIEW AIR HANDLER - DUCT IN ONE DIRECTON SCALE: 1/8" = 1'-0"

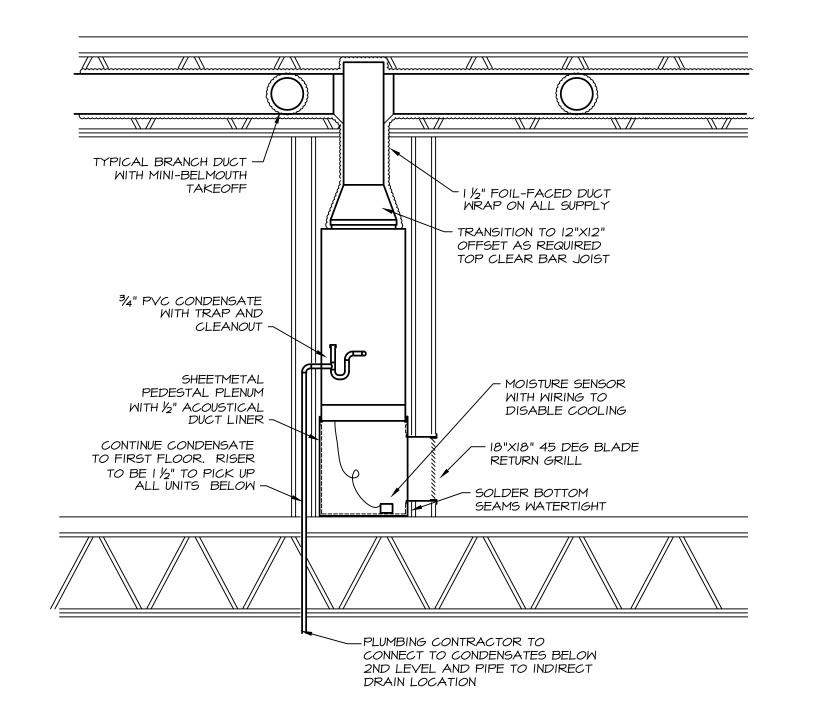

SECTION VIEW AIR HANDLER - DUCT IN TWO DIRECTIONS SCALE: 1/8" = 1'-0"

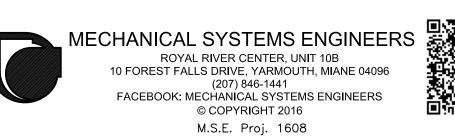

sheet number:

Xref ..\Architectural\24x36 Border.dwg

Kurt Magnusson 10257

velopme

York & Portlan

project architect: KAK

drawn by: KFM

MECHANICAL DETAILS

	HVAC UNIT SCHEDULE																
TAC	ACCEPTABLE MANUEACTURERS NOM		CFM	505	COOLING				HEATING				ELECTRIC		WEIGHT	REMARKS	
TAG	ACCEPTABLE MANUFACTURERS	NOMINAL SIZE	СГМ	ESP	TYPE	REFRIGERANT	TOTAL	SENSIBLE	EER	FUEL	OUTPUT	STAGES	POWER	MCA	МОР	WEIGHT	REMARNS
HVAC-I	TRANE, LENNOX, YORK, CARRIER	15 TONS	6,000	1.75"	DX	410A	186,050	124,700	11.00	NAT. GAS	280,000	2	208/60/3	81.0	110	2,100 LBS	WITH FACTORY ROOF CURB, (SEE NOTE BELOW) ECONOMIZER, BAROMETRIC RELIEF, RETURN AIR SMOKE DETECTOR, THROUGH-THE-CURB ELECTRIC AND GAS
HVAC-2	TRANE, LENNOX, YORK, CARRIER	4 TONS	1,600	0.90"	DX	410A	48,200	36,440	II.O	NAT. GAS	65,600	I	208/60/3	25.4	35	550 LBS	WITH FACTORY ROOF CURB, (SEE NOTE BELOW) ECONOMIZER, BAROMETRIC RELIEF, RETURN AIR SMOKE DETECTOR, THROUGH-THE-CURB ELECTRIC AND GAS
HVAC-3	TRANE, LENNOX, YORK, CARRIER	15 TONS	6,000	1.75"	DX	410A	186,050	124,700	11.00	NAT. GAS	280,000	2	208/60/3	81.0	110	2,100 LBS	WITH FACTORY ROOF CURB, (SEE NOTE BELOW) ECONOMIZER, BAROMETRIC RELIEF, RETURN AIR SMOKE DETECTOR, THROUGH-THE-CURB ELECTRIC AND GAS
HVAC-4	TRANE, LENNOX, YORK, CARRIER	5 TONS	2,000	0.90"	DX	410A	60,020	47,590	II.O	NAT. GAS	65,600	I	208/60/3	28.3	40	850 LBS	WITH FACTORY ROOF CURB, (SEE NOTE BELOW) ECONOMIZER, BAROMETRIC RELIEF, RETURN AIR SMOKE DETECTOR, THROUGH-THE-CURB ELECTRIC AND GAS
HVAC-5	TRANE, LENNOX, YORK, CARRIER	15 TONS	6,000	1.75"	DX	410A	186,050	124,700	11.00	NAT. GAS	280,000	2	208/60/3	81.0	110	2,100 LBS	WITH FACTORY ROOF CURB, (SEE NOTE BELOW) ECONOMIZER, BAROMETRIC RELIEF, RETURN AIR SMOKE DETECTOR, THROUGH-THE-CURB ELECTRIC AND GAS
HVAC-6	TRANE, LENNOX, YORK, CARRIER	4 TONS	1,600	0.90"	DX	410A	48,200	36,440	11.0	NAT. GAS	65,600	l	208/60/3	25.4	35	550 LBS	WITH FACTORY ROOF CURB, (SEE NOTE BELOW) ECONOMIZER, BAROMETRIC RELIEF, RETURN AIR SMOKE DETECTOR, THROUGH-THE-CURB ELECTRIC AND GAS

							FAN	SCHEDULE		
TAG	ACCEPTABLE MANUFACTURERS	ТҮРЕ	CFM	ESP	ELECTR	IC		REMARKS	CONTROL	
	MODEL MARKET METALENE	2	01 111	20.	POWER	BHP	AMPS	NEW WICE	OGNINGE	
FL-I	BROAN XB8OL	CEILIING FAN-LIGHT	80	O.I"	115 / 60 / 1		5.0	COMBINATION FAN/LIGHT WITH ADJUSTABLE TIME DELAY OFF IN-FAN	POWERED BY ROOM LIGHT SWITCH	
EF-I	GREENHECK, COOK	VARIABLE SPEED CENTRIFUGAL	0-480	0.1"	115 / 60 / 1	0.04		ROOF-MOUNTED WITH ROOF CURB, ADAPTOR CURB , DISCONNECT & ECM MOTOR	SPEED CONTROLLED BY PRESSURE CONTROLLER	
EF-2	GREENHECK, COOK	VARIABLE SPEED CENTRIFUGAL	0-240	0.1"	115 / 60 / 1	0.02		ROOF-MOUNTED WITH ROOF CURB, ADAPTOR CURB , DISCONNECT & ECM MOTOR	SPEED CONTROLLED BY PRESSURE CONTROLLER	
EF-3	GREENHECK, COOK	VARIABLE SPEED CENTRIFUGAL	0-240	0.1"	115 / 60 / 1	0.02		ROOF-MOUNTED WITH ROOF CURB, ADAPTOR CURB , DISCONNECT & ECM MOTOR	SPEED CONTROLLED BY PRESSURE CONTROLLER	
EF-4	GREENHECK, COOK	VARIABLE SPEED CENTRIFUGAL	0-240	0.1"	115 / 60 / 1	0.02		ROOF-MOUNTED WITH ROOF CURB, ADAPTOR CURB , DISCONNECT & ECM MOTOR	SPEED CONTROLLED BY PRESSURE CONTROLLER	
EF-5	GREENHECK, COOK	VARIABLE SPEED CENTRIFUGAL	0-480	0.1"	115 / 60 / 1	0.04		ROOF-MOUNTED WITH ROOF CURB, ADAPTOR CURB , DISCONNECT & ECM MOTOR	SPEED CONTROLLED BY PRESSURE CONTROLLER	
EF-6	GREENHECK, COOK	VARIABLE SPEED CENTRIFUGAL	0-480	0.1"	115 / 60 / 1	0.04		ROOF-MOUNTED WITH ROOF CURB, ADAPTOR CURB , DISCONNECT & ECM MOTOR	SPEED CONTROLLED BY PRESSURE CONTROLLER	
EF-7	GREENHECK, COOK	VARIABLE SPEED CENTRIFUGAL	0-240	0.1"	115 / 60 / 1	0.02		ROOF-MOUNTED WITH ROOF CURB, ADAPTOR CURB , DISCONNECT & ECM MOTOR	SPEED CONTROLLED BY PRESSURE CONTROLLER	
EF-8	GREENHECK, COOK	VARIABLE SPEED CENTRIFUGAL	0-240	0.1"	115 / 60 / 1	0.02		ROOF-MOUNTED WITH ROOF CURB, ADAPTOR CURB , DISCONNECT & ECM MOTOR	SPEED CONTROLLED BY PRESSURE CONTROLLER	
EF-9	GREENHECK, COOK	VARIABLE SPEED CENTRIFUGAL	0-480	0.1"	115 / 60 / 1	0.04		ROOF-MOUNTED WITH ROOF CURB, ADAPTOR CURB , DISCONNECT & ECM MOTOR	SPEED CONTROLLED BY PRESSURE CONTROLLER	
EF-IO	GREENHECK, COOK	VARIABLE SPEED CENTRIFUGAL	0-240	0.1"	115 / 60 / 1	0.02		ROOF-MOUNTED WITH ROOF CURB, ADAPTOR CURB , DISCONNECT & ECM MOTOR	SPEED CONTROLLED BY PRESSURE CONTROLLER	
EF-II	GREENHECK, COOK	VARIABLE SPEED CENTRIFUGAL	0-480	O.I"	115 / 60 / 1	0.04		ROOF-MOUNTED WITH ROOF CURB, ADAPTOR CURB , DISCONNECT & ECM MOTOR	SPEED CONTROLLED BY PRESSURE CONTROLLER	
EF-I2	GREENHECK, COOK	VARIABLE SPEED CENTRIFUGAL	0-480	O.I"	115 / 60 / 1	0.02		ROOF-MOUNTED WITH ROOF CURB, ADAPTOR CURB , DISCONNECT & ECM MOTOR	SPEED CONTROLLED BY PRESSURE CONTROLLER	
EF-I3	GREENHECK, COOK	VARIABLE SPEED CENTRIFUGAL	0-480	O.I"	115 / 60 / 1	0.04		ROOF-MOUNTED WITH ROOF CURB, ADAPTOR CURB , DISCONNECT & ECM MOTOR	SPEED CONTROLLED BY PRESSURE CONTROLLER	
EF-14	GREENHECK, COOK	VARIABLE SPEED CENTRIFUGAL	0-480	O.I"	115 / 60 / 1	0.04		ROOF-MOUNTED WITH ROOF CURB, ADAPTOR CURB , DISCONNECT & ECM MOTOR	SPEED CONTROLLED BY PRESSURE CONTROLLER	
EF-I5	GREENHECK, COOK	VARIABLE SPEED CENTRIFUGAL	0-480	O.I"	115 / 60 / 1	0.04		ROOF-MOUNTED WITH ROOF CURB, ADAPTOR CURB , DISCONNECT & ECM MOTOR	SPEED CONTROLLED BY PRESSURE CONTROLLER	
EF-I6	GREENHECK, COOK	VARIABLE SPEED CENTRIFUGAL	0-480	O.I"	115 / 60 / 1	0.04		ROOF-MOUNTED WITH ROOF CURB, ADAPTOR CURB , DISCONNECT & ECM MOTOR	SPEED CONTROLLED BY PRESSURE CONTROLLER	
EF-17	GREENHECK, COOK	VARIABLE SPEED CENTRIFUGAL	0-480	0.1"	115 / 60 / 1	0.04		ROOF-MOUNTED WITH ROOF CURB, ADAPTOR CURB , DISCONNECT & ECM MOTOR	SPEED CONTROLLED BY PRESSURE CONTROLLER	
EF-18	GREENHECK, COOK	VARIABLE SPEED CENTRIFUGAL	0-240	O.I"	115 / 60 / 1	0.02		ROOF-MOUNTED WITH ROOF CURB, ADAPTOR CURB , DISCONNECT & ECM MOTOR	SPEED CONTROLLED BY PRESSURE CONTROLLER	
EF-19	GREENHECK, PANASONIC, NUTONE/BROAN	CEILING FAN	110	O.I"	115 / 60 / 1		3.0		POWERED BY ROOM LIGHT SWITCH	
CF-I	GREENHECK, COOK	CIRCULATOR	9,600	O.I"	115 / 60 / 1	0.5		WITH WALL HANGING BRACKET & OSHA GUARD	CONTROLLED BY CO MONITORING SYSTEM	
CF-2	GREENHECK, COOK	CIRCULATOR	9,600	O.I"	115 / 60 / 1	0.5		WITH WALL HANGING BRACKET & OSHA GUARD	CONTOLLED BY CO MONITORING SYSTEM	
GE-I	GREENHECK, COOK	PROPELLER	2,660	0.3"	115 / 60 / 1	0.25		WITH WALL COLLAR & OSHA GUARD	CONTINUOUS RUN - 24/7	
GE-2	GREENHECK, COOK	PROPELLER	16,200	0.3"	208/60/3	2.0		WITH WALL COLLAR, MAGNETIC STARTER & OSHA GUARD	CONTROLLED BY CO MONITORING SYSTEM	
GE-3	GREENHECK, COOK	PROPELLER	16,200	0.3"	208/60/3	2.0		WITH WALL COLLAR, MAGNETIC STARTER & OSHA GUARD	CONTROLLED BY CO MONITORING SYSTEM	

NOTE - ALL HVAC UNITS WILL BE MOUNTED ON ROOF CURBS, HOWEVER THE SUPPLY AND RETURN WILL BE HORIZONTAL. HVAC EQUIPMENT WILL NEED TO HAVE <u>FACTORY</u> ECONOMIZER AND RELIEF. SUPPLY ACOUSTICAL ROOF CURBS WITH HORIZONTAL RETURN THROUGH THE CURB IF THE MANUFACTURER DOES NOT HAVE A HORIZONTAL ECONOMIZER OPTION. BOTTOM LINE IS NO NON-FACTURY ECONOMIZER SYSTEMS.

	HEAT PUMP OUTDOOR UNIT SCHEDULE											
TAG	ACCEPTABLE MANUFACTURERS	NOMINAL TONS	COOLING BTUH *	HEATING BTUH **	POWER	ELECTRIC MOP	MCA	REFRIGERANT	SEER	HSPF	WEIGHT	REMARKS
OU-AI	SAMSUNG, MITSUBISHI, FJ, DAIKIN. TRANE	1.5	18,000	20,000	208/60/1	15	9.4	410A	20.1	10.0	99 LBS	MOUNT ON 18" HIGH BASE & FACTORY WIND BAFFLES
OU-A2	SAMSUNG, MITSUBISHI, FJ, DAIKIN. TRANE	1.5	18,000	20,000	208/60/1	15	9.4	410A	20.1	10.0	99 LBS	MOUNT ON 18" HIGH BASE & FACTORY WIND BAFFLES
OU-A3	SAMSUNG, MITSUBISHI, FJ, DAIKIN. TRANE	1.5	18,000	20,000	208/60/1	15	9.4	410A	20.1	10.0	99 LBS	MOUNT ON 18" HIGH BASE & FACTORY WIND BAFFLES
OU-A4	SAMSUNG, MITSUBISHI, FJ, DAIKIN. TRANE	1.5	18,000	20,000	208/60/1	15	9.4	410A	20.1	10.0	99 LBS	MOUNT ON 18" HIGH BASE & FACTORY WIND BAFFLES
OU-BI	SAMSUNG, MITSUBISHI, FJ, DAIKIN. TRANE	2.0	24,000	27,000	208/60/1	20	13.6	410A	20.1	10.0	142 LBS	MOUNT ON 18" HIGH BASE & FACTORY WIND BAFFLES
<i>0</i> U-B2	SAMSUNG, MITSUBISHI, FJ, DAIKIN. TRANE	2.0	24,000	27,000	208/60/1	20	13.6	410A	20.1	10.0	142 LBS	MOUNT ON 18" HIGH BASE & FACTORY WIND BAFFLES
0U-B3	SAMSUNG, MITSUBISHI, FJ, DAIKIN. TRANE	2.0	24,000	27,000	208/60/1	20	13.6	410A	20.1	10.0	142 LBS	MOUNT ON 18" HIGH BASE & FACTORY WIND BAFFLES
<i>0</i> U-B4	SAMSUNG, MITSUBISHI, FJ, DAIKIN. TRANE	2.5	30,000	32,000	208/60/1	35	21.7	410A	20.1	10.0	142 LBS	MOUNT ON 18" HIGH BASE & FACTORY WIND BAFFLES
0U-B5	SAMSUNG, MITSUBISHI, FJ, DAIKIN. TRANE	2.0	24,000	27,000	208/60/1	20	13.6	410A	20.1	10.0	142 LBS	MOUNT ON 18" HIGH BASE & FACTORY WIND BAFFLES
OU-CI	SAMSUNG, MITSUBISHI, FJ, DAIKIN. TRANE	2.5	30,000	32,000	208/60/1	35	21.7	410A	20.1	10.0	142 LBS	MOUNT ON 18" HIGH BASE & FACTORY WIND BAFFLES
OU-I	SAMSUNG, MITSUBISHI, FJ, DAIKIN. TRANE	1.5	18,000	20,000	208/60/1			410A				MOUNT ON 18" HIGH BASE & FACTORY WIND BAFFLES
<i>0</i> U-2	SAMSUNG, MITSUBISHI, FJ, DAIKIN. TRANE	2.0	24,000	27,000	208/60/1		6	410A				MOUNT ON 18" HIGH BASE & FACTORY WIND BAFFLES


* COOLING OPERATING RANGE OF 23 DEG. F. TO 115 DEG. F. ** HEATING OPERATING RANGE OF 10 DEG. F. TO 60 DEG. F.

	HEAT PUMP INDOOR UNIT SCHEDULE										
TAG	ACCEPTABLE MANUFACTURERS	NOMINAL	CFM		ELECT	RIC		REFRIGERANT	REMARKS		
TAG	ACCEPTABLE MANUFACTURERS	TONS	СГМ	POWER	AUXILIARY HEAT	MCA	FLA	МОР	REPRIGERANT	REMARKS	
AH-AI	SAMSUNG, MITSUBISHI, FJ, DAIKIN. TRANE	1.5	530	208/60/1	3.0 KW	13.63	12.5	15	410A	WITH FACTORY FILTER RACK & MOISTURE SENSOR	
AH-A2	SAMSUNG, MITSUBISHI, FJ, DAIKIN. TRANE	1.5	530	208/60/1	3.0 KM	13.63	12.5	15	410A	WITH FACTORY FILTER RACK & MOISTURE SENSOR	
AH-A3	SAMSUNG, MITSUBISHI, FJ, DAIKIN. TRANE	1.5	53 <i>0</i>	208/60/1	3.0 KM	13.63	12.5	15	410A	WITH FACTORY FILTER RACK & MOISTURE SENSOR	
AH-A4	SAMSUNG, MITSUBISHI, FJ, DAIKIN. TRANE	1.5	53 <i>0</i>	208/60/1	3.0 KM	13.63	12.5	15	410A	WITH FACTORY FILTER RACK & MOISTURE SENSOR	
AH-BI	SAMSUNG, MITSUBISHI, FJ, DAIKIN. TRANE	2.0	630	208/60/1	5.0 KM	23.26	18.03	30	410A	WITH FACTORY FILTER RACK & MOISTURE SENSOR	
AH-B2	SAMSUNG, MITSUBISHI, FJ, DAIKIN. TRANE	2.0	630	208/60/1	5.0 KM	23.26	18.03	30	410A	WITH FACTORY FILTER RACK & MOISTURE SENSOR	
AH-B3	SAMSUNG, MITSUBISHI, FJ, DAIKIN. TRANE	2.0	630	208/60/1	5.0 KM	23.26	18.03	30	410A	WITH FACTORY FILTER RACK & MOISTURE SENSOR	
AH-B4	SAMSUNG, MITSUBISHI, FJ, DAIKIN. TRANE	2.5	900	208/60/1	5.0 KM	23.26	18.03	30	410A	WITH FACTORY FILTER RACK & MOISTURE SENSOR	
AH-B5	SAMSUNG, MITSUBISHI, FJ, DAIKIN. TRANE	2.0	630	208/60/1	5.0 KM	24.20	18.03	30	410A	WITH FACTORY FILTER RACK & MOISTURE SENSOR	
AH-CI	SAMSUNG, MITSUBISHI, FJ, DAIKIN. TRANE	2.5	900	208/60/1	5.0 KM	23.26	18.03	30	410A	WITH FACTORY FILTER RACK & MOISTURE SENSOR	
AH-I	SAMSUNG, MITSUBISHI, FJ, DAIKIN. TRANE	1.5		208/60/1	NA				410A	WALL HUNG WITH CONDENSATE PUMP	
AH-2	SAMSUNG, MITSUBISHI, FJ, DAIKIN. TRANE	2.0		208/60/1	NA				410A	WALL HUNG WITH CONDENSATE PUMP	

^{*} COOLING CAPACITIES BASED ON 80/67 DEG. F. ENTERING AIR & 95 DEG. F. AT THE CONDENSER (OUTDOOR UNIT)

REGISTER & GRILLE SCHEDULE											
TYPE	ACCEPTABLE MANUFACTURERS	REMARKS									
3-WAY THROW CEILING DIFFUSERS	PRICE, METALAIRE, TITUS	WHITE FINISH, COMMERCIAL GRADE - WITH OPPOSED BLADE DAMPERS									
4-WAY THROW CEILING DIFFUSERS	PRICE, METALAIRE, TITUS	WHITE FINISH, COMMERCIAL GRADE - WITH OPPOSED BLADE DAMPERS									
RETURN GRILLES	PRICE, METALAIRE, TITUS	WHITE FINISH, COMMERCIAL GRADE - 45 DEG. VANES ¾" SPACEING.									

	ELECTRIC HEATER SCHEDULE											
TAG	ACCEPTABLE MANUFACTURERS	TYPE	KW	VOLTAGE	REMARKS							
EH-I		ELECTRIC WALL HEATER	3.0	208/60/	COMMERCIAL GRADE WITH BUILT-IN THERMOSTAT							
EH-2		ELECTRIC WALL HEATER	2.0	208/60/	COMMERCIAL GRADE WITH BUILT-IN THERMOSTAT							
EH-3	Q-MARK SSHO4OO8	ELECTRIC WALL HEATER	3.0	208/60/	COMMERCIAL GRADE WITH BUILT-IN THERMOSTAT							
EH-4	Q WINNE SSITE TO CO	ELECTRIC WALL HEATER	3.0	208/60/	COMMERCIAL GRADE WITH BUILT-IN THERMOSTAT							
EH-5		ELECTRIC WALL HEATER	2.0	208/60/	COMMERCIAL GRADE WITH BUILT-IN THERMOSTAT							
EH-6		ELECTRIC WALL HEATER	4.0	208/60/	COMMERCIAL GRADE WITH BUILT-IN THERMOSTAT							

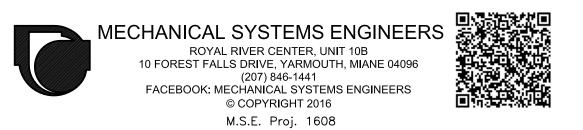



Magnusson 10257

project architect: KAK drawn by: KFM

MECHANICAL SCHEDULES

^{**} HEATING CAPACITIES BASED ON 70 DEG. F. ENTERING AIR & 47/43 DEG. F. AT THE CONDENSER (OUTDOOR UNIT)