EXTENT OF UNPROTECTED OPENINGS IN EXTERIOR WALLS CLOSE TO A LOT LINE:

NORTH-EAST WALL IS BETWEEN 5' & 10' OF LOT LINE

ALLOWABLE PERCENTAGE OF UNPROTECTED OPENINGS = 25% (PER 2009 IBC TABLE 705.8)

NORTH-WEST WALL IS BETWEEN 10' & 15' OF LOT LINE ALLOWABLE PERCENTAGE OF UNPROTECTED OPENINGS = 45% (PER 2009 IBC TABLE 705.8)


AREA OF NORTH-EAST ELEVATION = 263 SF

AREA OF UNPROTECTED WIN./DOOR = +/- 55 SF AREA OF UNPROTECTED VENTS $= \pm / - 5 \text{ SF}$ AREA OF UNPROTECTED OPENINGS $= \pm / - 60 \text{ SF}$ UNPROTECTED PERCENTAGE OF WALL = +/- 22.8%

LIFE SAFEY SYMBOL KEY: REFER TO A5.1 FOR FIRE RATED ASSEMBLIES


ONE (1) HOUR PARTITION / BARRIER (1-WAY ONLY)

ONE (1) HOUR PARTITION / BARRIER (2-WAY)

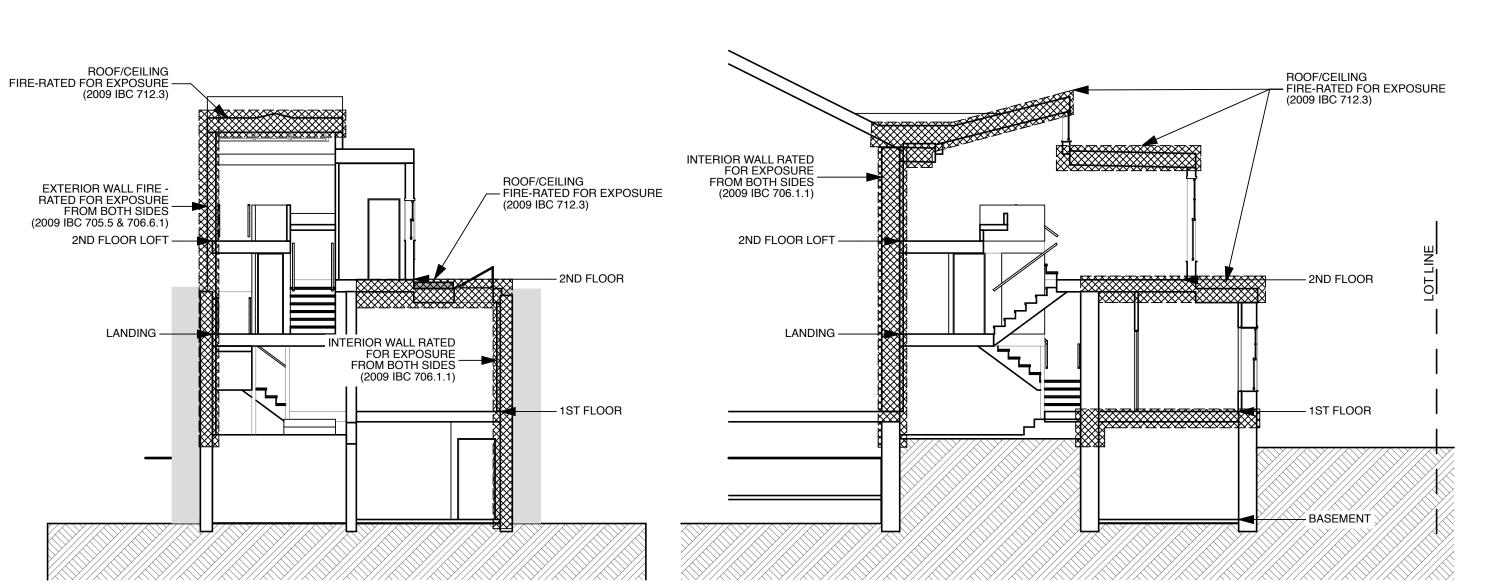

SECTION SCALE: 1/8" = 1'-0'

SECTION

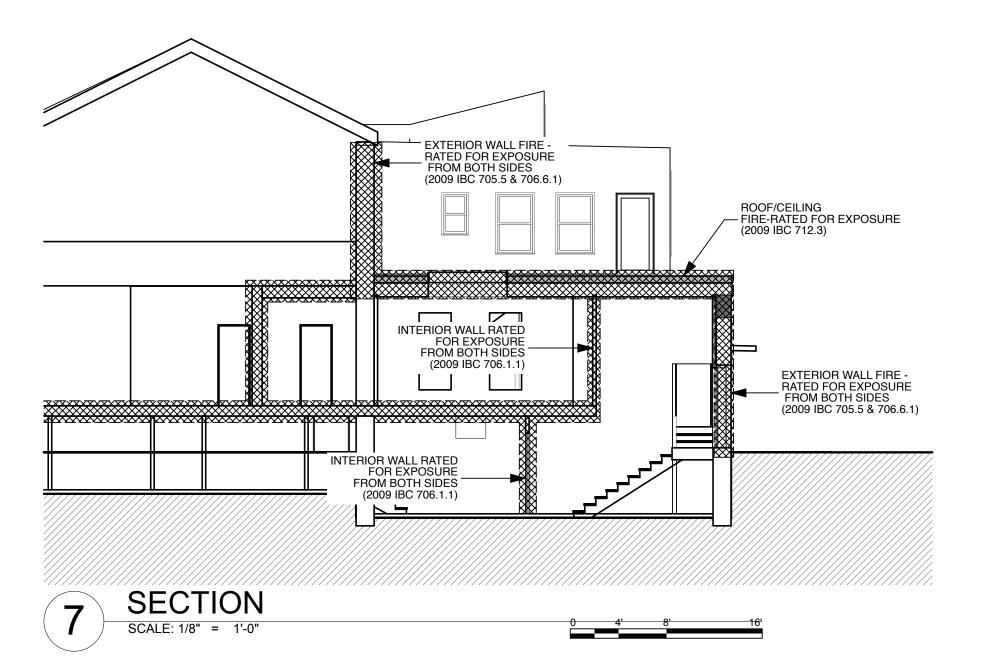

LIFE SAFETY NOTES:

BUILDING OCCUPANCY: R2 (1 unit residential, non-townhouse)

BUILDING CODES: IBC-2009, NFPA-101: 2009

FLOOR AREA: 1st. floor = 780 SF

423 SF 2nd. floor = 112 SF 3rd. floor =

Total area = $\frac{112 \text{ G}}{1,315 \text{ SF}}$ (gross enclosed floor area)

CONSTRUCTION TYPE: Type 5B


SPRINKLERS: Residential 13-R throughout the proposed work


One (1) basement floor below grade plane. Two (2) floors above grade plane Highest floor is less than 14' above lowest level of fire department vehicle **BUILDING HEIGHT:**


access.


Building with two exits NUMBER OF EXITS:

To be located on each floor as per IBC 2009 / NFPA 101 SMOKE ALARMS:

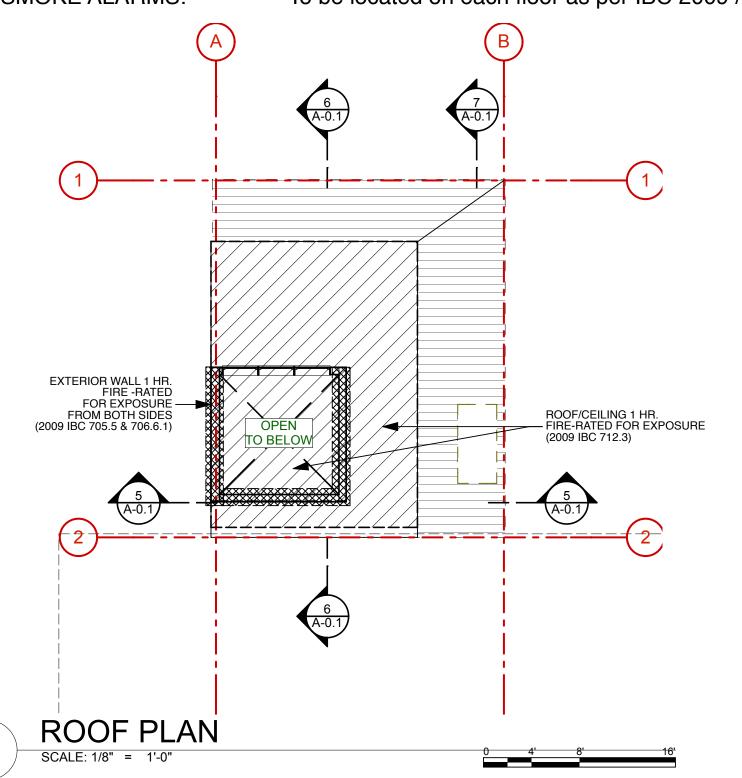

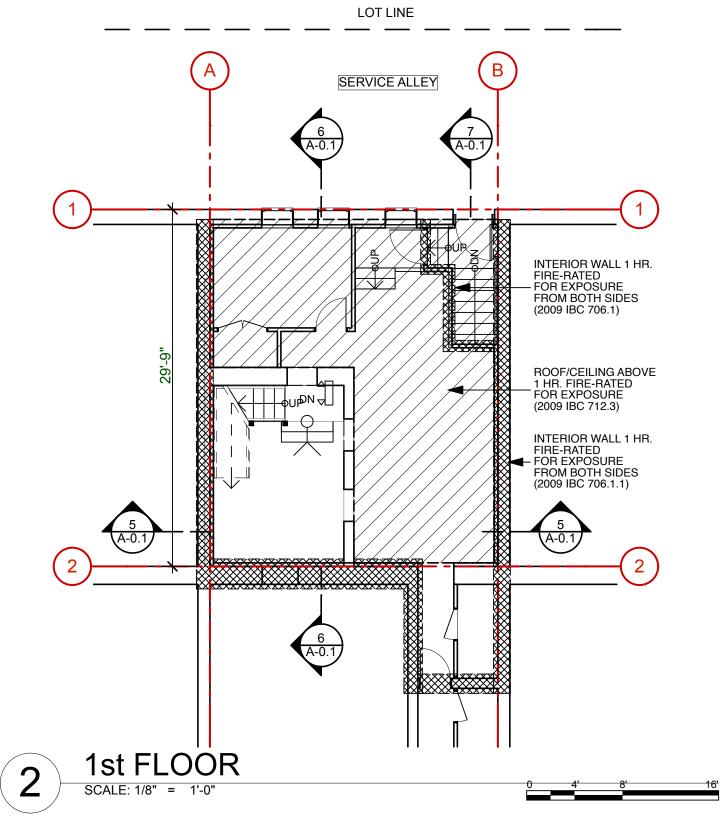

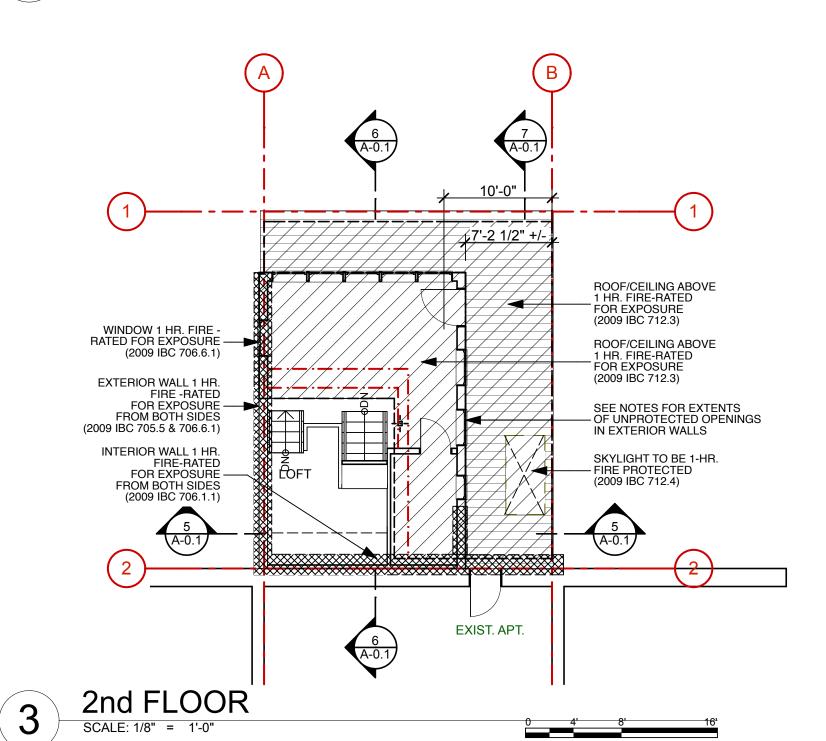

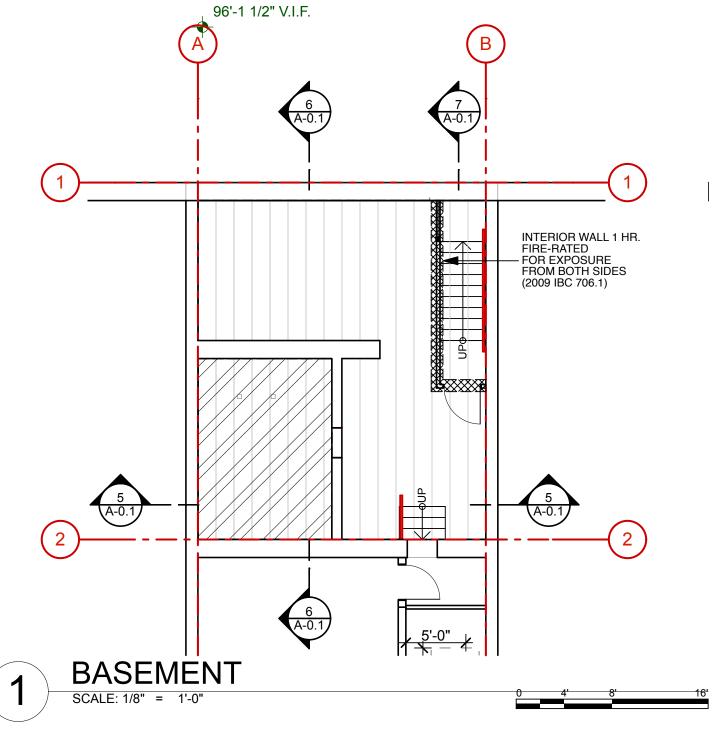



FOR PERMIT

PROJECT: I33 SPRING ST JOHN STADLER I33 Spring St Portland, ME

DRAWING: LIFE SAFETY Scale: DRAWN BY: JJT REVISED: Date: June 6, 2013

06/06/2013