

DISPLAY THIS CARD ON PRINCIPAL FRONTAGE OF WORK
CITY OF PORTLAND

Please Read
 Application And
 Notes, If Any,
 Attached

BU **PERMIT** ION

Permit Number: 100030

This is to certify that COTTON STREET DEVELOPMENT LLC is Restaurant
 has permission to install a kitchen hood system w/ superior venting for "Mama's Old School Pizza" connected w/ permit #091429
 AT 505 FORE ST CB# 038 C016001 FEB 11 2010

PERMIT ISSUED

provided that the person or persons, firm or corporation accepting this permit shall comply with all of the provisions of the Statutes of Maine and of the Ordinances of the City of Portland regulating the construction, maintenance and use of buildings and structures, and of the application on file in this department.

Apply to Public Works for street line and grade if nature of work requires such information.

Notification of inspection must be given and written permission procured before this building or part thereof is lath or other work is set-in. 24 HOURS NOTICE IS REQUIRED.

A certificate of occupancy must be procured by owner before this building or part thereof is occupied.

OTHER REQUIRED APPROVALS

Fire Dept. CAPT. R. Lawrence
 Health Dept. _____
 Appeal Board _____
 Other _____
 Department Name

James Paul 2/11/10
 Director - Building & Inspection Services

PENALTY FOR REMOVING THIS CARD

City of Portland, Maine - Building or Use Permit Application
 389 Congress Street, 04101 Tel: (207) 874-8703, Fax: (207) 874-8716

Permit No: 10-0030	Issue Date:	CBL: 038 C016001
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Location of Construction: 505 FORE ST	Owner Name: COTTON STREET DEVELOPME	Owner Address: PO BOX 6799	Phone:
Business Name:	Contractor Name: Atlantic Restaurant Services	Contractor Address: 34 Albion Road Windham	Phone: 2076530645
Lessee/Buyer's Name	Phone:	Permit Type: Hood Systems, Commerical	Zone: B-3

Past Use: Commercial - Restaurant	Proposed Use: Commercial - Restaurant - install a kitchen hood system w/ exterior venting for "Siano's Old Port Pizza" connected w/ permit #091429	Permit Fee: \$150.00	Cost of Work: \$13,000.00	CEO District: 1
Proposed Project Description: install a kitchen hood system w/ exterior venting for "Siano's Old Port Pizza" connected w/ permit #091429		FIRE DEPT: <input checked="" type="checkbox"/> Approved <input type="checkbox"/> Denied <i>* See Conditions</i>	INSPECTION: Use Group: <i>A-2</i> Type: <i>hood</i> <i>IMC-2003</i>	
		Signature: <i>RG</i>	Signature: <i>JMB 2/11/10</i>	
PEDESTRIAN ACTIVITIES DISTRICT (P.A.D.)				
Action: <input type="checkbox"/> Approved <input type="checkbox"/> Approved w/Conditions <input type="checkbox"/> Denied				
Signature: _____ Date: _____				

Permit Taken By: Ldobson	Date Applied For: 01/12/2010	Zoning Approval
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1. This permit application does not preclude the Applicant(s) from meeting applicable State and Federal Rules. 2. Building permits do not include plumbing, septic or electrical work. 3. Building permits are void if work is not started within six (6) months of the date of issuance. False information may invalidate a building permit and stop all work..	Special Zone or Reviews <input type="checkbox"/> Shoreland <input type="checkbox"/> Wetland <input type="checkbox"/> Flood Zone <input type="checkbox"/> Subdivision <input type="checkbox"/> Site Plan Maj <input type="checkbox"/> Minor <input type="checkbox"/> MM <input type="checkbox"/>	Zoning Appeal <input type="checkbox"/> Variance <input type="checkbox"/> Miscellaneous <input type="checkbox"/> Conditional Use <input type="checkbox"/> Interpretation <input type="checkbox"/> Approved <input type="checkbox"/> Denied	Historic Preservation <input type="checkbox"/> Not in District or Landmark <input type="checkbox"/> Does Not Require Review <input type="checkbox"/> Requires Review <input type="checkbox"/> Approved <input checked="" type="checkbox"/> Approved w/Conditions <input type="checkbox"/> Denied
	Date: <i>1/12/10</i>	Date: _____	Date: <i>1/15/2010</i>

PERMIT ISSUED

FEB 11 2010

City of Portland

CERTIFICATION

I hereby certify that I am the owner of record of the named property, or that the proposed work is authorized by the owner of record and that I have been authorized by the owner to make this application as his authorized agent and I agree to conform to all applicable laws of this jurisdiction. In addition, if a permit for work described in the application is issued, I certify that the code official's authorized representative shall have the authority to enter all areas covered by such permit at any reasonable hour to enforce the provision of the code(s) applicable to such permit.

SIGNATURE OF APPLICANT ADDRESS DATE PHONE

RESPONSIBLE PERSON IN CHARGE OF WORK, TITLE DATE PHONE

BUILDING PERMIT INSPECTION PROCEDURES

Please call 874-8703 or 874-8693 (ONLY)

to schedule your inspections as agreed upon

Permits expire in 6 months, if the project is not started or ceases for 6 months.

The Owner or their designee is required to notify the inspections office for the following inspections and provide adequate notice. Notice must be called in 48-72 hours in advance in order to schedule an inspection:

By initializing at each inspection time, you are agreeing that you understand the inspection procedure and additional fees from a "Stop Work Order" and "Stop Work Order Release" will be incurred if the procedure is not followed as stated below.

A Pre-construction Meeting will take place upon receipt of your building permit.

Framing/Rough Plumbing/Electrical: Prior to Any Insulating or drywalling

Final inspection required at completion of work.

Certificate of Occupancy is not required for certain projects. Your inspector can advise you if your project requires a Certificate of Occupancy. All projects DO require a final inspection.

If any of the inspections do not occur, the project cannot go on to the next phase, REGARDLESS OF THE NOTICE OR CIRCUMSTANCES.

CERIFICATE OF OCCUPANICES MUST BE ISSUED AND PAID FOR, BEFORE THE SPACE MAY BE OCCUPIED.



Signature of Applicant/Designee



Date



Signature of Inspections Official



Date

City of Portland, Maine - Building or Use Permit

389 Congress Street, 04101 Tel: (207) 874-8703, Fax: (207) 874-8716

Permit No: 10-0030	Date Applied For: 01/12/2010	CBL: 038 C016001
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Location of Construction: 505 FORE ST	Owner Name: COTTON STREET DEVELOPME	Owner Address: PO BOX 6799	Phone:
Business Name:	Contractor Name: Atlantic Restaurant Services	Contractor Address: 34 Albion Road Windham	Phone: (207) 653-0645
Lessee/Buyer's Name	Phone:	Permit Type: Hood Systems, Commerical	

Proposed Use: Commercial - Restaurant - install a kitchen hood system w/ exterior venting for "Siano's Old Port Pizza" connected w/ permit #091429	Proposed Project Description: install a kitchen hood system w/ exterior venting for "Siano's Old Port Pizza" connected w/ permit #091429
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Dept: Historic **Status:** Approved with Conditions **Reviewer:** Deborah Andrews **Approval Date:** 01/15/2010

Note: **Ok to Issue:**

- 1) * Approval based on revised drawing submitted by Atlantic Restaurant Services on 1/15/2010. Revised drawing reflects 8/07 approval by Historic Preservation Board for installation of ductwork. (Project was approved but never constructed.)

Dept: Zoning **Status:** Approved with Conditions **Reviewer:** Marge Schmuckal **Approval Date:** 01/12/2010

Note: **Ok to Issue:**

- 1) ANY exterior work requires a separate review and approval thru Historic Preservation. This property is located within an Historic District.
- 2) This permit is being approved on the basis of plans submitted. Any deviations shall require a separate approval before starting that work.
- 3) The current use of the building is restaurant use on the first floor with offices above. Any change of use shall require a separate permit and approval.

Dept: Building **Status:** Approved with Conditions **Reviewer:** Jeanine Bourke **Approval Date:** 02/11/2010

Note: **Ok to Issue:**

- 1) SEPARATE APPLICATION AND APPROVAL IS REQUIRED FOR THE WOOD FIRED CLAY OVEN AND FUME EXHAUST
- 2) The hood, duct and exhaust shall be installed per IMC 2003 and NFPA 96
This permit is approved based on the plans submitted and updated for reductions in the cleaances based on the application of a UL approved fire wrap or equivalent assembly per code.
- 3) Separate permits are required for any electrical, plumbing, sprinkler, fire alarm or HVAC or exhaust systems. Separate plans may need to be submitted for approval as a part of this process.
- 4) Application approval based upon information provided by applicant. Any deviation from approved plans requires separate review and approrval prior to work.

Dept: Fire **Status:** Approved with Conditions **Reviewer:** Capt Keith Gautreau **Approval Date:** 01/20/2010

Note: **Ok to Issue:**

- 1) Install shall comply with all manufacture's specifications.
- 2) Fire extinguishers required. Installation per NFPA 10
- 3) Install shall comply with NFPA 96.
A compliance letter is required

PERMIT ISSUED

FEB 11 2010

City of Portland

Location of Construction: 505 FORE ST	Owner Name: COTTON STREET DEVELOPME	Owner Address: PO BOX 6799	Phone:
Business Name:	Contractor Name: Atlantic Restaurant Services	Contractor Address: 34 Albion Road Windham	Phone (207) 653-0645
Lessee/Buyer's Name	Phone:	Permit Type: Hood Systems, Commerical	

Comments:

2/1/2010-jmb: Spoke with Mark W. About details, the hood location has changed but the plan elevation submitted 1/15/10 and approved by historic is where the duct will be located. This is at the recess between the old and new buildings. Need detail on noncombustible wall for hood mount, distance to ceiling and verify the property line.

2/11/2010-jmb: Received revision from Mark for new hood placement and verifcaiton that the property line is well over 10' from the exhaust location.

1/15/2010-gg: received from historic as of 01/15/2010. /gg

PERMIT ISSUED

FEB 11 2010

City of Portland



General Building Permit Application


If you or the property owner owes real estate or personal property taxes or user charges on any property within the City, payment arrangements must be made before permits of any kind are accepted.

Location/Address of Construction: <u>505 FORE ST.</u>		
Total Square Footage of Proposed Structure/Area <u>SEE CODE DETECH SHEET A/B</u>		Square Footage of Lot
Tax Assessor's Chart, Block & Lot Chart# <u>38</u> Block# <u>C</u> Lot# <u>16</u>		Applicant * <u>must be owner, Lessee or Buyer</u> * Name Address City, State & Zip
Lessee/DBA (If Applicable) <u>SIANO'S OLD PORT PIZZERIA</u>		Owner (if different from Applicant) Name Address City, State & Zip
Current legal use (i.e. single family) If vacant, what was the previous use? <u>UNA.</u>		Cost Of Work: \$ <u>13,000</u> C of O Fee: \$ _____ Total Fee: \$ <u>150</u>
Proposed Specific use: _____ Is property part of a subdivision? _____ If yes, please name _____ Project description: <u>Siano's Old Port Pizza kitchen hood</u>		
Contractor's name: <u>ATLANTIC REST. SVC.</u>		
Address: <u>34 ARBION RD</u>		
City, State & Zip <u>WINDHAM ME 04062</u>		Telephone: _____
Who should we contact when the permit is ready: <u>MARK</u>		Telephone: <u>653-0645</u>
Mailing address: <u>SAME</u>		

Please submit all of the information outlined on the applicable Checklist. Failure to do so will result in the automatic denial of your permit.

In order to be sure the City fully understands the full scope of the project, the Planning and Development Department may request additional information prior to the issuance of a permit. For further information or to download copies of this form and other applications visit the Inspections Division on-line at www.portlandmaine.gov, or stop by the Inspections Division office, room 315 City Hall or call 874-8703.

I hereby certify that I am the Owner of record of the named property, or that the owner of record authorizes the proposed work and that I have been authorized by the owner to make this application as his/her authorized representative. I agree to conform to all applicable laws of this jurisdiction. In addition, if a permit for work described in this application is issued by the City of Portland, Maine, the Code Official's authorized representative shall have the authority to enter all areas covered by this permit at any reasonable hour to enforce the provisions of the codes applicable to this permit.

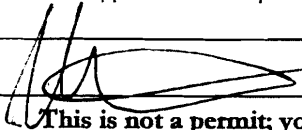Signature: 


Date: 1/11/10


This is not a permit; you may not commence ANY work until the permit is issued

RECEIVED

JAN 12 2010


Dept. of Building Inspections
City of Portland, Maine

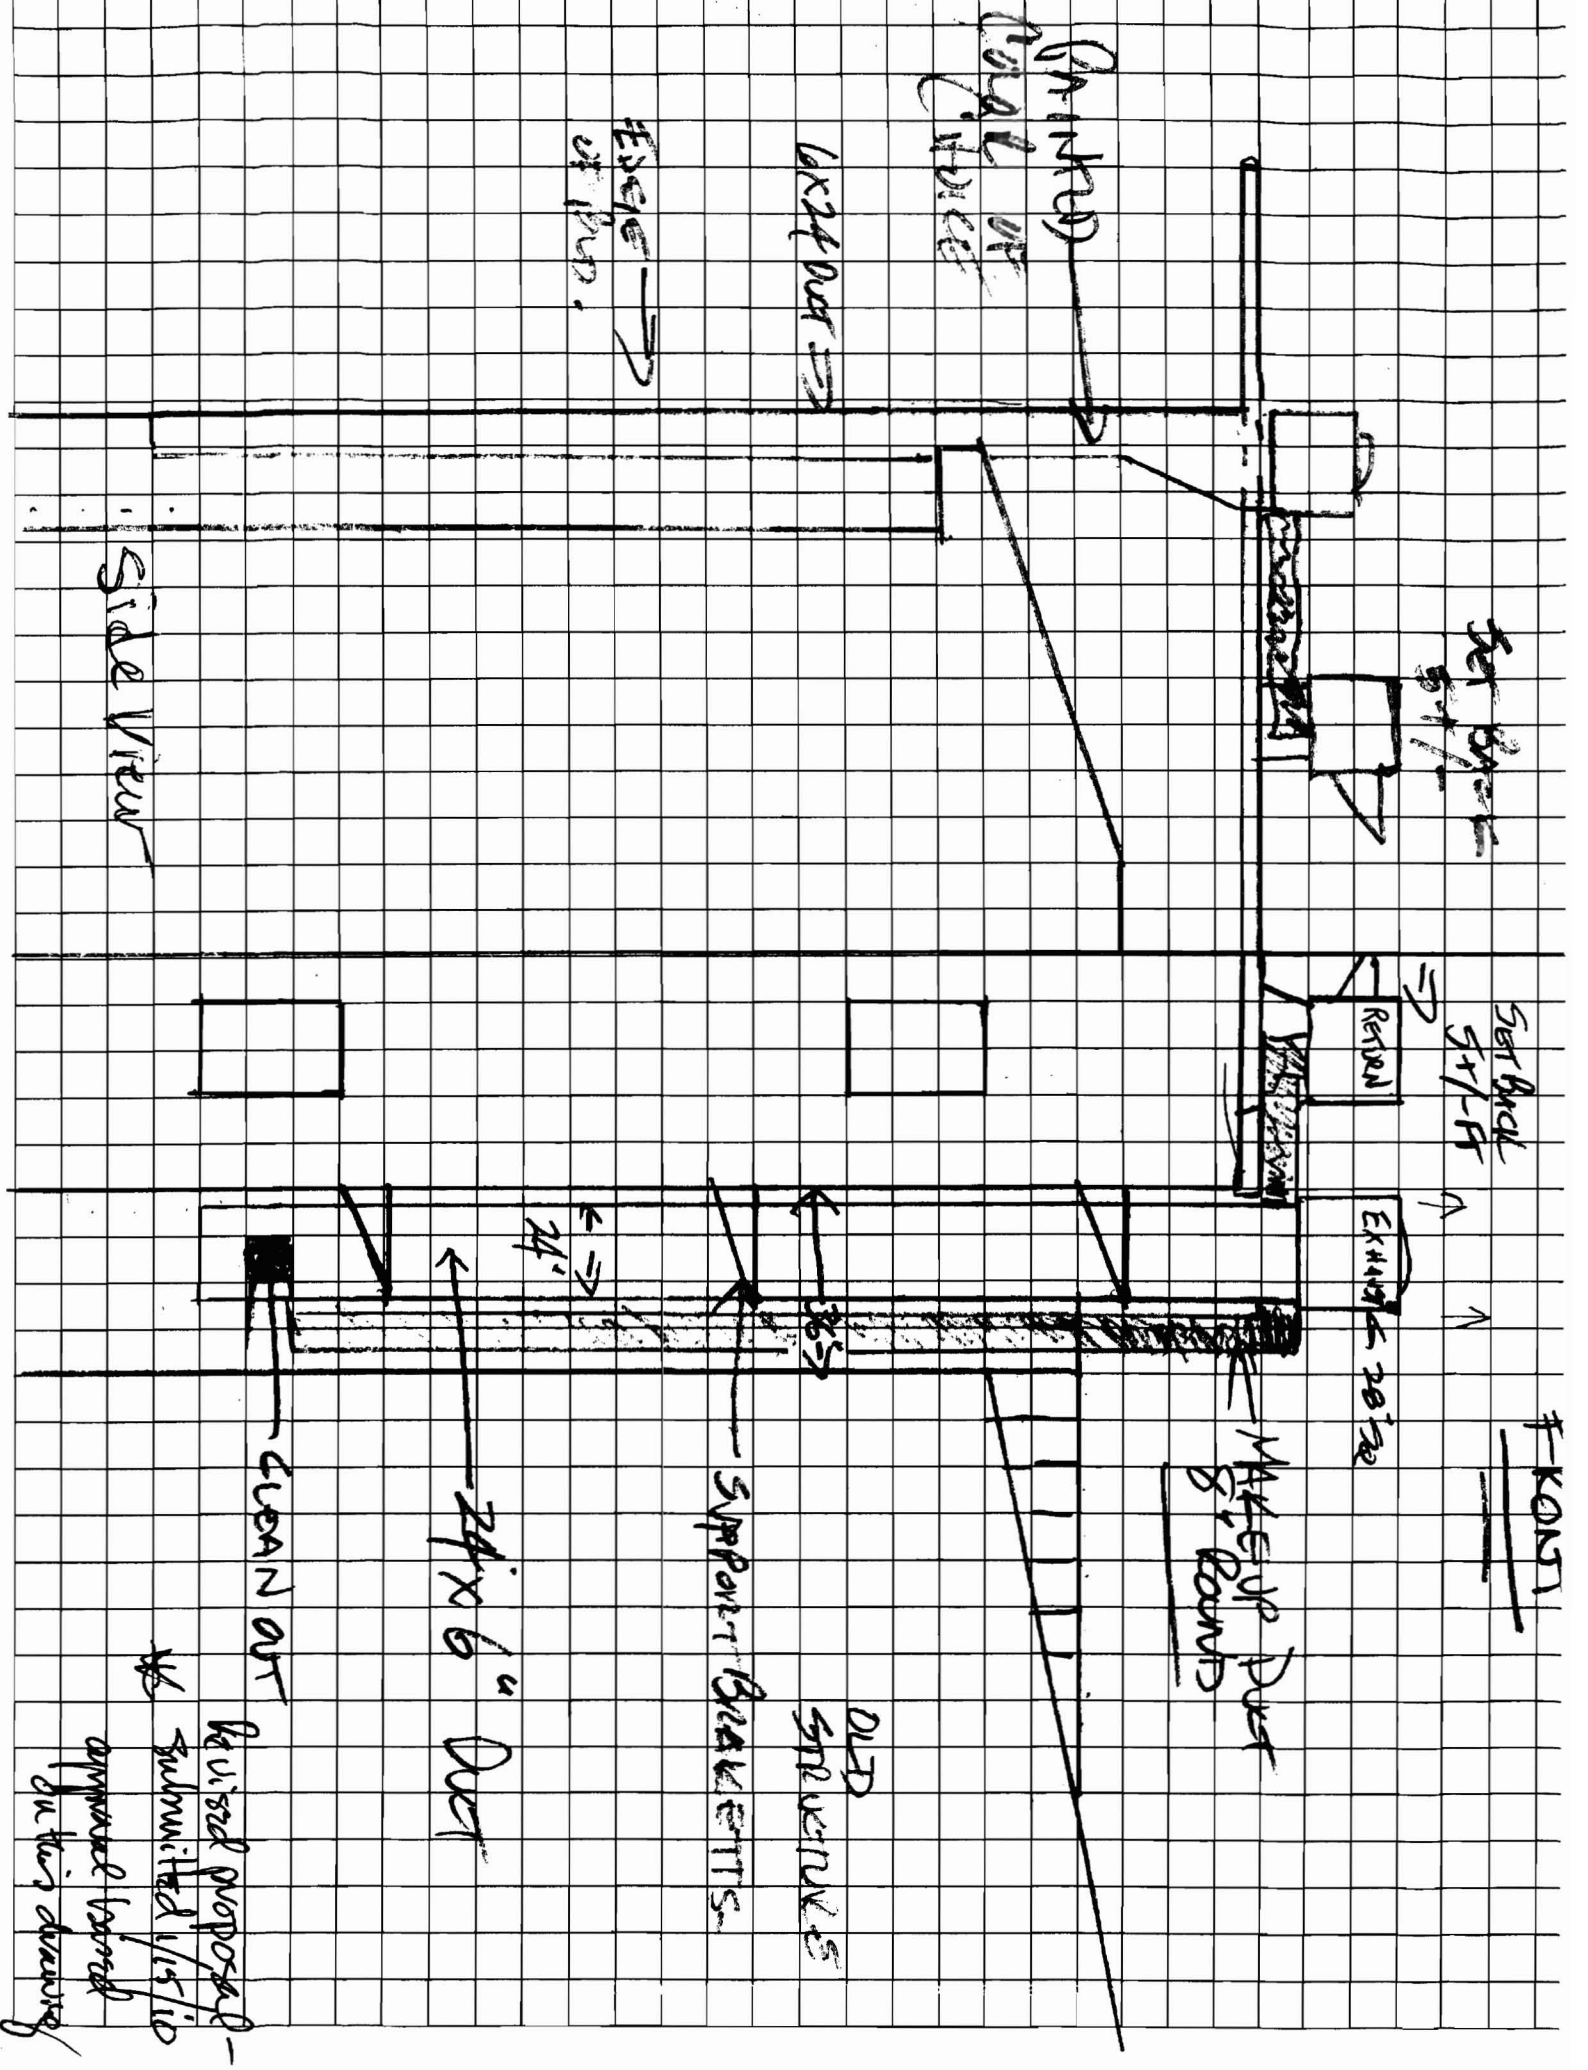

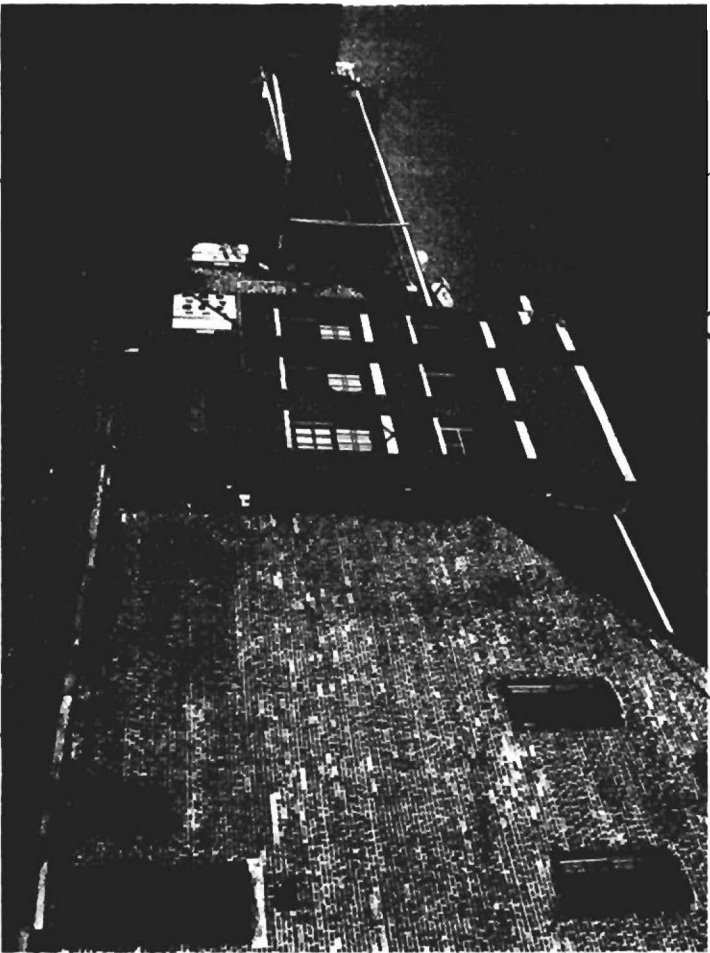

11/21/2009

Proposed

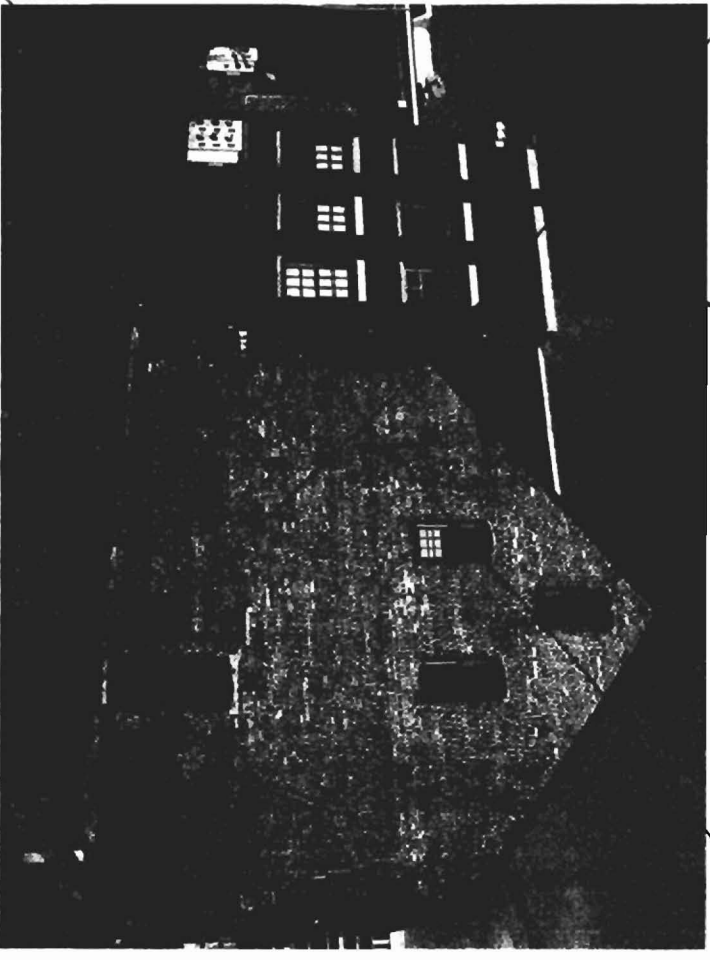

11/21/2009

Proposed


See plan
1/15/10

SIANO'S
OLDFATHER
505 FARRIS ST.

Atlantic Restaurant Service
34 Albion Road
Windham, ME 04062

207-653-0645

Project: SIANO'S OP.
505. TARE

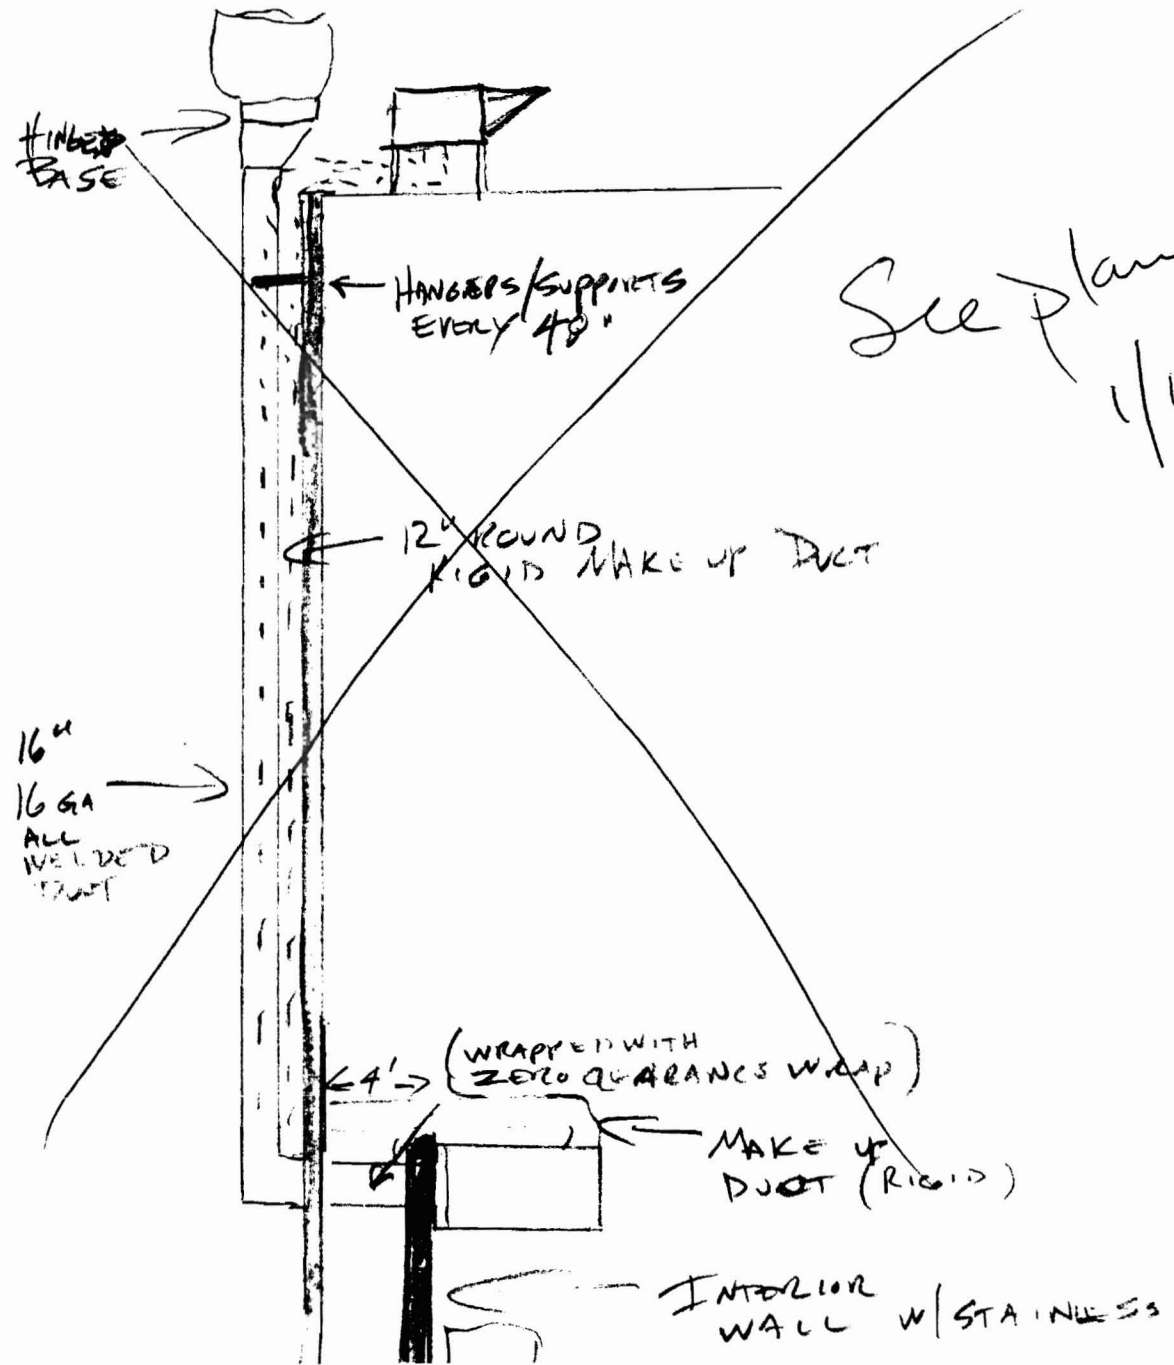



Strengthening a Remarkable City, Building a Community for Life • www.portlandmaine.gov

Lee Urban - Director of Planning and Development
Jeanie Bourke - Inspection Division Services Director

Kitchen Exhaust System Checklist and code Provisions

Dear Applicant,

The following is a checklist to assist you in filing for a permit for a Kitchen Exhaust system. The applicable Mechanical Code provisions have also been attached. Please complete this and submit job specific construction documents that demonstrate compliance with the attached information.

Type of System:

Type I X Type II _____

Type I systems are systems that vent fryers, grills, broilers, ovens or woks.

Type II systems are systems that vent steamers and other non grease producing appliances.

Type of Materials:

Is the hood Stainless steel or other type of steel? STAINLESS If Other, what Type? _____

Is the duct work Stainless steel or other type of steel? TINNED If Other, what type? PAINTED COLD ROLLED 16 GA

Thickness of the steel for the hood 18 GA

Thickness of the duct for the hood 16 GA

Type of Hood and Duct Supports

THREADED ROD INTERIOR

STEEL WALL SUPPORTS - WELDED - EXTERIOR

Type of seams and Joints FLANGED - EDGE - WELD -

Grease Gutters provided? YES

Hood Clearance reduction to Combustibles design /specs:

N/A

Duct Clearance reduction to Combustibles design /specs:

FLAME GUARD DUCT WRAP

Vibration Isolation System:

RILWIN

Air Velocity within the duct system 3800 CFM

Grease accumulation prevention system:

GREASE DRAIN w/ REMOVABLE CUP

Cleanouts AT ELBOW

Grease Duct enclosure N/A

Exhaust Termination Roof X Wall ~~XXXX~~

Fire Suppression System BY FIRE SAFE

Exhaust fan mounting and clearance from the roof / wall or Combustibles:

AT LEAST 10'

Exhaust fan distance from property lines MIN 10'

Exhaust fan distance from other vents or openings MIN 10'

Exhaust fan distance from adjacent buildings ..

Exhaust fan height above adjoining grade MIN 3'

Hood Specs

Style of Hood NON-TYPICAL STANDARD BOX

Type of Filter BAFFLE - ALUM




Height of filter above nearest cooking surface LESS THAN 4'

Capacity of hood CFM ~~5000~~ 4200

Make up Air system description and capacity

FILTERED SUPPLY - BELT DRIVE 2940 CFM

- FAN #2 NSAU2-G12 - SUPPLY FAN
 1. SUPPLY UNIT WITH 12" BLOWER IN SIZE #2 HOUSING
 2. INTAKE HOOD WITH EZ FILTERS
 3. SIDE DISCHARGE - AIR FLOW RIGHT → LEFT
 4. GRAVITY BACK DRAFT DAMPER 22" X 24", STANDARD GALVANIZED CONSTRUCTION, 1 1/4" REAR FLANGE, FOR SIZE 2 UNTEMPERED FAN HOUSING (5182) BLOWER DISCHARGE

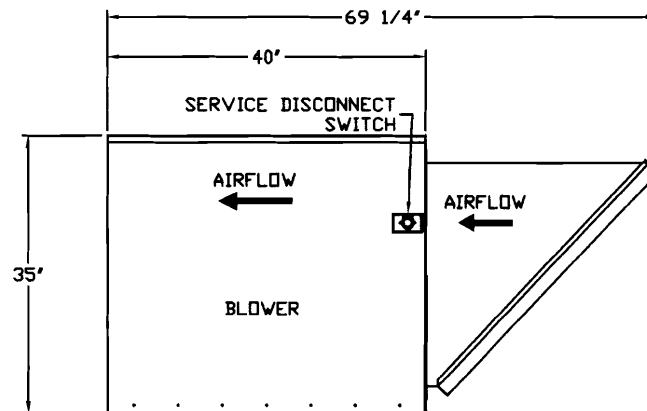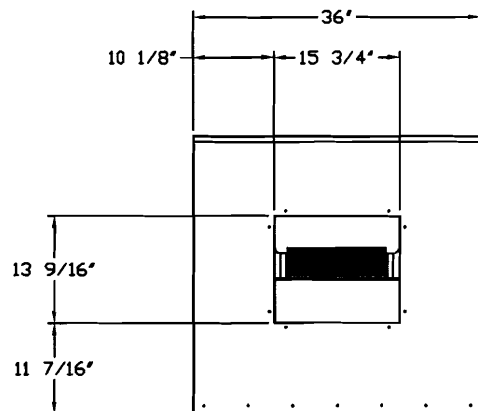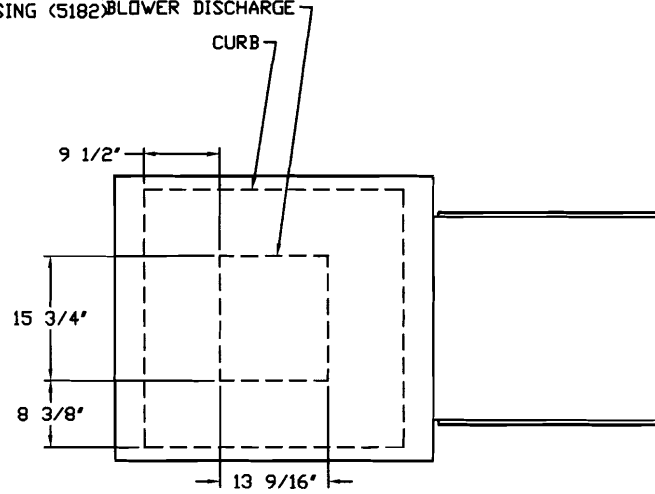

CUSTOMER APPROVAL TO MANUFACTURE:

Approved as Noted

Approved with NO Exception Taken

Revise and Resubmit

SIGNATURE _____

Your Title _____ Date _____

CAPTIVE AIR

JOB Portland #1067054

LOCATION

DATE 1/4/2010


JOB # 1067054

DWG # Portland#1067054 DRAWN BY BFC

REV. 3.00

SCALE 8.5' x 11'

FAN #1 NCA16FA - EXHAUST FAN

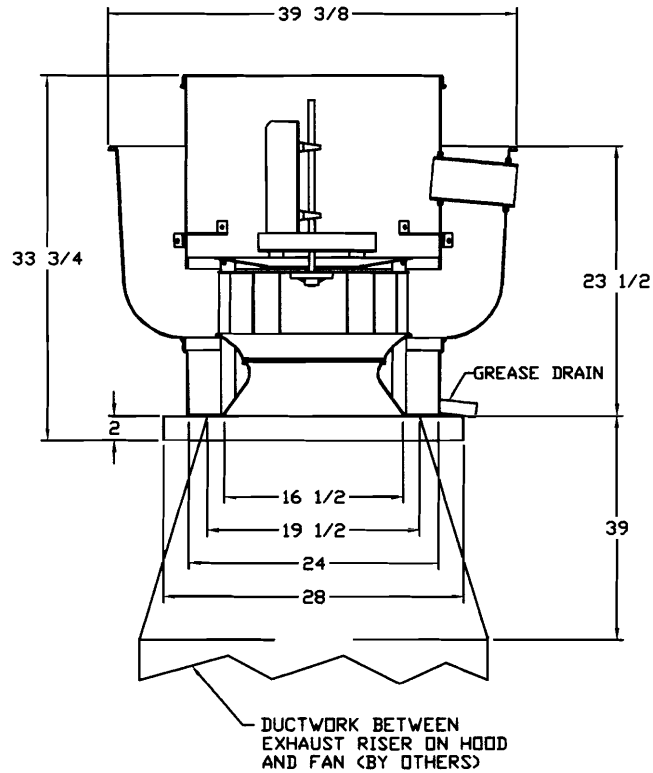

FEATURES:

- ROOF MOUNTED FANS
- RESTAURANT MODEL
- UL762
- AMCA SOUND AND AIR CERTIFIED
- WIRING FROM MOTOR TO DISCONNECT SWITCH
- WEATHERPROOF DISCONNECT
- HIGH HEAT OPERATION 300°F (149°C)
- GREASE CLASSIFICATION TESTING

NORMAL TEMPERATURE TEST
EXHAUST FAN MUST OPERATE CONTINUOUSLY WHILE EXHAUSTING AIR AT 300°F (149°C) UNTIL ALL FAN PARTS HAVE REACHED THERMAL EQUILIBRIUM, AND WITHOUT ANY DETERIORATING EFFECTS TO THE FAN WHICH WOULD CAUSE UNSAFE OPERATION.

ABNORMAL FLARE-UP TEST
EXHAUST FAN MUST OPERATE CONTINUOUSLY WHILE EXHAUSTING BURNING GREASE VAPORS AT 600°F (316°C) FOR A PERIOD OF 15 MINUTES WITHOUT THE FAN BECOMING DAMAGED TO ANY EXTENT THAT COULD CAUSE AN UNSAFE CONDITION.

OPTIONS

- GREASE BOX
- FAN BASE CERAMIC SEAL - FOR GREASE DUCTS
- HINGE KIT - SHIPS LOOSE FOR CURB SUPPLIED BY OTHERS

CUSTOMER APPROVAL TO MANUFACTURE:

Approved as Noted

Approved with NO Exception Taken

Revise and Resubmit

SIGNATURE _____

Your Title _____ Date _____

CAPTIVE AIR

<i>JOB</i> Portland #1067054	
<i>LOCATION</i>	
<i>DATE</i> 1/4/2010	<i>JOB #</i> 1067054
<i>DWG #</i> Portland#1067054	<i>DRAWN BY</i> BFC
<i>REV.</i> 3.00	<i>SCALE</i> 8.5' x 11'

EXHAUST FAN INFORMATION

FAN UNIT NO.	FAN UNIT MODEL #	MODEL	TAG	CFM	S.P.	RPM	H.P.	Ø	VOLT	FLA	WEIGHT (LBS.)
1	NCA16FA	NCA16FA		3000	1.100	1093	1.500	1	230	10.2	179.05

HEATER/MUA FAN INFORMATION

FAN UNIT NO.	FAN UNIT MODEL #	BLOWER	HOUSING	TAG	CFM	S.P.	RPM	H.P.	Ø	VOLT	FLA	WEIGHT (LBS.)
2	NSAU2-G12	G12	NSAU.2		2700	1.000	880	1.500	1	230	10.2	287.77

FAN OPTIONS

FAN UNIT NO.	OPTION (Qty. - Descr.)
1	1 - Grease Box
	1 - Fan Base Ceramic Seal - For Grease Ducts
	1 - Hinge Kit - Ships Loose for Curb Supplied by Others
2	1 - Gravity Backdraft Damper for Size 2 Housing

FAN ACCESSORIES

FAN UNIT NO.	FAN UNIT TAG	EXHAUST			SUPPLY			
		GREASE CUP	GRAVITY DAMPER	WALL MOUNT	SIDE DISCHARGE	GRAVITY DAMPER	MOTORIZED DAMPER	WALL MOUNT
1		YES						
2					YES	YES		

CUSTOMER APPROVAL TO MANUFACTURE:Approved as Noted Approved with NO Exception Taken Revise and Resubmit

SIGNATURE _____

Your Title _____ Date _____

CAPTIVE AIRE

JOB Portland #1067054

LOCATION


DATE 1/4/2010

JOB # 1067054

DWG # Portland#1067054 DRAWN BY BFC

REV. 3.00

SCALE 8.5' x 11'

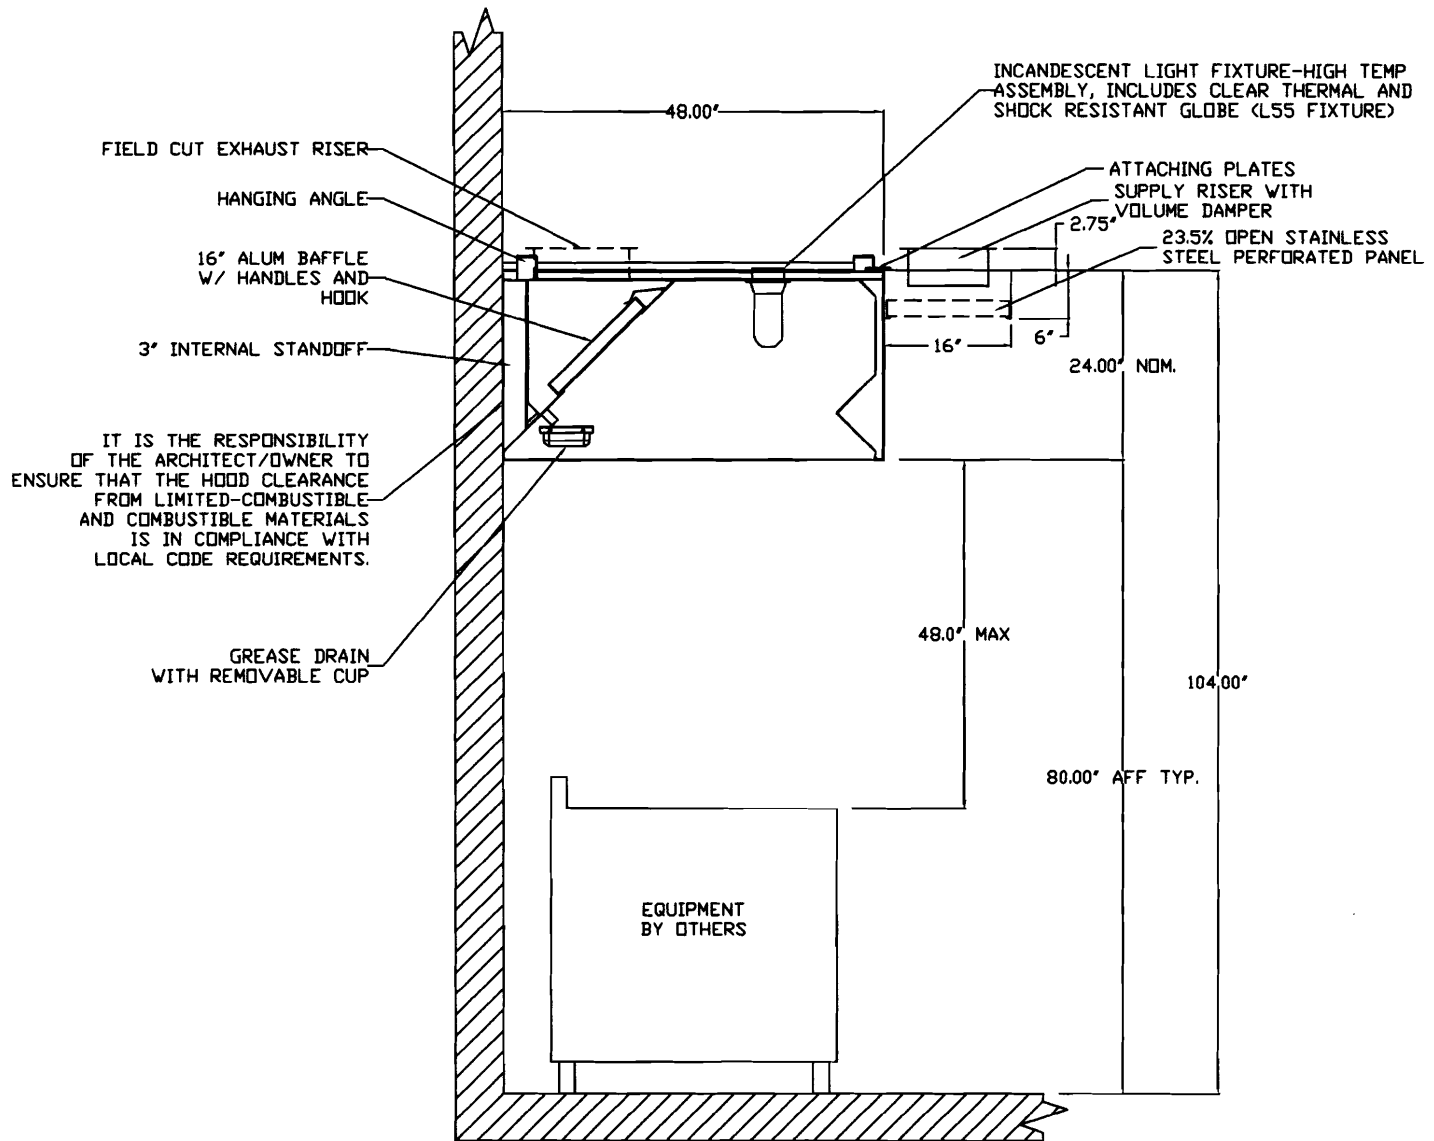

IT IS THE RESPONSIBILITY OF THE ARCHITECT/OWNER TO ENSURE THAT THE HOOD CLEARANCE FROM LIMITED-COMBUSTIBLE AND COMBUSTIBLE MATERIALS IS IN COMPLIANCE WITH LOCAL CODE REQUIREMENTS.

SECTION VIEW - MODEL 4824ND-2-PSP-F

CUSTOMER APPROVAL TO MANUFACTURE:

Approved as Noted

Approved with NO Exception Taken


Revise and Resubmit

SIGNATURE _____


Your Title _____ Date _____



JOB Portland #1067054	
LOCATION	
DATE 1/4/2010	JOB # 1067054
DWG # Portland#1067054	DRAWN BY BFC
REV. 3.00	SCALE 8.5' x 11'

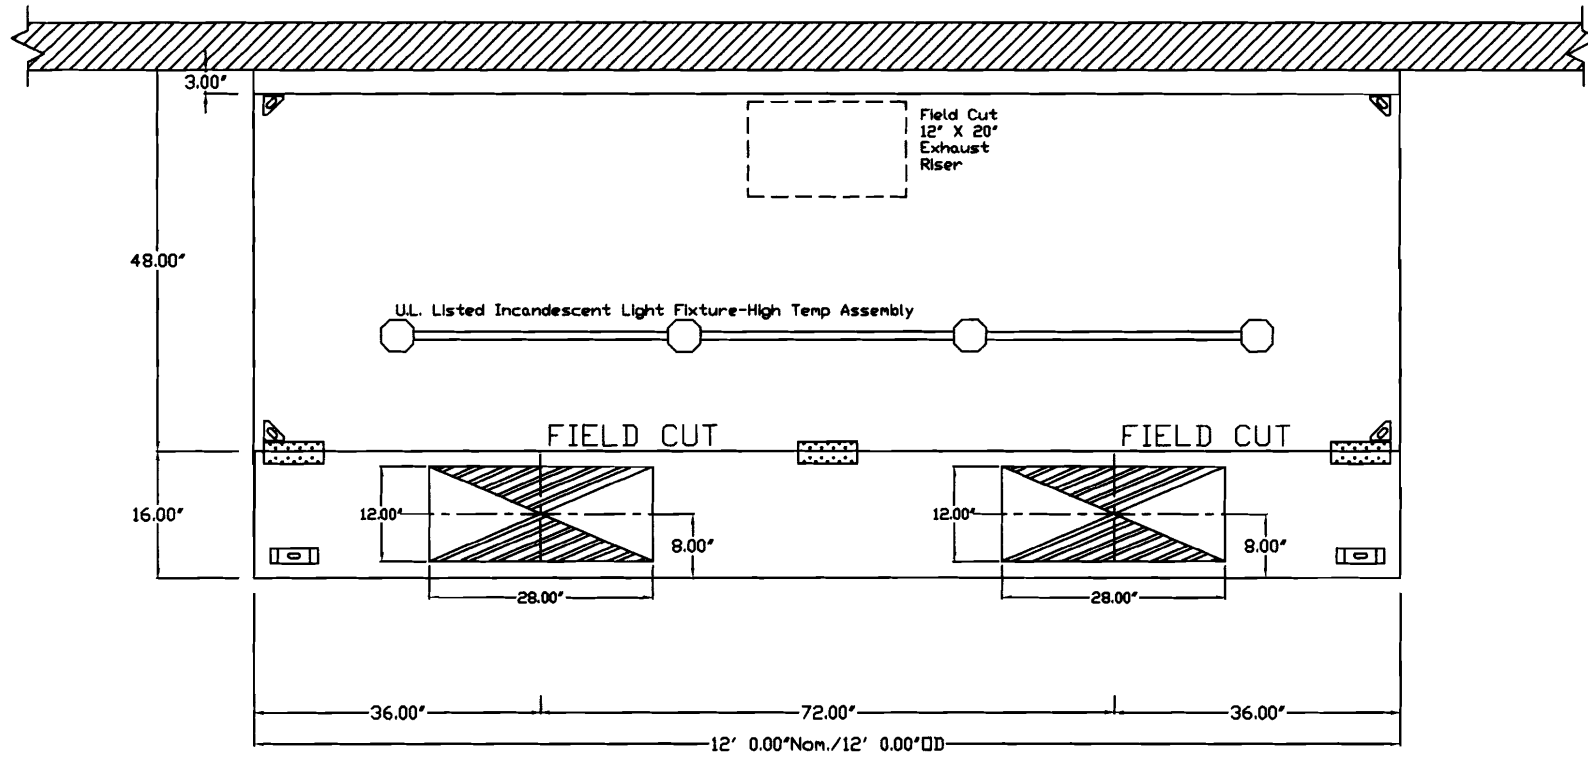

PLAN VIEW - Hood #1
12' 0.00" LONG 4824ND-2-PSP-F

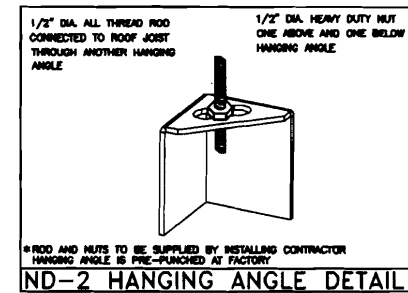

CUSTOMER APPROVAL TO MANUFACTURE:

Approved as Noted

Approved with NO Exception Taken

Revise and Resubmit

SIGNATURE _____

Your Title _____ Date _____

CAPTIVE AIR

JOB Portland #1067054

LOCATION

DATE 1/4/2010

JOB # 1067054

DWG # Portland#1067054 DRAWN BY BFC

REV. 3.00

SCALE 8.5' x 11'

HOOD INFORMATION

HOOD NO.	MODEL	LENGTH	MAX. COOKING TEMP.	EXHAUST PLENUM					SUPPLY PLENUM					HOOD CONSTRUCTION	HOOD CONFIG.		
				TOTAL EXH. CFM	RISER(S)				TOTAL SUP. CFM	RISER(S)					END TO END	ROW	
				WIDTH	LENG.	DIA.	CFM	S.P.	WIDTH	LENG.	DIA.	CFM	S.P.				
1	4824 ND-2-PSP-F	12' 0.00'	600 Deg.	3000	12'	20'		3000	-0.669'	2700					430 SS Where Exposed	ALONE	ALONE

HOOD INFORMATION

HOOD NO.	FILTER(S)			LIGHT(S)			UTILITY CABINET(S)						FIRE SYSTEM PIPING	HOOD HANGING WGHT	
	TYPE	QTY.	HEIGHT	LENGTH	QTY.	TYPE	WIRE GUARD	LOCATION	FIRE SYSTEM		ELECTRICAL	SWITCHES			
									TYPE	SIZE	MODEL #	QUANTITY	LOCATION		
1	Alum Baffle w/ Handles	4	16'	16'	4	Incandescent Light Fixt	NO							NO	536 LBS

PERFORATED SUPPLY PLENUM(S)

HOOD NO.	POS.	LENGTH	WIDTH	HEIGHT	RISER(S)				
					WIDTH	LENG.	DIA.	CFM	S.P.
1	Front	144'	16'	6'	12'	28'		1350	0.176'
					12'	28'		1350	0.176'

CAPTIVE-AIRE HOODS ARE
BUILT IN COMPLIANCE WITH



NFPA #96
NSF
UL 710 & ULC710 STANDARDS
E.T.L. LISTED 3054804-001

CUSTOMER APPROVAL TO MANUFACTURE:

Approved as Noted

Approved with NO Exception Taken

Revise and Resubmit

SIGNATURE _____

Your Title _____ Date _____

CAPTIVE-AIRE

JOB Portland #1067054

LOCATION

DATE 1/4/2010 **JOB #** 1067054

DWG # Portland#1067054 **DRAWN BY** BFC

REV. 3.00 **SCALE** 8.5' x 11'

Jeanie Bourke - Siano's


From: "mark" <hoodguy1@roadrunner.com>
To: <jmb@portlandmaine.gov>
Date: 2/10/2010 2:38 PM
Subject: Siano's
Attachments: Siano Hood.doc

Jeanie,
This is that drawing we talked about.
According to Kerry, the property owner, we are well within the 10' set back from property lines.
I think that was it
Mark Weimer.

Atlantic Restaurant Service
34 Albion Road
Windham, ME 04062

207-653-0645


Project: SIANO'S
505 FORE ST.

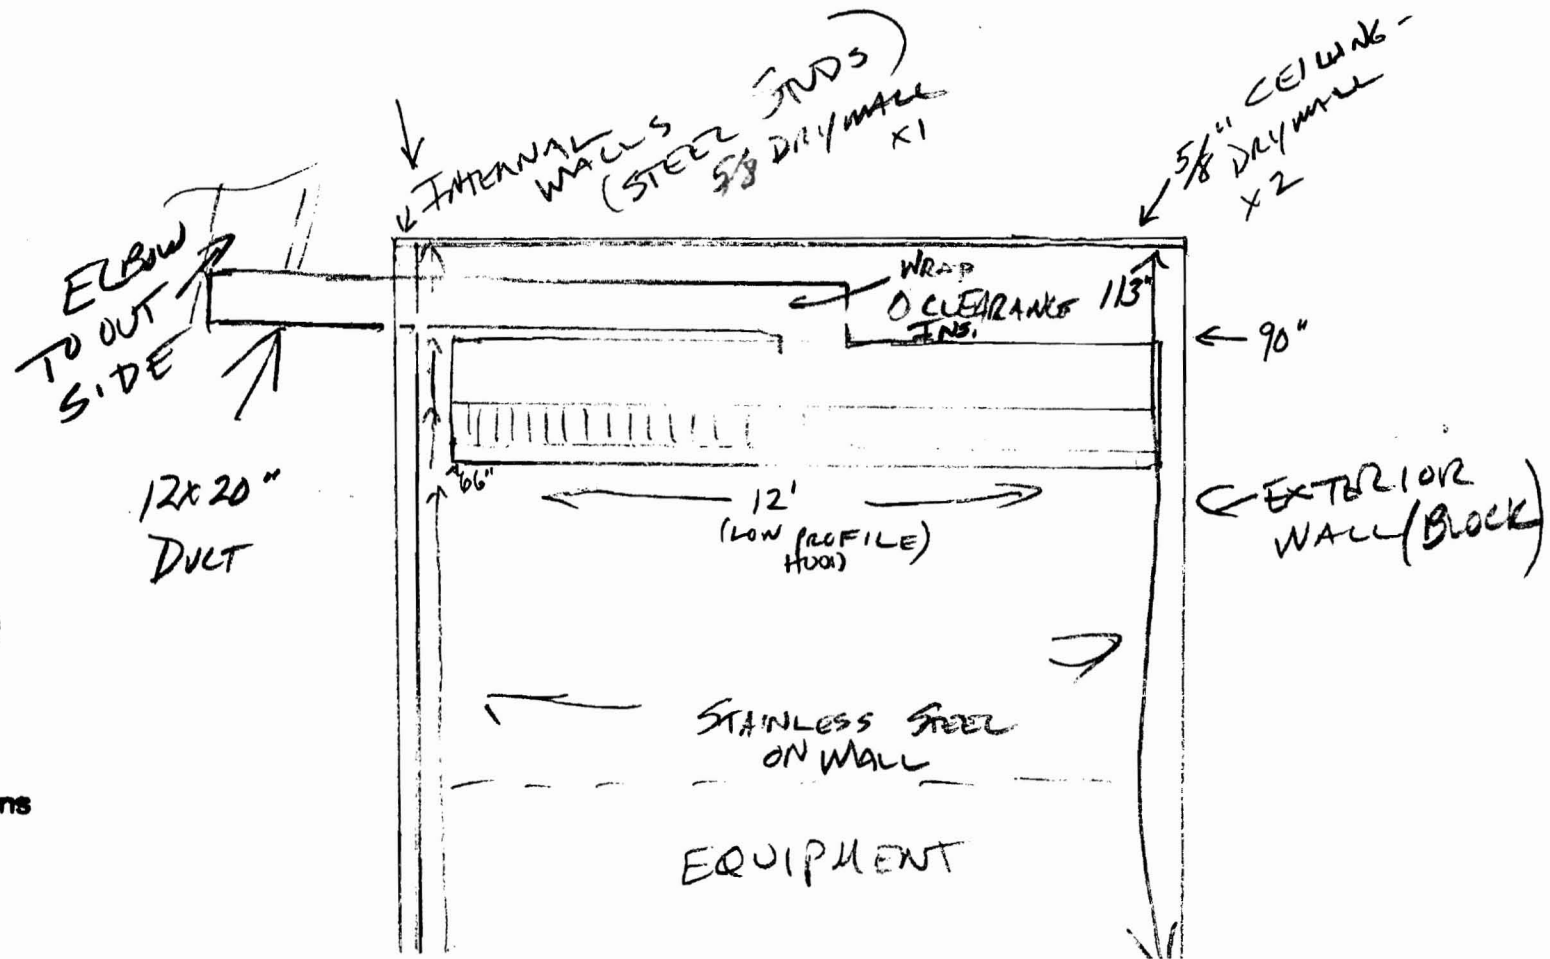

RECEIVED

FEB 11 2010

Dept. of Building Inspections
City of Portland Maine

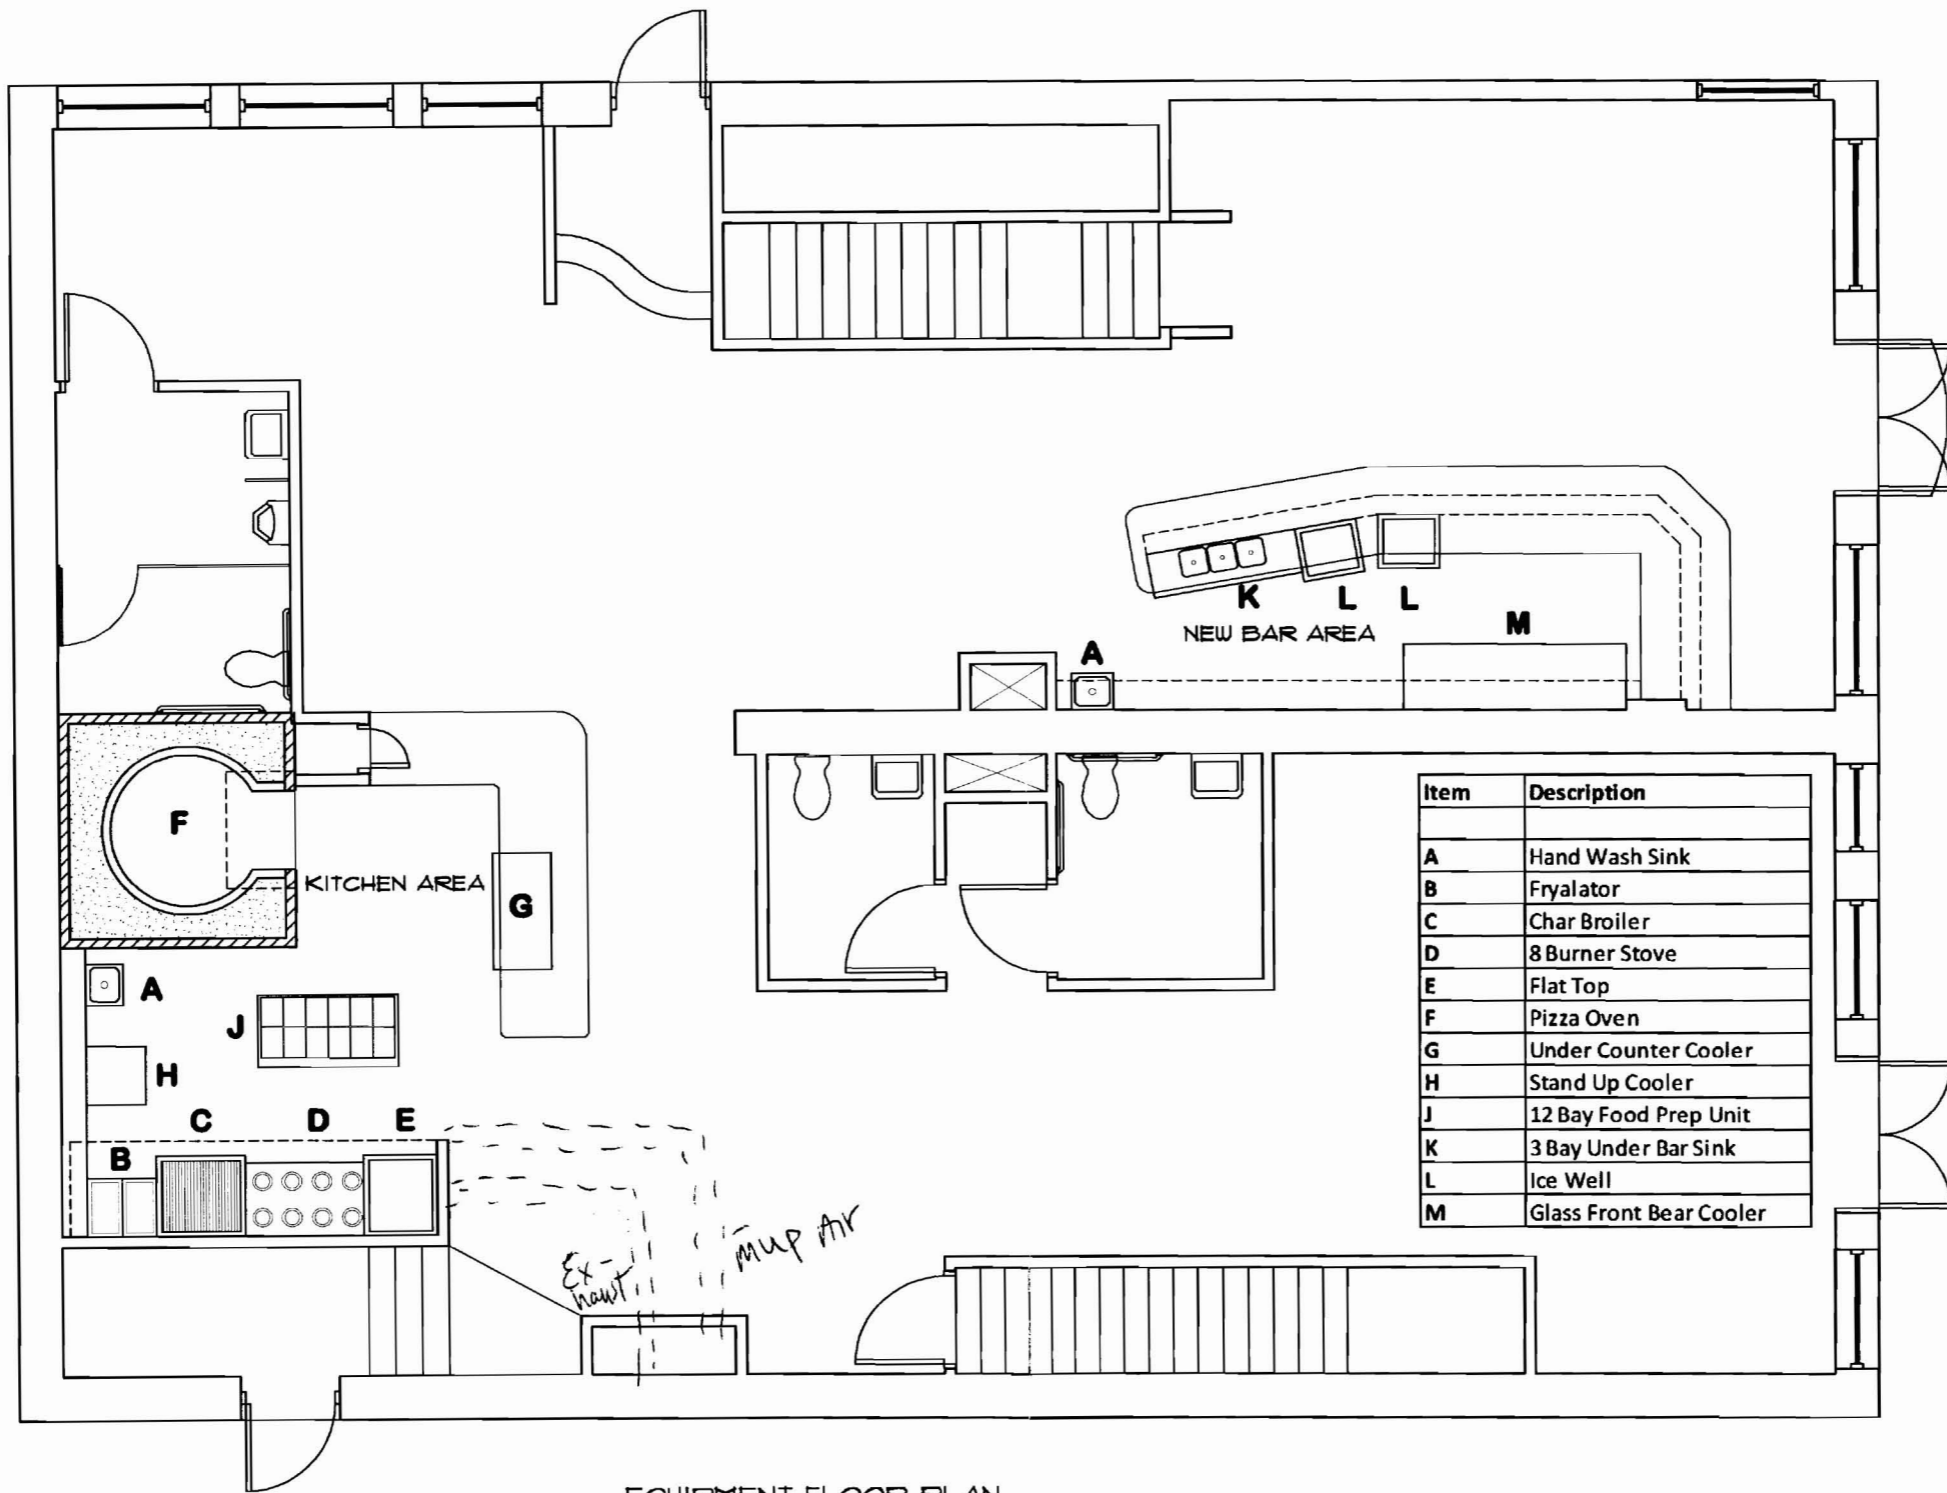

Item	Description
A	Hand Wash Sink
B	Fryalator
C	Char Broiler
D	8 Burner Stove
E	Flat Top
F	Pizza Oven
G	Under Counter Cooler
H	Stand Up Cooler
J	12 Bay Food Prep Unit
K	3 Bay Under Bar Sink
L	Ice Well
M	Glass Front Bear Cooler

EQUIPMENT FLOOR PLAN
SCALE: 3/16" = 1'-0"

PROPERTY OF
ad-de-Tech
238 Riverside Industrial Parkway
Portland, ME 04102
207-523-6468

Siano's Old Port Pizzeria
505 Commercial St. Portland, ME
Siano's Old Port Pizzeria, LLC

DATE	NO	REMARKS	BY
12-16-08	A	ISSUED FOR PERMITTING	JJO
01-29-09	B	ISSUED FOR PERMITTING	JJO

CODE: IBC 2008
TOWN: Portland
DATE: 12-10-08
SCALE: As Noted
DRAWN: JJO
TITLE:
Equipment Floor Plan
FILE: 000-00-08
SHEET:
A-2e