

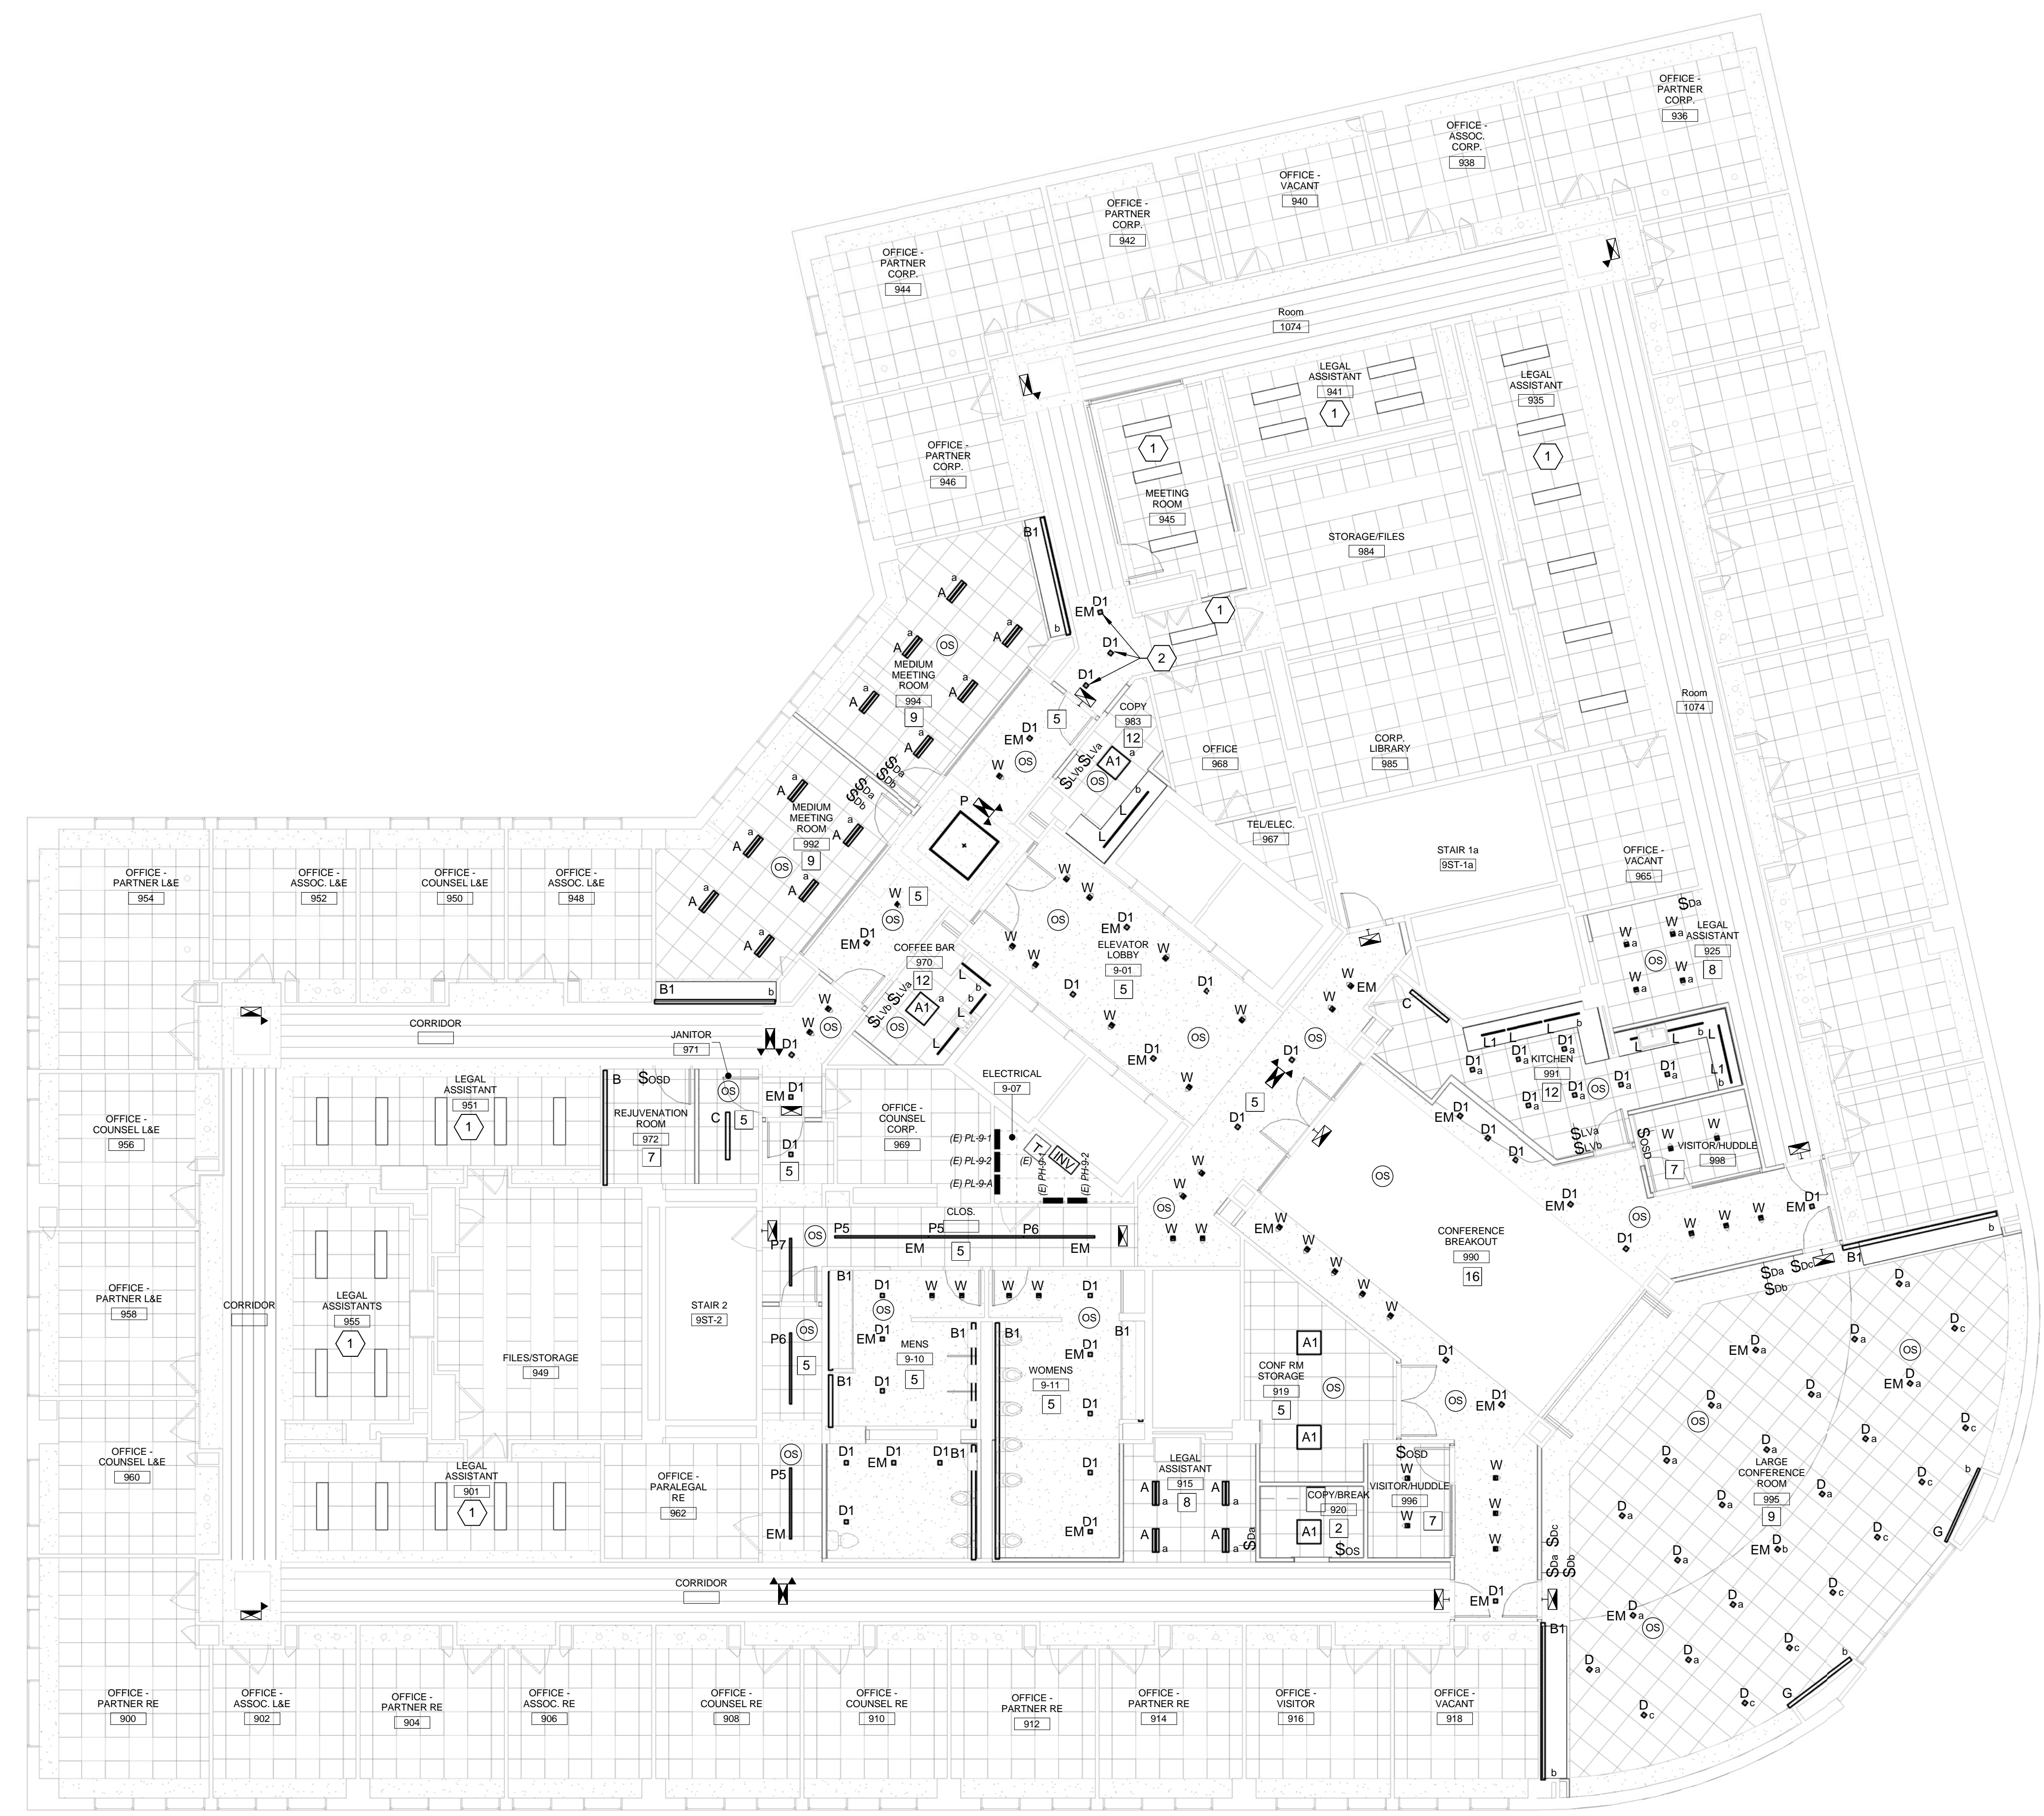


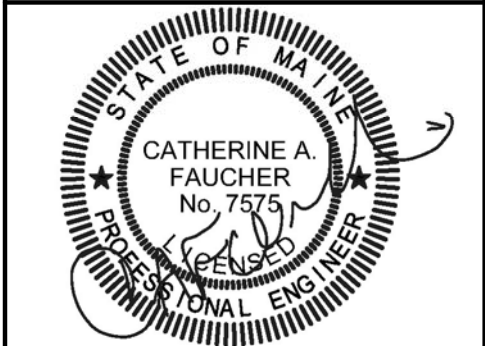

160 Veranda Street
Portland, Maine 04103
T: 207.221.2260
F: 207.221.2266
Web: www.allied-eng.com

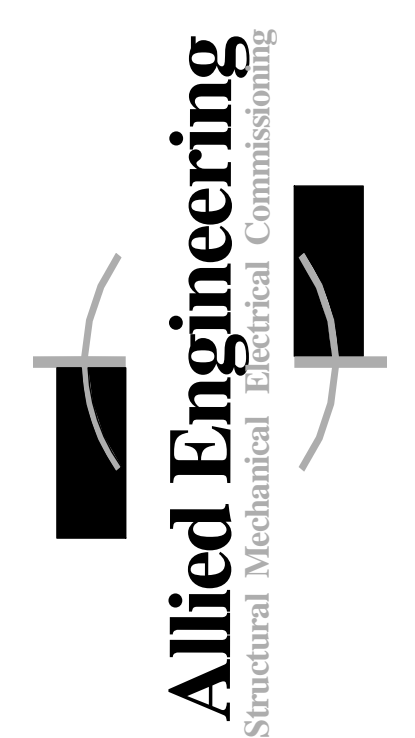

- 1 RELOCATE EXISTING LUMINAIRES IN THIS ROOM TO NEW CEILING AS INDICATED.
- 2 CONNECT TO EXISTING CORRIDOR LIGHTING BRANCH CIRCUIT AND CONTROLS.

C9 KEYNOTES

- 1 LIGHTING CONTROL SHALL BE MANUAL ON/MANUAL OFF VIA WALL SWITCHES.
- 2 LIGHTING CONTROL SHALL BE MANUAL ON/AUTO OFF WALL SENSOR SWITCH - DETAIL A1/EL-50.1
- 3 - NOT USED -
- 4 LIGHTING CONTROL SHALL BE AUTO ON/AUTO OFF WALL SENSOR SWITCH WIRED FOR 3-WAY OPERATION - SEE DETAIL D1/EL-50.1
- 5 LIGHTING CONTROL SHALL BE AUTO ON/AUTO OFF VIA CEILING OCCUPANCY SENSOR(S) - SEE DETAIL F1/EL-50.1
- 6 LIGHTING CONTROL SHALL BE MANUAL ON/AUTO OFF VIA CEILING SENSOR(S) - DETAIL A3/EL-50.1
- 7 LIGHTING CONTROL SHALL BE WALL MOUNTED OCCUPANCY SENSOR DIMMER SWITCH, MANUAL ON, AUTOMATIC OFF (NO DETAIL)
- 8 LIGHTING CONTROL SHALL BE 0-10V DIMMING WITH AUTO OFF VIA CEILING SENSOR(S) - DETAIL C3/EL-50.1
- 9 LIGHTING CONTROL SHALL BE AUTOMATIC-ON/AUTOMATIC-OFF VIA CEILING MOUNTED OCCUPANCY SENSORS WITH OFF OVERRIDE AND MANUAL DIMMING CONNECTED TO THE LOAD SIDE OF THE SENSOR RELAY - DETAIL D3/EL-50.1
- 10 LIGHTING CONTROL SHALL BE DUAL CIRCUIT SWITCHING WITH 2-BUTTON OCCUPANCY SENSOR - DETAIL F3/EL-50.1
- 11 LIGHTING CONTROL SHALL BE MANUAL ON/AUTO OFF WITH AUTOMATIC DAYLIGHT CONTROL - DETAIL A6/EL-50.1
- 12 LIGHTING CONTROL SHALL BE SWITCHING OF MULTIPLE GROUPS WITH AUTO OFF VIA CEILING SENSOR(S) - SEE DETAIL C6/EL-50.1

Mark Date Description

ISSUED FOR CONSTRUCTION

SEPTEMBER 21, 2016

Drawing Title

FLOOR 9 LIGHTING PLAN

Scale: As indicated

Drawing Number

EL-10.3