



HARRIMAN

AUBURN PORTLAND MANCHESTER


TD BANK ONE PORTLAND SQUARE 3RD FLOOR IT ROOM RELOCATION

PORTLAND, ME


Harriman Project No. 15494

Key Plan


Proj North

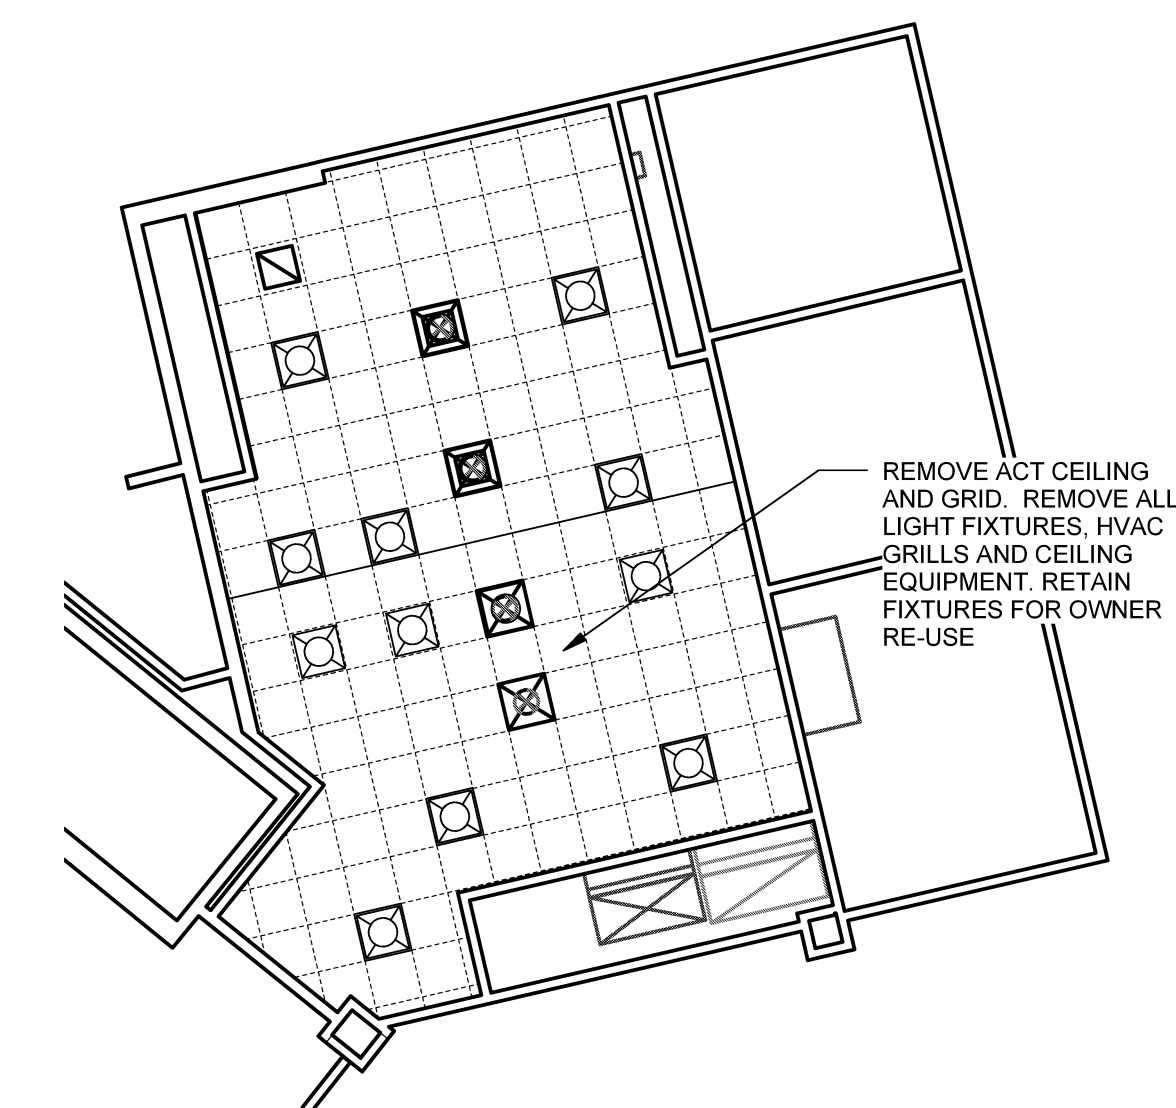

D5 THIRD FLOOR DEMOLITION CEILING PLAN SCALE: 1/8" = 1'-0"

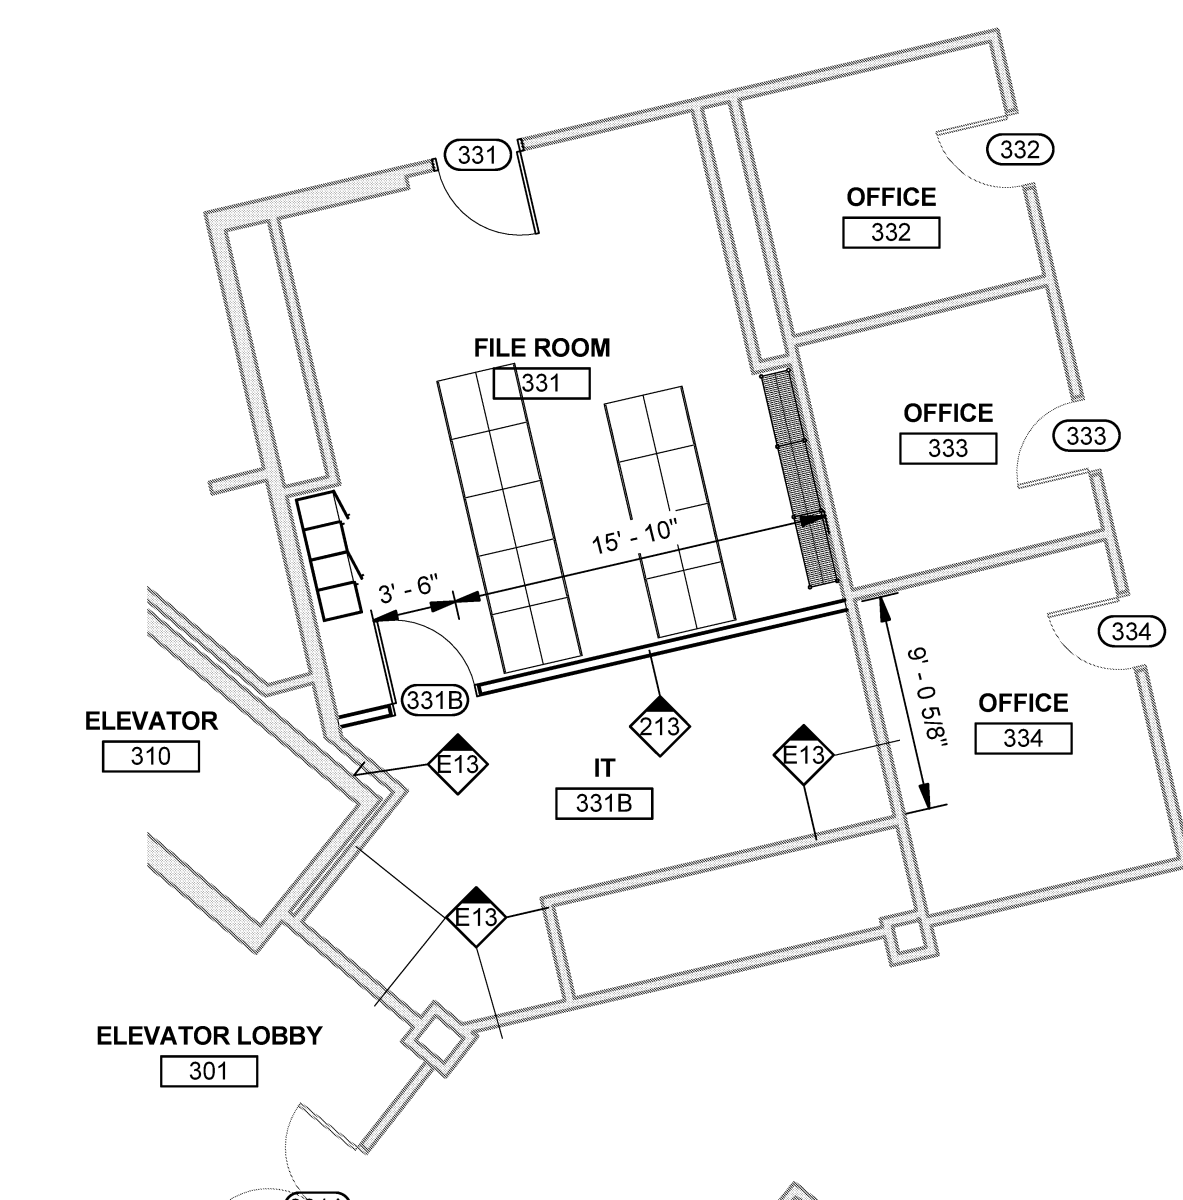

B5 THIRD FLOOR PLAN SCALE: 1/8" = 1'-0"

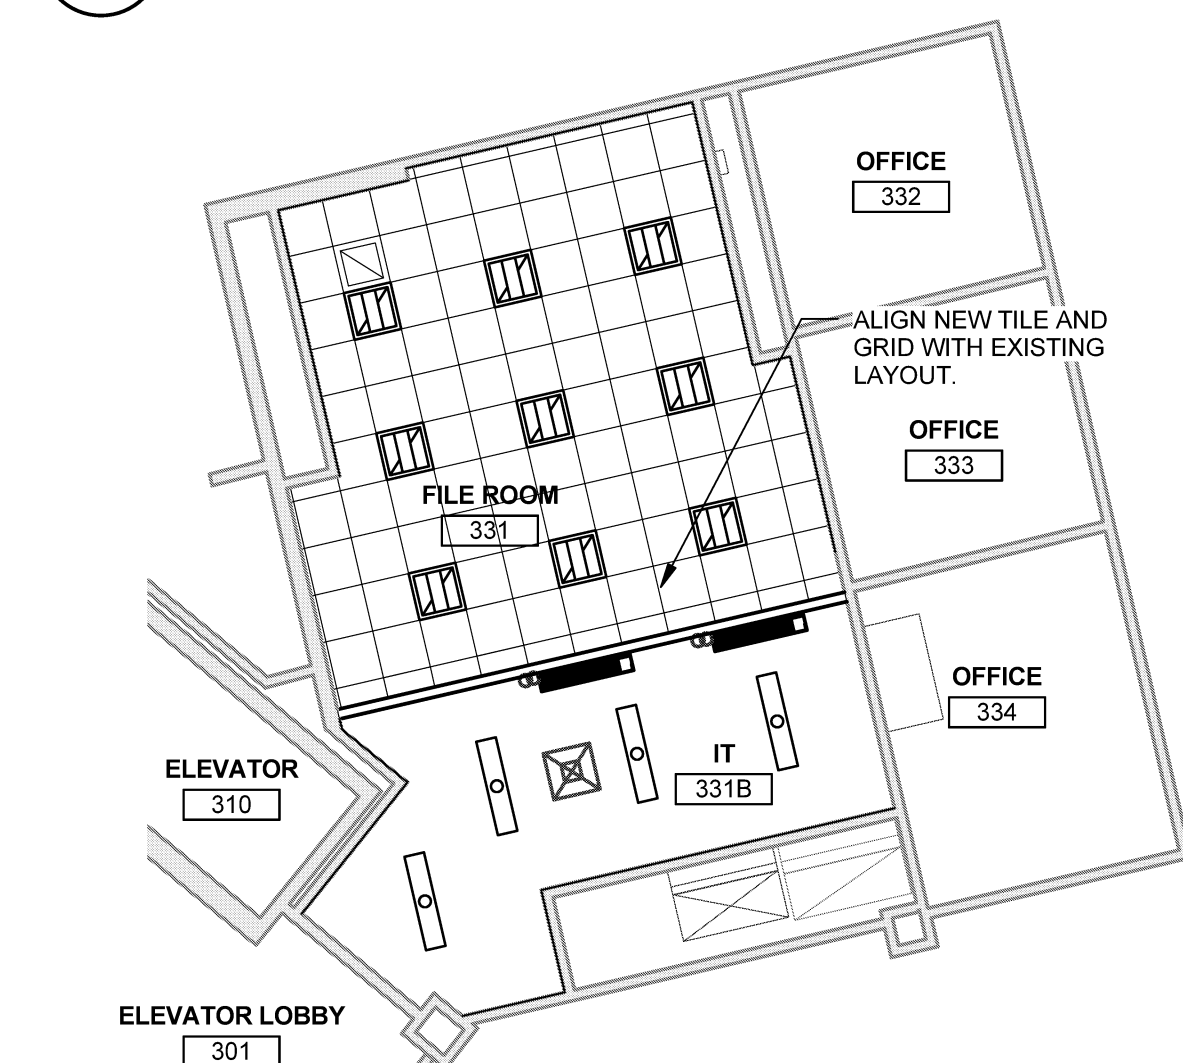

A5 THIRD FLOOR CEILING PLAN SCALE: 1/8" = 1'-0"

ROOM FINISH SCHEDULE table with columns: NUMBER, NAME, FLOOR, BASE, WALLS (NORTH, EAST, SOUTH, WEST), CEILING (MATERIAL, HEIGHT), REMARKS.


DOOR AND FRAME SCHEDULE table with columns: No., DOOR PANELS (PANEL SIZE, TYPE, MAT), FRAME (TYPE, MAT / FIN, DETAILS), FIRE RATING, HDW SET, REMARKS.

MATERIALS LEGEND table with columns: SPEC SECTION, MATERIAL, CODE NO., MANUFACTURER / SERIES, SIZE, COLOR / FINISH, REMARKS.


- DOOR NOTES: 1. SEE SPECIFICATIONS FOR HARDWARE SET DESCRIPTIONS. 2. ALL SWINGING DOORS TO BE 1-3/4" THICK (U.N.O.)...

- DOOR HARDWARE TYPES: HARDWARE SET 1: LOCKSET (STORAGE FUNCTION), 3 HINGES PER LEAF. HARDWARE SET 2: LOCKSET (STORAGE FUNCTION), 3 HINGES PER LEAF, SILENCERS, CLOSER, KICK PLATE, DOOR STOP, CARDREADER...


- GENERAL NOTES: 1. INTERIOR PARTITION DIMENSIONS ARE TO FACE OF EXISTING FINISH OF EXISTING PARTITION U.N.O. NEW CONSTRUCTION IS TO BE CENTERLINE...

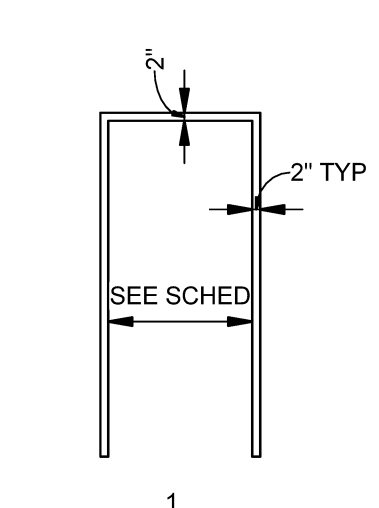


B1 HM FRAME TYPE SCALE: 1/4" = 1'-0"

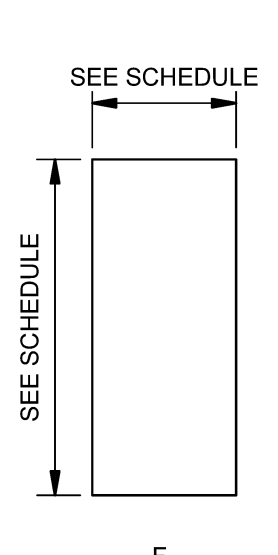


B2 DOOR TYPES SCALE: 1/4" = 1'-0"

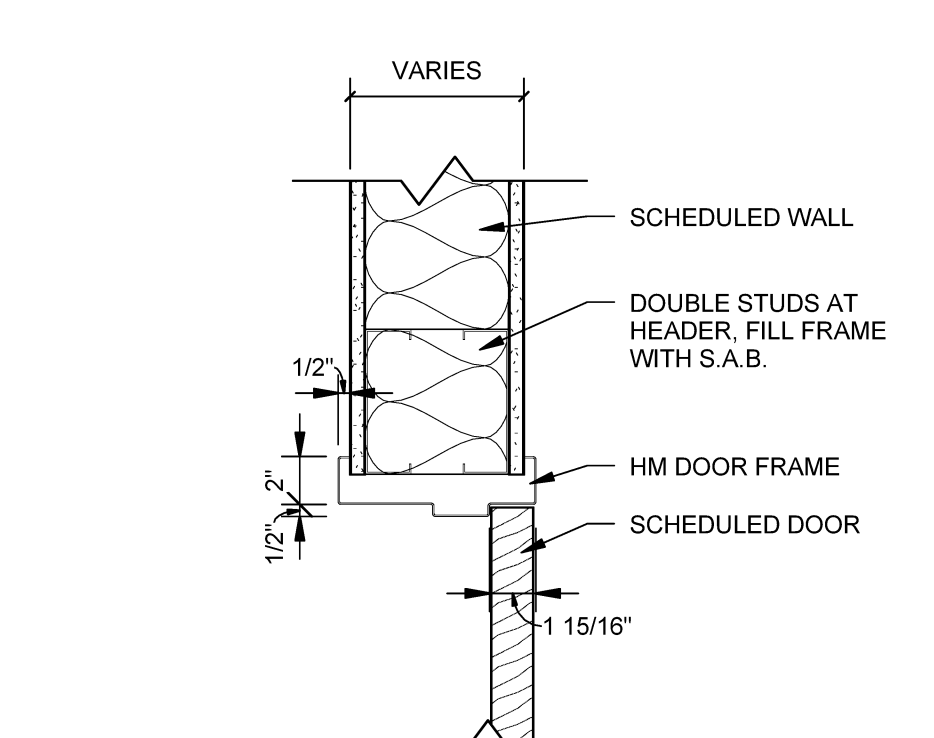

A1 TYP. HEAD DETAIL, HM FRAME SCALE: 1 1/2" = 1'-0"

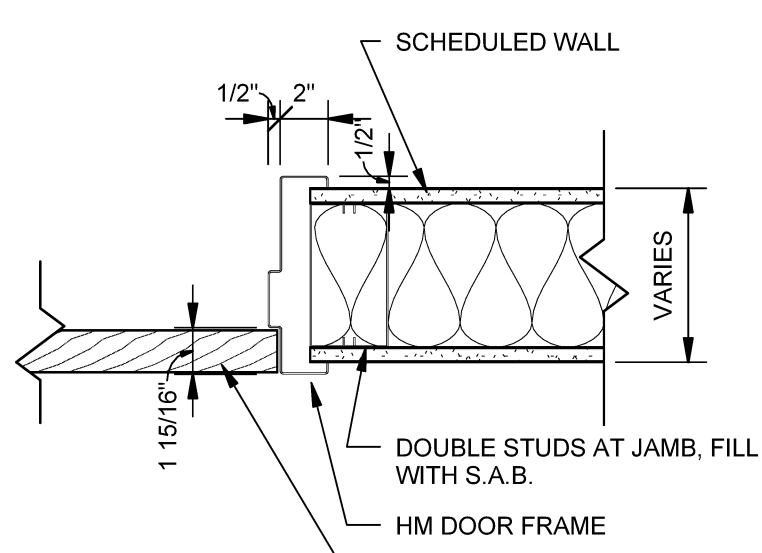

A2 TYP. JAMB DETAIL, HM FRAME SCALE: 1 1/2" = 1'-0"

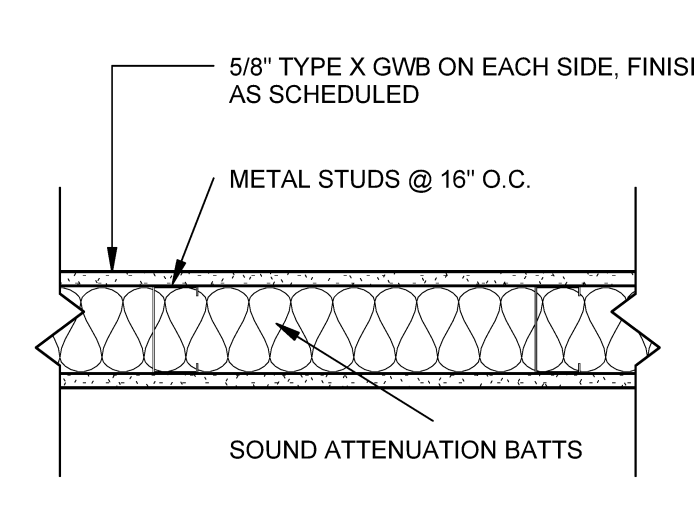

A3 STANDARD PARTITION WALL TO 6" ABOVE CEILING SCALE: 1 1/2" = 1'-0"

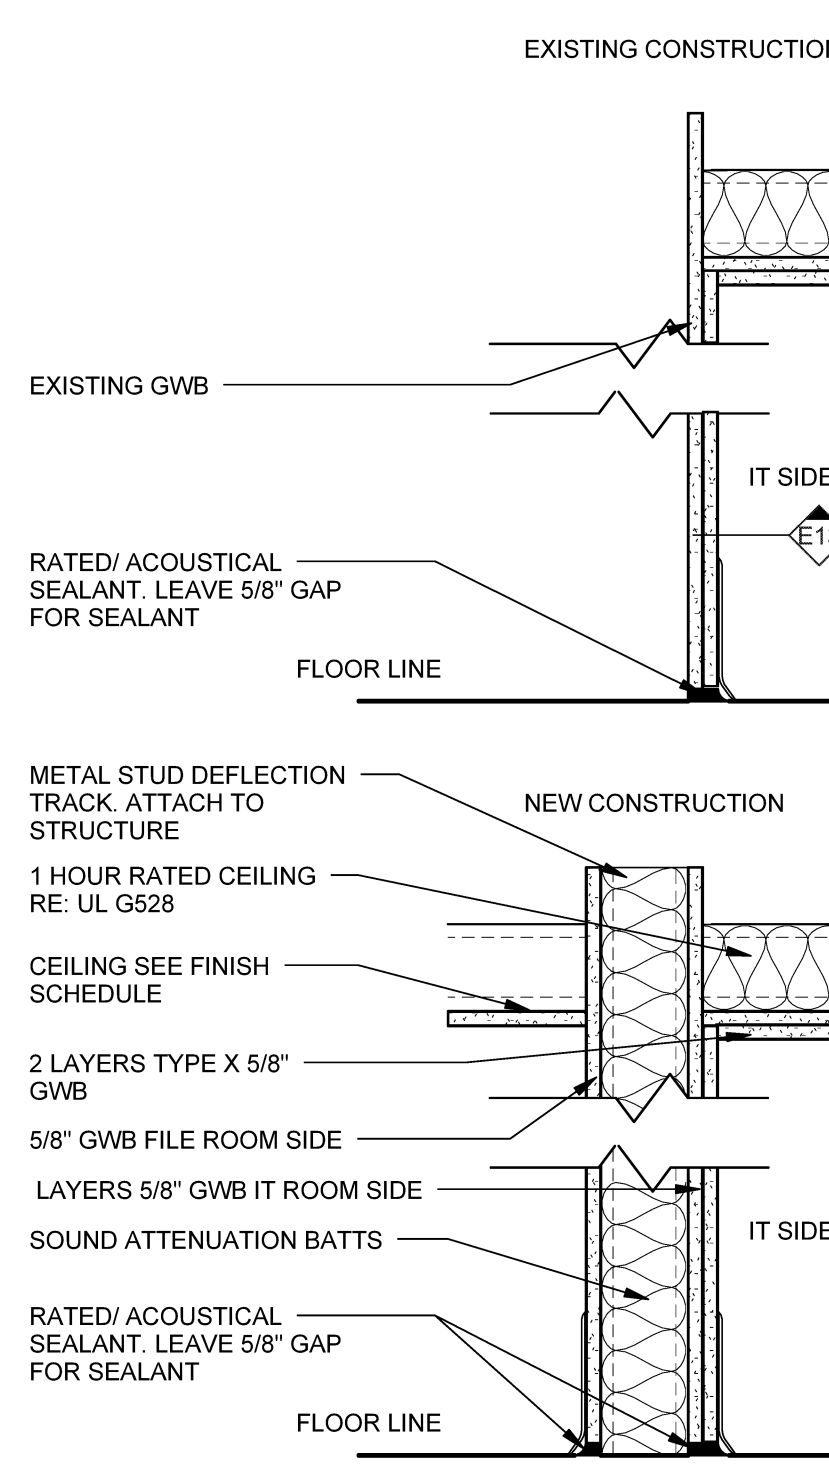


Table with columns: DESCRIPTION, non rated UL419, 1 hour UL-419, smoke UL-407. Rows include 3 5/8" STEEL STUD, EXISTING WALL - ADD ONE LAYER TYPE 'X' GWB.

Issues and Revisions table with columns: Mark, Date, Description.

Table with columns: Mark, Date, Description. Row: 10-20-15 CONSTRUCTION DOCUMENTS.

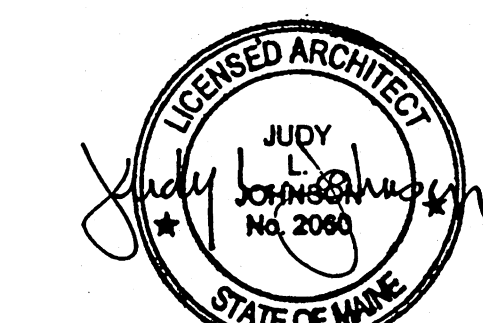


Table with columns: Drawing Scales, PA / PE, Drawn By, Copyright information.

FIRST FLOOR PLAN, RCP, SCHEDULES AND DETAILS

A10.1

Plot Date: 10/20/2015 10:35:01 AM