



SCALE: 1/16" = 1'-0"

Existing Second Floor Plan - Proposed Alterations SCALE: 1/16" = 1'-0"

GRAPHIC KEY

Renovated Areas

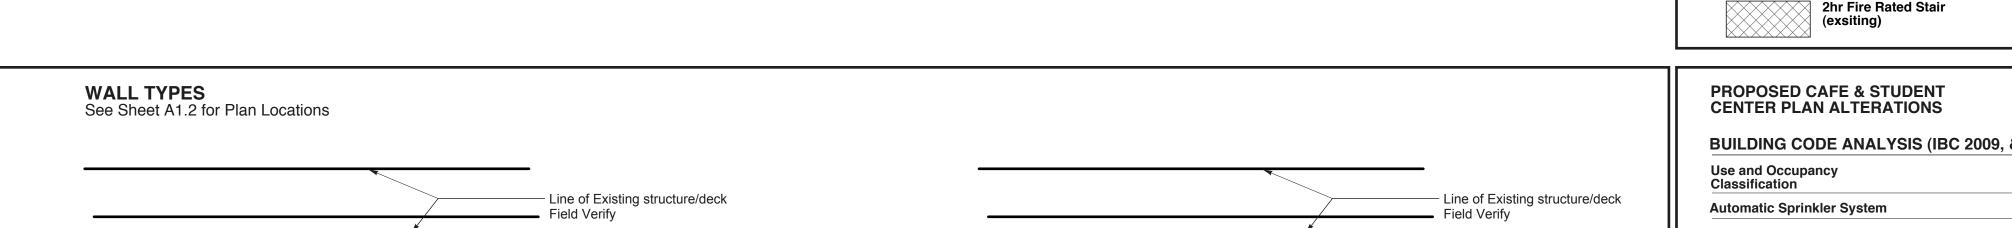

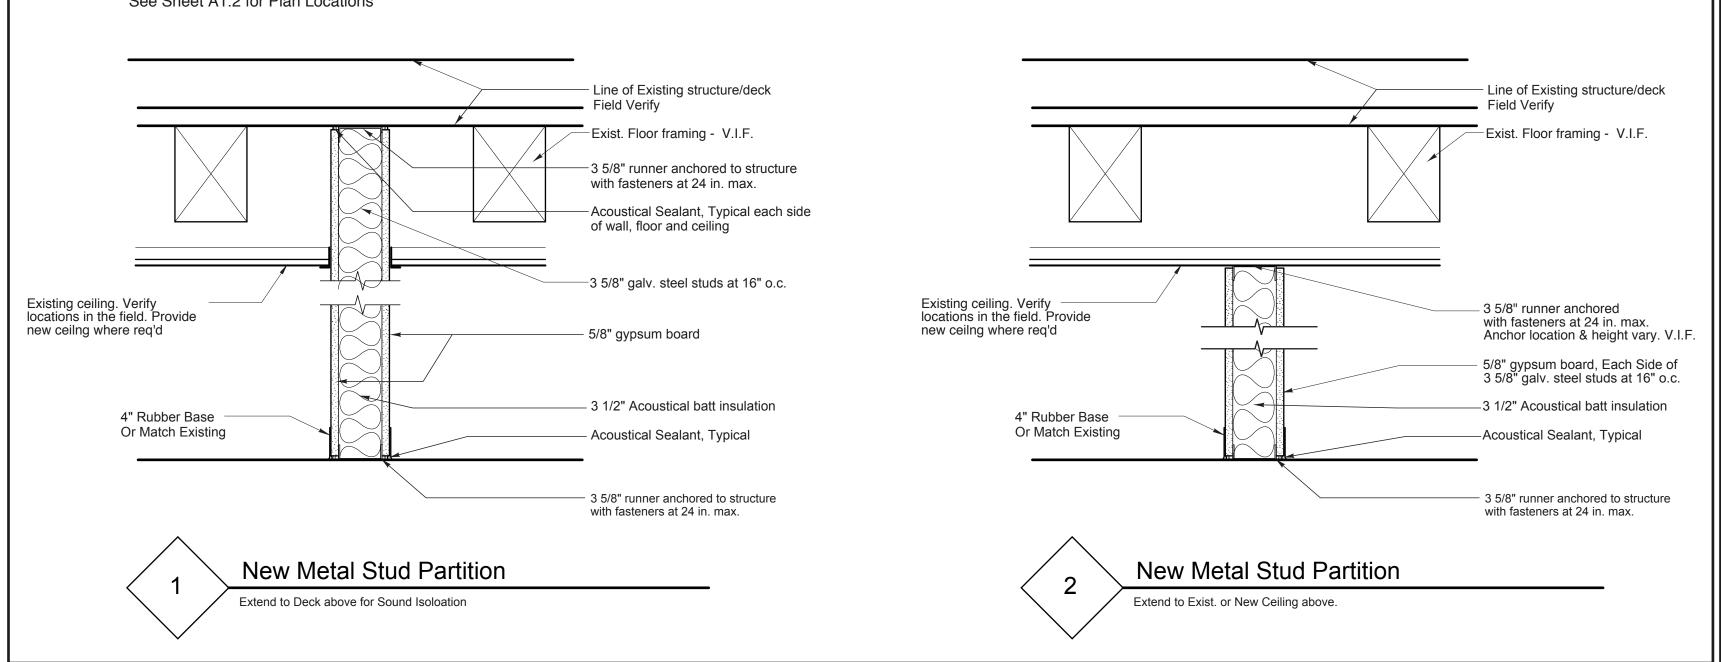

BUILDING CODE ANALYSIS (IBC 2009, & 2009 NFPA 101)	
Use and Occupancy Classification	Business Group B
Automatic Sprinkler System	The building is currently fully sprinklered per NFPA 13
Existing Building Information	Second Floor Total Floor Area = Approx 11,778 sq ft
Means of Egress Components Exit access travel distance w/ automatic sprinkler system	300 ft (IBC Table 1016.1) 300 ft (NFPA 101, 39.2.6.1)
	Not Exceeded
Minumum number of exits required per floor Exits Provided	(2) (IBC Table 1021.1) (2) (NFPA 101, 7.4.1.1) (3)
Min. number of exits required for Combined Cafe/Student Center	(2) (IBC Table 1021.1) (2) (NFPA 101, 7.4.1.1)
Minumum width = 3'-0" (3 exits provided total width = 12'-0")	
Maximum Common Path of Travel	100 ft (IBC Table 1014.3) 100 ft (NFPA 101, 39.2.5.3.1 & 7.5.1.1.4)
	Not Exceeded
Exit Through Intervening Spaces	Allowed per (NFPA 101, 7.5.1.2, 7.5.1.2.1) and (IBC 1014.2) Marked and identified per 7.10
Occupant Load (NFPA 101 Table 7.3.1.2, and BC 1004.1.1)	
Cafe Food Serving (including washing area)	861 sq ft
Occupant Load calculated using Occupant Load Factor of 100 gross sq ft per person	Occupancy Load = 9 persons
Cafe Area (Not incld. serving and washing area)	424 sq ft
Occupant Load calculated using Occupant Load	Occupancy Load = 28 persons

Existing Walls

New Walls

MAINE

Existing Walls To Be Removed

Existing Doors To Be Removed/Relocated

====

Richard Re Portland, ME 207.773.9699

Student Proposed Cafe and S Center Alterations Drawn by: File Name:

Floor Plans