

SPRINGER'S JEWELERS FREE STREET ENTRANCE & ELEVATOR RENOVATIONS

INDEX OF DRAWINGS

STORE FIXTURE PLAN STORE POWER PLAN

STORE REFLECTED CEILING PLAN STORE ELEVATIONS

DEMOLITION & FLOOR PLANS

ELEVATIONS, SECTIONS & PARTIAL ROOF FRAMING PLAN

DETAILS & REFLECTED CEILING PLANS A-104 DOORS, WINDOWS & PARTITION TYPES ELECTRICAL SYMBOLS LIST AND DETAILS

1ST FLOOR LIGHTING PLAN

E2.0 BASEMENT POWER PLANS

1ST FLOOR POWER AND SYSTEMS PLANS

RISER DIAGRAMS AND FEEDER SCHEDULE

ABBREVIATIONS

CONCRETE MASONRY UNIT(S) **GYPSUM WALLBOARD HOLLOW METAL FRAME** LONG LEG VERTICAL LAMINATED VENEER LUMBER

MAX MAXIMUM MINIMUM

NOT IN CONTRACT PRESSURE TREATED TONGUE & GROOVE

UNLESS NOTED OTHERWISE VERIFY IN FIELD

SPECIFICATIONS

ALLOWANCE No. 1 ELECTRICAL CONTRACTOR TO INCLUDE \$500.00 ALLOWANCE FOR LIGHT FIXTURES IN LOBBY 01, LOBBY 02 & LOBBY 03

ALTERNATE No. 1: IN LIEU OF ANODIZED FINISH FOR ALUMINUM STOREFRONT, ENTRANCE DOOR, ALUMINUM WINDOWS & PREFINISHED ALUMINUM

FLASHING, PROVIDE SATIN BLACK BAKED ENAMEL FINISH

ALUMINUM STOREFRONT: KAWNEER THERMALLY BROKEN 2" x 4 1/2" ALUMINUM TUBE WITH

BLACK ANODOZIED FINISH ALUMINUM WINDOW: THERMALLY BROKEN WITH BLACK ANODIZED FINISH; MATCH EXISTING WINDOW PROFILES TO GREATEST EXTENT POSSIBLE

GLAZING TYPE 1: TEMPERED 1" CLEAR INSULATED GLASS **GWB FINISH:** PROVIDE LEVEL FOUR FINISHING OF GWB, WITH 1 PRIMER AND 2 FINISH COATS OF PAINT

HILTI THREADED ROD: 3/4" Ø HILTI HAS-E THREADED ROD WITH SCREEN TUBE, HIT-HY 20 ADHESIVE, 8" EMBEDMENT

FIRE RESISTANT GWB: 5/8" TYPE X FC GYPSUM WALLBOARD MIRROR FRAMELESS 24" x 36"; MOUNT BOTTOM AT ≤ 3'-4" AFF P-1 TOILET: KOHLER K-3810 SANTA ROSA COMPACT ELONGATED TOILET WITH

TOILET SEAT, COVER & LEFT-HAND TRIP LEVER P-2 LAVATORY KOHLER K-1999 BRENHAM WALL-MOUNT LAVATORY WITH SHROUD & 8" CENTER-SET, LESS SOAP DISPENSER HOLE; KOHLER CORALAIS WIDESPREAD LAVATORY FAUCET WITH LEVER HANDLES

PREFINISHED ALUMINUM FLASHING: 20 GAUGE MINIMUM; FINISH TO MATCH THAT OF WINDOWS SUSPENDED ACOUSTIC TILE: REPLACE EXISTING CEILING GRID & TILE WITH ARMSTRONG CIRRUS TEGULAR 2X2 TILES WITH STANDARD 15/16" GRID

GENERAL NOTES

DRAWING NOTES: UNLESS INDICATED OR OBVIOUS OTHERWISE, OR INDICATED AS "NIC," ALL DRAWING NOTES REFER TO NEW CONSTRUCTION, TO BE INCLUDED IN CONTRACT

DIMENSIONS: DIMENSIONS ARE TO FACE OF NEW STUD FRAMING, AND TO FINISH FACE OF EXISTING CONSTRUCTION, UNLESS INDICATED

LAYOUTS: DO NOT START LAYOUTS WITH DIMENSIONS INDICATED AS "+/-" WOOD @ CONCRETE: PROVIDE PRESSURE TREATED WOOD WHERE WOOD IS IN CONTACT WITH CONCRETE, MASONRY OR STONE

ALUMINUM @ CONCRETE: ISOLATE ALUMINUM FROM CONTACT WITH CONCRETE RATED CONSTRUCTION: COMPLETELY SEGREGATE SPACES, CHASES & SHAFTS ENCLOSED BY RATED CONSTRUCTION & MAINTAIN CONTINUITY OF SPECIFIED RATING, INCLUDING AT FLOOR/CEILING ASSEMBLIES

ROUGH OPENINGS FOR FUTURE: WHERE ROUGH OPENINGS FOR FUTURE INSTALLATION OF DOORS ARE INDICATED, INFILL SUCH OPENINGS IN ACCORDANCE WITH INDICATED PARTITION TYPES, INCLUDING REMOVABLE FRAMING

UTILITIES CHASE: 2-HOUR RATED CHASE FOR GAS, ELECTRICAL, SPRINKLER & REFRIGERANT LINES


FLOOR ELEVATIONS: ALL VERTICAL FLOOR & SLAB ELEVATIONS ARE APPROXIMATE

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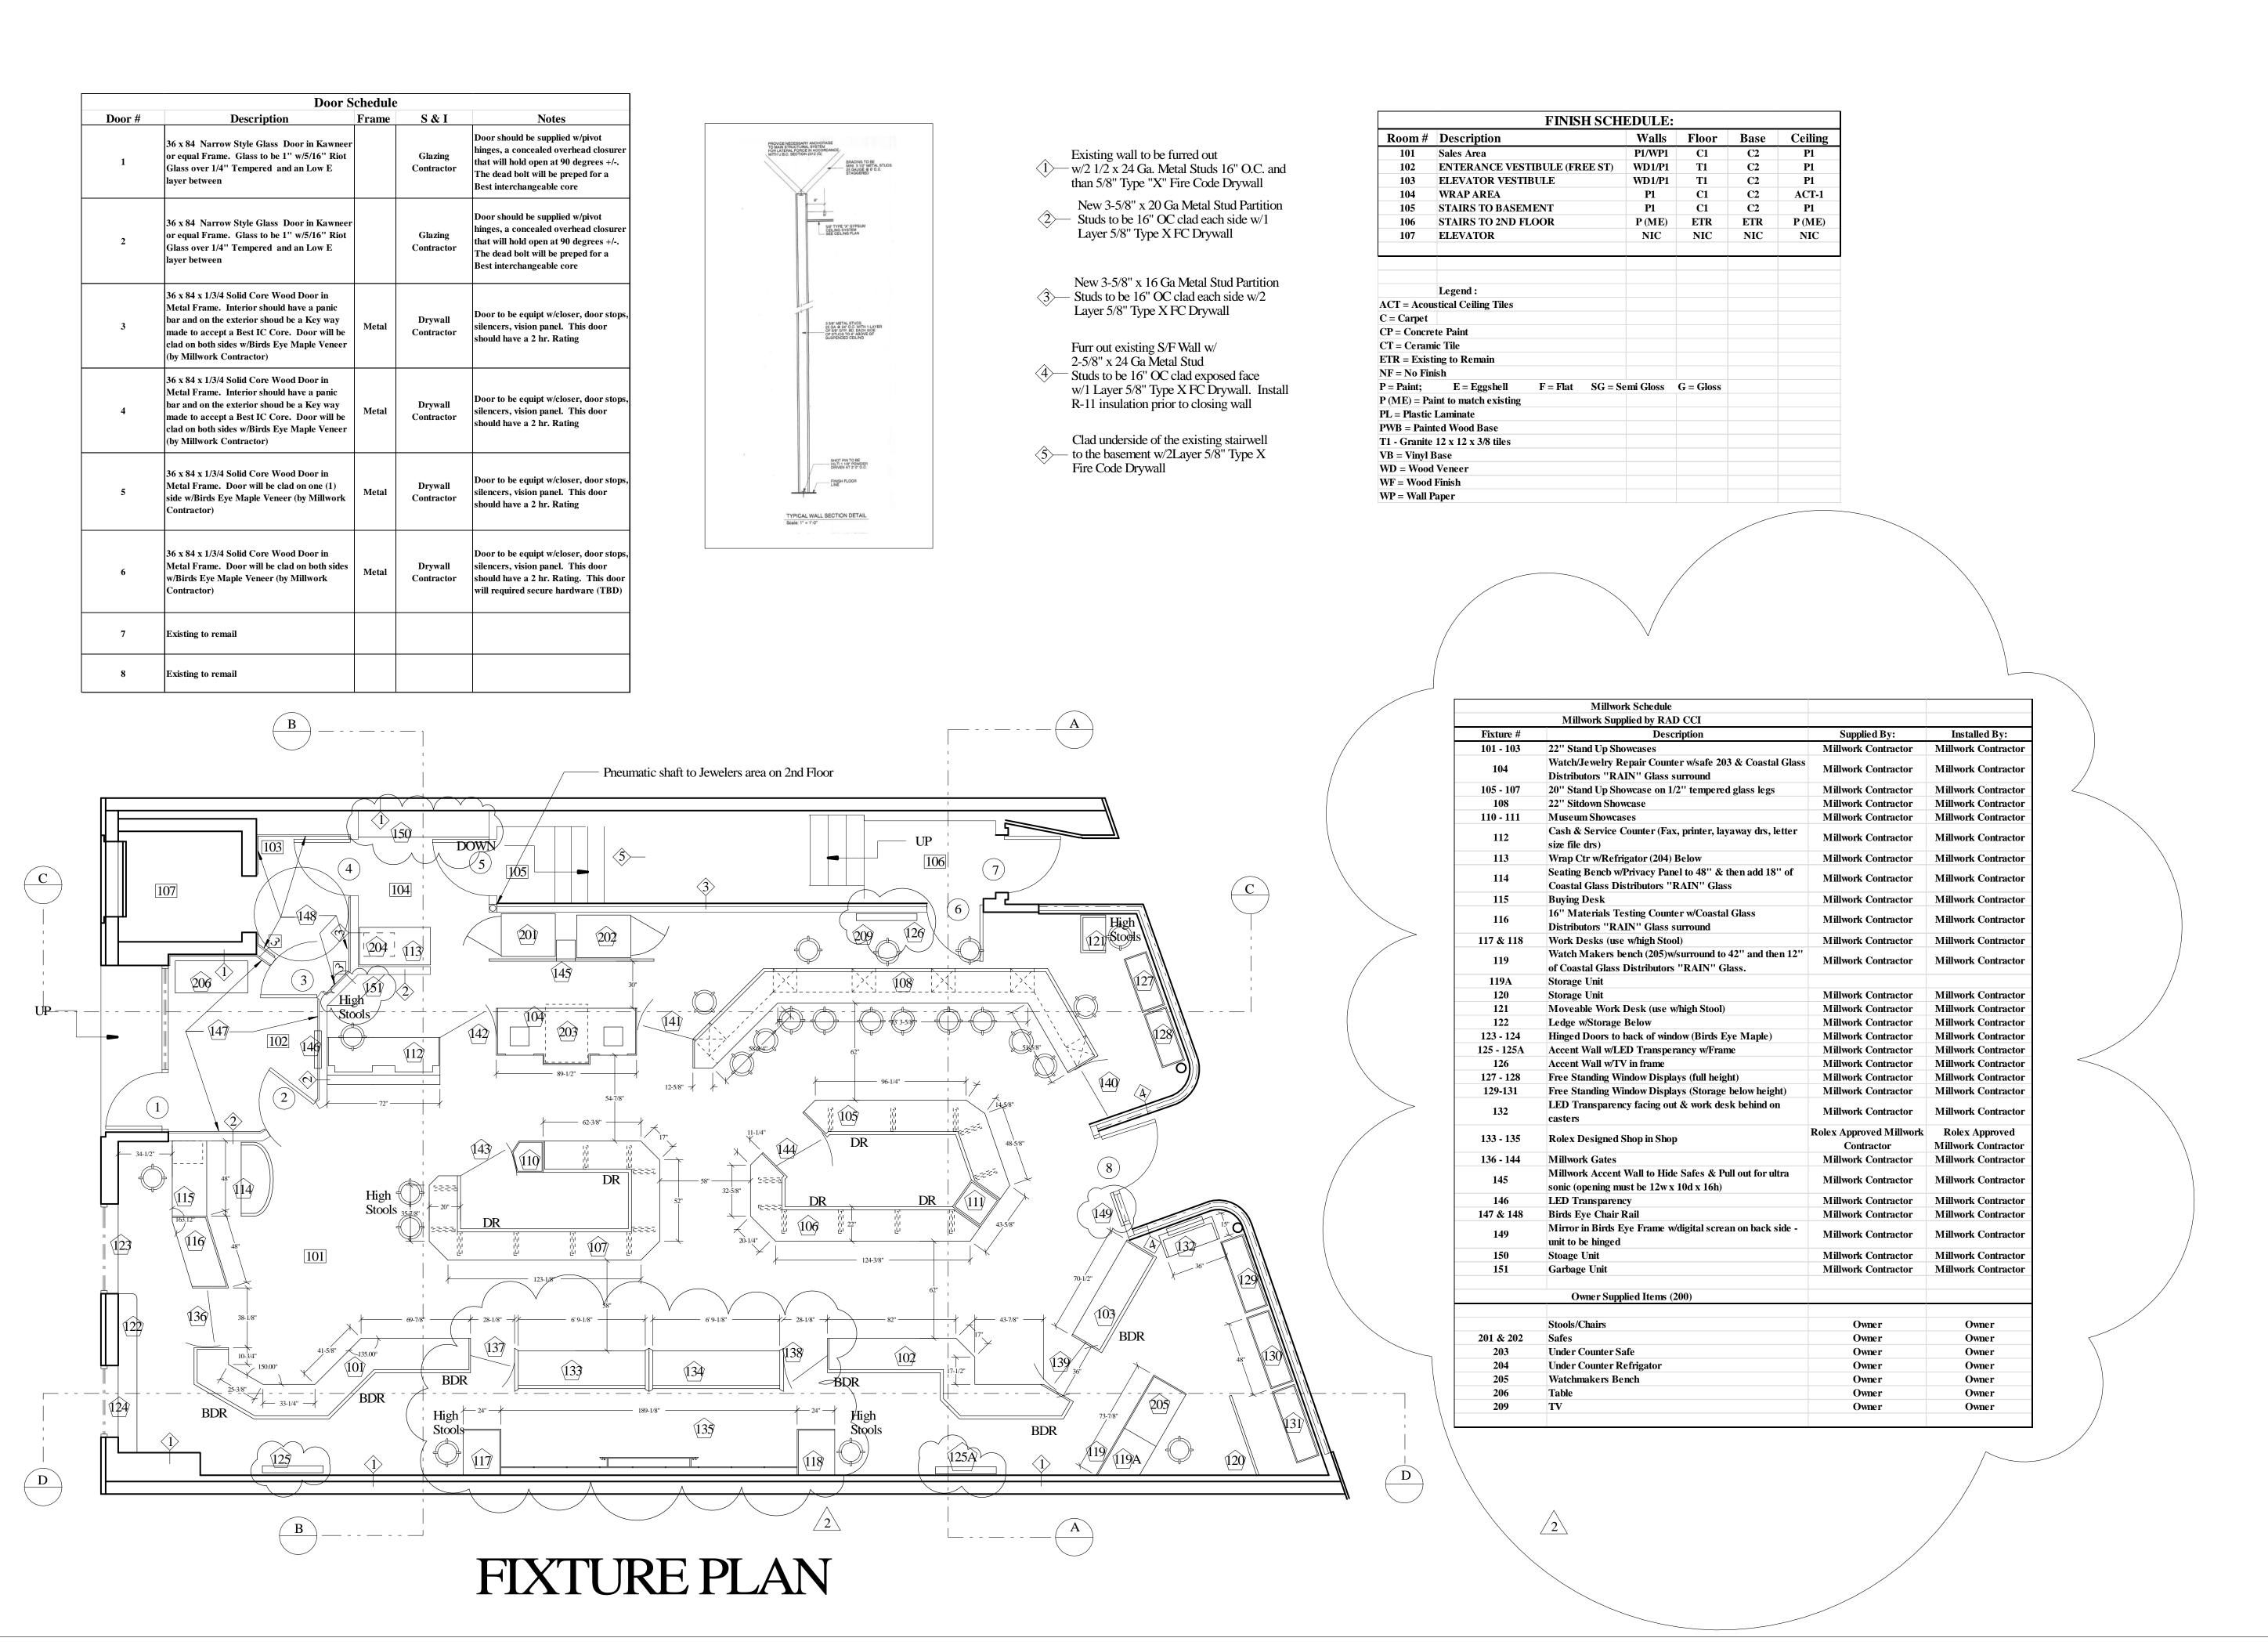
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APRIL 27, 2012 drawn by:

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COVER SHEET

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SPRINGER'S JEWELERS

580 CONGRESS STREET PORTLAND, MAINE

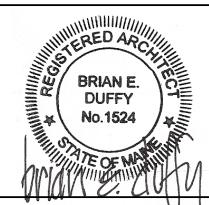1/4" = 1' - 0"

date: APRIL 27, 2012

drawn by:


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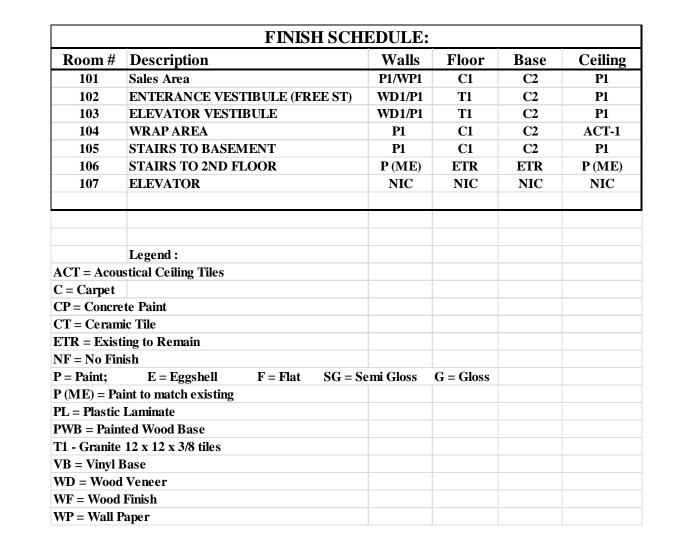
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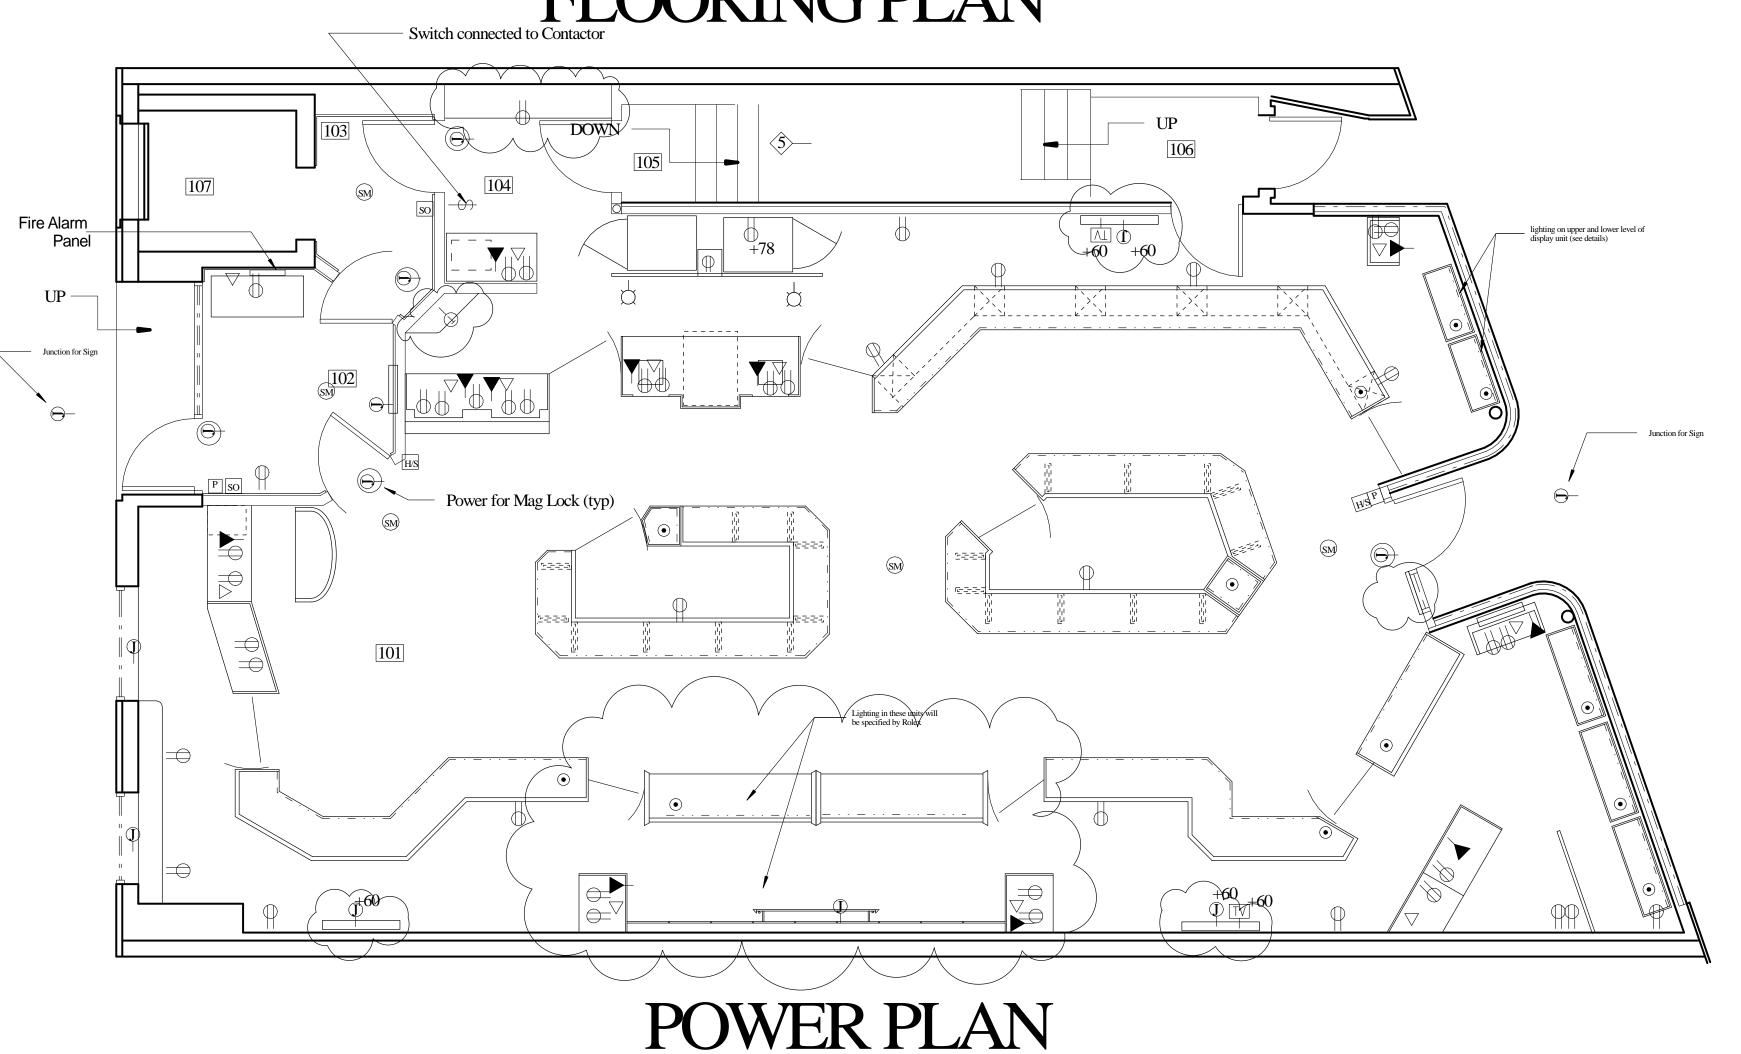
FIXTURE PLAN

sheet:

A1





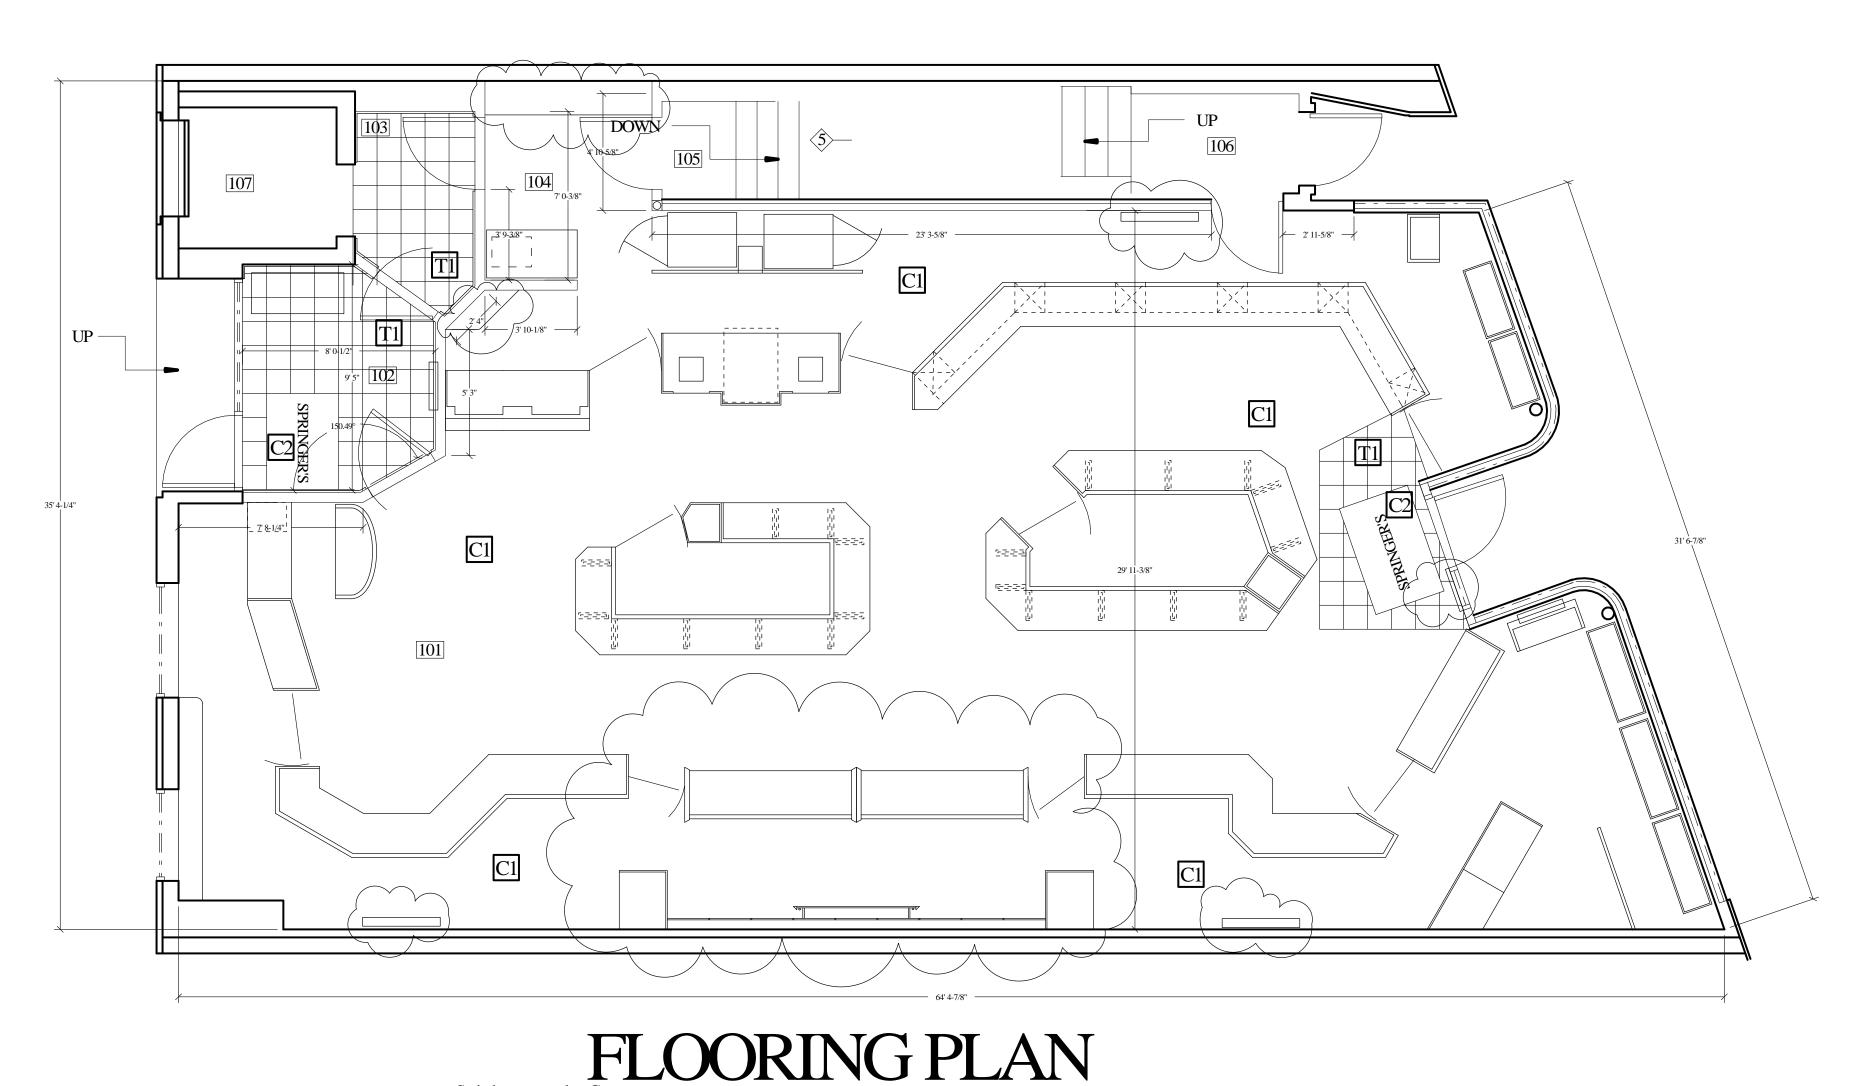

New 3-5/8" x 16 Ga Metal Stud Partition

Studs to be 16" OC clad each side w/2
Layer 5/8" Type X FC Drywall

Furr out existing S/F Wall w/
2-5/8" x 24 Ga Metal Stud

Studs to be 16" OC clad exposed face
w/1 Layer 5/8" Type X FC Drywall. Install
R-11 insulation prior to closing wall

Clad underside of the existing stairwell
to the basement w/2Layer 5/8" Type X
Fire Code Drywall

FIRE ALARM NOTES:

SM Ceiling Mtd Smoke Detector

H/S Horn/Strobe

P Pull Station

SO Strobe Only

All Fire Alarm Devices will be hardwired back to a cental alarm panel that is to be Monitored by LL'S Local Alarm
Contractor.

Existing wall to be furred out


w/2 1/2 x 24 Ga. Metal Studs 16" O.C. and than 5/8" Type "X" Fire Code Drywall


New 3-5/8" x 20 Ga Metal Stud Partition
Studs to be 16" OC clad each side w/1
Layer 5/8" Type X FC Drywall


Exact heights and locations of Fire Alarm Devices will be determined by


adhere to all Fire Codes


the Local Fire Alarm Contractor and will

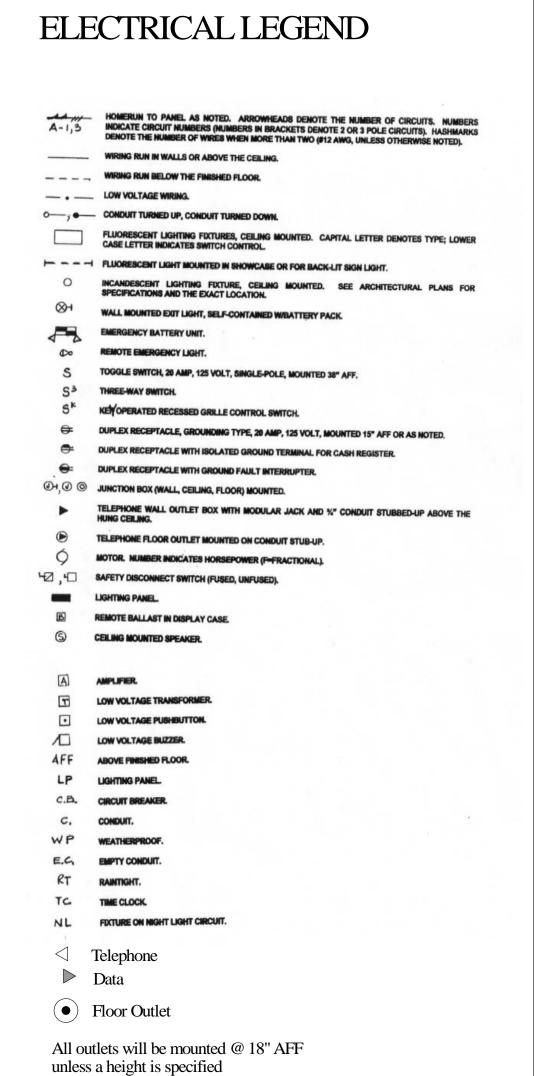

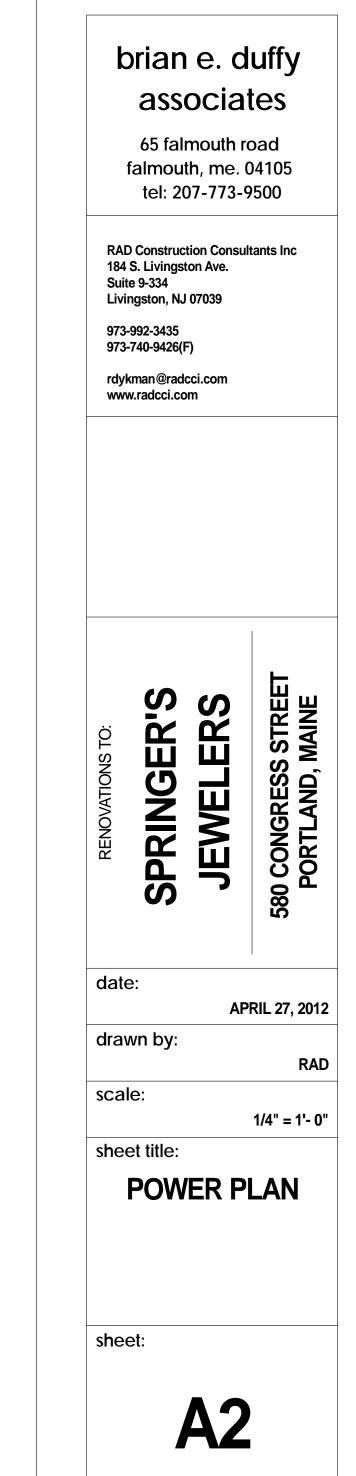

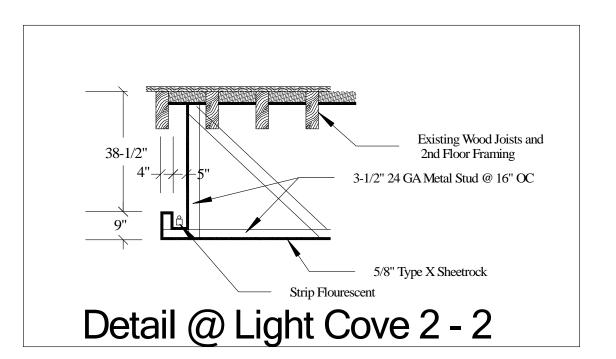


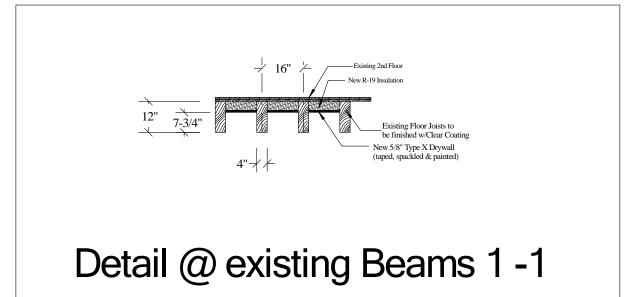


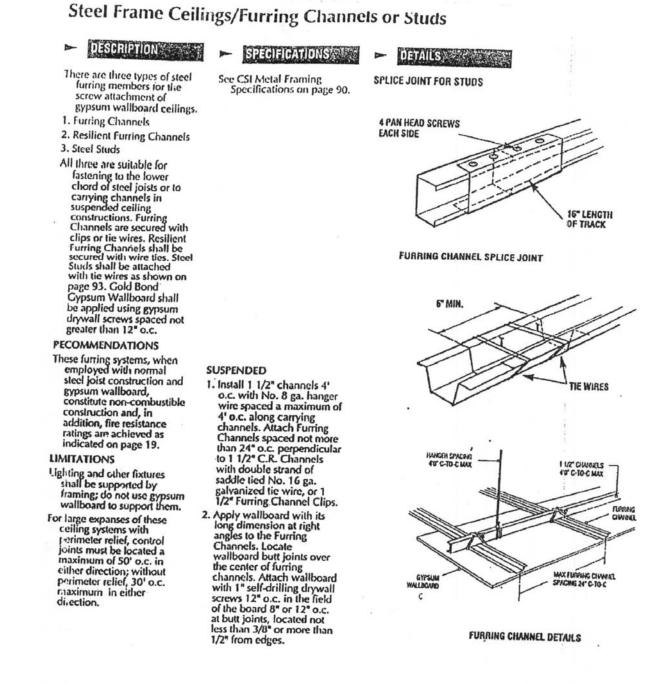



DRYWALL CEILING AND FRAMING DETAIL

TO SCALE

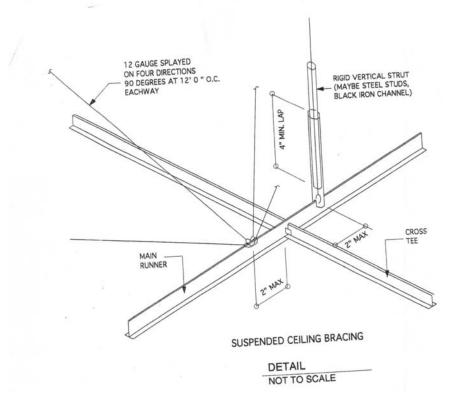


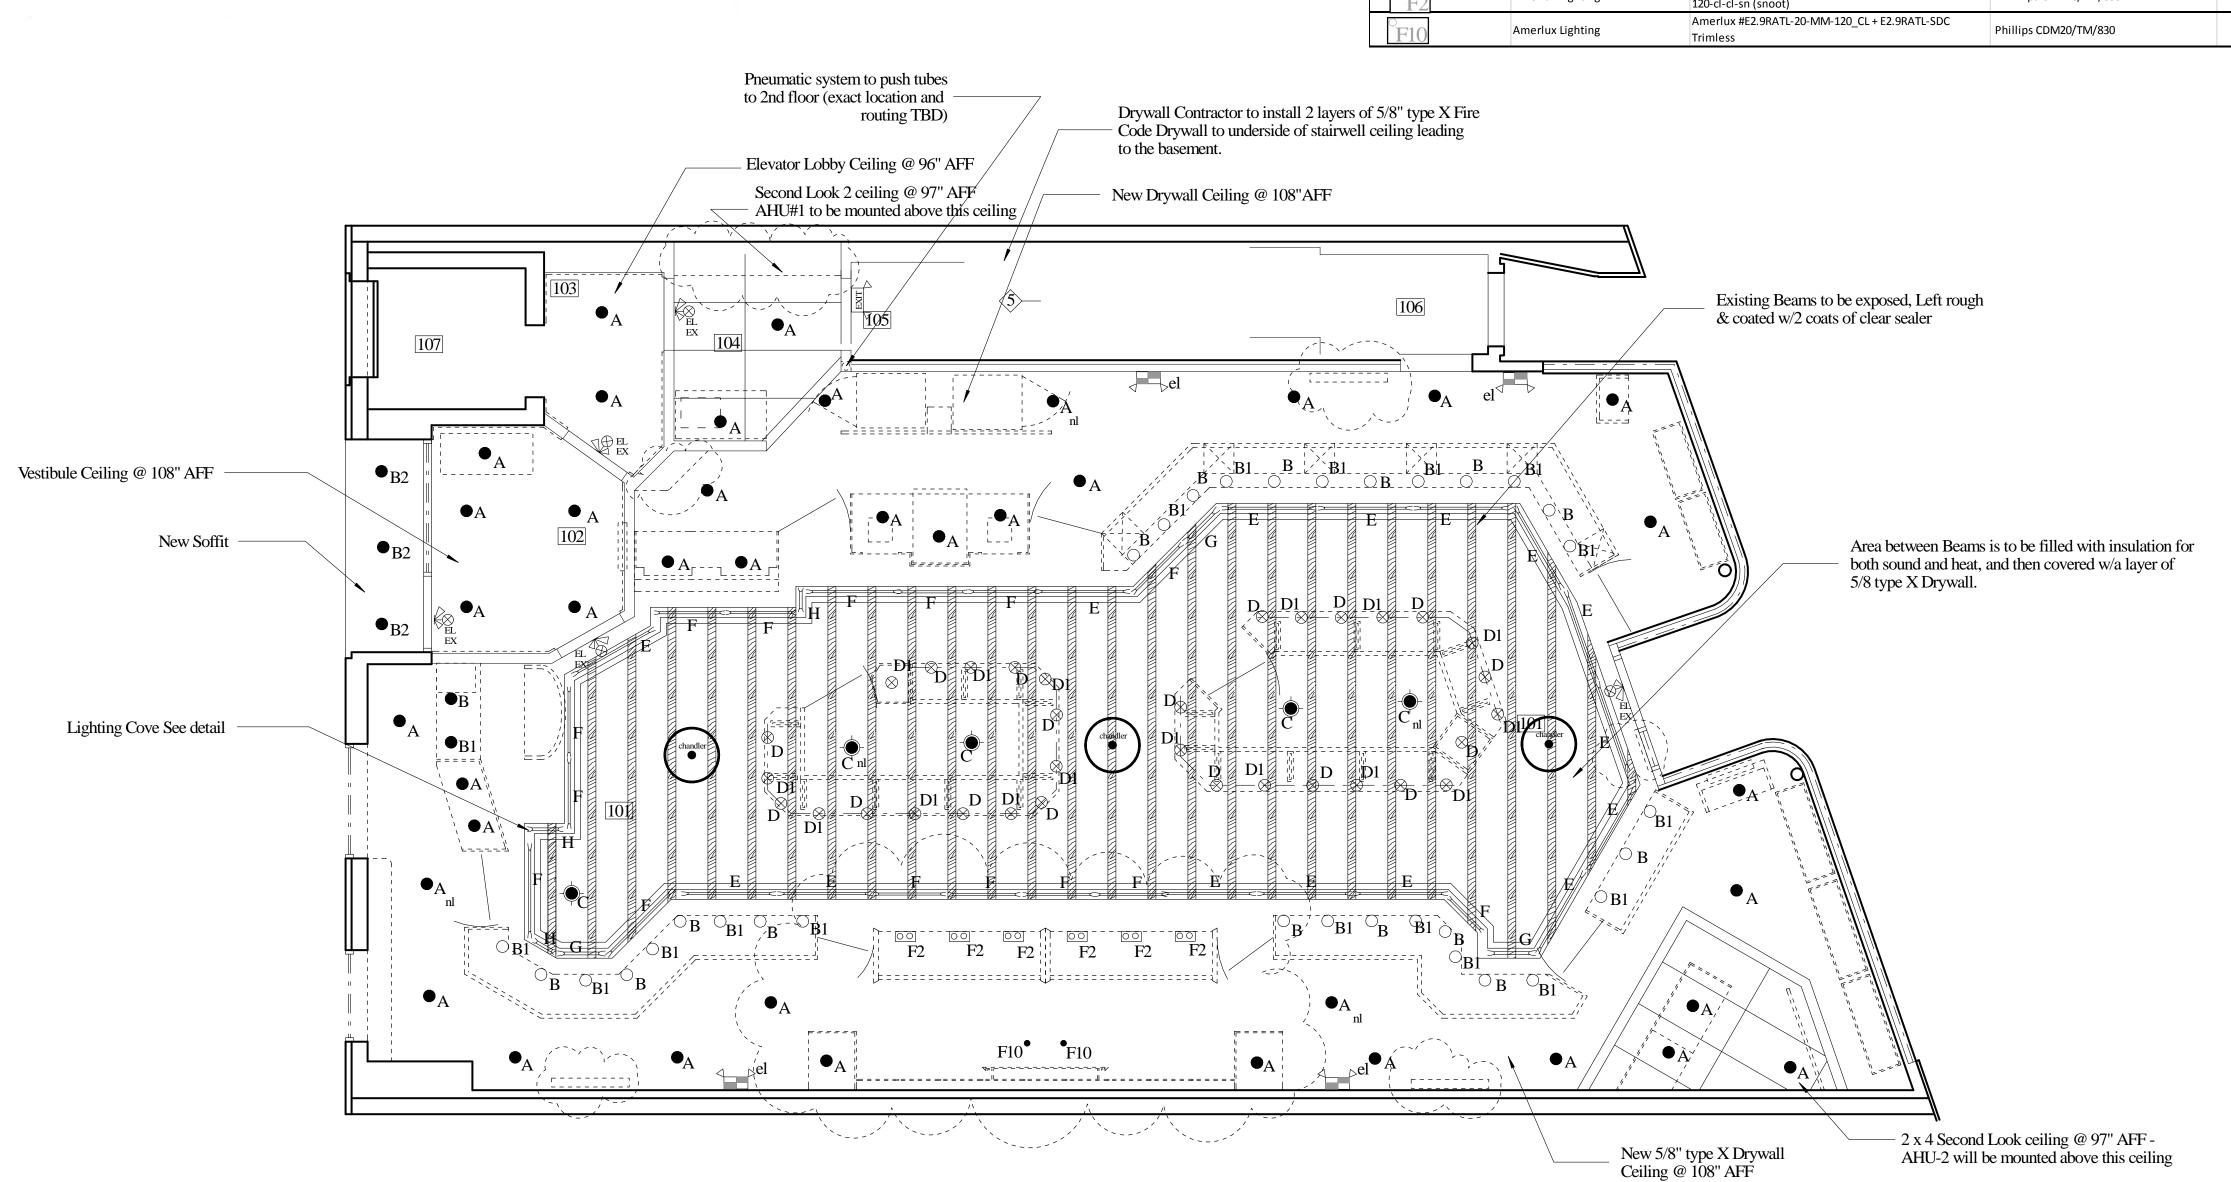


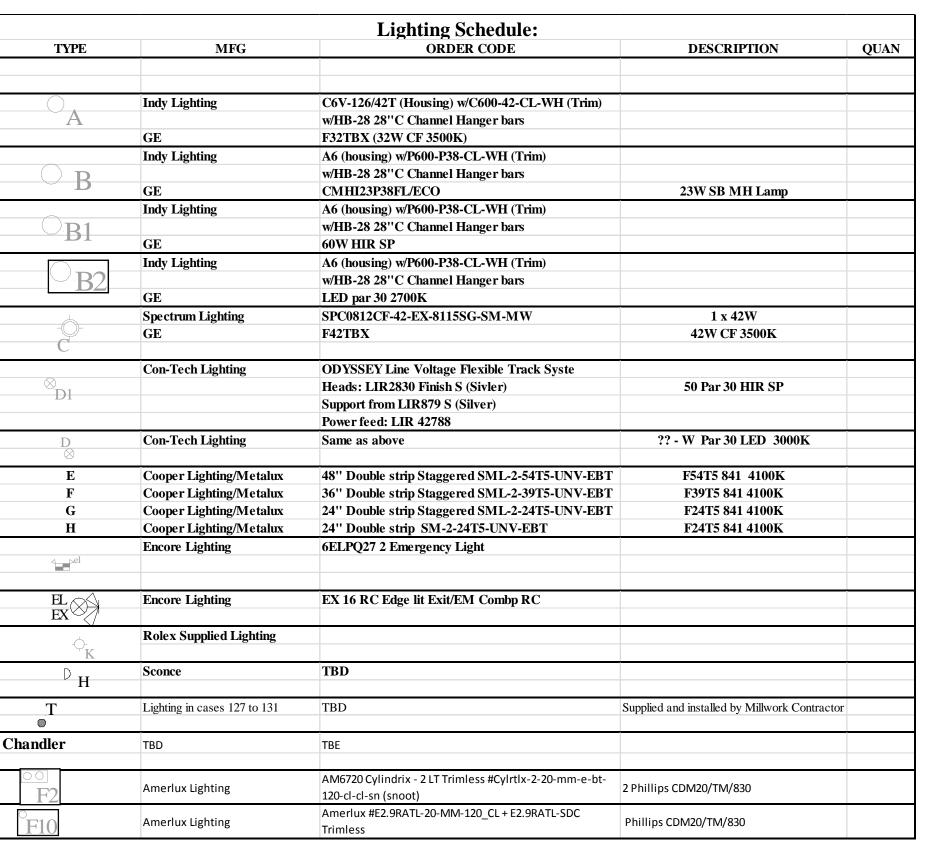


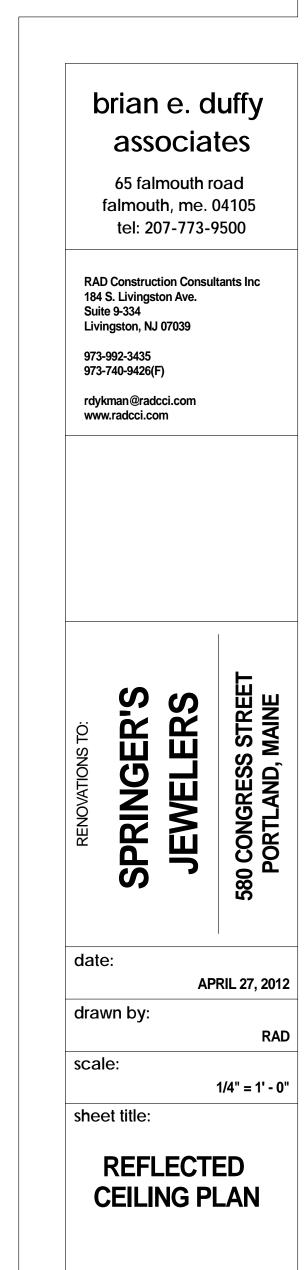



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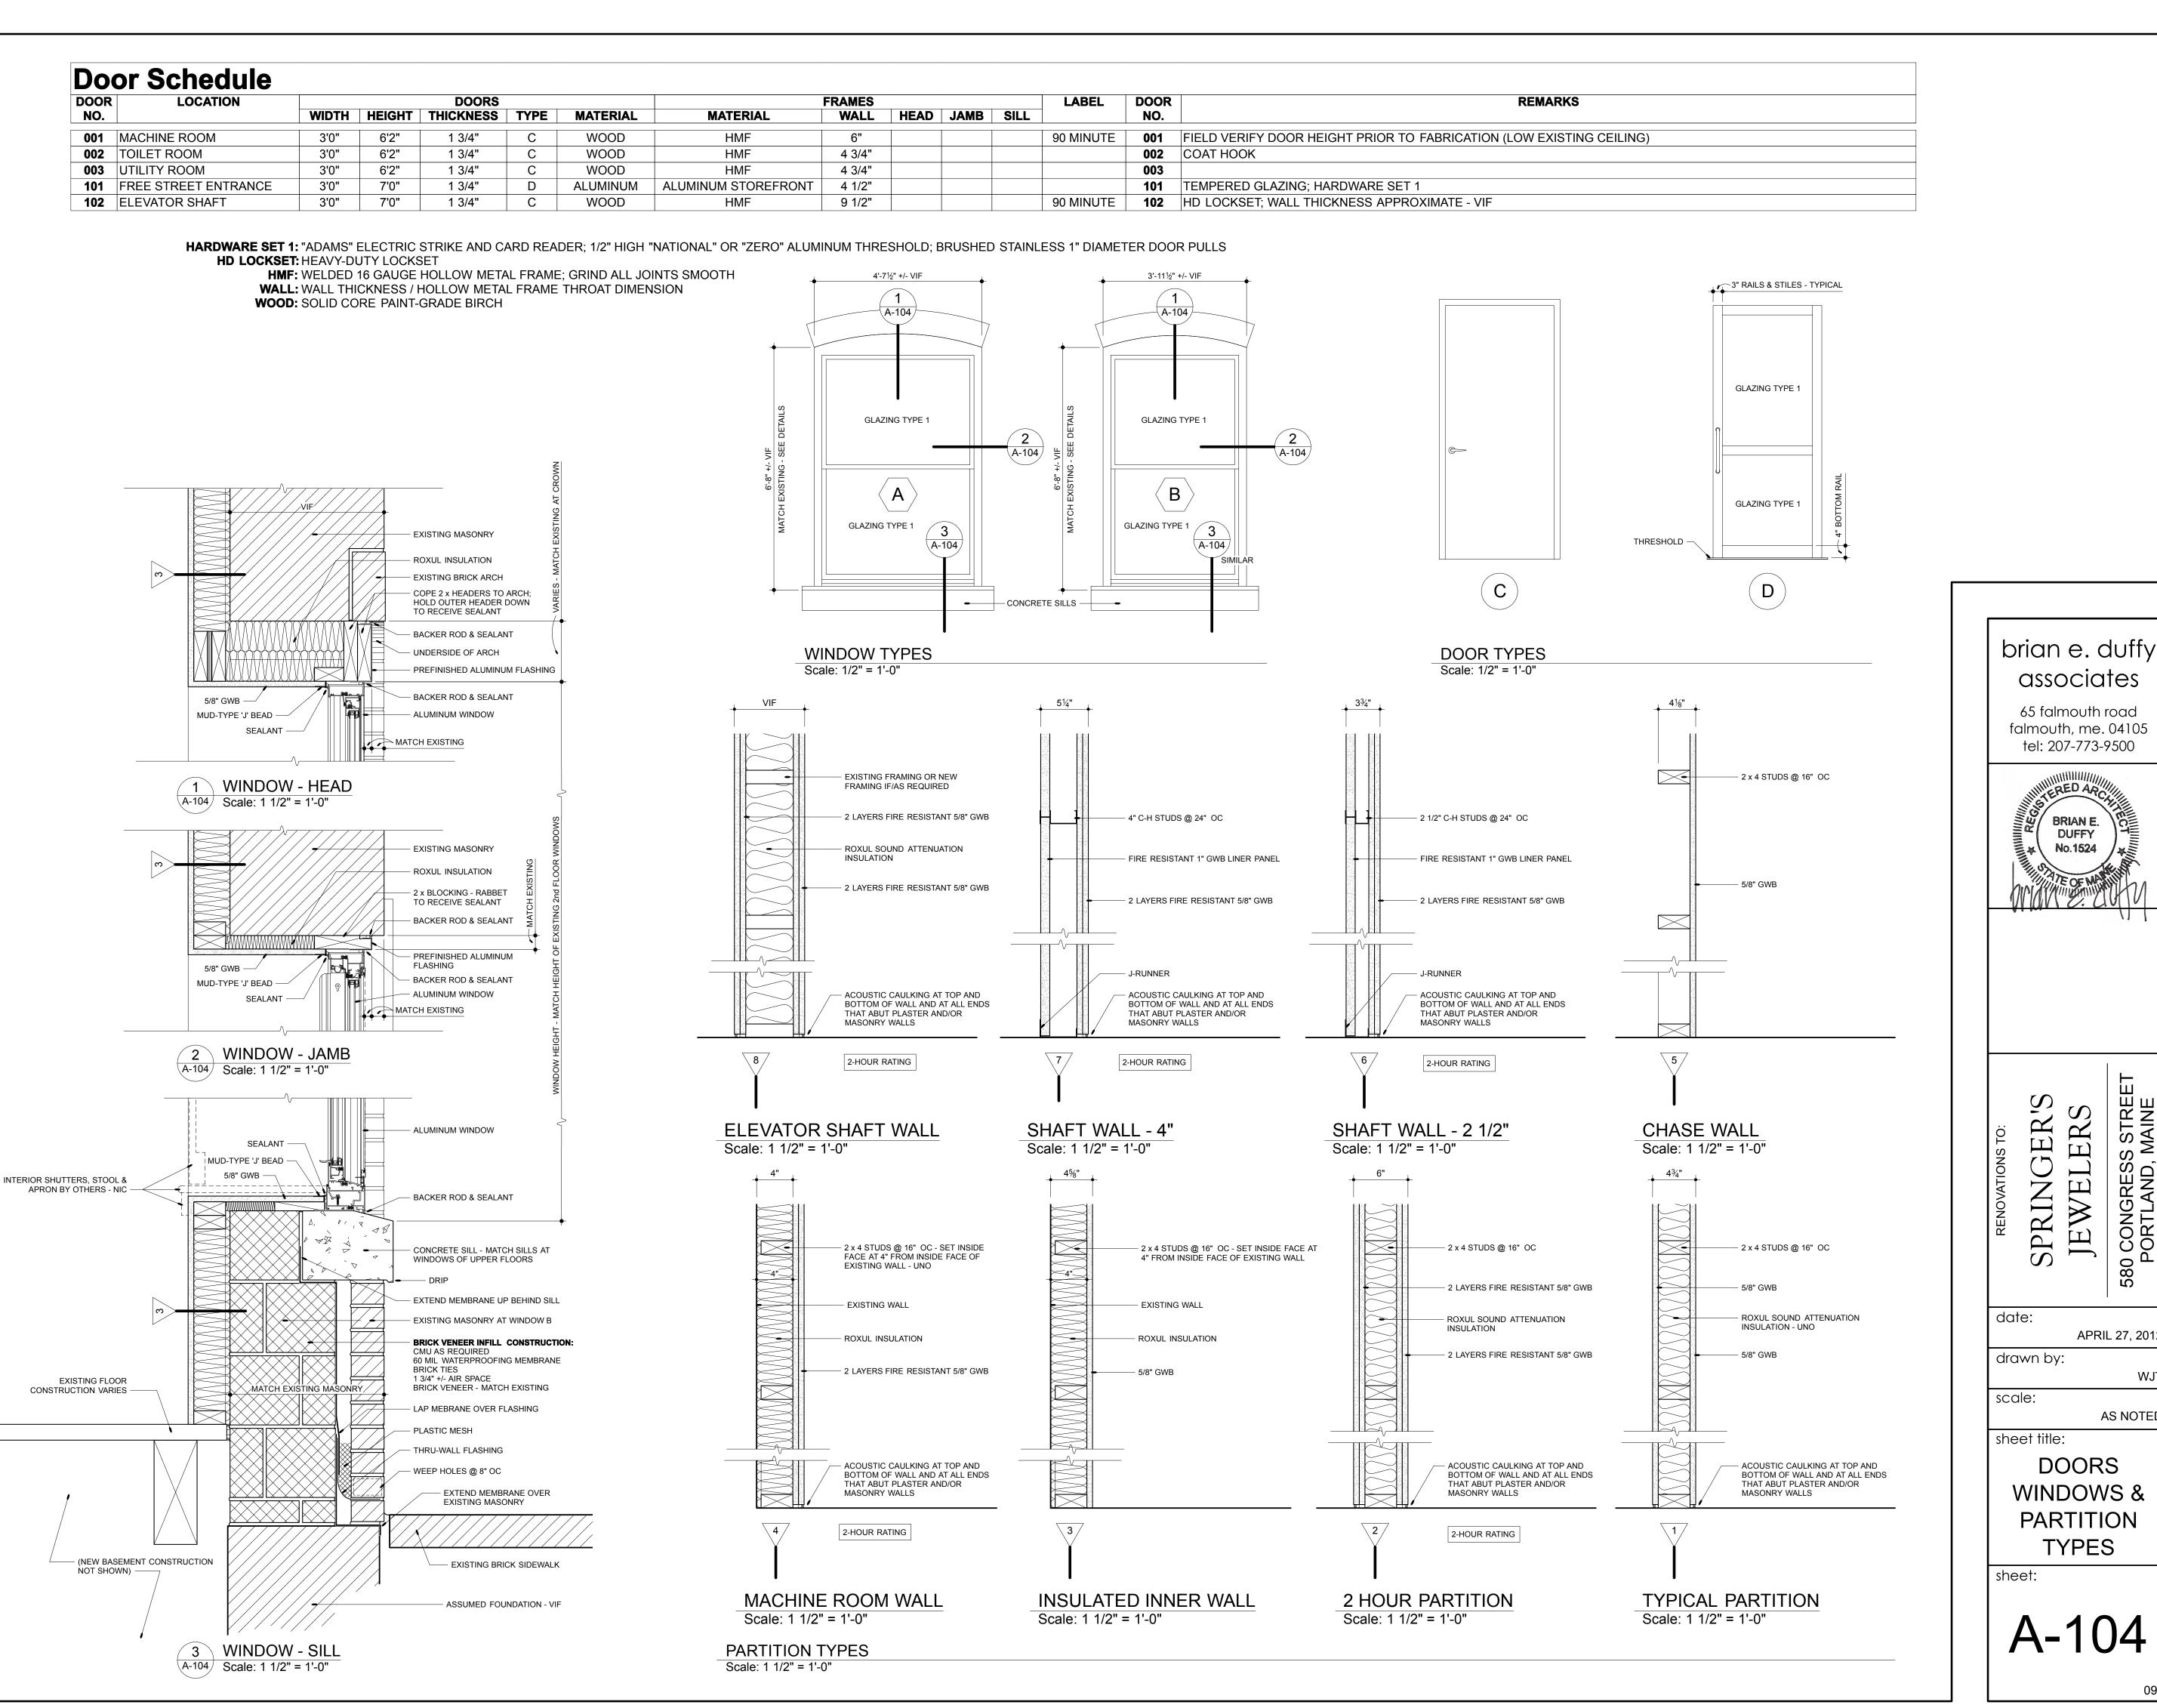


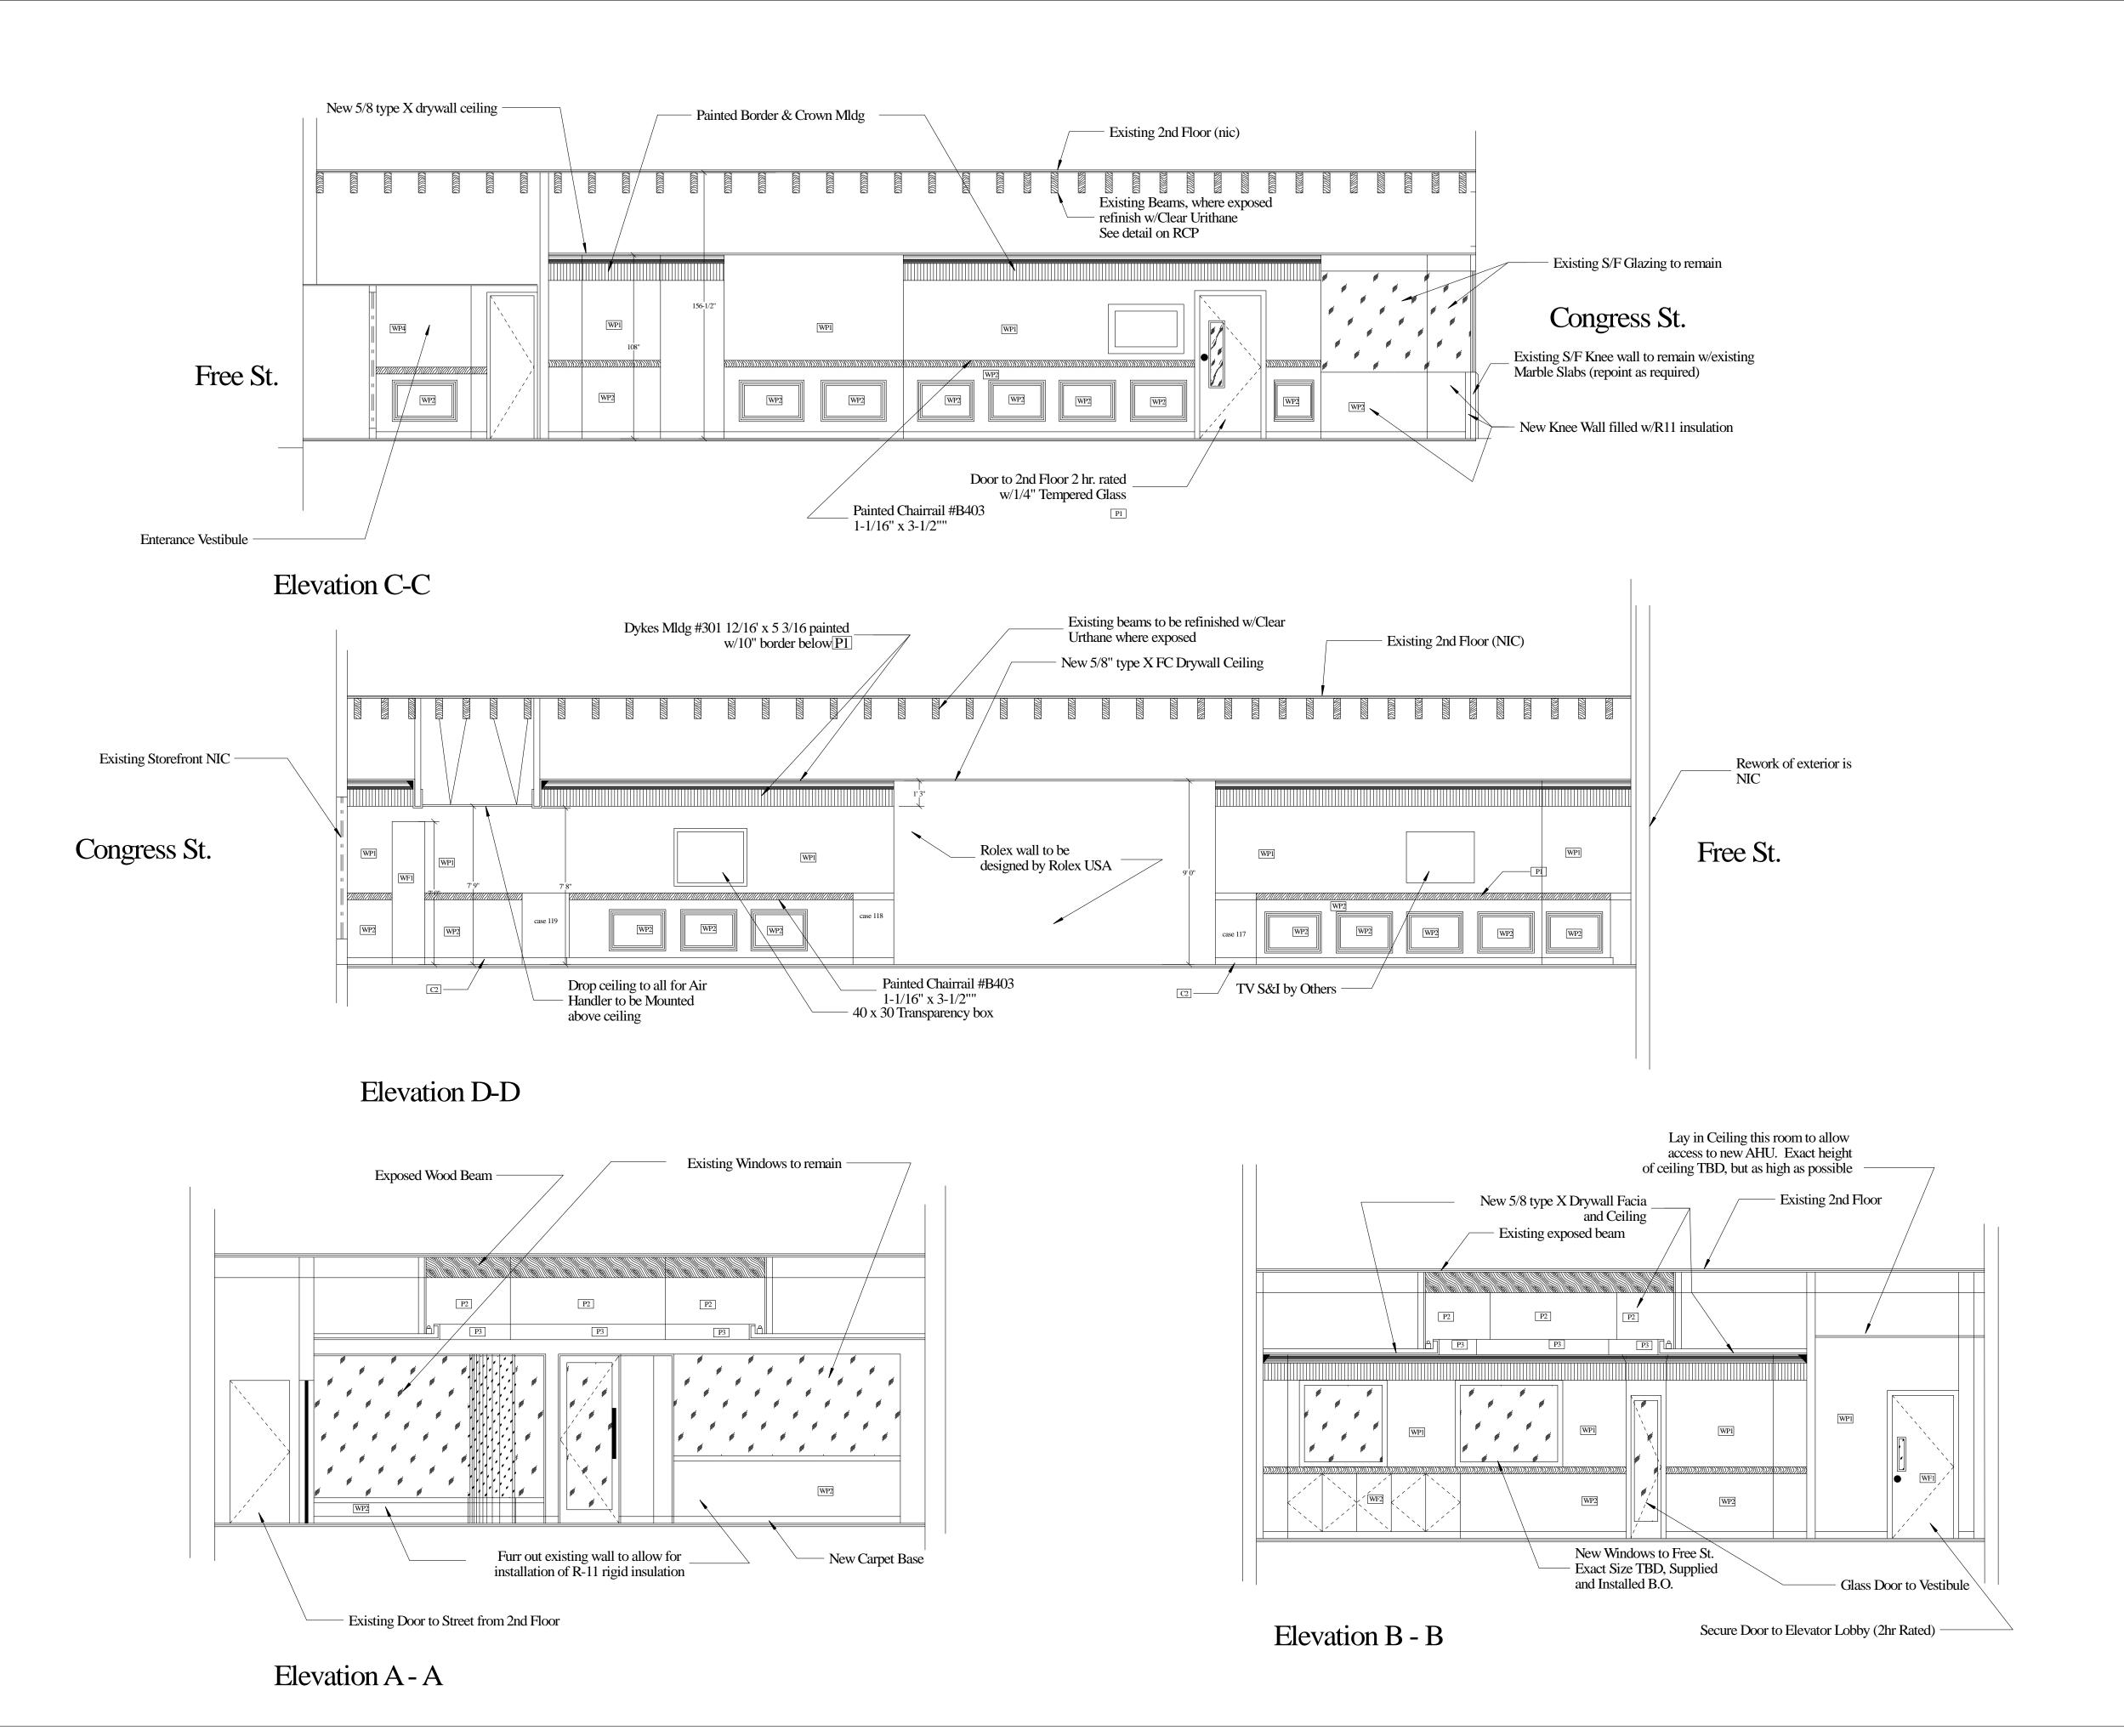

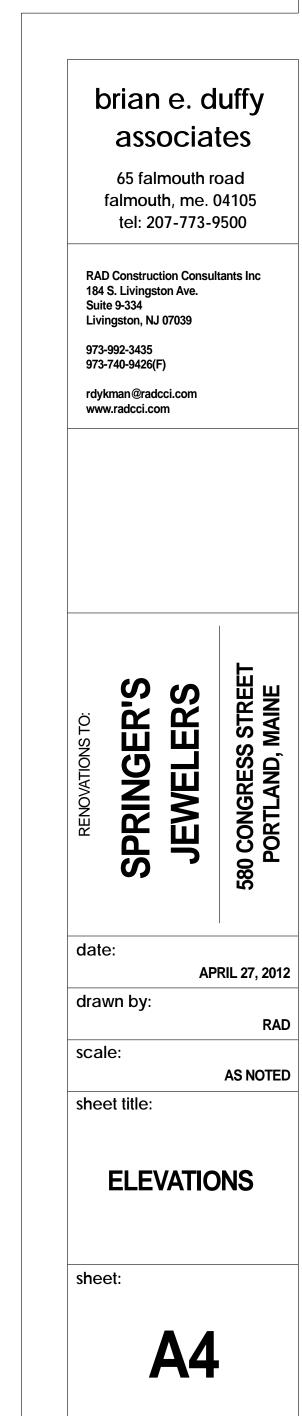

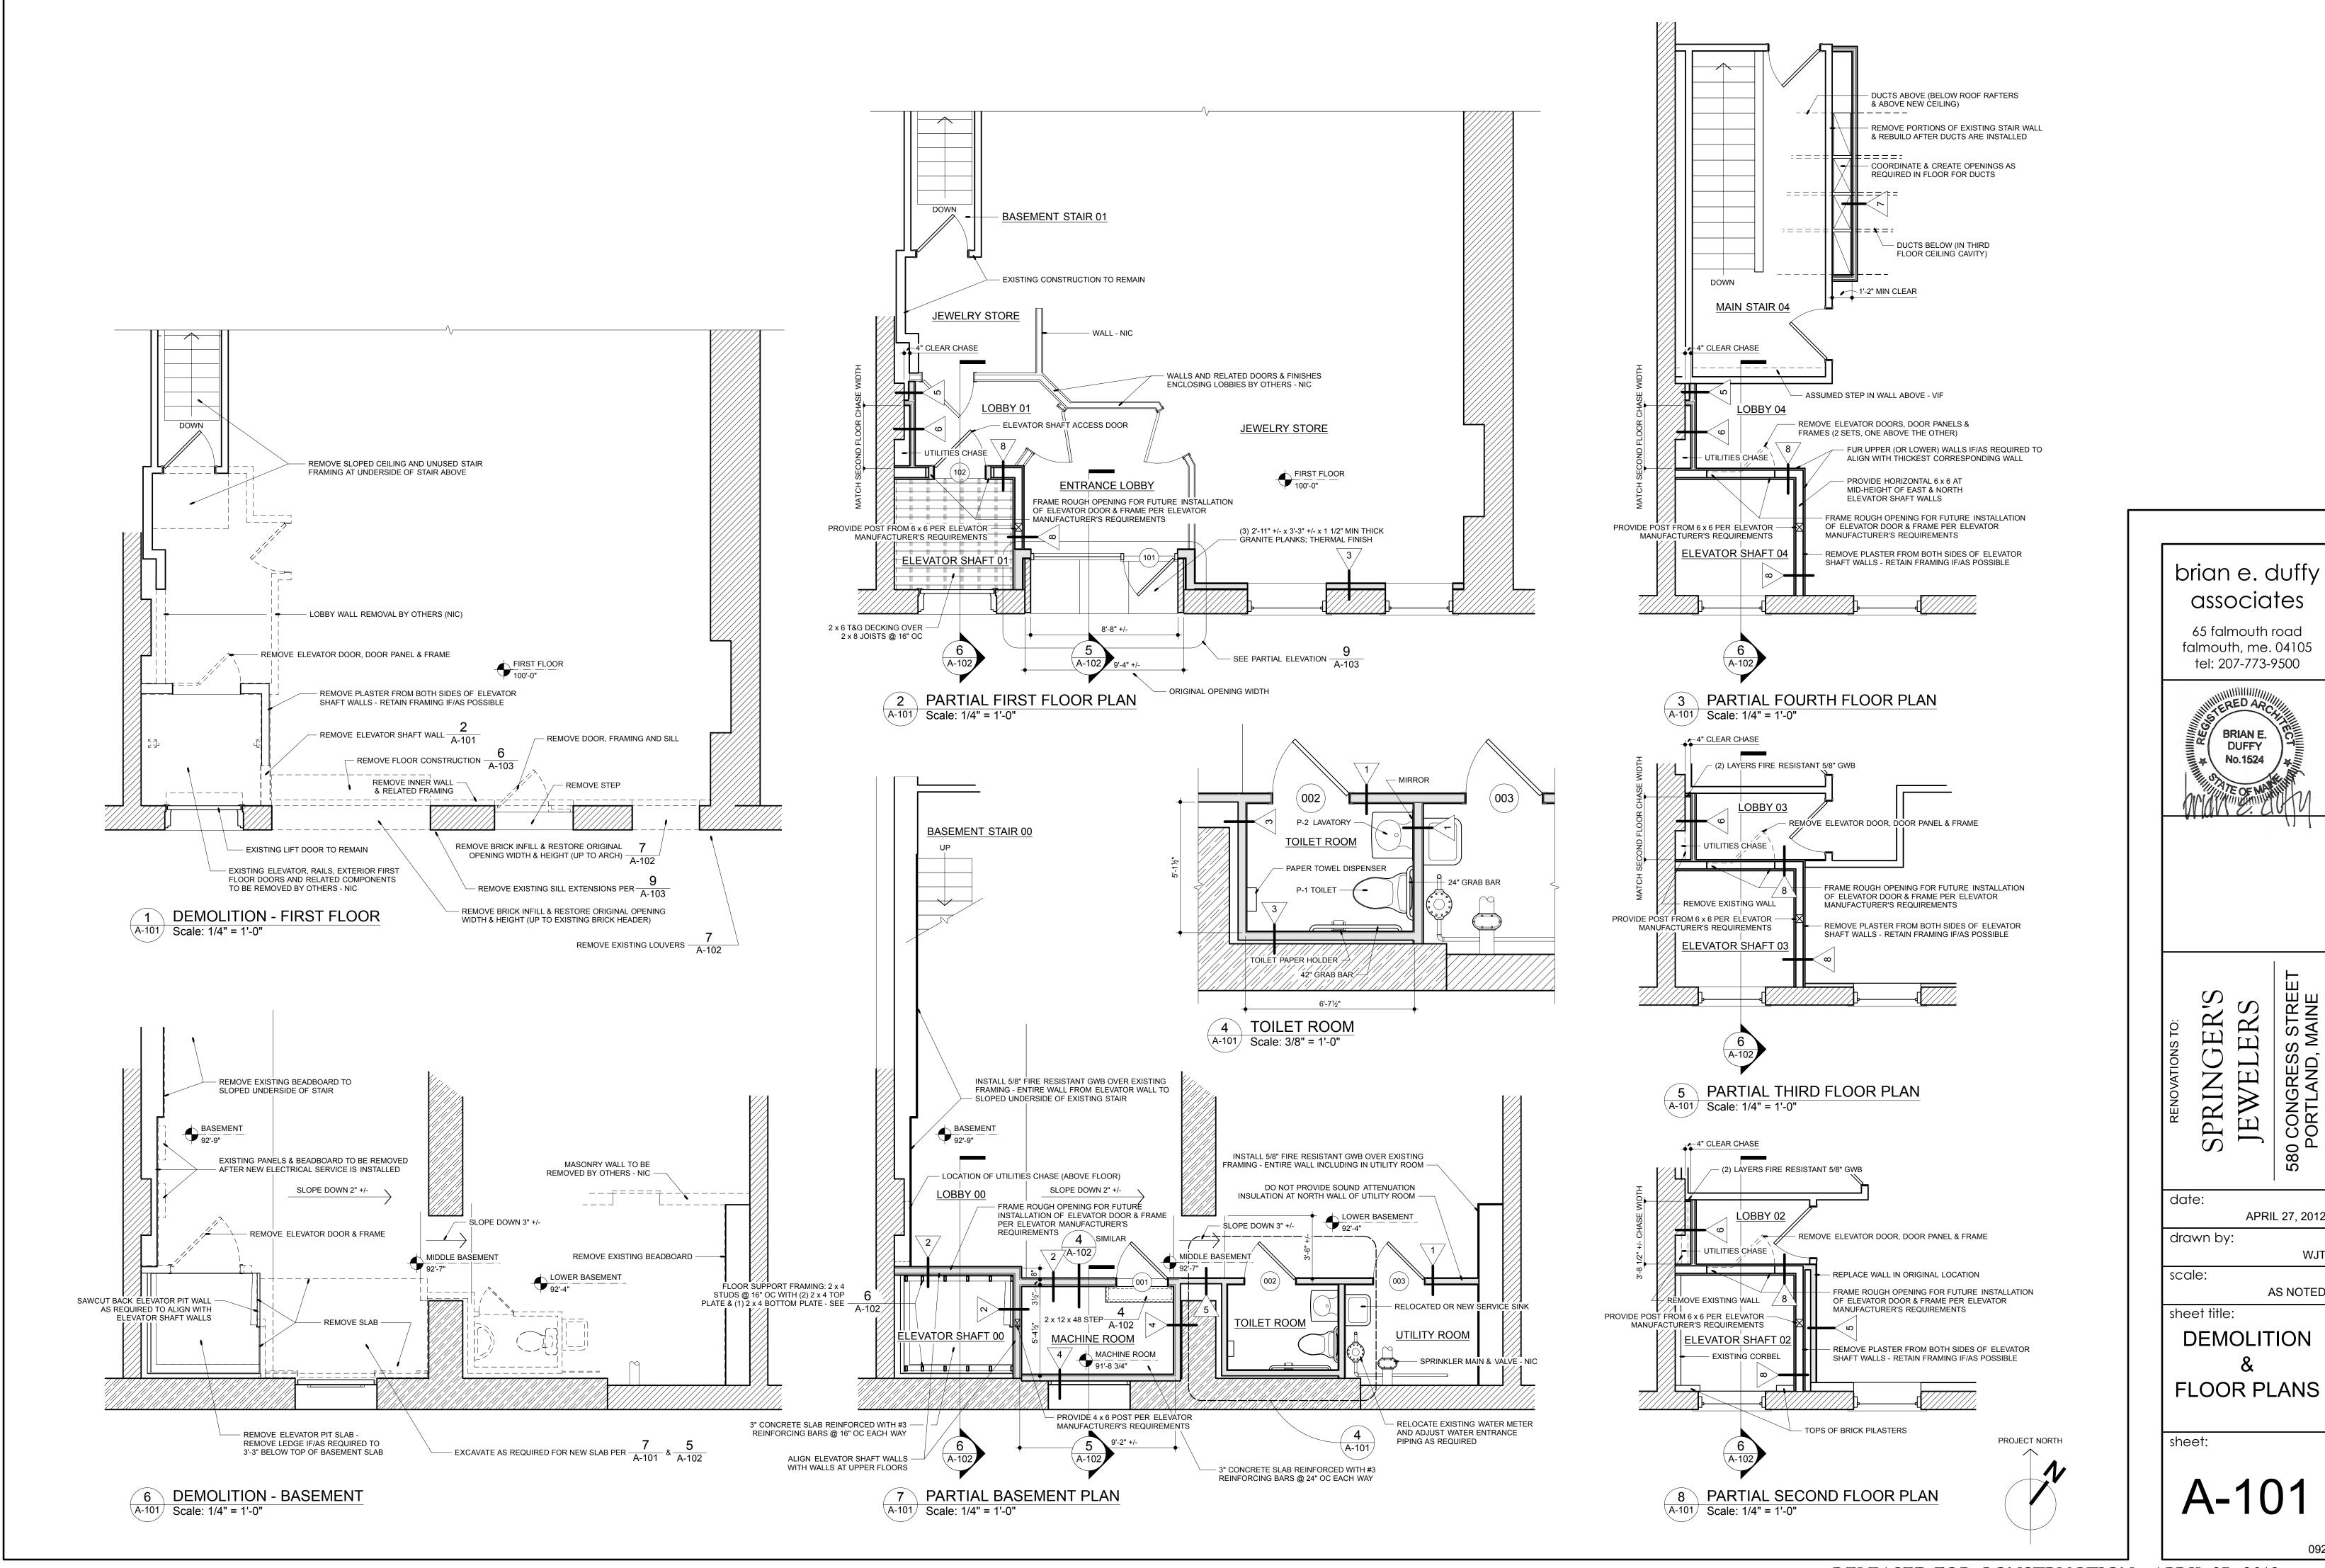
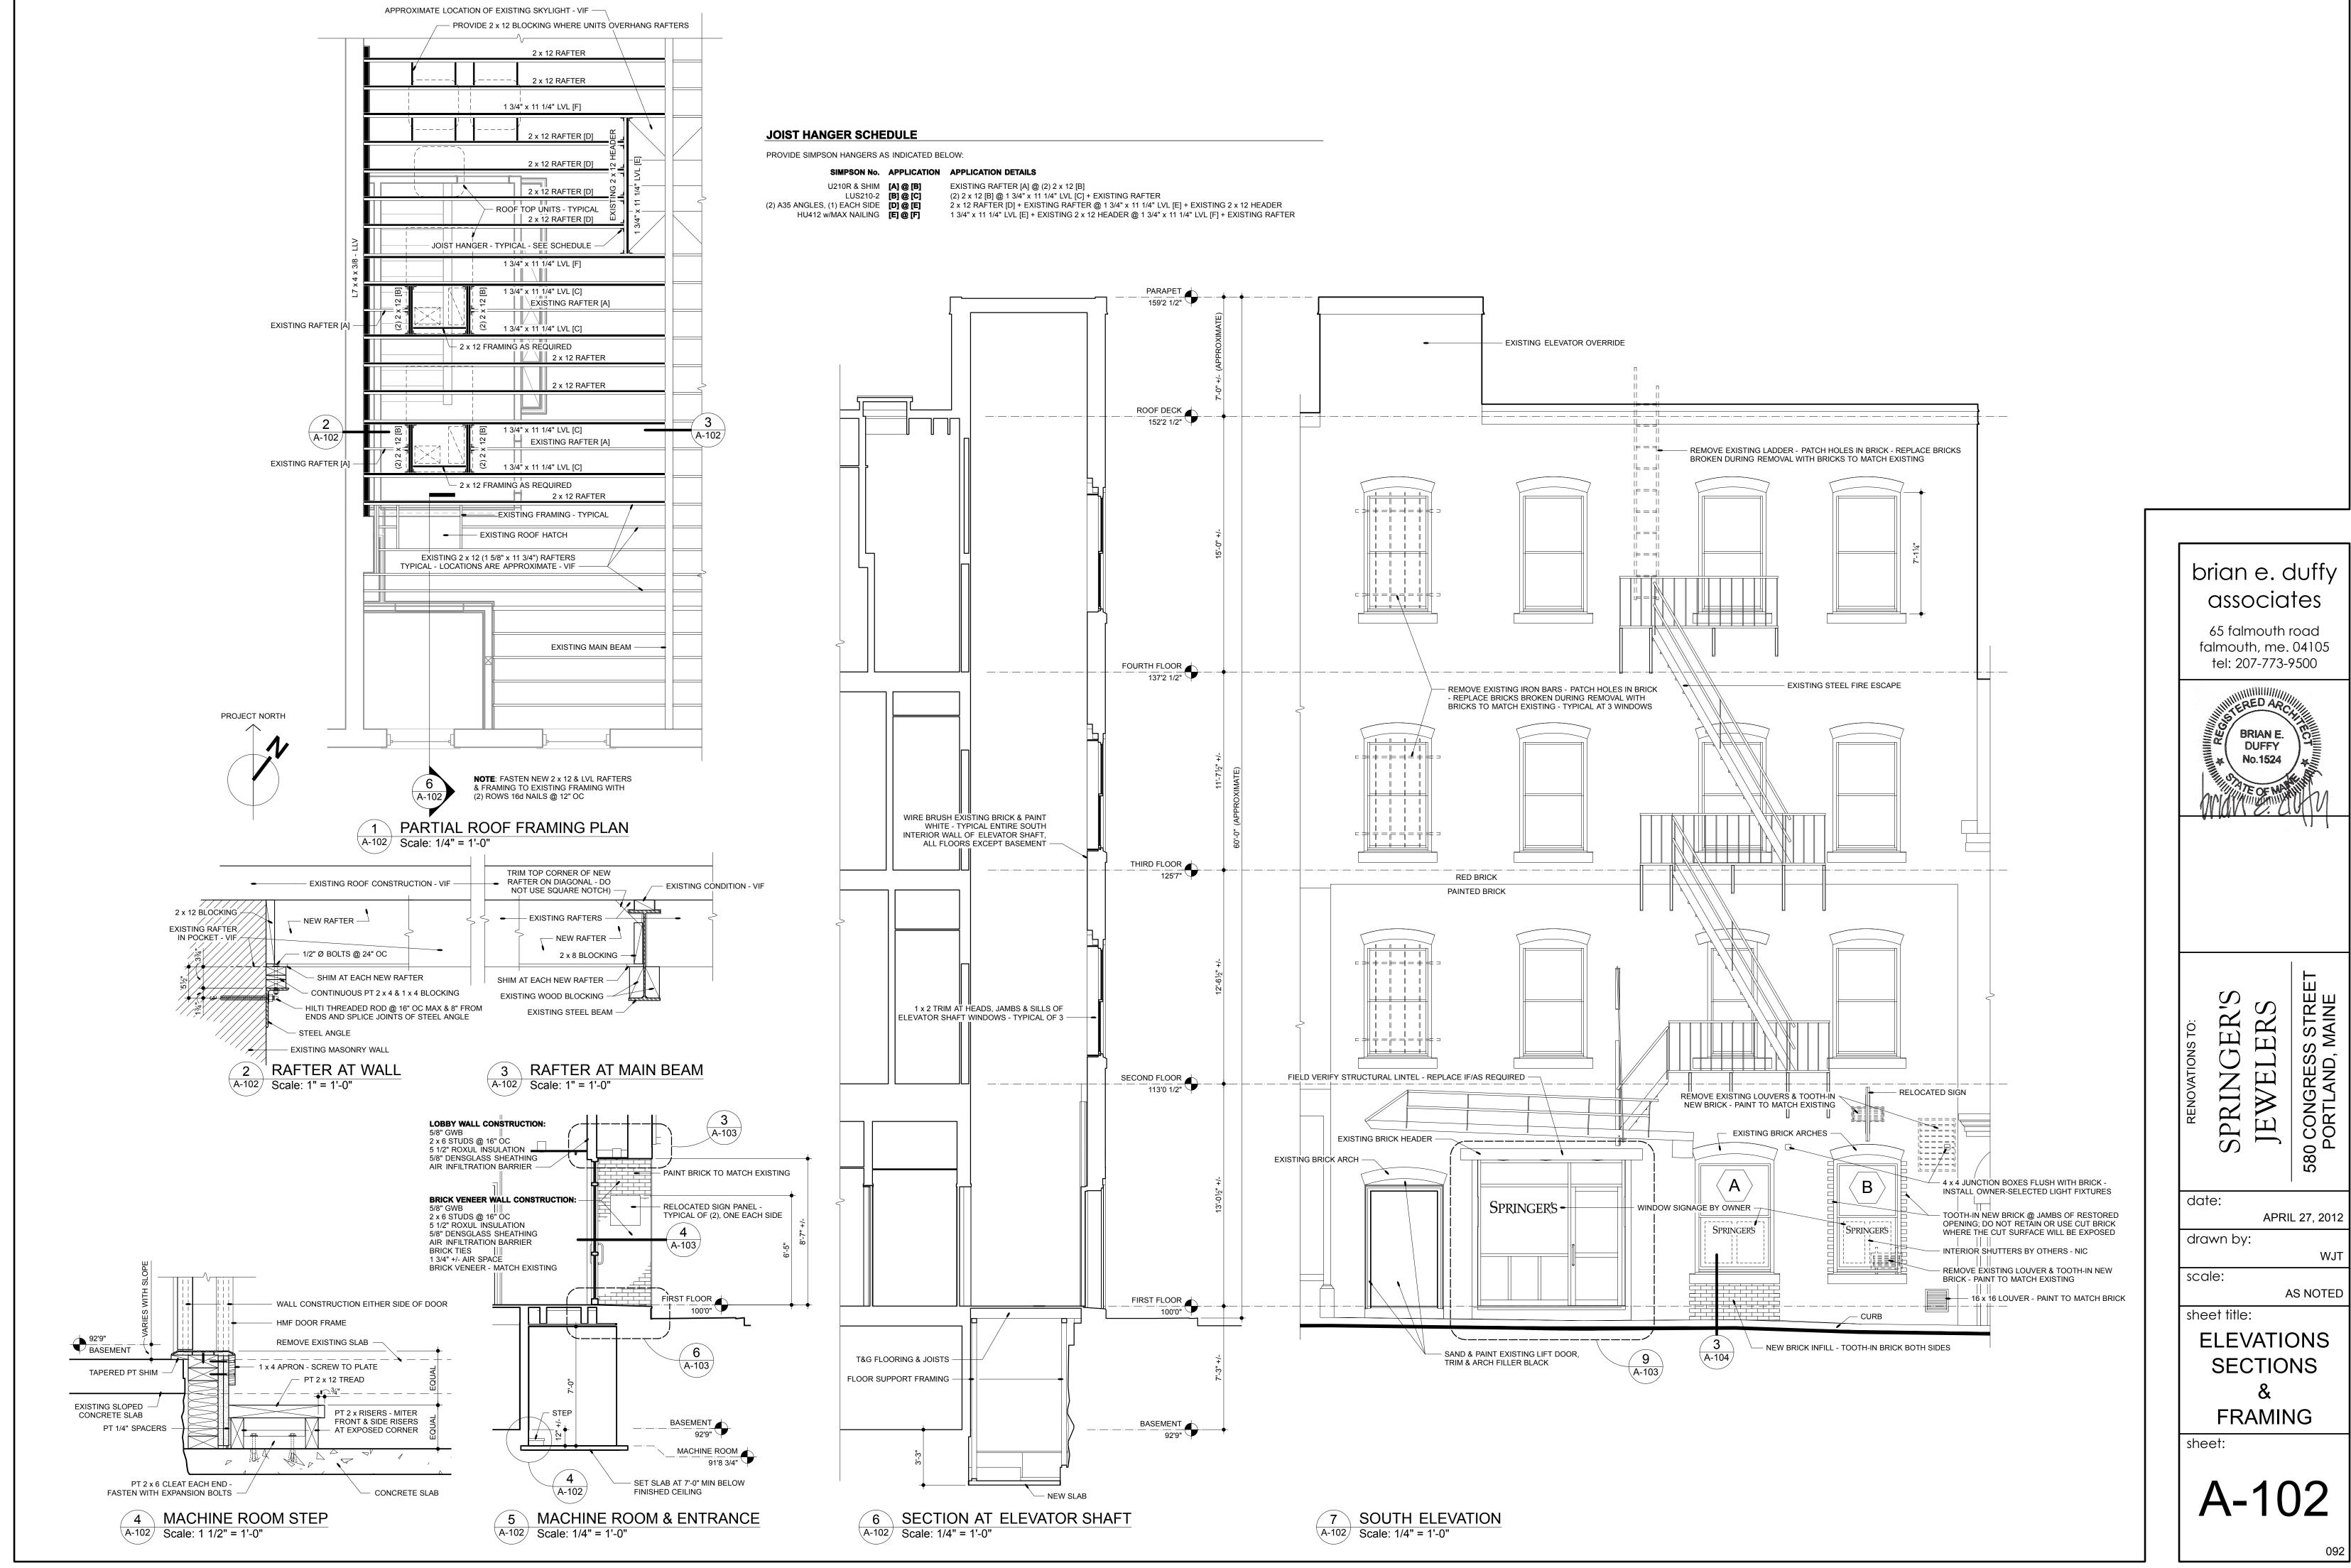
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APRIL 27, 2012

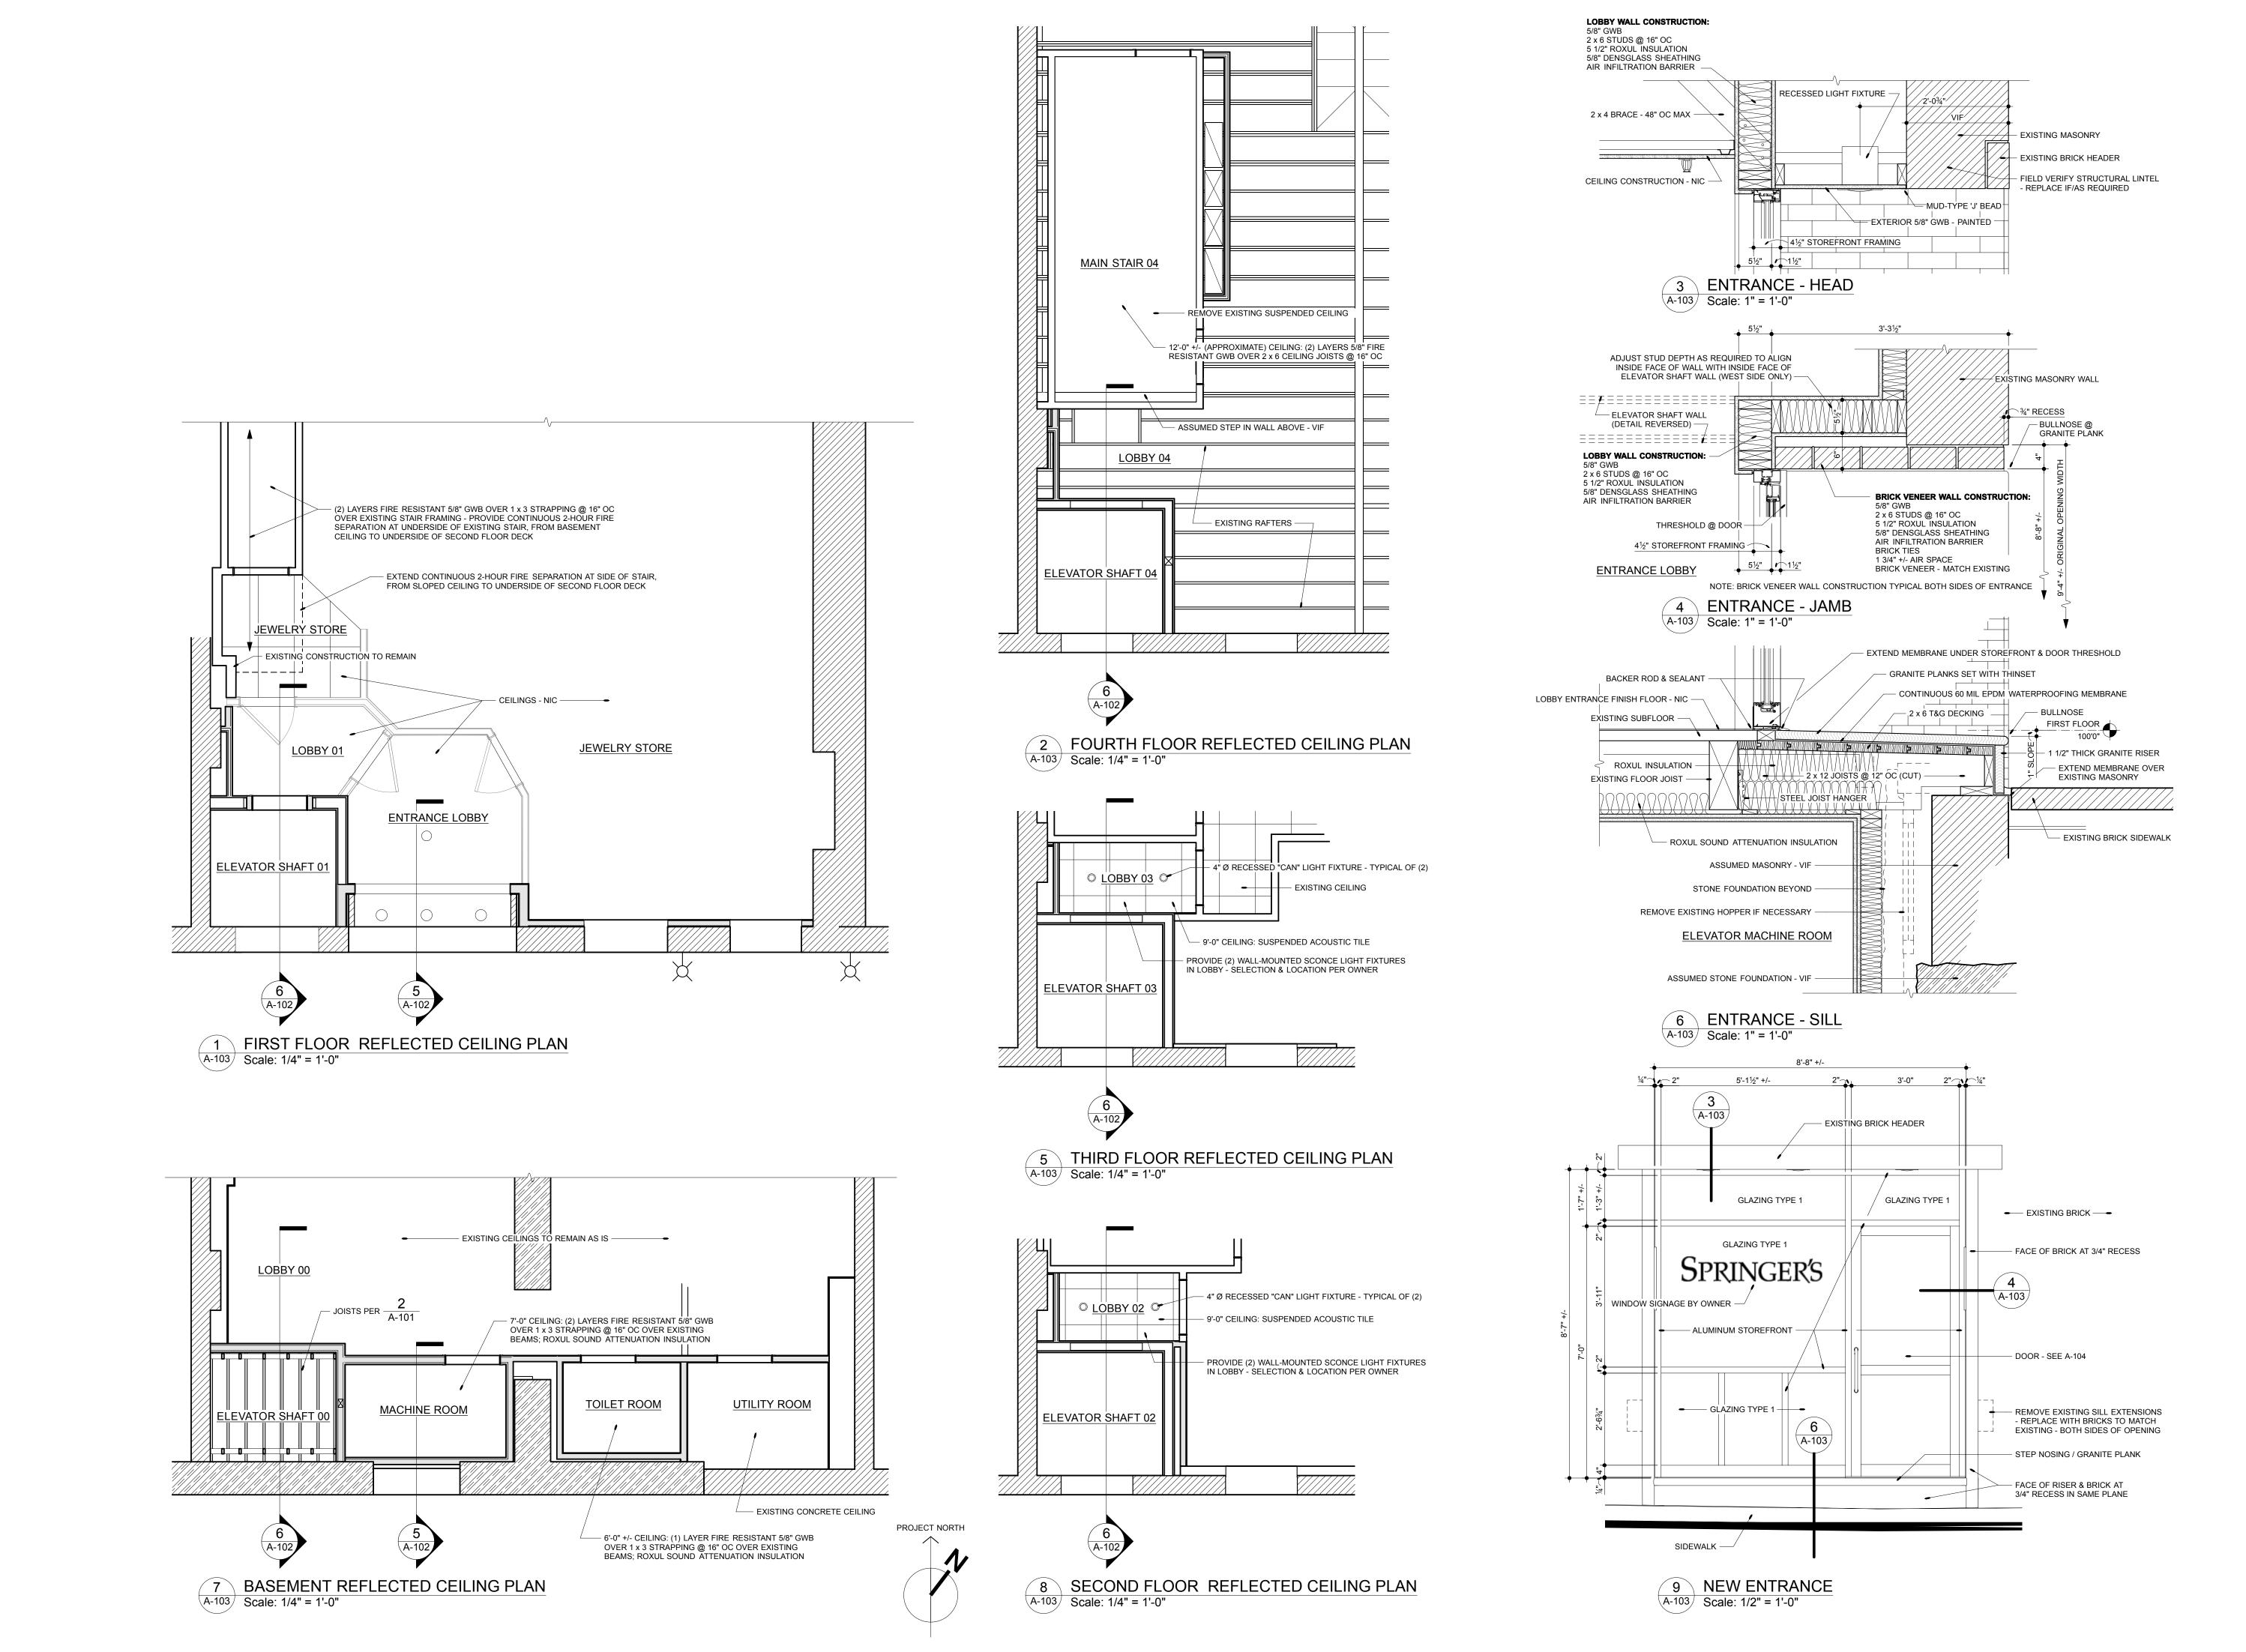
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Εl	ECTRICAL SYMBOLS & INSTRUCTIONS
XXX	ROOM NUMBER.
X	KEYED NOTE, SEE NOTE OF SAME LETTER ON SHEET.
X	DETAIL DESIGNATION: UPPER FIELD IS DETAIL IDENTIFIER, LOWER FIELD IS SHEET NUMBER WHERE DETAIL IS SHOWN.
[]	INDICATES EXISTING DEVICE OR ITEM.
	BRANCH CIRCUIT WIRING CONCEALED IN CEILING OR WALL.
	BRANCH CIRCUIT WIRING CONCEALED IN FLOOR.
	EXPOSED WIRING.
	MULTI-CONDUCTOR BRANCH CIRCUIT, NO. OF HASHMARKS IS NO. OF CIRCUIT CONDUCTORS, WITHOUT HASHMARKS TWO CIRCUIT CONDUCTORS. ALL CIRCUITS TO INCLUDE SEPARATE GREEN GROUNDING CONDUCTOR. FOR FLUORESCENT LIGHTING CIRCUITS, INCREASE NEUTRAL CONDUCTOR 1 SIZE OVER PHASE CONDUCTORS (#10 AWG FOR 20A CIRCUIT)
-\ \-	HOMERUN TO CIRCUIT AND PANELBOARD INDICATED, NO. OF ARROWS IS NO. OF PHASE WIRES, NO. OF HASHMARKS INDICATE NO. OF CIRCUIT CONDUCTORS.
─	DIRECTIVE ARROW.
	CIRCUIT BREAKER.
<u>-</u>	GROUND.
J D P	JUNCTION BOX, SPLICE BOX AND PULL BOX.
X a	FLUORESCENT LIGHTING FIXTURE & OUTLET, UPPER CASE LETTER TYPE, LOWER CASE LETTER IS CONTROL GROUP, RECTANGLES INDICATE NO. OF SECTIONS. SEE LIGHTING FIXTURE SCHEDULE FOR TYPES AND MOUNTING.
°⊗	CEILING MOUNTED LIGHTING FIXTURE, LETTER SUBSCRIPTS AS ABOVE.
·⊗°	WALL MOUNTED LIGHTING FIXTURE, LETTER SUBSCRIPTS AS ABOVE.
$\otimes \otimes$	WALL MOUNT AND CEILING MOUNT EXIT LIGHTS. SEE FIXTURE SCHEDULE FOR TYPE(S).
❖	EMERGENCY LIGHTING BATTERY UNIT WITH LIGHTING HEADS AS NOTED. SEE FIXTURE SCHEDULE FOR TYPE(S).
S Sp	SPST FLUSH WALL SWITCH 4'-0" UP ON CENTER ADJUSTED TO MINIMUM CUT OF BLOCK OR TILE, LOWER CASE LETTER IS CONTROL GROUP, WITH "H" 6' ABOVE FLOOR, WITH "P" PILOT LIGHT.
~~~ ~~~	120/208 VOLT PANELBOARD, FLUSH MOUNTED AND SURFACE MOUNTED.
	UNIVERSAL PANEL OR CABINET, FLUSH MOUNTED AND SURFACE MOUNTED.
Ō.	MOTOR OF SIZE SHOWN, WITH "F" FRACTIONAL HORSEPOWER MOTOR BELOW 1/20 HP OR 100 WATTS.
M	UTILITY POWER METER. MOUNT 5'-0" UP.
Ф	DUPLEX GROUNDED POLARIZED 120 VOLT THREE-WRE CONVENIENCE OUTLET 1'-6" UP VERTICALLY, WITH "U" 4'-0" AFF OR 0'-6" ABOVE COUNTER, ADJUST TO MINIMUM CUT OF BLOCK OR TILE, LETTER IS CIRCUIT GROUP, WITH "WP" WEATHERPROOF, WITH "G" FOR GROUND FAULT PROTECTED BY GFCI RECEPTACLE OR CIRCUIT BREAKER LOCATED UPSTREAM, WITH "H" MOUNT 7'-6" UP OR AS NOTED.
•	GROUND FAULT CIRCUIT INTERRUPTING (GFCI) DUPLEX RECEPTACLE, 120 VOLT THREE-WIRE 20 AMP, SUBSCRIPTS AND MOUNTING AS ABOVE.
•	EQUIPMENT CONNECTION.
급	SINGLE THROW HEAVY DUTY FUSED DISCONNECT SWITCH, NO. OF POLES AND SIZE AS REQUIRED FOR THE LOAD, "NF" NON FUSED, "WP" WEATHERPROOF.
▼ 2 W P	TELEPHONE OUTLET 1'-6" AFF, QUANTITY AS NOTED, WITH "W" 4'-0" AFF, WITH "P" FOR PAY TELEPHONE 4'-0" AFF, WITH "U" 0'-6" ABOVE COUNTER.
$\nabla \stackrel{2}{\nabla}$	COMPUTER DATA OUTLET 1'-6" AFF, WITH "U" 0'-6" ABOVE COUNTER, QUANTITY AS NOTED.
▼ ▼	COMBINATION TELEPHONE AND COMPUTER DATA OUTLET 1'-6" AFF, WITH "U" 0'-6" ABOVE COUNTER, QUANTITY AS NOTED.
[FACP]	FIRE ALARM CONTROL PANEL.
\$7 H	FIRE ALARM AUDIO/VISUAL ALARM, 6'-8" AFF.
\$7	FIRE ALARM VISUAL ALARM, 6'-8" AFF.
F	FIRE ALARM MANUAL PULL STATION 4'-0" AFF.
S	FIRE ALARM SMOKE DETECTOR, CEILING MOUNTED UNLESS NOTED OTHERWISE.
D _{MAG}	MAGNETIC DOOR STRIKE.

A AFF AFG ATS BATT BKR BLDG C,c CB CKT CLG CM.P. CT DISTRIB DN DWG E EC ER ELECT	AMPERES ABOVE FINISHED FLOOR ABOVE FINISHED GRADE AUTOMATIC TRANSFER SWITCH BATTERY BREAKER BUILDING CONDUIT, CONDUCTOR CIRCUIT BREAKER CIRCUIT CEILING CENTRAL MAINE POWER CO. CURRENT TRANSFORMER DISTRIBUTION DOWN DRAWING EXISTING ELECTRICAL CONTRACTOR EXISTING REPLACE ELECTRIC, ELECTRICAL	ELEV EMERG EMT EQUIP EXIST'G EXT FA FACP FIN FLR GND HP J-BOX KVA KW LGT LTG MAX MIN N	ABBREVIATIONS ELEVATION, ELEVATOR EMERGENCY ELECTRICAL METALLIC TUBING EQUIPMENT EXISTING EXTERIOR FIRE ALARM FIRE ALARM FIRE ALARM CONTROL PANEL FINISH, FINISHED FLOOR GROUND HORSEPOWER, HEAT PUMP JUNCTION BOX KILO VOLT AMPS KILOWATT(S) LIGHT LIGHTING MAXIMUM MINIMUM NEW	NIC NID NO OC PNL PVC PWR RECEP RLSC SW TEL TRANS TYP UG V W WM WP	NOT IN CONTRACT NETWORK INTERFACE DEMARCATIONUMBER ON CENTER PANEL, PANEL BOARD POLYVINYL CHLORIDE POWER REMOVE RECEPTACLE RELOCATE RIGID STEEL CONDUIT SWITCH TELEPHONE TRANSFORMER TYPICAL UNDERGROUND VOLTS WATTS WATTS WIREMOLD WEATHERPROOF WIREWAY


TYPE	DESCRIPTION	VOLTS	VA	MOUNTING & INSTRUCTIONS	LAMPING
Α	INDY LIGHTING CAT# C6V-126/42T-C600-42-CL-WH 6" VERTICAL CFL DOWNLIGHT, OPEN CLEAR REFLECTOR, LOW IRIDESCENT SPECULAR ALZAK FINISH, WHITE FLANGE, w/#HB-28 28" C-CHANNEL BAR HANGERS (PAIR), ELECTRONIC BALLAST	120	•//	RECESS IN GWB CEILING	1-42W CF
В	INDY LIGHTING CAT# A6-P600-P38-CL-WH 6" VERTICAL PAR DOWNLIGHT, OPEN CLEAR REFLECTOR, SPECULAR ALZAK FINISH, WHITE FLANGE, w/#HB-28 28" C-CHANNEL BAR HANGERS (PAIR), ELECTRONIC BALLAST	120		RECESS IN GWB CEILING	TBD
B1	INDY LIGHTING CAT# A6-P600-P38-CL-WH, SAME AS TYPE B	120		RECESS IN GWB CEILING	TBD
B2	INDY LIGHTING CAT# A6-P600-P38-CL-WH, SAME AS TYPE B	120		RECESS IN GWB CEILING	TBD
С	SPECTRUM LIGHTING CAT# SPC0812CF-42-EX-8115SF-SM-MW 8" OPEN CYLINDER DOWNLIGHT, 1L 42W, SOFT GLOW ALZAK REFLECTOR, MATTE WHITE FINISH, ELECTRONIC BALLAST	120		SURFACE MOUNT TO GWB CEILING	1-42W CF
D/D1 TRACK	CON-TECH LIGHTING ODYSSEY LINE VOLTAGE FLEXIBLE TRACK SYSTEM, w/#LIR879 CABLE CEILING CONNECTOR AND #LIR42788 ROUND CANOPY & POWER SUPPLY CORD, INCLUDE ALL ADDITIONAL PARTS NECESSARY TO PROVIDE A COMPLETE SYSTEM	120			
D	CON-TECH LIGHTING CAT# LIR2830 TRACK HEAD, SILVER FINISH	120			TBD
D1	CON-TECH LIGHTING CAT# LIR2830 TRACK HEAD, SILVER FINISH	120			TBD
E	COOPER CAT# SML-2-54T5-UNV-EBT 4' STAGGERED STRIPLIGHT, 2L T5HO, ELECTRONIC BALLAST	120		MOUNT IN COVE	FP54/841
F	COOPER CAT# SML-2-39T5-UNV-EBT 3' STAGGERED STRIPLIGHT, 2L T5HO, ELECTRONIC BALLAST	120		MOUNT IN COVE	FP39/841
F2	AMERLUX CAT# CYLRTLX-2-20-MM-E-BT-120-CL-CL-SN MULTIPLE TRIMLESS EXTRUDED DISPLAY DOWNLIGHTS, 12 DEGREE SPOT (EACH LAMP), BLACK TEXTURE FINISH, ELECTRONIC BALLAST, w/SNOOT	120		RECESS IN GWB CEILING	2-CDM20/TM/ 830
F10	AMERLUX CAT# E2.9RATL-20-MM-120_CL + E2.94ATL-SDC	120		RECESS IN GWB CEILING	CDM20/TM/830
G	COOPER CAT# SML-2-24T5-UNV-EBT 2' STAGGERED STRIPLIGHT, 2L T5HO, ELECTRONIC BALLAST	120		MOUNT IN COVE	FP24/841
Н	COOPER CAT# SM-2-24T5-UNV-EBT 2' STRIPLIGHT, 2L T5HO, ELECTRONIC BALLAST	120		MOUNT IN COVE	FP24/841
К	LIGHTING SUPPLIED BY ROLEX				
L	SCONCE (TBD)	120		WALL MOUNT	TBD
9\\\\\\\\\\\\\\\\\\\\\\\\\\\\\\\\\\\\\	ENCORE LIGHTING CAT# CX-16-RC LED EXIT SIGN/EGRESS LIGHT COMBO UNIT, EDGELIT, RECESSED LED EGRESS DOWNLIGHTS, RECESSED STEEL HOUSING, NICAD BATTERIES, TRIM FINISH TBD	120		RECESS IN GWB CEILING	LEDS INCLUDED
₽	ENCORE LIGHTING CAT# 6ELPQ27-2 LOW PROFILE EMERGENCY EGRESS LIGHTING UNIT, 6V 27W, STEEL HOUSING, TWO HEADS, 90 MINUTE BATTERY OUTPUT, WHITE FINISH	120		WALL MOUNT 0'-6" BELOW CEILING	6V/12W PER HEAD (INCLUDED



FIRE ALARM RISER DIAGRAM

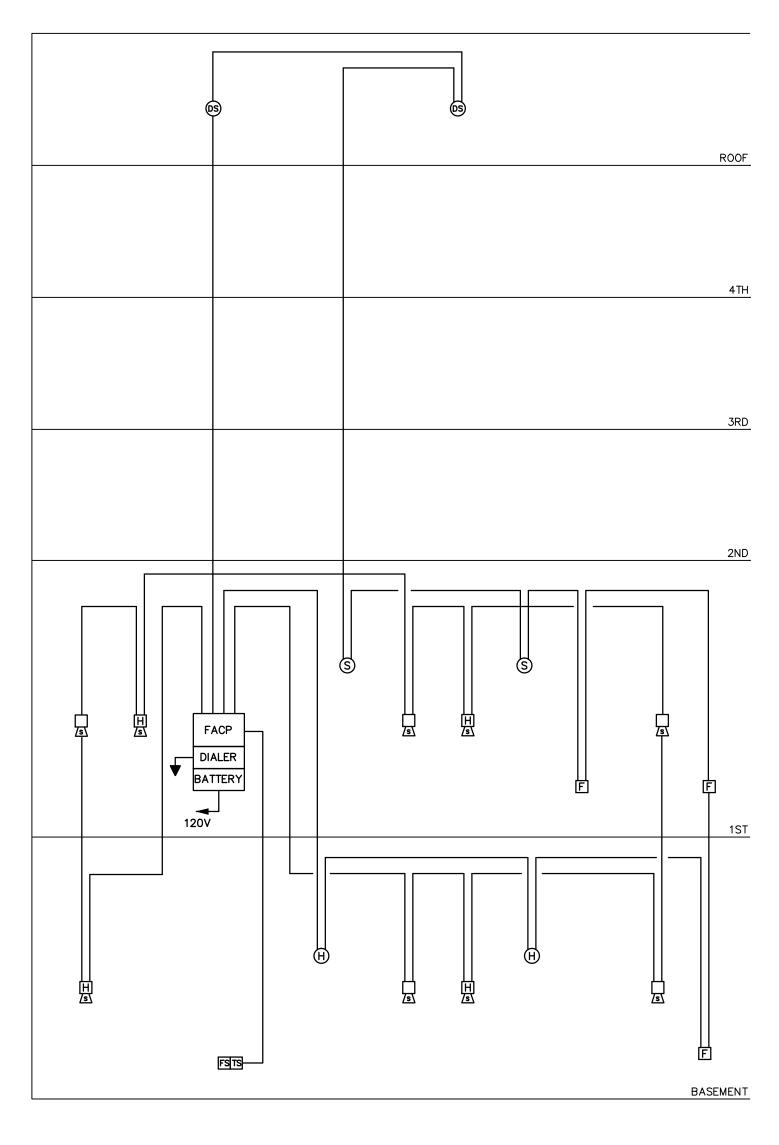FIRE ALARM NOTES:

- 1. DIAGRAM DENOTES GENERAL ARRANGEMENT OF DEVICES AND TYPICAL SCHEMATIC WIRING. SEE FLOOR PLAN DRAWINGS FOR ACTUAL QUANTITIES AND LOCATIONS OF DEVICES.
- 2. PROVIDE ALL NECESSARY SYSTEM CARDS, POWER EXTENDER MODULES, POWER SUPPLIES, ENCLOSURES, AND INTERFACE MODULES NECESSARY FOR A COMPLETE AND FUNCTIONING SYSTEM.
- 3. PROVIDE SMOKE DETECTOR PROTECTION AT ALL FIRE ALARM EQUIPMENT LOCATIONS (NOT SHOWN
- PROVIDE SCREW SET LOCK ON DEVICES FOR ALL CIRCUIT BREAKERS SUPPLYING FIRE ALARM EQUIPMENT.
- 5. UPON FIRE ALARM CONTROL PANEL ACTIVATION, RELEASE DOOR HOLDERS.

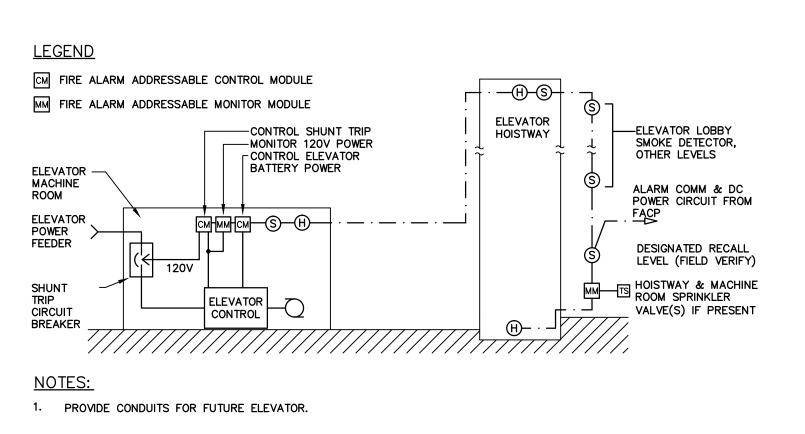


ELEVATOR WIRING DIAGRAM
NO SCALE

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SPRINGER'S
JEWELERS
380 CONGRESS STREET

date: APRIL 27, 2012

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scale:

AS NOTED
sheet title:

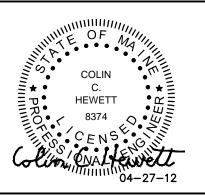ELECTRICAL SYMBOLS LIST AND DETAILS

sheet:

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	LIGHTING RELAY/CONTROL SCHEDULE											
LIGHTING	CONTROL	LOAD SERVED	СКТ	PNL'BD	CON	TROL CLOCK	LOCAL	DEMARKS				
PANEL	RELAY	LOAD SERVED	VA	CKT	ON	OFF	SWITCH	REMARKS				
RPB	1	NIGHTLIGHTS	550	1-B1	_	_	_	_				
RPB	2	SET UP / CLEAN UP	1000	24-B1	_	_	a	_				
RPB	3	EXTERIOR ENTRY LIGHTS	240	3-B1	l x	l x	_	_				
RPB	4	WINDOW DISPLAY CASE LED LIGHTS	200	5-B1	l x	l x	_	_				
RPB	5	STORE DOWNLIGHTS/SCONCES	1380	15-B1	_	-	b	_				
RPB	6	CHANDELIERS	1200	17-B1	_	_	a	_				
RPB	7	COVE LIGHTS (c)	840	2-B1	_	_	Ь	_				
RPB	8	COVE LIGHTS (d)	825	4-B1	_	_	Ь	_				
RPB	9	DISPLAY TRACK (e)	1550	6-B1	_	_	Ь	_				
RPB	10	DISPLAY TRACK (f)	1550	8-B1	_	-	b	_				
RPB	11	DISPLAY TRACK (g)	1550	10-B1	_	_	ь	_				
RPB	12	DISPLAY TRACK (h)	1400	12-B1	_	_	Ь	_				
RPB	13	DISPLAY TRACK (i)	1400	14-B1	_	_	ь	_				
RPB	14	DISPLAY TRACK (j)	1400	16-B1	_	_	ь	_				
RPB	15	DISPLAY DOWNLIGHTS	760	18-B1	_	-	ь	_				
RPB	16	DISPLAY DOWNLIGHTS	930	20-B1	_	_	ь	_				
RPB	17	DISPLAY DOWNLIGHTS	1110	22-B1	l _	_	b	_				
RPB	18	DISPLAY LEDS	261	7-B1	_	_	b	_				
RPB	19	DISPLAY LEDS	342	9-B1	_	_	b	_				
RPB	20	DISPLAY LEDS	282	11-B1	_	-	b	_				
RPB	21	DISPLAY LEDS	300	13-B1	_	_	b	_				
RPB	22	SPARE	_	_	-	_	_	_				
RPB	23	SPARE	_	_	-	_	_	_				
RPB	24	SPARE	_	_	_	_	_	_				

GENERAL NOTES

- THIS PLAN HAS BEEN COMPILED FROM FIELD OBSERVATIONS. FIELD VERIFY ALL CONDITIONS AND OBSERVE NECESSARY SAFETY PRECAUTIONS BEFORE DOING ANY WORK.
- 2. RUN SURFACE WIRING AS INCONSPICUOUS AS POSSIBLE, IN WALL AND CEILING CORNERS WHERE POSSIBLE, AS INDICATED.
- 3. DEVICES WITH CONTINUOUS LINETYPE INDICATE NEW UNLESS OTHERWISE INDICATED.
- 4. DEVICES WITH DASHED LINETYPE — INDICATE EXISTING TO REMAIN UNLESS OTHERWISE INDICATED.
- 5. DEVICES WITH HIDDEN LINETYPE ---- INDICATE REMOVE UNLESS OTHERWISE INDICATED.
- IN EVENT ANY UNSAFE WIRING IS ENCOUNTERED, IMMEDIATELY NOTIFY ENGINEER FOR CORRECTIVE ACTION.
- 7. PROVIDE OWNER 3 DAYS NOTICE OF ANY POWER OUTAGES.

KEYED NOTES


A WIRE LOW VOLTAGE 2-BUTTON SWITCH TO LIGHTING RELAY PANEL "RPB" IN BASEMENT.

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PLOT DATE: Apr 27, 2012



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date:

drawn by:

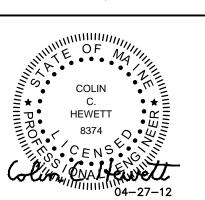
CCH/ELH 1/4" = 1'-0"


APRIL 27, 2012


sheet title:

1ST FLOOR LIGHTING PLAN

E1.1

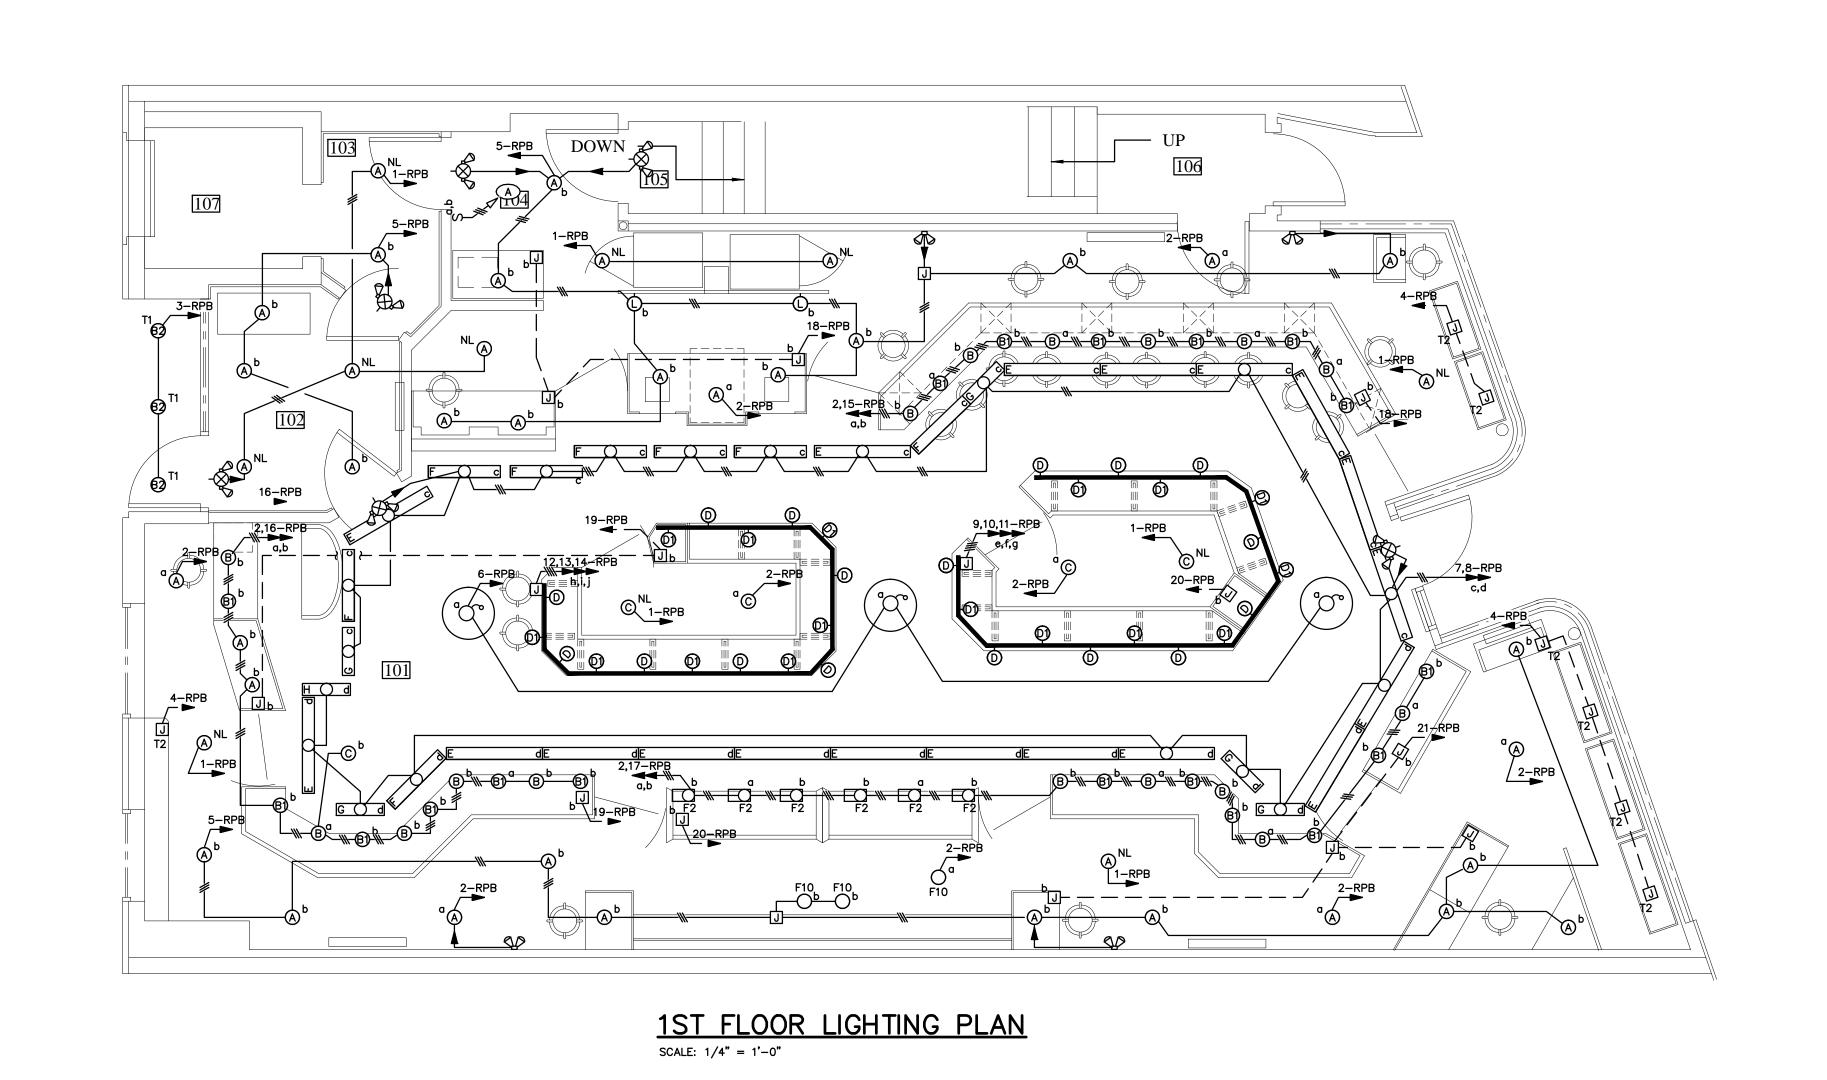

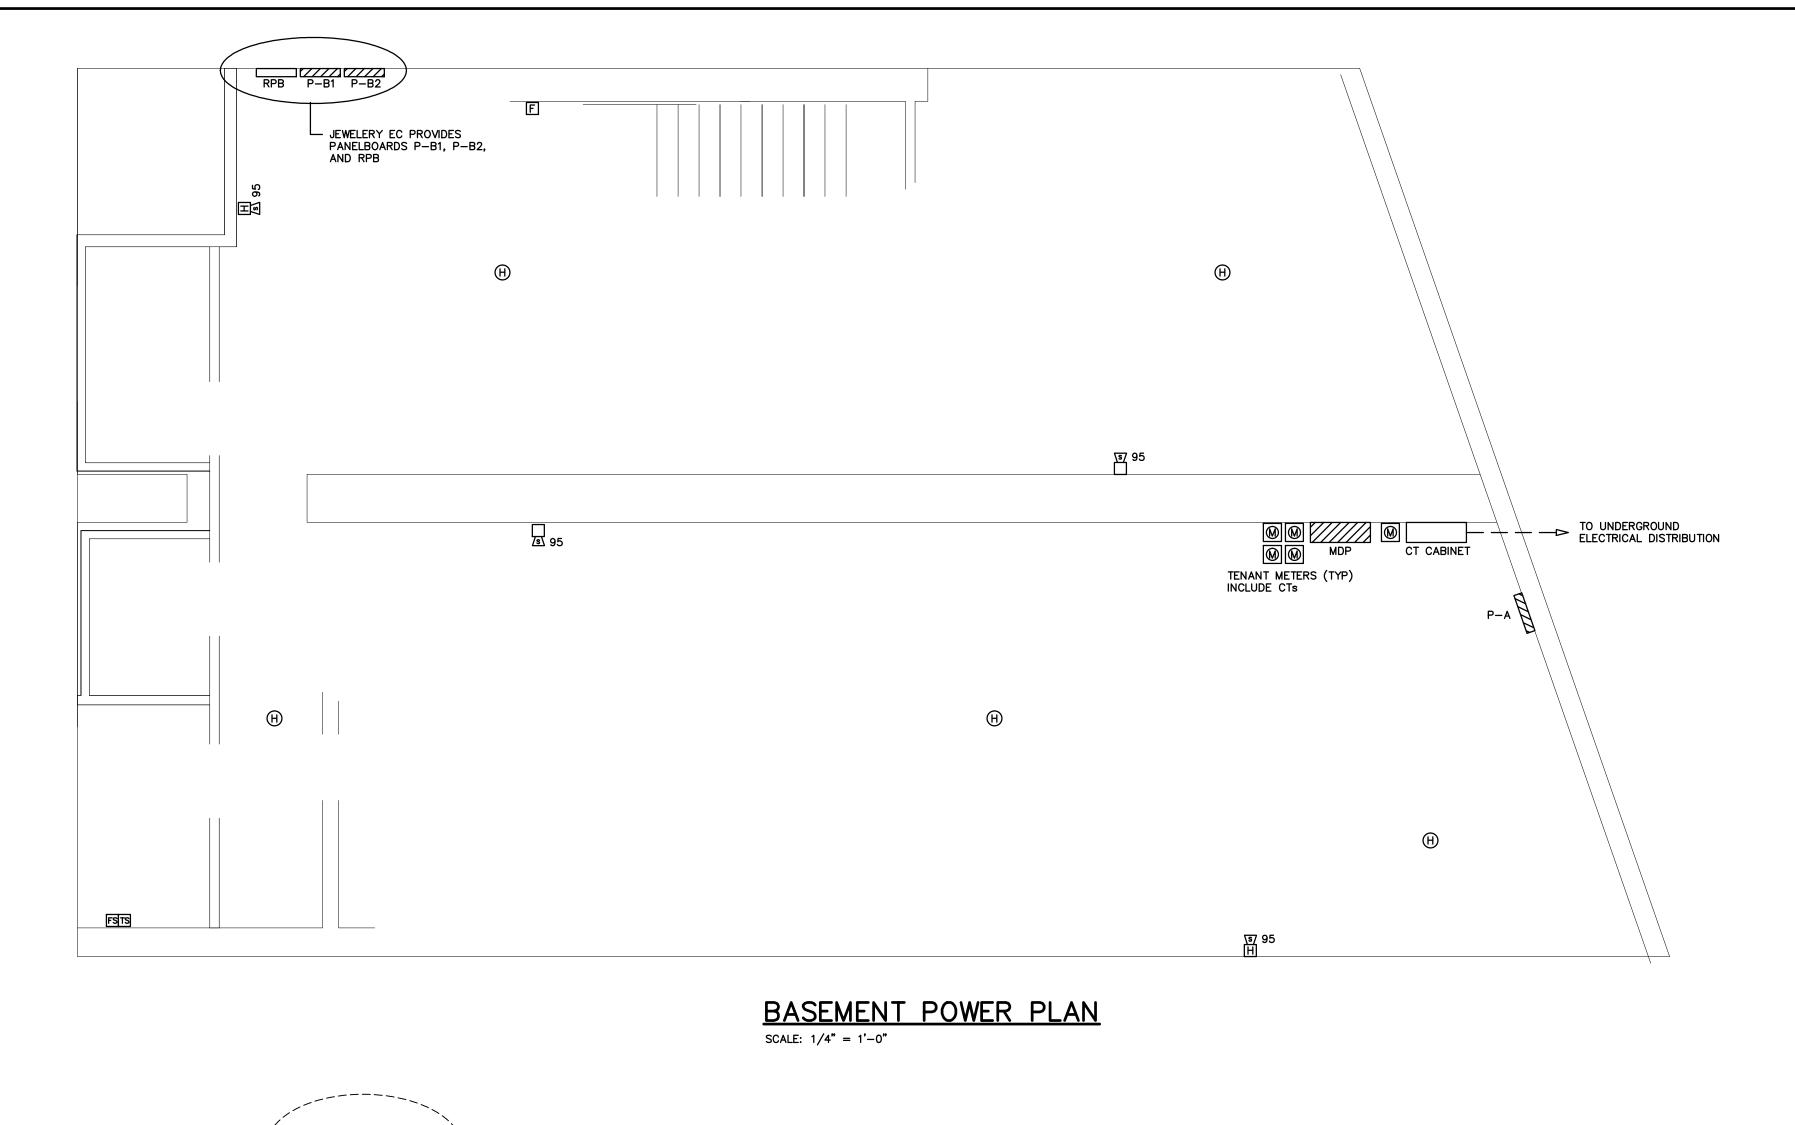

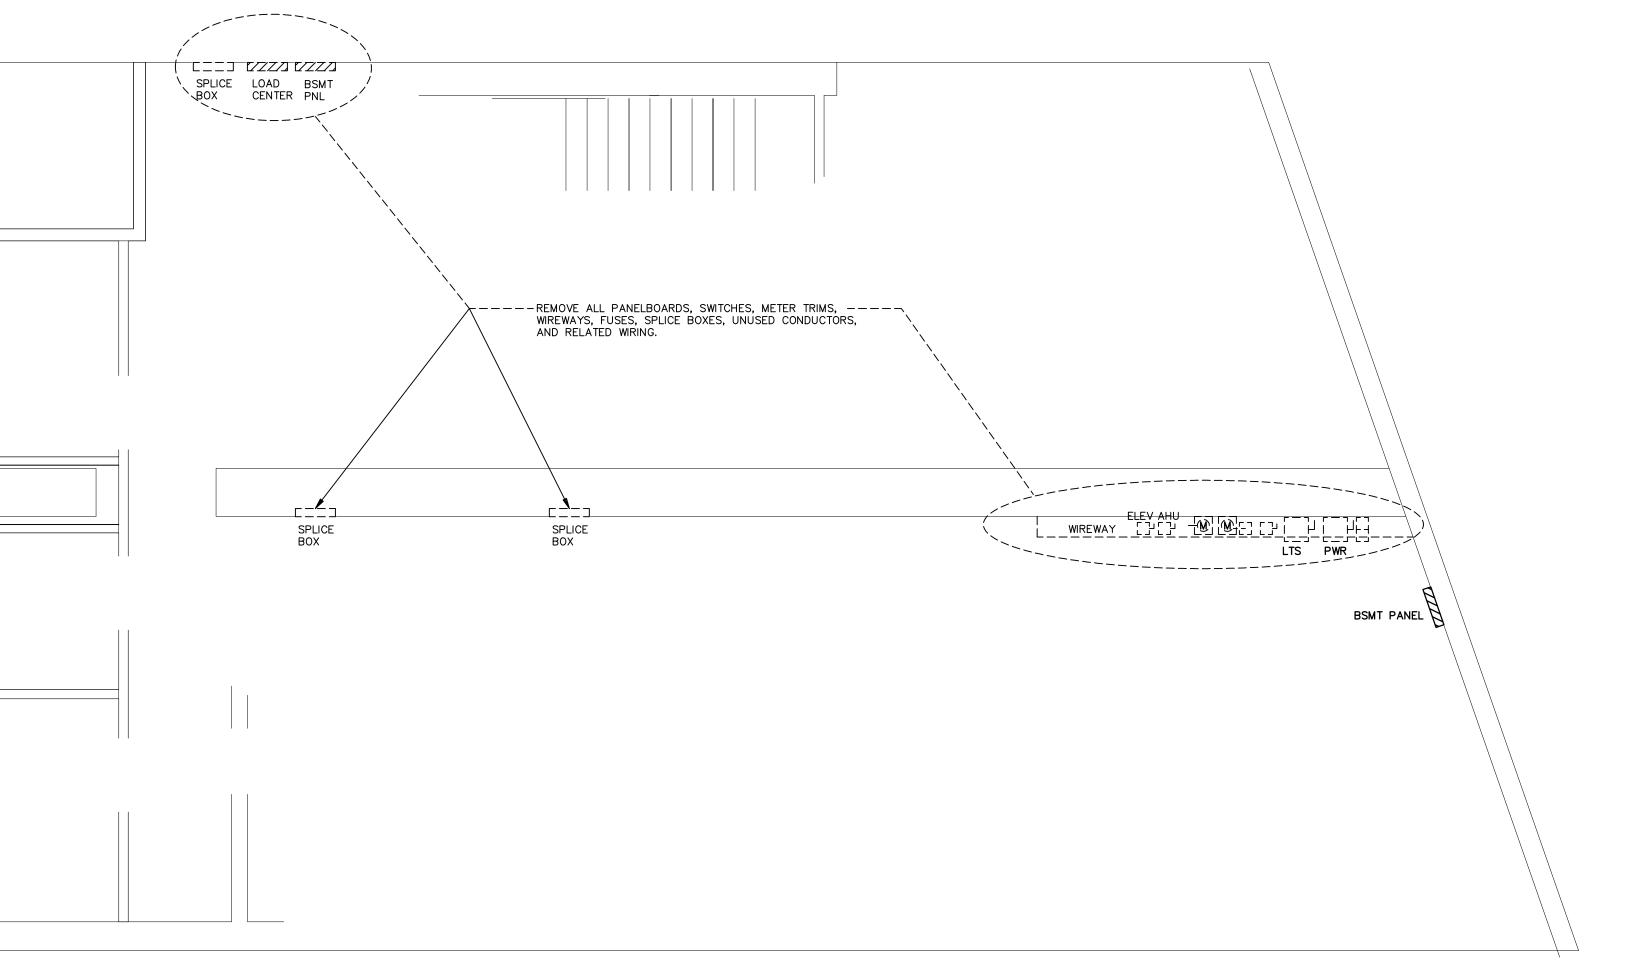

BASEMENT DEMOLITION PLAN

SCALE: 1/4" = 1'-0"

GENERAL NOTES

1. THIS PLAN HAS BEEN


- THIS PLAN HAS BEEN COMPILED FROM FIELD OBSERVATIONS. FIELD VERIFY ALL CONDITIONS AND OBSERVE NECESSARY SAFETY PRECAUTIONS BEFORE DOING ANY WORK.
- 2. RUN SURFACE WIRING AS INCONSPICUOUS AS POSSIBLE, IN WALL AND CEILING CORNERS WHERE POSSIBLE, AS INDICATED.
- 3. DEVICES WITH CONTINUOUS LINETYPE ————— INDICATE NEW UNLESS OTHERWISE INDICATED.
- 4. DEVICES WITH DASHED LINETYPE — INDICATE EXISTING TO REMAIN UNLESS OTHERWISE INDICATED.
- 5. DEVICES WITH HIDDEN LINETYPE ---- INDICATE REMOVE UNLESS OTHERWISE INDICATED.
- IN EVENT ANY UNSAFE WIRING IS ENCOUNTERED, IMMEDIATELY NOTIFY ENGINEER FOR CORRECTIVE ACTION.
- 7. PROVIDE OWNER 3 DAYS NOTICE OF ANY POWER OUTAGES.

brian e. duffy

associates

65 falmouth road falmouth, me. 04105 tel: 207-773-9500



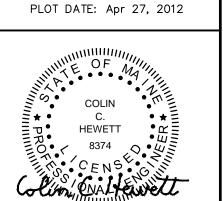

SPRINGER'S JEWELERS

date: APRIL 27, 2012

drawn by:


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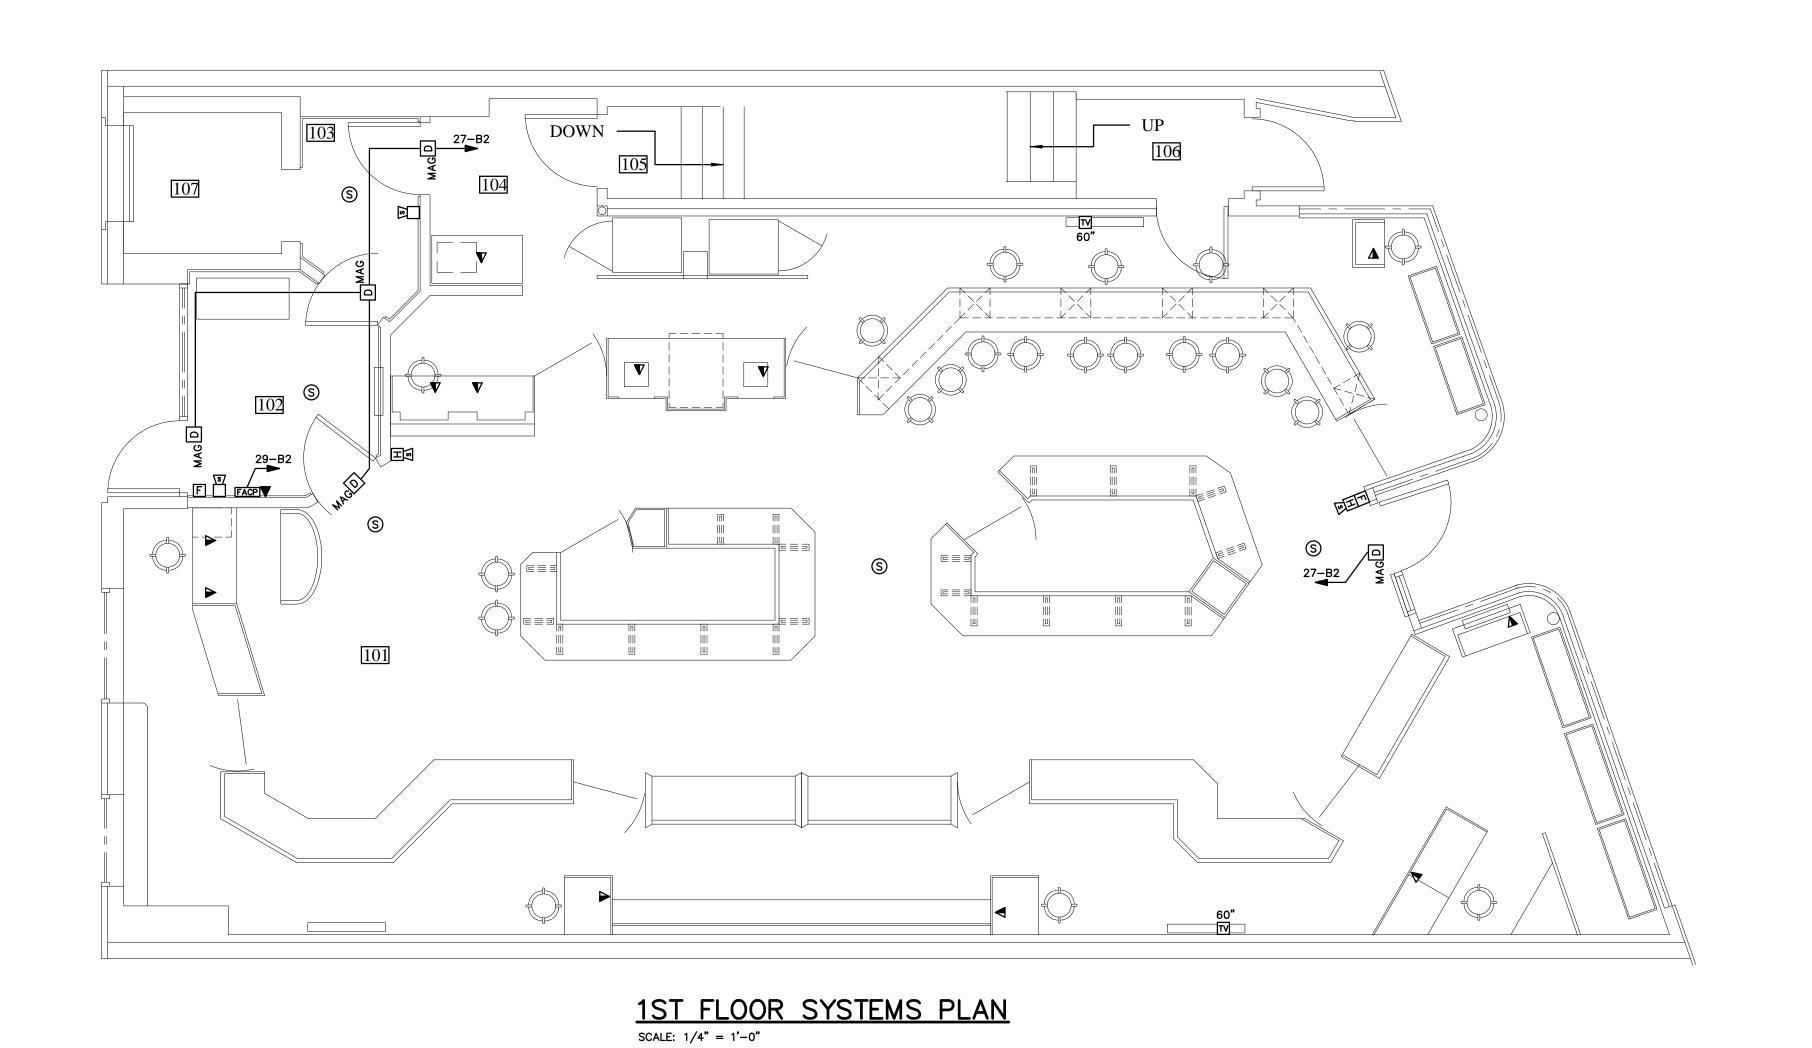
BASEMENT POWER PLANS

sheet:

E2.0



SCALE: 1/4" = 1'-0"

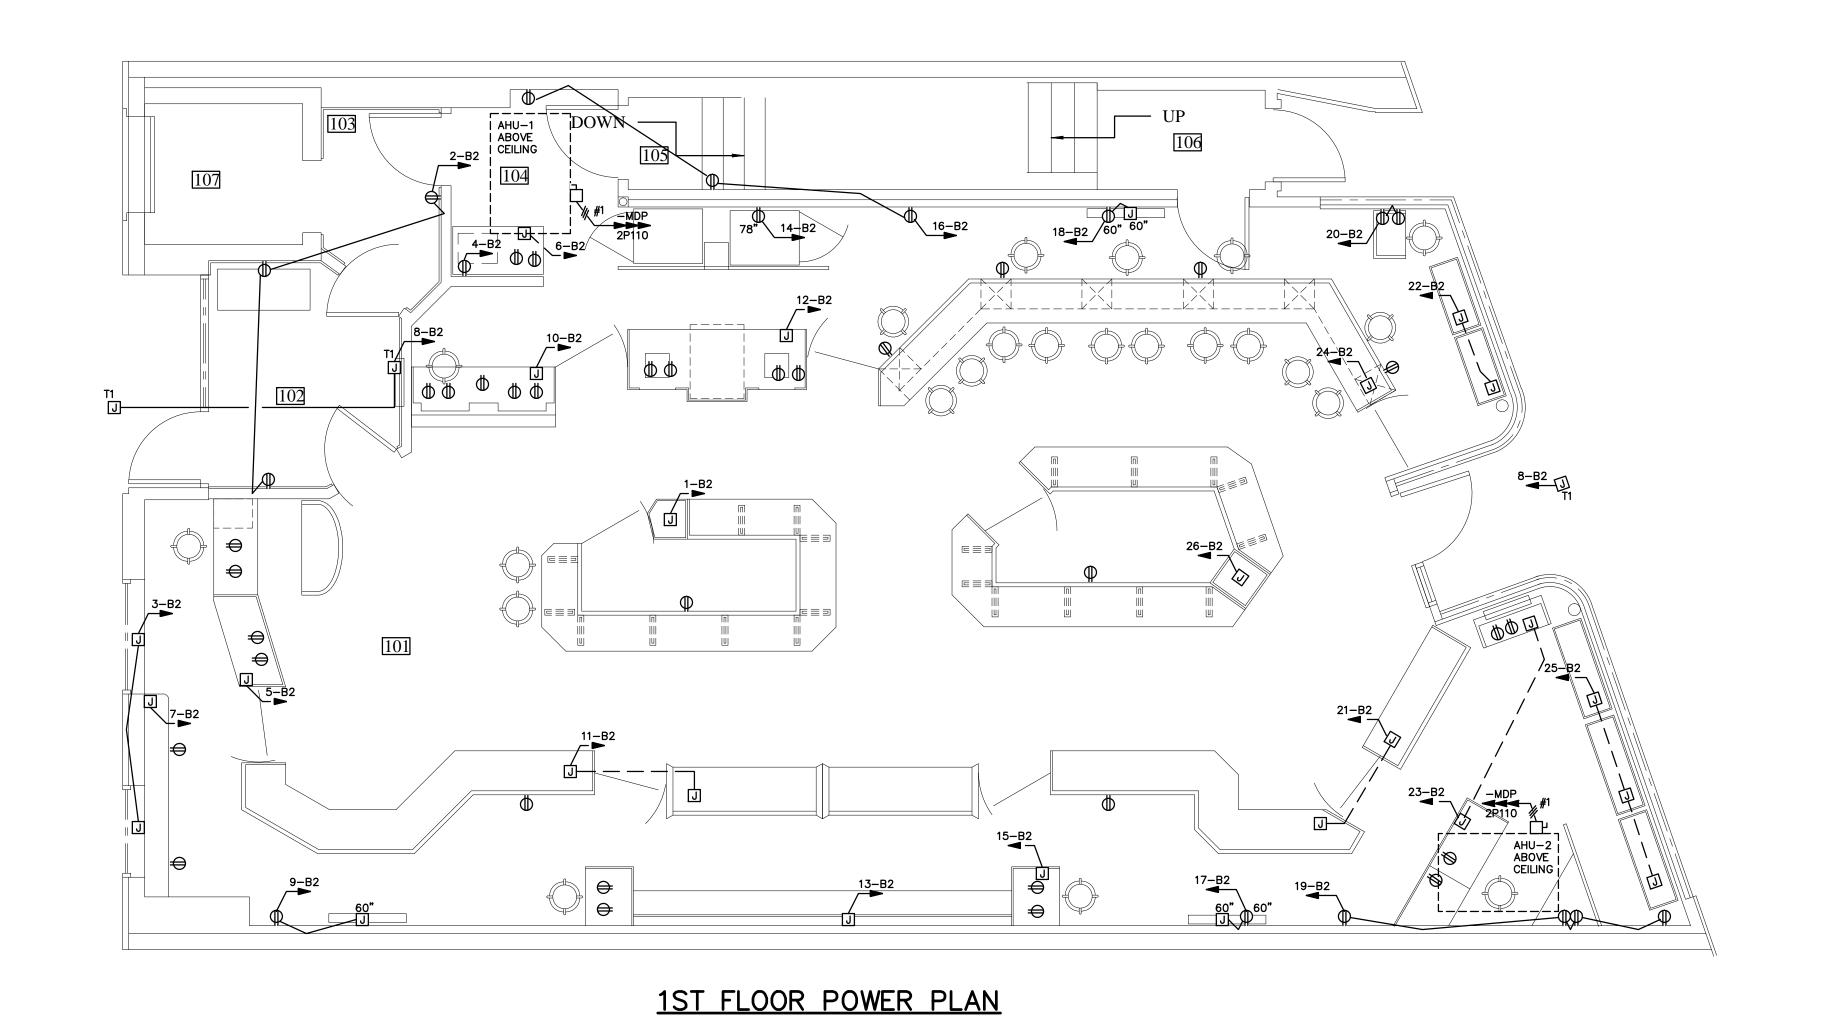


GENERAL NOTES

- THIS PLAN HAS BEEN COMPILED FROM FIELD OBSERVATIONS. FIELD VERIFY ALL CONDITIONS AND OBSERVE NECESSARY SAFETY PRECAUTIONS BEFORE DOING ANY WORK.
- 2. RUN SURFACE WIRING AS INCONSPICUOUS AS POSSIBLE, IN WALL AND CEILING CORNERS WHERE POSSIBLE, AS INDICATED.
- DEVICES WITH CONTINUOUS LINETYPE INDICATE NEW UNLESS OTHERWISE INDICATED.
- 4. DEVICES WITH DASHED LINETYPE — INDICATE EXISTING TO REMAIN UNLESS OTHERWISE INDICATED.
- 5. DEVICES WITH HIDDEN LINETYPE ---- INDICATE REMOVE UNLESS OTHERWISE INDICATED.
- IN EVENT ANY UNSAFE WIRING IS ENCOUNTERED, IMMEDIATELY NOTIFY ENGINEER FOR CORRECTIVE ACTION.
- 7. PROVIDE OWNER 3 DAYS NOTICE OF ANY POWER OUTAGES.



65 falmouth road falmouth, me. 04105 tel: 207-773-9500



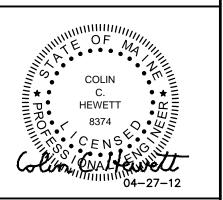

SPRINGER'S
JEWELERS
580 CONGRESS STREET

date: APRIL 27, 2012

drawn by:

scale:

1/4" = 1'-0" sheet title:


CCH/ELH

1ST FLOOR POWER AND SYSTEMS PLANS


sheet:

E2.1

EXISTING ELECTRICAL RISER DIAGRAM
SCALE: NO SCALE

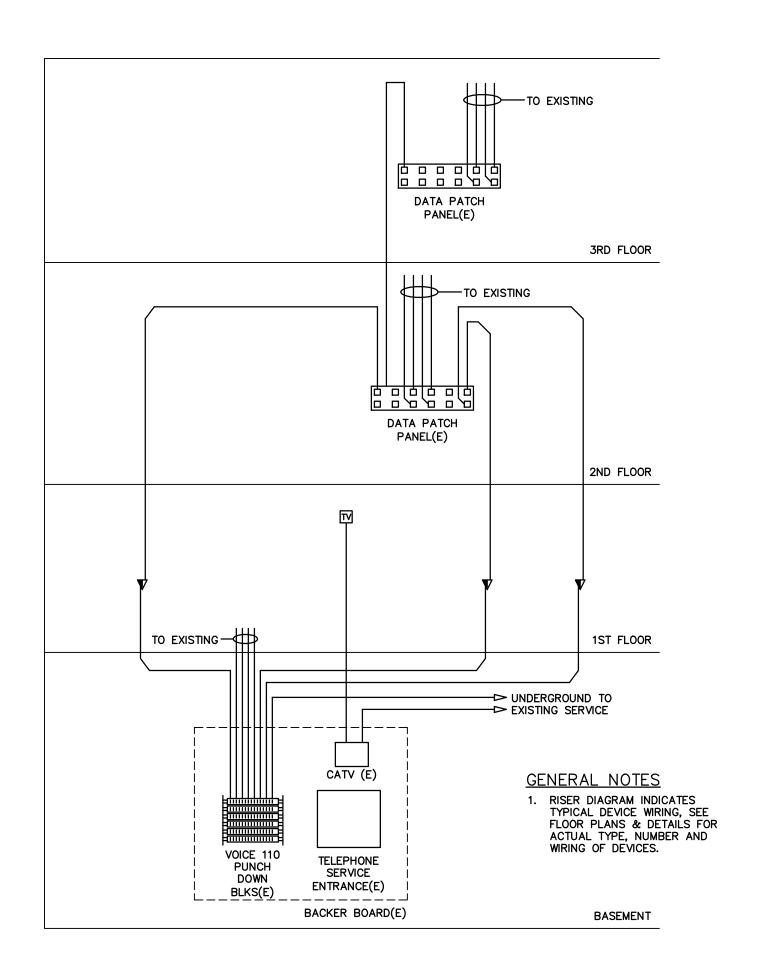

TELEPHONE/DATA RISER DIAGRAM
NOT TO SCALE

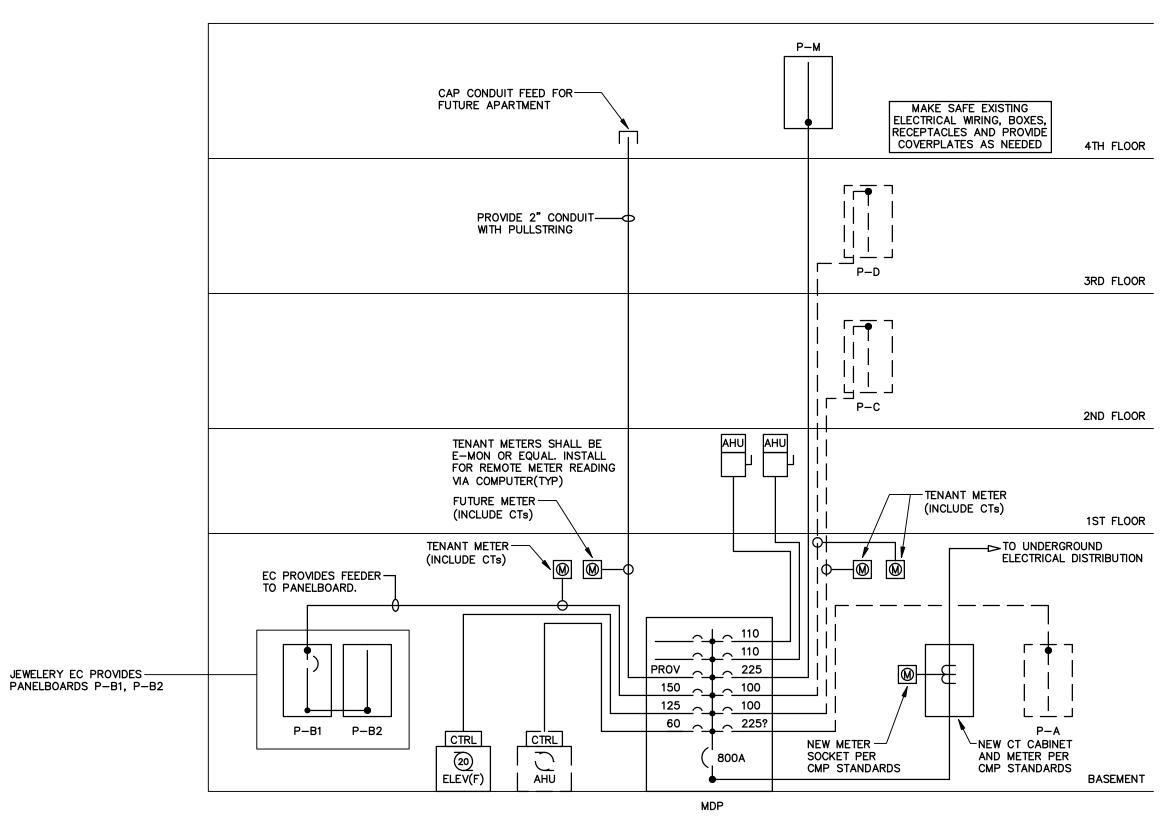

ELECTRICAL RISER DIAGRAM — REVISED
SCALE: NO SCALE

<u>M</u> [<u> </u>			SW	/ITC	HBOA	ARD S		IEDL	JLE		
		МА	INS			OVER		NOTEO				
BUS	ENTRY	PHASE	WIRE	VOLTS	SUB/THRU FEED LUGS	CURRENT PROTECT.	ID TAG	NO. WIRES	SIZE WIRE	INSUL'N	CONDUIT	NOTES
800A	СВ	3	4	280/ 120	_	800A	F-MDP	8	500MCM	XHHW	2-4"	1
					DISTRI	BUTION	CIRCUIT	BRE	AKERS	5		
	OVERCUR	RENT	DEVICE:	S			LOAD	SERVE	.D			NOTES
NO.	CB SIZE	SW	SIZE	FUSE SIZE			20/10	OLIVIE				110120
1	100		-	-	PROVIS	ION						
2	125		- [_	PROVIS	ION						
3	225		-	_	PROVIS	ION						
4	150		- [_	PANELE	BOARDS P-	·B1 & P-B2					
5	125		-	_	ELEVAT	OR (FUTUR	E)					
6	60		- [_	AHU (E	XISTING)						
7	110		-	_	AHU (N	IEW)						
8	110		-	_	AHU (N	IEW)						
0	225		-	-	PANELE	BOARD P-N	1					
10	100		-	-	PANELE	BOARD P-D	(EXISTING)					
11	100		-	-	PANELE	BOARD P-C	(EXISTING)					
12	225		-	-	PANELE	BOARD P-A	(EXISTING)					
13	-		-	-	_							
14	_		-	_	_							
15	_		-]	_	_							
16	-		-	-	-	<u> </u>						

MAIN SWITCHBOARD NOTES

FREE STANDING MAIN SWITCHBOARD, INDIVIDUALLY MOUNTED MAIN BREAKER TYPE PE SERIES, INCLUDE POWER LOGIC METER, FEEDER SECTION BREAKERS TO BE I—LINE MOUNTING, MINIMUM A.I.C. PER SPECIFICATION.

		PA	NELB	DAR	D (& I	FEE	DER	SCH	IEDUL	E_				
PANELBOARD MAINS OVER SUPPLY FEEDERS															
ID TAG	MOUNT'G	LOCATION	BUS	ENTRY	PHASE	WIRE	VOLTS	SUB/THRU FEED LUGS	CURRENT PROTECT.	ENT ECT. ID TAG		SIZE WIRE	INSUL'N	CONDUIT	NOTES
P-B1	SURF	BASEMENT	150A	СВ	3	4	208/ 120	THRU	150A	F-B1	4	#1/0 #6	XHHW THW	2"	1
P-B2	SURF	BASEMENT	150A	LUG	3	4	208/ 120	-	150A	F-B2	4	#1/0 #6	XHHW THW	2"	1
P-M	FLUSH	4TH FLOOR	225A	LUG	3	4	208/ 120	-	225A	F-M	4	#4/0 #4	XHHW THW	2 1/2"	1
AHU (E)	-	BASEMENT	60A	_	3	4	208/ 120	-	60A	F-AHU	4	#4 #10	XHHW THW	1"	2
ELEV(FUT)	-	BASEMENT	125A	_	3	4	208/ 120	-	125A	F-ELEV	4	#1 #6	XHHW THW	2"	3
AHU-1	-	1ST FLOOR CEILING	110A	_	1	3	208/ 120	-	110A	F-AHU1	3	#1 #6	XHHW THW	1 1/2"	4
AHU-2	-	1ST FLOOR CEILING	110A	-	1	3	208/ 120	-	110A	F-AHU2	3	#1 #6	XHHW THW	1 1/2"	4


PANELBOARD & MISC EQUIPMENT NOTES

- 1 NQOD PANELBOARD, BOLT-ON BREAKERS, MINIMUM GUTTERS 5" SIDES AND DEPTH, 8" FEED END, 10,000 A.I.C.
- PROVIDE TEMPORARY POWER FOR EXISTING AHU. UNIT WILL BE REMOVED WHEN NEW MECHANICAL SYSTEM IS OPERATIONAL. LABEL BREAKER "SPARE" FOLLOWING DEMO.
- 3 POWER FOR FUTURE ELEVATOR.
- 4 NEMA 1 FUSED DISCONNECT.



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SPRINGER'S JEWELERS 580 CONGRESS STREET PORTLAND, MAINE

date: APRIL 27, 2012

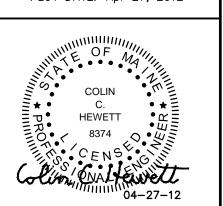drawn by: CCH/ELH

scale:

sheet title:

RISER DIAGRAMS & FEEDER SCHEDULE

sheet

E5.1