## Wall Type Legend

1 EXISTING WALL

DESCRIPTION

DOOR - STOREFRONT RESERVE PULL

NARROW FRAME SINGLE

3 NEW PARTITION WALL TO 6" (152MM) ABOVE CEILING


20 GA 3-5/8" (86 MM) METAL STUDS 16" (406MM) O.C. WITH 5/8" (16 MM) TYPE "X" GWB ON ONE OR BOTH SIDES TO MINIMUM OF 6" (152 MM) ABOVE CEILING GRID. DRYWALL SCREWS @ 12" (305 MM) O.C., 45 DEGREES. METAL STUD REINFORCEMENT @ 48" (1219 MM) O.C. ABOVE CEILING LINE TO STRUCTURE ABOVE. - MATCH EXISTING WALL THICKNESS, VERIFY IN FIELD.

(5) NEW FURRED WALL TO 6" (152 MM) ABOVE CEILING 20 GA 3-5/8" (86 MM) METAL STUDS 16" (406 MM) O.C. WITH 5/8" (16 MM) TYPE "X" GWB TO MINUMUM OF 6" (152MM) ABOVE CEILING GRID. DRYWALL SCREWS @ 12" (305 MM) O.C., 45 DEGREE METAL STUD REINFORCEMENT @ 48" (1219 MM) O.C. ABOVE CEILING LINE TO STRUCTURE ABOVE.

Type

Standard

Type

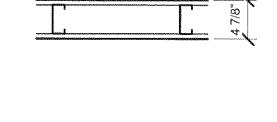

DOOR SCHEDULE - "D"

Finish

Hardwaie

Group

Frame Type Frame Material RESP.



SYMBOL ITEM	<u>WEIGHT</u>	<u>HEIGHT</u>	APPROXIMATE WIDT
Hand Dryer	350 LBS	2'-11" to 3'-11"	2'-10" Behinc Hand Dr
Restroom Grab Bars	250 LBS	3'-0" to 5'-2"	12" Behind Grab Bar

Extent of Backbar Upper

Casework

Upper Storage (Cubby) 300 LBS Cabinets at Backbar

Provide fire retardant 2x6 or 2x8 wood stud blocking as required to support any wall attachments

## FLOOR PLAN NOTES

A. GENERAL CONTRACTOR TO VERIFY ALL DIMENSIONS AND NOTIFY STARBUCKS CONSTRUCTION MANAGER OF ANY DISCREPANCIES PRIOR TO CONSTRUCTION. ALL DIMENSIONS TO BE TAKEN FROM DESIGNATED DATUM POINT.

B. IF EXISTING EXTERIOR ENTRANCE THRESHOLD EXCEEDS REQUIRED AMERICAN'S WITH DISABILITY ACT (ADA) MAXIMUM HEIGHT OF THE FOLLOWING: 1/4: STEP, 1/2" BEVEL, OR COMBINATION OF 1/4" STEP AND 1/4" BEVEL, REMOVE AND REPLACE WITH ACCESSIBLE THRESHOLD. RAISED THRESHOLDS AND FLOOR LEVEL CHANGES AT ACCESSIBLE DOORWAYS TO BE BEVELED WITH A SLOPE NO GREATER

C. GENERAL CONTRACTOR TO PROVIDE FIRE TREATED WOOD STUD BLOCKING, OR EQUIVALENT TO SUPPORT ANY WALL ATTACHMENT AND/OR SIGNAGE.

D. ALL DOORS TO PROVIDE 32" (900MM) MINIMUM CLEAR OPENING WHEN OPENED TO 90 DEGRÉE POSITION UNLESS OTHERWISE NOTED.

E. VERIFY ALL EXISTING DOORS, HARDWARE AND FRAMES MEET STARBUCKS AND/OR CODE REQUIREMENTS.


F. INSTALL 1/4" (6MM) GREEN BOARD ON BACKBAR WALL PER SPECIFICATION.

## SHEET NOTES

1. ALIGN FINISHED FACE OF WALL TO EXISTING FINISH.

2. GC TO FIELD VERIFY EXISTING COLUMN LOCATIONS PRIOR TO CONSTRUCTION. NOTIFY AOR IF EXISTING LOCATIONS DO NOT COORDINATE WITH DRAWINGS.

3. INSTALL NEW RESERVE DOOR PULL IN PLACE OF EXISTING DOOR PULL.

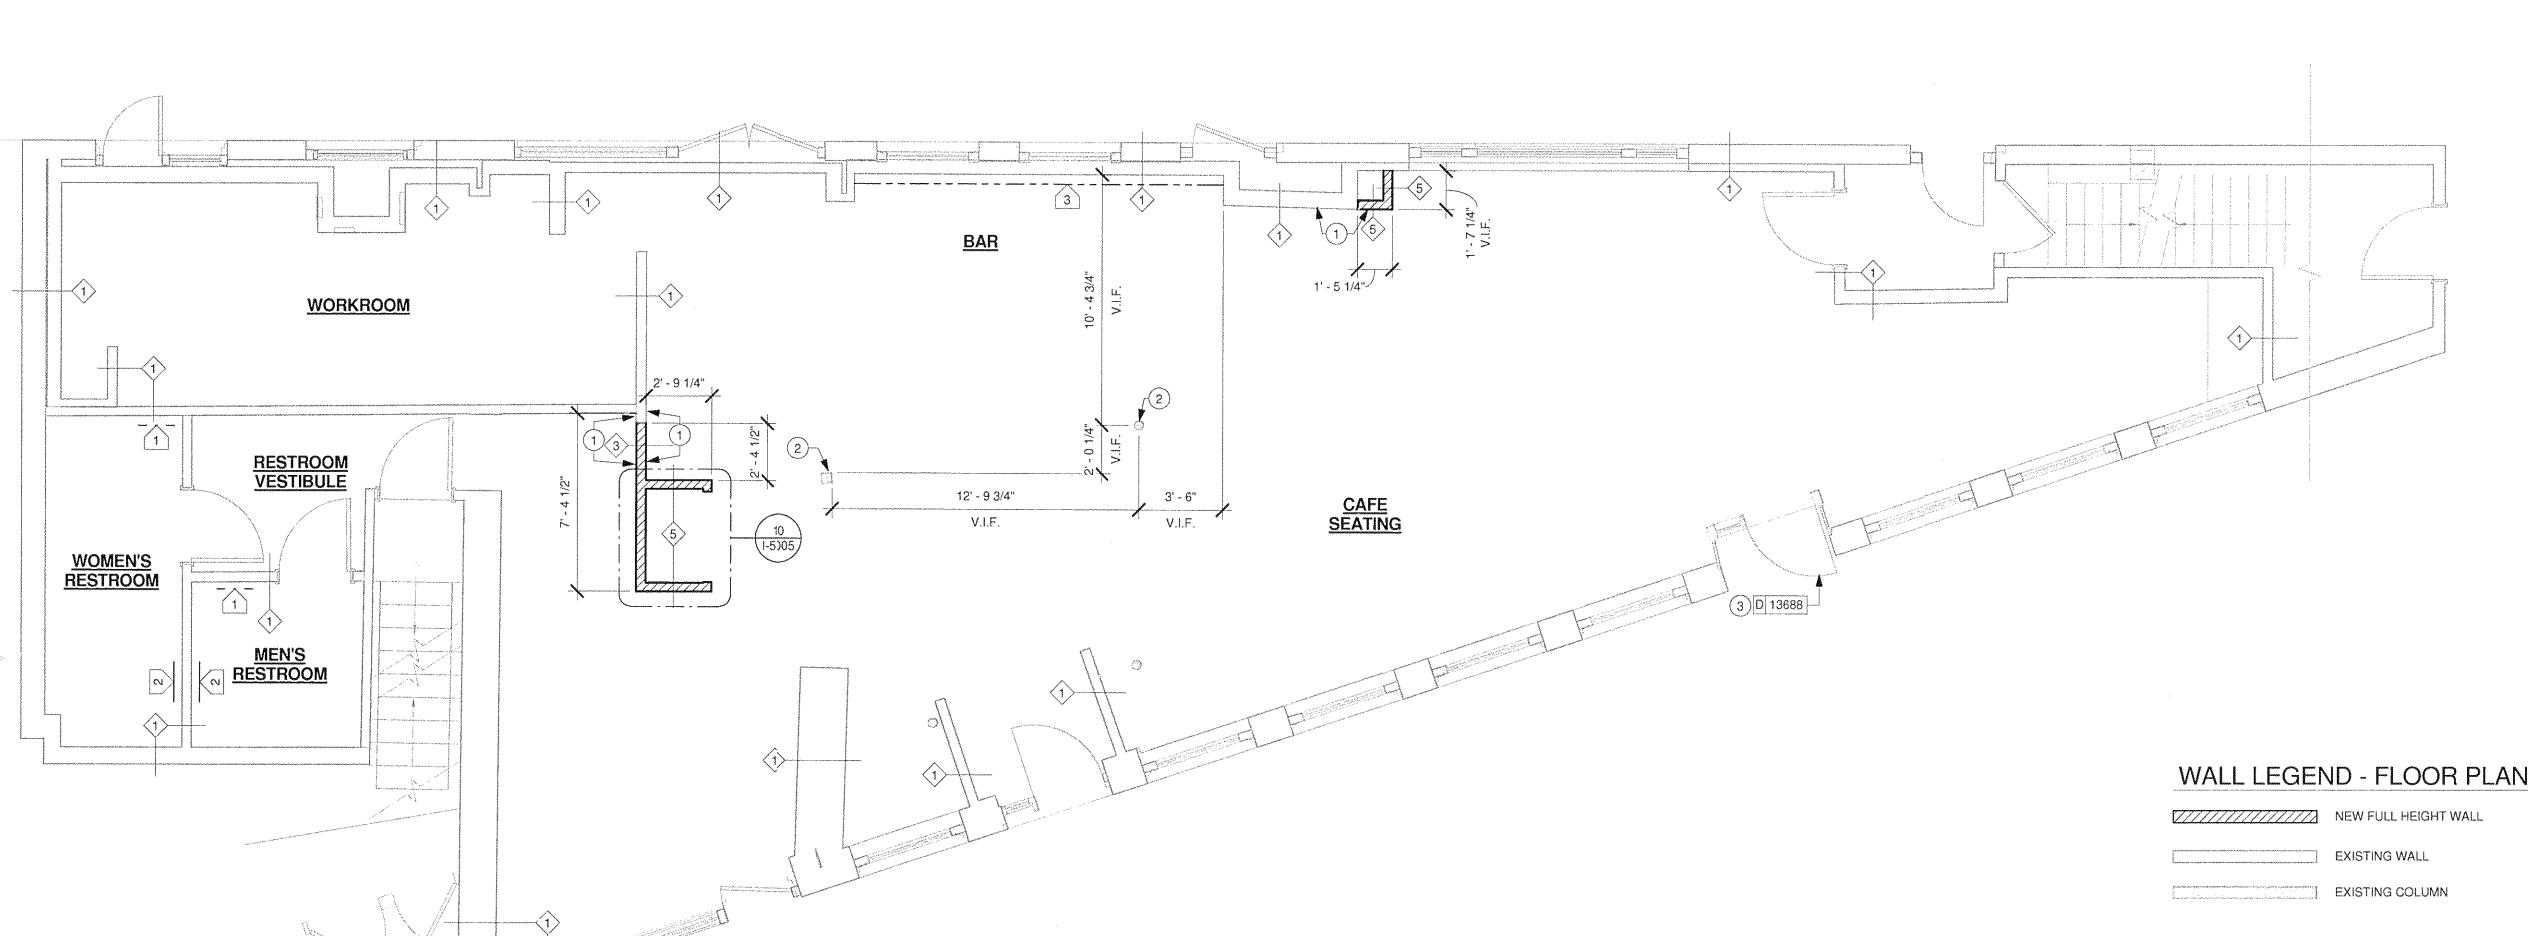

COMMENTS

www.bfcmetals.com. Finish: MT0011. Refer to Exterior Elevations for location and tag.


BFC Architectural Metals, Inc. Contact

## RESPONSIBILITY LEGEND

PROVIDED BY STARBUCKS

PROVIDED BY GENERAL CONTRACTOR PROVIDED BY LANDLORD PROVIDED BY VENDOR DIRECT

NOTE: ALL RESPONSIBILITES TO BE CONFIRMED WITH STARBUCKS DM PRIOR TO ORDERING / CONSTRUCTION

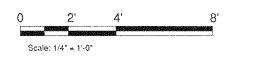



SHEET TITLE: FLOOR PLAN

SHEET NUMBER:

I-1103

As indicated

1 FLOOR PLAN

Scale: 1/4" = 1'-0"

DESIGN ID COUNT

13688

PROJECT NAME:
HAY BUILDING

STORE #: 7433

PROJECT #: 04704-026 CONCEPT: NCS PALETTE: REGIONAL MODERN ISSUE DATE: 12-16-2013

STARBUCKS COFFEE

COMPANY

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SEATTLE, WASHINGTON 98134

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CONSENT OF STARBUCKS CORPORATION.

Revision Schedule

MIOLOGOS 1 \*

Rev Date By

Description

DEC 20 2013

DESIGN MANAGER: ETA KLIGER LEED® AP: N/A

PRODUCTION DESIGNER: J.NEAL CHECKED BY: T. REISING