

City of Portland, Maine - Building or Use Permit Application
 389 Congress Street, 04101 Tel: (207) 874-8703, Fax: (207) 874-8716

PERMIT ISSUED

Permit No: 01-0924	Issue Date: JUL 31 2001	CBL: 037 E006001
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Location of Construction: 173 High St	Owner Name: Mmc Realty Corp	Owner Address: 22 Bramhall St	Phone: 207-774-6989
Business Name: n/a	Contractor Name: Gallant, Joe	Contractor Address: 15 Rochester St Westbrook	Phone: 2078575037
Lessee/Buyer's Name: n/a	Phone: n/a	Permit Type: Alterations - Commercial	Zone: B-3

Past Use: Commercial / Office	Proposed Use: Commercial / Office; Remove & Build walls to form new office and create new entrance area.	Permit Fee: \$48.00	Cost of Work: \$3,500.00	CEO District: 2
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FIRE DEPT: <input checked="" type="checkbox"/> Approved <input type="checkbox"/> Denied	INSPECTION: Use Group: B Type: 2B
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Proposed Project Description:
New Office Space

Signature: *[Signature]*
 PEDESTRIAN ACTIVITIES DISTRICT (P.A.D.)
 Action: Approved Approved w/Conditions Denied
 Signature: *[Signature]* Date: *[Date]*

Permit Taken By: gg	Date Applied For: 07/27/2001	Zoning Approval
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1. This permit application does not preclude the Applicant(s) from meeting applicable State and Federal Rules. 2. Building permits do not include plumbing, septic or electrical work. 3. Building permits are void if work is not started within six (6) months of the date of issuance. False information may invalidate a building permit and stop all work..	Special Zone or Reviews <input type="checkbox"/> Shoreland <input type="checkbox"/> Wetland <input type="checkbox"/> Flood Zone <input type="checkbox"/> Subdivision <input type="checkbox"/> Site Plan Maj <input type="checkbox"/> Minor <input type="checkbox"/> MM <input type="checkbox"/> Date: <i>[Signature]</i> 7/30/01	Zoning Appeal <input type="checkbox"/> Variance <input type="checkbox"/> Miscellaneous <input type="checkbox"/> Conditional Use <input type="checkbox"/> Interpretation <input type="checkbox"/> Approved <input type="checkbox"/> Denied Date:	Historic Preservation <input checked="" type="checkbox"/> Not in District or Landmark <input type="checkbox"/> Does Not Require Review <input type="checkbox"/> Requires Review <input type="checkbox"/> Approved <input type="checkbox"/> Approved w/Conditions <input type="checkbox"/> Denied Date: <i>[Signature]</i>
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PERMIT ISSUED WITH REQUIREMENTS

CERTIFICATION

I hereby certify that I am the owner of record of the named property, or that the proposed work is authorized by the owner of record and that I have been authorized by the owner to make this application as his authorized agent and I agree to conform to all applicable laws of this jurisdiction. In addition, if a permit for work described in the application is issued, I certify that the code official's authorized representative shall have the authority to enter all areas covered by such permit at any reasonable hour to enforce the provision of the code(s) applicable to such permit.

SIGNATURE OF APPLICANT	ADDRESS	DATE	PHONE
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RESPONSIBLE PERSON IN CHARGE OF WORK, TITLE	DATE	PHONE
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All Purpose Building Permit Application

If you or the property owner owes real estate or personal property taxes or user charges on any property within the City, payment arrangements must be made before permits of any kind are accepted.

Location/Address of Construction: 177 High St

Total Square Footage of Proposed Structure: not a structure (interior remodeling) Square Footage of Lot: ?

Tax Assessor's Chart, Block & Lot Chart# <u>037</u> Block# <u>E</u> Lot# <u>006</u>	Owner: <u>Joe Wishcamper</u>	Telephone: <u>774-6989</u>
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Lessee/Buyer's Name (If Applicable)	Applicant name, address & telephone: <u>Wishcamper Prop. Inc</u> <u>177 High St 774-6989</u>	Cost Of Work: \$ <u>3,500.00</u> Fee: \$ <u>48.00</u>
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Current use: office

If the location is currently vacant, what was prior use: _____

Approximately how long has it been vacant: _____

Proposed use: Office Space

Project description: Build walls to form new office.
Remove walls to inlarge office space + create new entrance area.

Contractor's name, address & telephone: Joe Gallant 15 Rochester St Westbrook
857-5037

Who should we contact when the permit is ready: Joe Gallant

Mailing address: _____

Phone: _____

IF THE REQUIRED INFORMATION IS NOT INCLUDED IN THE SUBMISSIONS THE PERMIT WILL BE AUTOMATICALLY DENIED AT THE DISCRETION OF THE BUILDING/PLANNING DEPARTMENT, WE MAY REQUIRE ADDITIONAL INFORMATION IN ORDER TO APPROVE THIS PERMIT.

I hereby certify that I am the Owner of record of the named property, or that the owner of record authorizes the proposed work and that I have been authorized by the owner to make this application as his/her authorized agent. I agree to conform to all applicable laws of this jurisdiction. In addition, if a permit for work described in this application is issued, I certify that the Code Official's authorized representative shall have the authority to enter all areas covered by this permit at any reasonable hour to enforce the provisions of the codes applicable to this permit.

Signature of applicant: Joseph Gallant DEPT. OF BUILDING INSPECTION CITY OF PORTLAND Date: 7/20/01

This is not a permit, you may not commence work until the permit is issued

Gang 7/27/01

BUILDING PERMIT REPORT

DATE: 30 July 2001 ADDRESS: 173 High Street CBL: 037-E-006

REASON FOR PERMIT: Interior renovations

BUILDING OWNER: MMC Realty Corp.

PERMIT APPLICANT: _____ /CONTRACTOR Joe Gallant

USE GROUP: B/S1 CONSTRUCTION TYPE: 2A CONSTRUCTION COST: \$3,500.00 PERMIT FEES: \$48100

The City's Adopted Building Code (The BOCA National Building Code/1999 with City Amendments)
 The City's Adopted Mechanical Code (The BOCA National Mechanical Code/1993)

CONDITION(S) OF APPROVAL

This permit is being issued with the understanding that the following conditions shall be met: *1, *21, *22, *23, *24, *25, *28, *30, *31, *35, *38.

- ~~1.~~ This permit does not excuse the applicant from meeting applicable State and Federal rules and laws.
2. Before concrete for foundation is placed, approvals from the Development Review Coordinator and Inspection Services must be obtained. (A 24 hour notice is required prior to inspection) **"ALL LOT LINES SHALL BE CLEARLY MARKED BEFORE CALLING."**
3. Foundation drain shall be placed around the perimeter of a foundation that consists of gravel or crushed stone containing not more than 10 percent material that passes through a No. 4 sieve. The drain shall extend a minimum of 12 inches beyond the outside edge of the footing. The thickness shall be such that the bottom of the drain is not higher than the bottom of the base under the floor, and that the top of the drain is not less than 6 inches above the top of the footing. The top of the drain shall be covered with an approved filter membrane material. Where a drain tile or perforated pipe is used, the invert of the pipe or tile shall not be higher than the floor elevation. The top of joints or top of perforations shall be protected with an approved filter membrane material. The pipe or tile shall be placed on not less than 2" of gravel or crushed stone, and shall be covered with not less than 6" of the same material. Section 1813.5.2
4. Foundations anchors shall be a minimum of 1/2" in diameter, 7" into the foundation wall, minimum of 12" from corners of foundation and a maximum 6' O.C. between bolts. Section 2305.17
5. Waterproofing and dampproofing shall be done in accordance with Section 1813.0 of the building code.
6. Precaution must be taken to protect concrete and masonry. Concrete Sections 1908.9-19.8.10/ Masonry Sections 2111.3-2111.4.
7. It is strongly recommended that a registered land surveyor check all foundation forms before concrete is placed. This is done to verify that the proper setbacks are maintained.
8. Private garages located beneath habitable rooms in occupancies in Use Group R-1, R-2, R-3 or I-1 shall be separated from adjacent interior spaces by fire partitions and floor/ceiling assembly which are constructed with not less than 1-hour fire resisting rating. Private garages attached side-by-side to rooms in the above occupancies shall be completely separated from the interior spaces and the attic area by means of 1/2 inch gypsum board or the equivalent applied to the garage side. (Chapter 4, Section 407.0 of the BOCA/1999)
9. All chimneys and vents shall be installed and maintained as per Chapter 12 of the City's Mechanical Code. (The BOCA National Mechanical Code/1993). Chapter 12 & NFPA 211
10. Sound transmission control in residential building shall be done in accordance with Chapter 12, Section 1214.0 of the City's Building Code.
11. Guardrails & Handrails: A guardrail system is a system of building components located near the open sides of elevated walking surfaces for the purpose of minimizing the possibility of an accidental fall from the walking surface to the lower level. Minimum height all Use Groups 42". In occupancies in Use Group A, B.H-4, I-1, I-2, M, R, public garages and open parking structures, open guards shall have balusters or be of solid material such that a sphere with a diameter of 4" cannot pass through any opening. Guards shall not have an ornamental pattern that would provide a ladder effect. Handrails shall be a minimum of 34" but not more than 38". Exception: Handrails that form part of a guard shall have a height not less than 36 inches (914 mm) and not more than 42 inches (1067 mm). Handrail grip size shall have a circular cross section with an outside diameter of at least 1 1/4" and not greater than 2". (Sections 1021 & 1022.0). Handrails shall be on both sides of stairway. (Section 1014.7) **R-3 (ONE & TWO FAMILY DWELLINGS) GUARD HEIGHT IS 36" MINIMUM.**
12. Headroom in habitable space is a minimum of 7'6". (Section 1204.0)
13. Stair construction in Use Group R-3 & R-4 is a minimum of 10" tread and 7 1/2" maximum rise. All other Use Group minimum 11" tread, 7" maximum rise. (Section 1014.0)
14. The minimum headroom in all parts of a stairway shall not be less than 80 inches. (6'8") 1014.4
15. The Minimum required width of a corridor shall be determined by the most restrictive of the criteria under section 1011.3 but not less than 36".
16. Every sleeping room below the fourth story in buildings of Use Groups R and I-1 shall have at least one operable window or exterior door approved for emergency egress or rescue. The units must be operable from the inside without the use of special knowledge or separate tools. Where windows are provided as means of egress or rescue they shall have a sill height not more than 44 inches (1118mm) above the floor. All egress or rescue windows from sleeping rooms shall have a minimum net clear opening height dimension of 24 inches (610mm). The minimum net clear opening width dimension shall be 20 inches (508)mm, and a minimum net clear opening of 5.7 sq. ft. (Section 1010.4)
17. Each apartment shall have access to two (2) separate, remote and approved means of egress. A single exit is acceptable when it exits directly from the apartment to the building exterior with no communications to other apartment units. (Section 1010.1)
18. All vertical openings shall be enclosed with construction having a fire rating of at least one (1) hour, including fire doors with self closure's. (Over 3 stories in height requirements for fire rating is two (2) hours. (Section 710.0)
19. The boiler shall be protected by enclosing with (1) hour fire rated construction including fire doors and ceiling, or by providing automatic extinguishment. (Table 302.1.1)

20. All single and multiple station smoke detectors shall be of an approved type and shall be installed in accordance with the provisions of the City's Building Code Chapter 9, Section 920.3.2 (BOCA National Building Code/1999); and NFPA 101 Chapter 18 & 19. (Smoke detectors shall be installed and maintained at the following locations):

- In the immediate vicinity of bedrooms
- In all bedrooms
- In each story within a dwelling unit, including basements

21. A portable fire extinguisher shall be located as per NFPA #10. They shall bear the label of an approved agency and be of an approved type. (Section 921.0)

22. The Fire Alarm System shall be installed and maintained to NFPA #72 Standard.

23. The Sprinkler System shall be installed and maintained to NFPA #13 Standard.

24. All exit signs, lights and means of egress lighting shall be done in accordance with Chapter 10 Section & Subsections 1023.0 & 1024.0 of the City's Building Code. (The BOCA National Building Code/1999)

25. Section 25 - 135 of the Municipal Code for the City of Portland states, "No person or utility shall be granted a permit to excavate or open any street or sidewalk from the time of November 15 of each year to April 15 of the following year".

26. The builder of a facility to which Section 4594-C of the Maine State Human Rights Act Title 5 MRSA refers, shall obtain a certification from a design professional that the plans commencing construction of the facility, the builder shall submit the certification the Division of Inspection Services.

27. Ventilation and access shall meet the requirements of Chapter 12 Sections 1210.0 and 1211.0 of the City's Building Code. (Crawl spaces & attics).

28. All electrical, plumbing and HVAC permits must be obtained by Master Licensed holders of their trade. **No closing in of walls until all electrical (min. 72 hours notice) and plumbing inspections have been done.**

29. All requirements must be met before a final Certificate of Occupancy is issued.

30. All building elements shall meet the fastening schedule as per Table 2305.2 of the City's Building Code (The BOCA National Building Code/1996).

31. Ventilation of spaces within a building shall be done in accordance with the City's Mechanical code (The BOCA National Mechanical Code/1993). (Chapter M-16)

32. Please read and implement the attached Land Use Zoning report requirements. *Any New Signage Requires A Separate permit And Approval*

33. Boring, cutting and notching shall be done in accordance with Sections 2305.3, 2305.3.1, 2305.4.4 and 2305.5.1 of the City's Building Code.


34. Bridging shall comply with Section 2305.16.



35. Glass and glazing shall meet the requirements of Chapter 24 of the building code. (Safety Glazing Section 2406.0)

36. All flashing shall comply with Section 1406.3.10.

37. All signage shall be done in accordance with Section 3102.0 signs of the City's Building Code, (The BOCA National Building Code/1999).

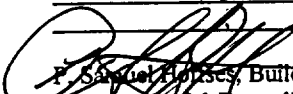38. *Metal Studs are to be used in bldgs. of this type of construction.*


F. Samuel Horses, Building Inspector

Cc:  Marge Schmuckal, Zoning Administrator
 Michael Nugent, Inspection Service Manager

PSH 10/1/00

****This permit is herewith issued, on the basis of plans submitted and conditions placed on these plans, any deviations shall require a separate approval.**

*****THIS PERMIT HAS BEEN ISSUED WITH THE UNDERSTANDING THAT ALL THE CONDITIONS OF THE APPROVAL SHALL BE COMPLETED. THEREFORE, BEFORE THE WORK IS COMPLETED A REVISED PLAN OR STATEMENT FROM THE PERMIT HOLDER SHALL BE SUBMITTED TO THIS OFFICE SHOWING OR EXPLAINING THAT THE CONDITIONS HAVE BEEN MET. IF THIS REQUIREMENT IS NOT RECEIVED YOUR CERTIFICATE OF OCCUPANCY SHALL BE WITHHELD. (You Shall Call for Inspections)**

******ALL PLANS THAT REQUIRE A PROFESSIONAL DESIGNER'S SEAL, (AS PER SECTION 114.0 OF THE BUILDING CODE) SHALL ALSO BE PRESENTED TO THIS DIVISION ON AUTO CAD LT. 2000, DXF FORMAT OR EQUIVALENT.**

*******CERTIFICATE OF OCCUPANCY FEE \$50.00**

UNIT DEED

File
Condo 7
Condo
38, 39, 40,
Garage Tit


GARAGE ASSOCIATES of Portland, a Maine limited partnership with its principal place of business at Portland, County of Cumberland, State of Maine, in consideration of One Dollar and other valuable consideration, grants to A-4 Realty Associates of Maine, a New Hampshire partnership, whose mailing address is 177 High Street, Portland, Maine 04101, with Warranty Covenants, the Units ("Units") designated as Unit 7, Unit 38, Unit 39, Unit 40 and Unit 41 of The Gateway, a Condominium located in the City of Portland, County of Cumberland and State of Maine ("Condominium") created pursuant to the provisions of the Maine Condominium Act, (the "Act") by The Gateway, a Condominium, Declaration of Condominium, dated December 1, 1986 and recorded in the Cumberland County Registry of Deeds, Book 7621, Page 103, as amended by a First Amendment to Declaration of Condominium dated March 9, 1987, and recorded in said Registry, Book 7669, Page 212 (collectively hereinafter called the "Declaration") and by the Plats and Plans incorporated into the Declaration and recorded therewith in the Cumberland County Registry of Deeds. The Units are subject to and have the benefit of the Declaration, the Plats, Plans and the Act which are incorporated herein by reference, to which reference is hereby made for a more particular description of the real property hereby conveyed and of the rights, obligations, easements, development rights, special Declarant rights, air rights, restrictions, covenants and conditions pertaining thereto. The Units are conveyed subject to such taxes and assessments, including Common Expenses, allocable to the Units, if any, as are not due and payable on the date of delivery of this deed.

Units 38, 39, 40 and 41 are hereby conveyed subject to the right hereby reserved of Garage Associates of Portland, its successors and assigns, to take full and complete possession of such units for a period of not more than 24 consecutive months in order to facilitate construction activities in or relating to Unit 9, the common elements, and/or on adjoining property; provided, however, that, during such period of possession, Garage Associates of Portland, its successors and assigns, as owner of Unit 9, shall provide 4 parking spaces for use by Grantee in Unit 9 of The Gateway, a Condominium.

IN WITNESS WHEREOF, Garage Associates of Portland has caused this instrument to be signed by High Street Development.

Corporation, its General Partner, by its officer hereunto duly authorized, this 10th day of November, 1987.

Signed, Sealed and Delivered
in the Presence of:

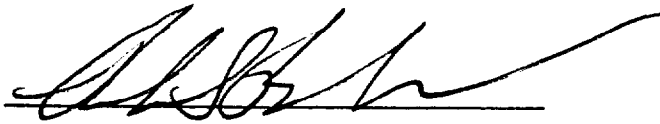

GARAGE ASSOCIATES OF PORTLAND
By High Street Development
Corporation, Its General Partner

By: Timothy M. O'Neil
Its Vice President



STATE OF MAINE
CUMBERLAND, ss.

November 10, 1987.

Personally appeared before me the above-named TIMOTHY M. O'Neil, Vice President of said High Street Development Corporation, and acknowledged the foregoing to be his free act and deed in his said capacity and the free act and deed of said Corporation.



Notary Public/Attorney-at-Law

BRUCE M. TOMPKINS

JOB WORKSHEET

Cover letter / Construction detail

Area 1 Remove approximately 20' of non bearing wall
Build new 2x4 non-bearing wall according to plan. ✓
Relocate entrance door in new wall. ✓

Area 2 Remove shelving and built INS.
Build small 2x4 wall to form an office. ✓
Install office entrance door in that wall.

Area 3 Build 3 new 2x4 non-bearing walls to form a new office. ✓
Install 1 new office entrance door.

All walls being built are non-bearing, walls will be anchored to the floor and tops will be secured to the bottom of the steel trusses.

All walls will be sheet rocked with 1/2" (taped, sanded and painted)

JOB WORKSHEET

Electrical Detail

Area 1 Remove any wiring in walls to be taken down.
No new wiring in this area. *requires permit.*

Area 2 Reuse switch that is there and add 2 more ceiling lights.
Outlets on wall will be dropped 2'.

Area 3 Relocate switch to new wall and add 2 more ceiling lights.
Install 5 outlets in new walls.

JOB WORKSHEET

Cover letter / Construction detail

**Area 1 Remove approximately 20' of non bearing wall
Build new 2x4 non-bearing wall according to plan.
Relocate entrance door in new wall.**

**Area 2 Remove shelving and built INS.
Build small 2x4 wall to form an office.
Install office entrance door in that wall.**

**Area 3 Build 3 new 2x4 non-bearing walls to form a new office.
Install 1 new office entrance door.**

All walls being built are non-bearing, walls will be anchored to the floor and tops will be secured to the bottom of the steel trusses.

All walls will be sheet rocked with 1/2" (taped, sanded and painted)

JOB WORKSHEET


Electrical Detail

Area 1 Remove any wiring in walls to be taken down.
No new wiring in this area.

Area 2 Reuse switch that is there and add 2 more ceiling lights.
Outlets on wall will be dropped 2'.

Area 3 Relocate switch to new wall and add 2 more ceiling lights.
Install 5 outlets in new walls.

walls to be built
 walls to be removed

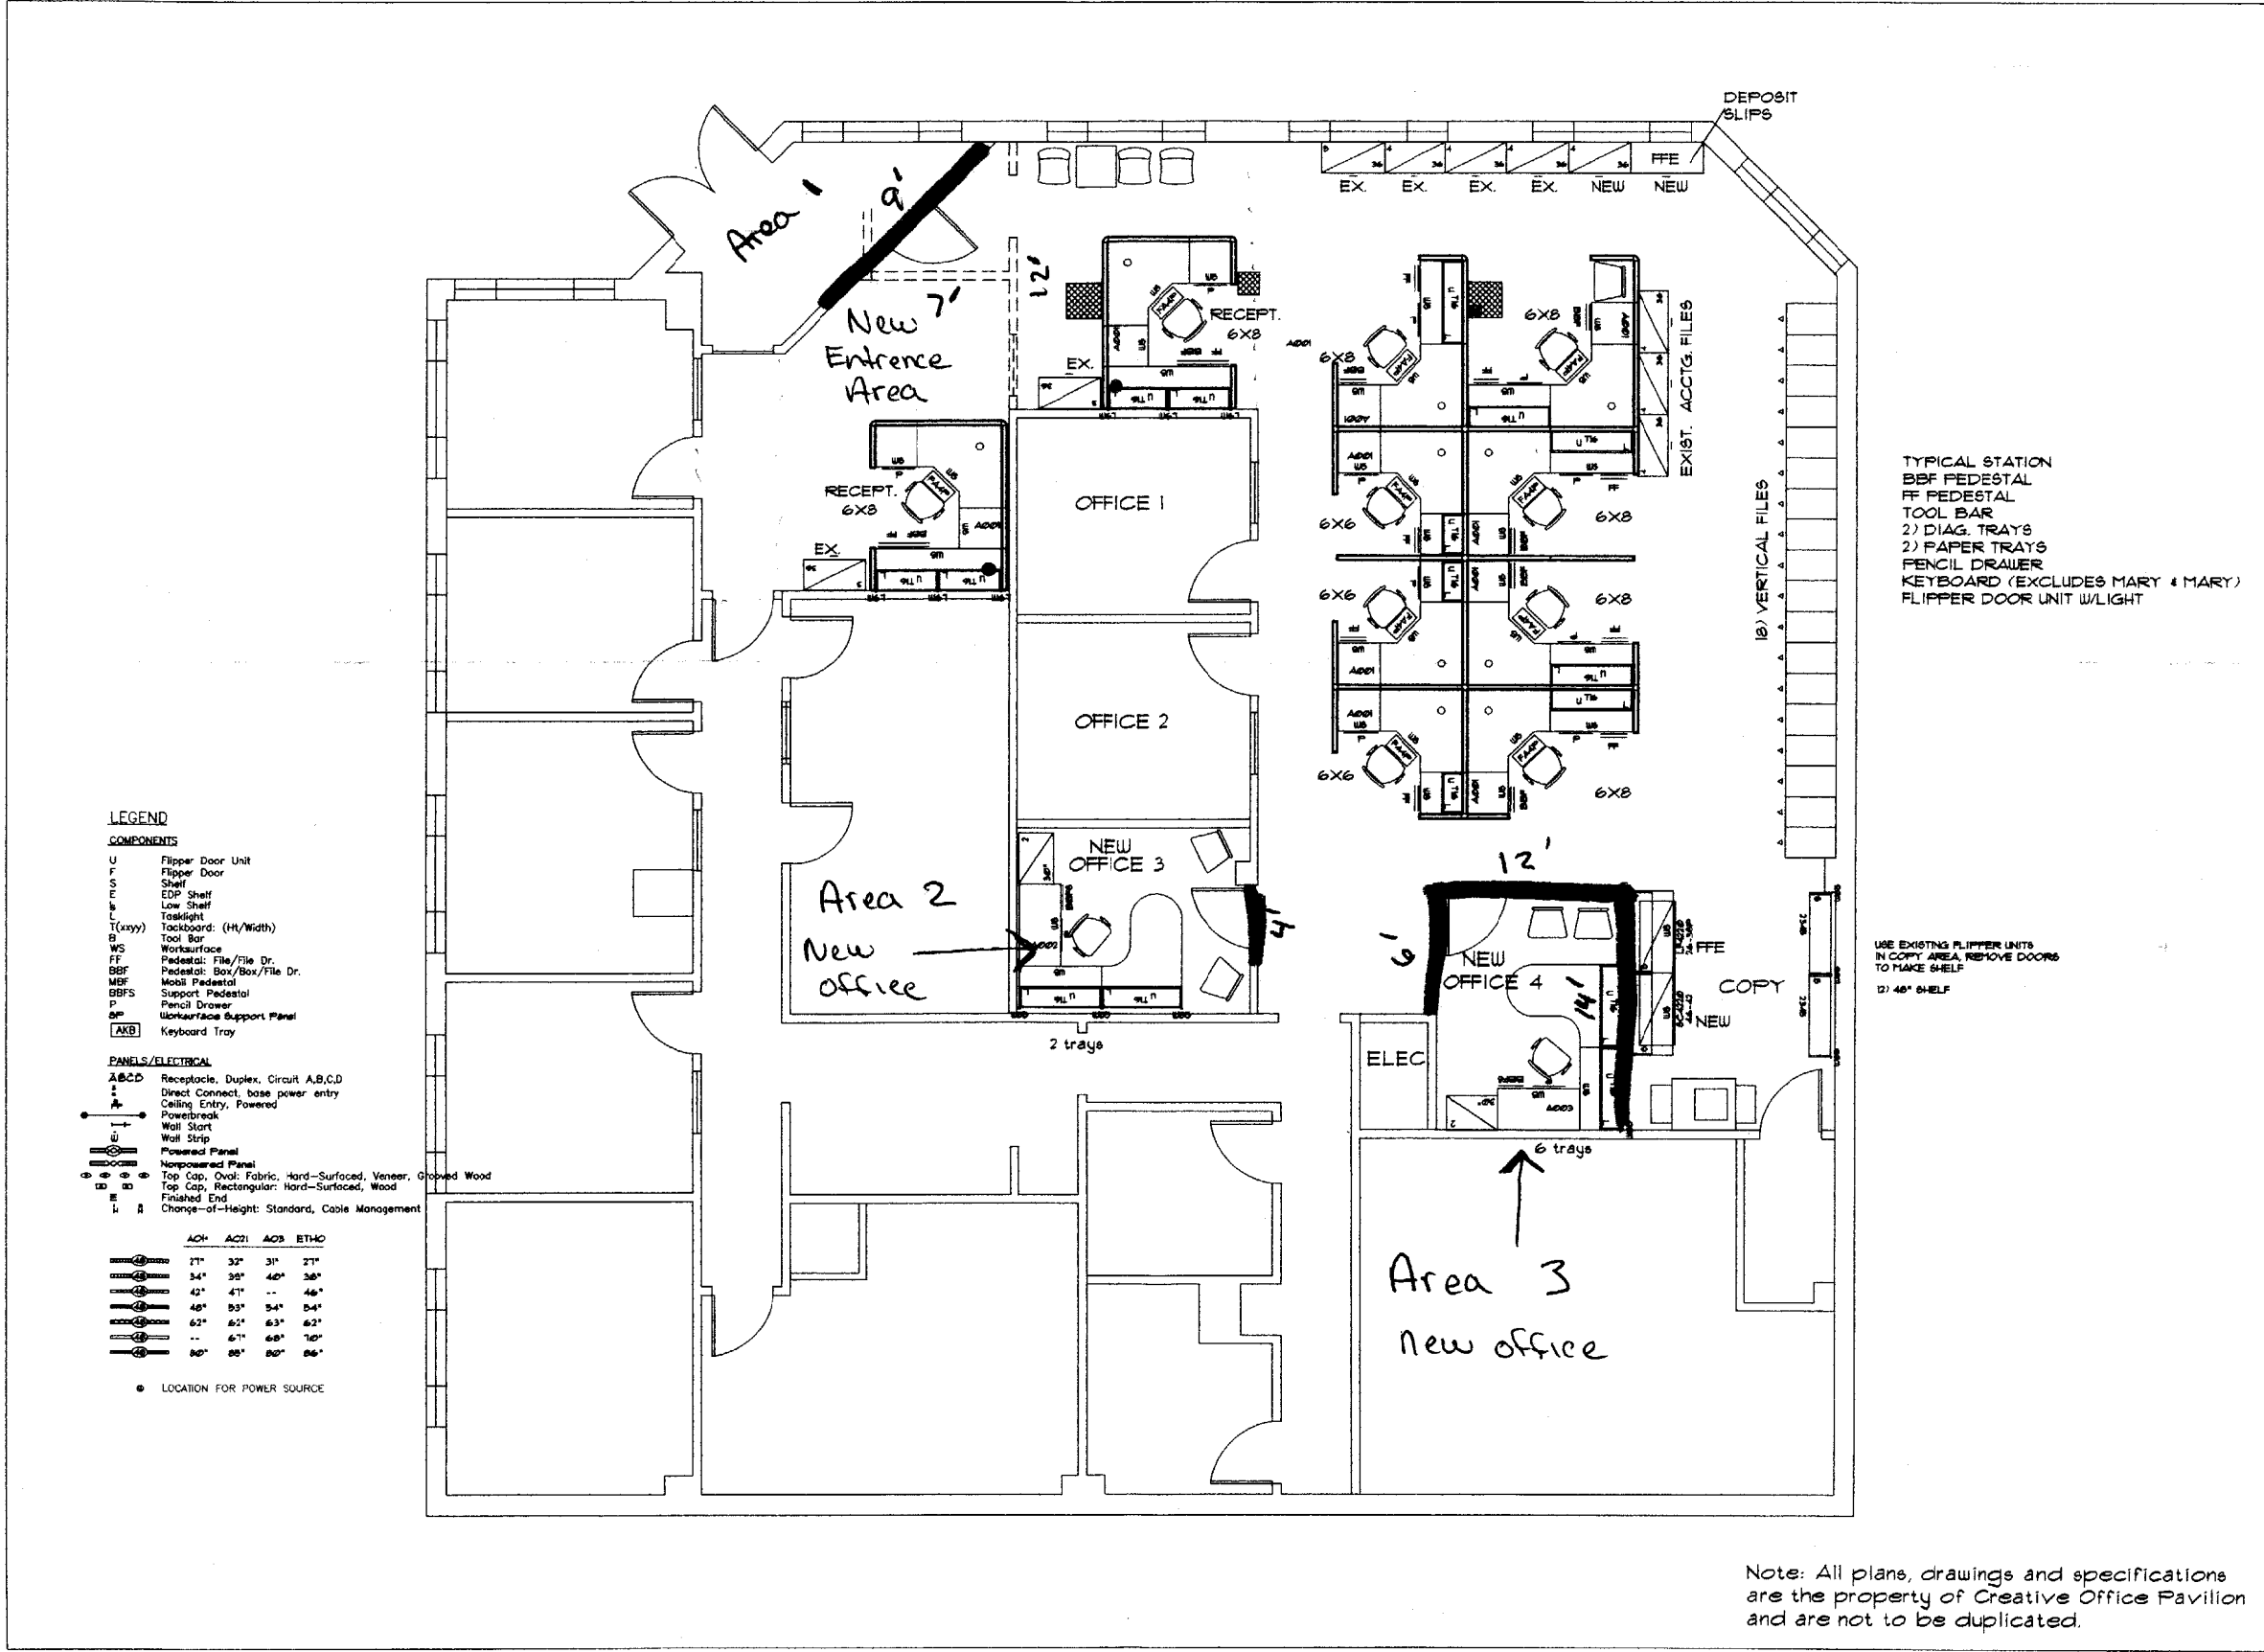

LEGEND

COMPONENTS

- U Flipper Door Unit
- F Flipper Door
- S Shelf
- E EDP Shelf
- L Low Shelf
- T(xxyy) Tasklight
- B Taskboard: (H/W) Width
- WS Worksurface
- FF Pedestal: File/File Dr.
- BBF Pedestal: Box/Box/File Dr.
- MBF Mod. Pedestal
- BBFS Support Pedestal
- P Pencil Drawer
- UP Worksurface Support Panel
- AKB Keyboard Tray

PANELS/ELECTRICAL

- ABCD Receptacle, Duplex, Circuit A,B,C,D
- Direct Connect, base power entry
- Ceiling Entry, Powered
- Powerbreak
- Wall Start
- Wall Strip
- Powered Panel
- Nonpowered Panel
- Top Cap, Oval: Fabric, Hard-Surfaced, Veneer, Grooved Wood
- Top Cap, Rectangular: Hard-Surfaced, Wood
- Finished End
- Change-of-Height: Standard, Cable Management

AC1	AC2	AC3	ETH40
21"	30"	31"	21"
34"	35"	40"	30"
42"	41"	44"	44"
48"	53"	54"	54"
62"	62"	63"	62"
67"	67"	70"	70"
80"	80"	80"	86"

● LOCATION FOR POWER SOURCE



15 FRANKLIN STREET
 PORTLAND, MAINE 04101
 207.715.7100

WISHCAMPER PROPERTIES

177 HIGH STREET
 PORTLAND, MAINE

SCALE: 1/8" = 1'-0"

DATE: 2/22/01

DRAWN BY: JBK

SALES:

PROJECT MGR:


REVISIONS:
 2/22/01
 5/2/01
 5/8/01

PROJECT NAME:
 WISHCAMP

FURNITURE
 PLAN

Note: All plans, drawings and specifications are the property of Creative Office Pavilion and are not to be duplicated.

walls to be built
 walls to be removed

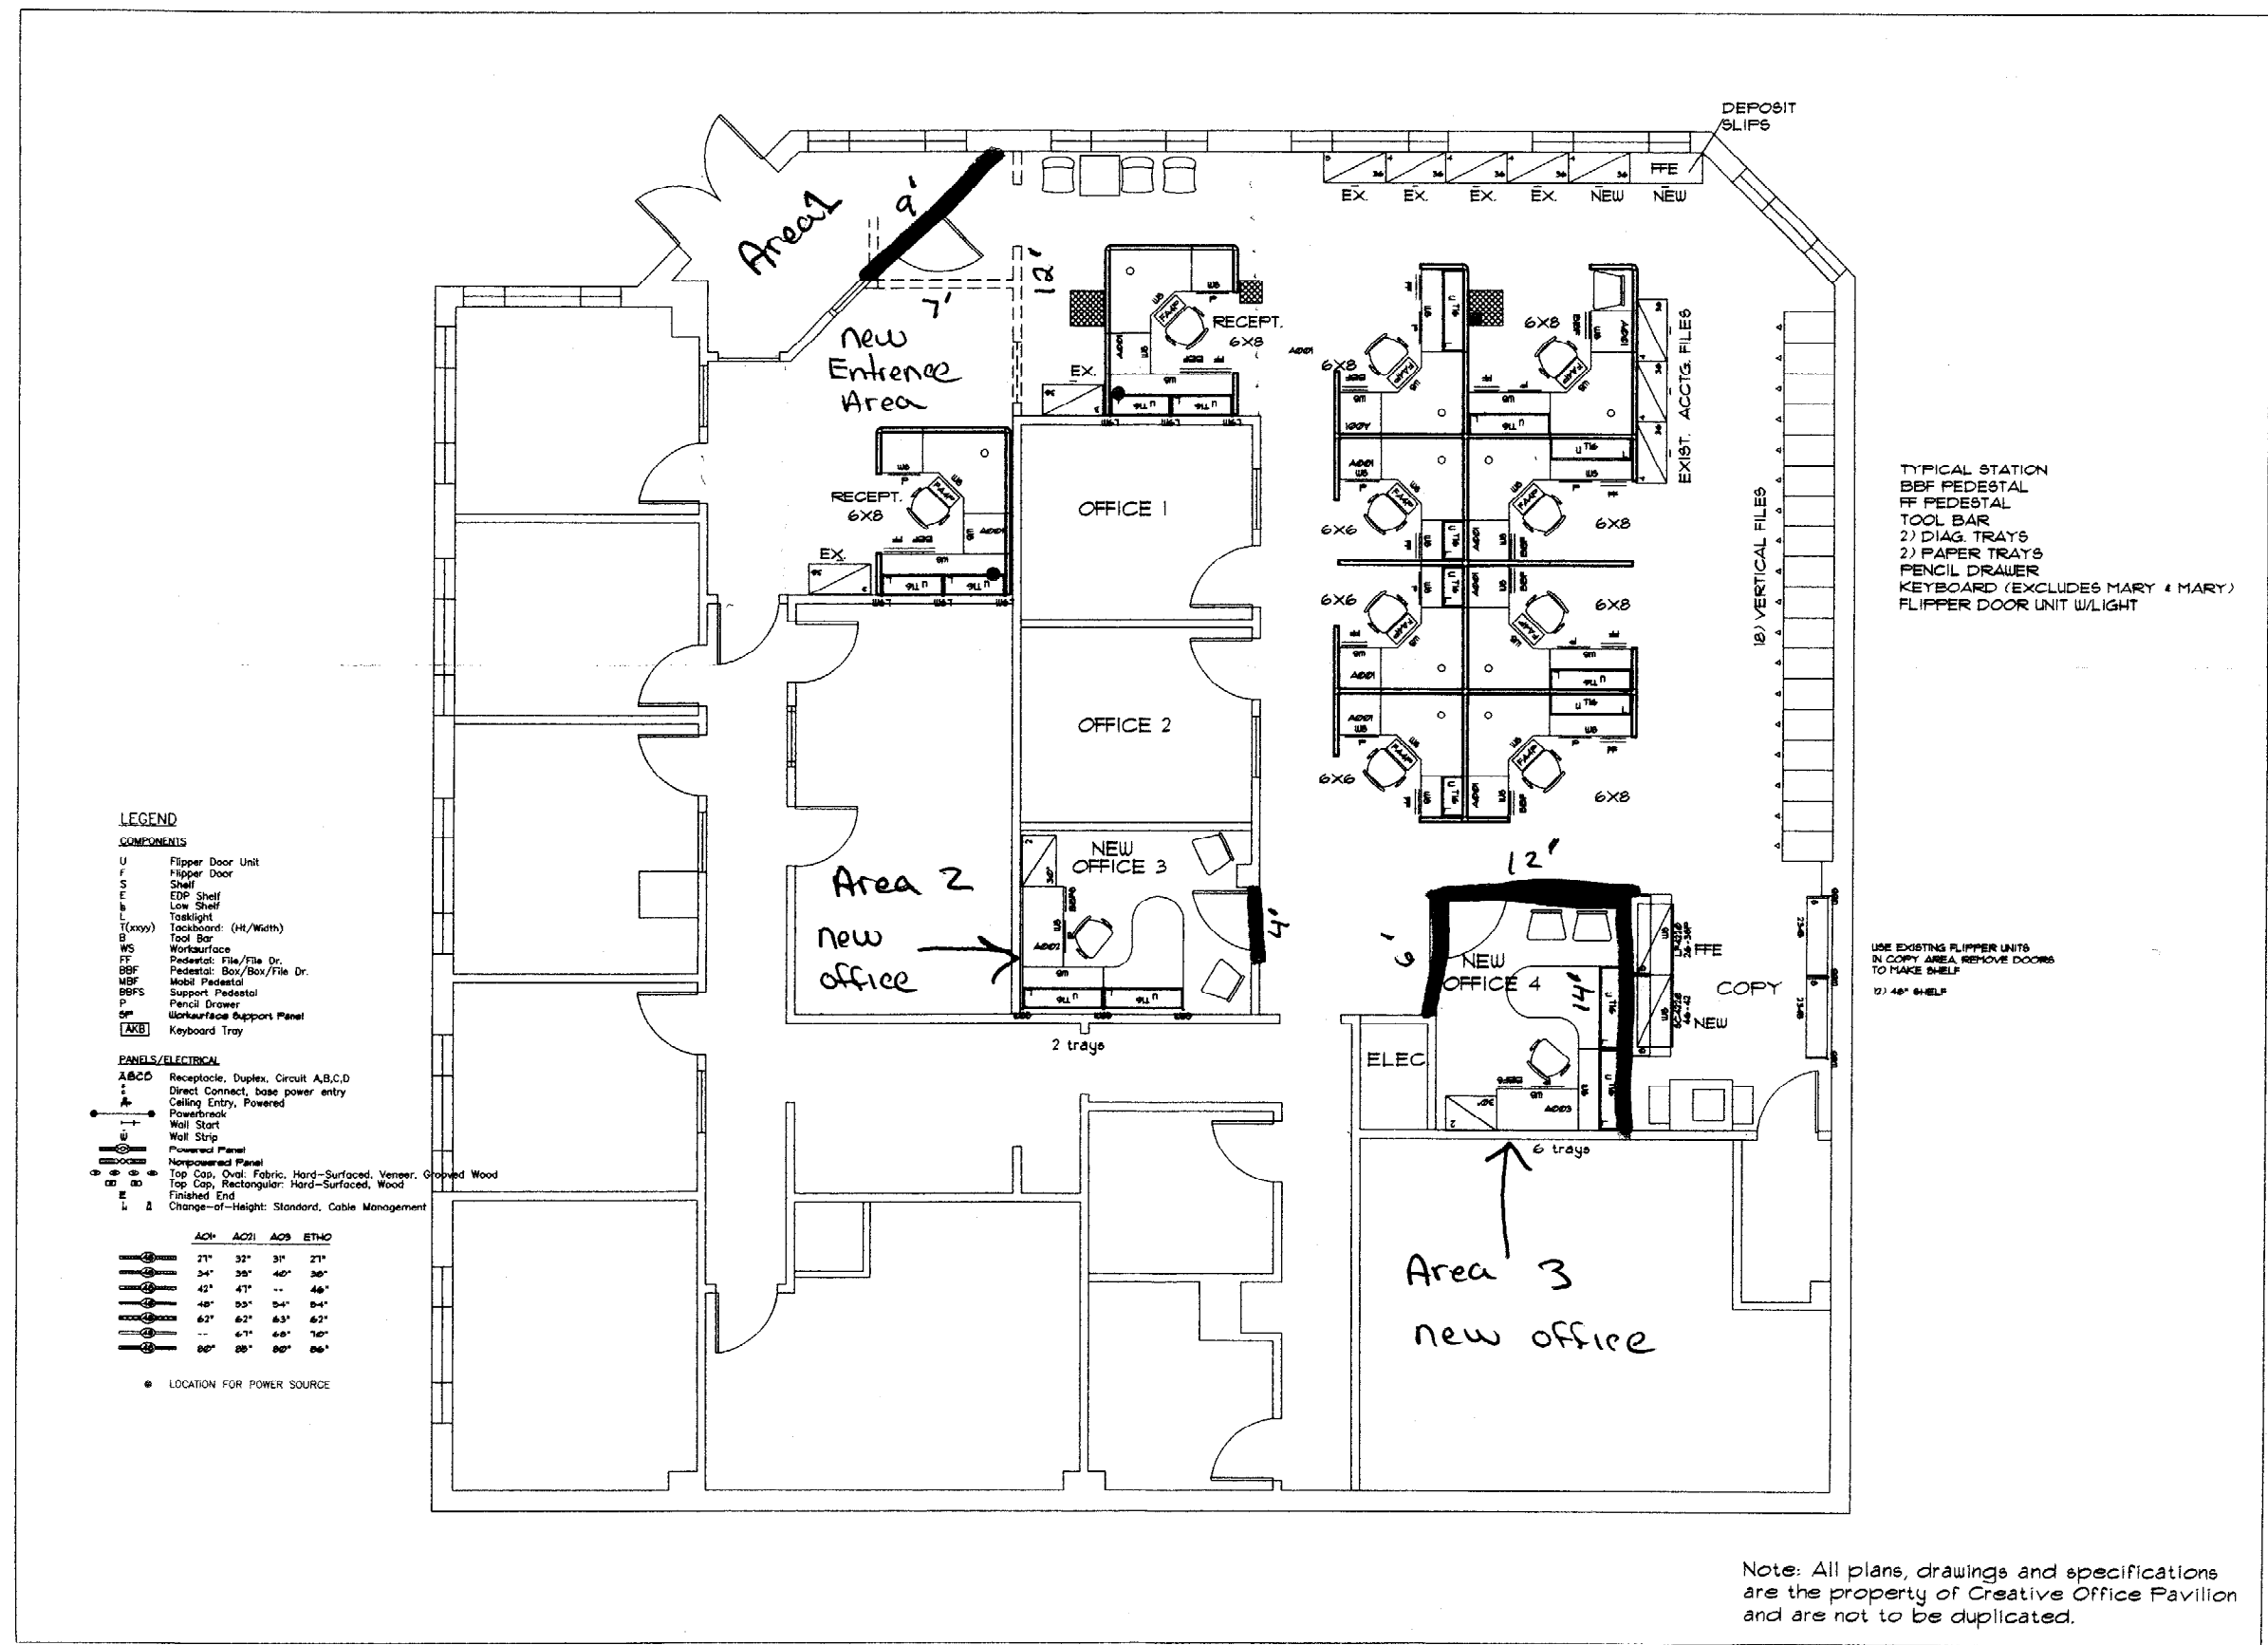

WISHCAMPER PROPERTIES
 177 HIGH STREET
 PORTLAND, MAINE

SCALE: 1/8" = 1'-0"
 DATE: 2/22/01
 DRAWN BY: JBK
 SALES:
 PROJECT MGR:
 REVISIONS:
 2/22/01
 5/12/01
 5/18/01
 PROJECT NAME: WISHCAMP

FURNITURE PLAN

Note: All plans, drawings and specifications are the property of Creative Office Pavilion and are not to be duplicated.



15 FRANKLIN STREET
 PORTLAND, MAINE 04101
 207.775.1100

WISHCAMPER PROPERTIES

117 HIGH STREET
 PORTLAND, MAINE

SCALE:
 1/8" = 1'-0"

DATE:
 2/22/01

DRAWN BY:
 JBK


SALES:

PROJECT MGR:

REVISIONS:
 2/22/01
 5/2/01
 5/8/01

PROJECT NAME:
 WISHCAMP

FURNITURE
 PLAN

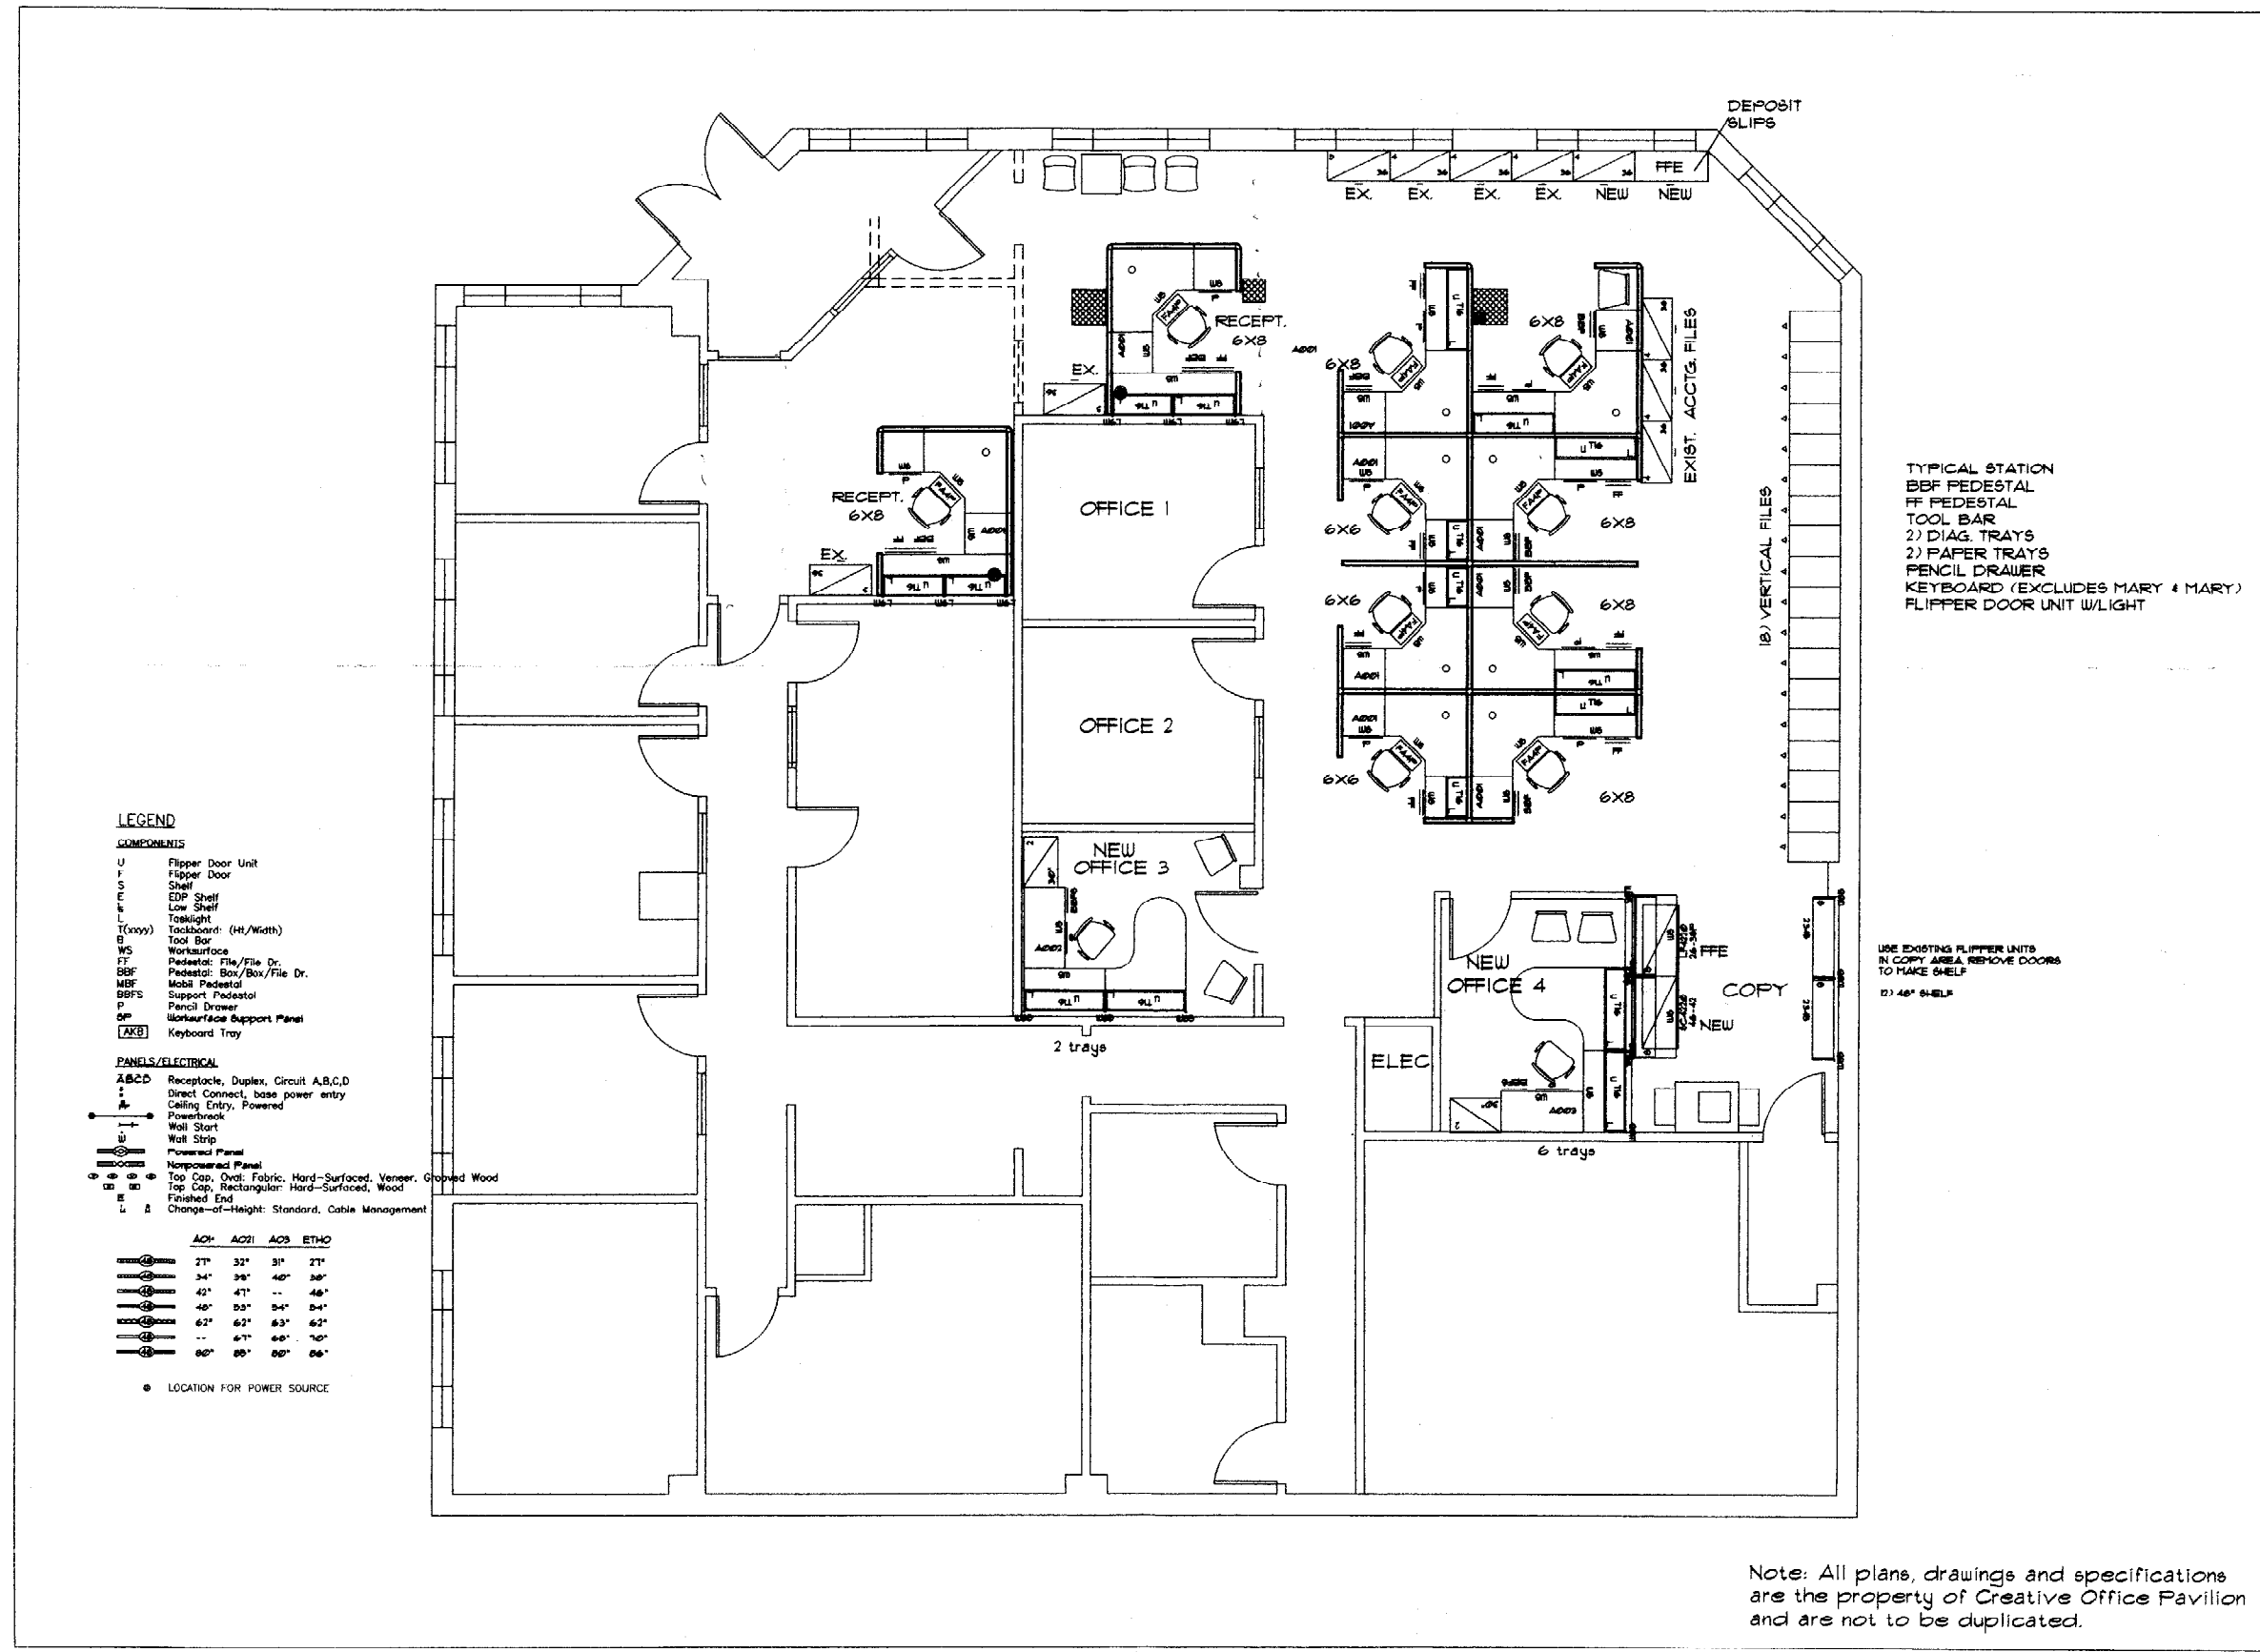

LEGEND

COMPONENTS

- U Flipper Door Unit
- F Flipper Door
- S Shelf
- E DFP Shelf
- L Low Shelf
- T Tasklight
- T (Tray) Tasklight
- B Tool Bar
- WS Worksurface
- FF Pedestal: File/File Dr.
- BBF Pedestal: Box/Box/File Dr.
- MBF Mobil Pedestal
- BBFS Support Pedestal
- P Pencil Drawer
- SP Worksurface Support Panel
- AKB Keyboard Tray

PANELS/ELECTRICAL

- ABCD Receptacle, Duplex, Circuit A,B,C,D
- Direct Connect, base power entry
- ⌚ Ceiling Entry, Powered
- Powerbook, Powered
- Wall Start
- Wall Strip
- Powered Panel
- Nonpowered Panel
- Top Cap, Oval: Fabric, Hard-Surfaced, Veneer, Grooved Wood
- Top Cap, Rectangular: Hard-Surfaced, Wood
- Finished End
- Change-of-Height: Standard, Cable Management

ACO1	ACO2	ACS	ETHO
27"	32"	31"	27"
34"	39"	40"	36"
42"	47"	--	46"
48"	53"	54"	54"
62"	62"	63"	62"
--	67"	68"	70"
80"	80"	80"	86"

● LOCATION FOR POWER SOURCE

TYPICAL STATION
 BBF PEDESTAL
 FF PEDESTAL
 TOOL BAR
 2) DIAG. TRAYS
 2) PAPER TRAYS
 PENCIL DRAWER
 KEYBOARD (EXCLUDES MARY & MARY)
 FLIPPER DOOR UNIT W/LIGHT

USE EXISTING FLIPPER UNITS
 IN COPY AREA. REMOVE DOORS
 TO MAKE SHELF
 2) 48" SHELF


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15 FRANKLIN STREET
 PORTLAND, MAINE 04101
 207.775.7100

WISHCAMPER PROPERTIES

177 HIGH STREET
 PORTLAND, MAINE



TYPICAL STATION
 BBF PEDESTAL
 FF PEDESTAL
 TOOL BAR
 2) DIAG. TRAYS
 2) PAPER TRAYS
 PENCIL DRAWER
 KEYBOARD (EXCLUDES MARY & MARY)
 FLIPPER DOOR UNIT W/LIGHT

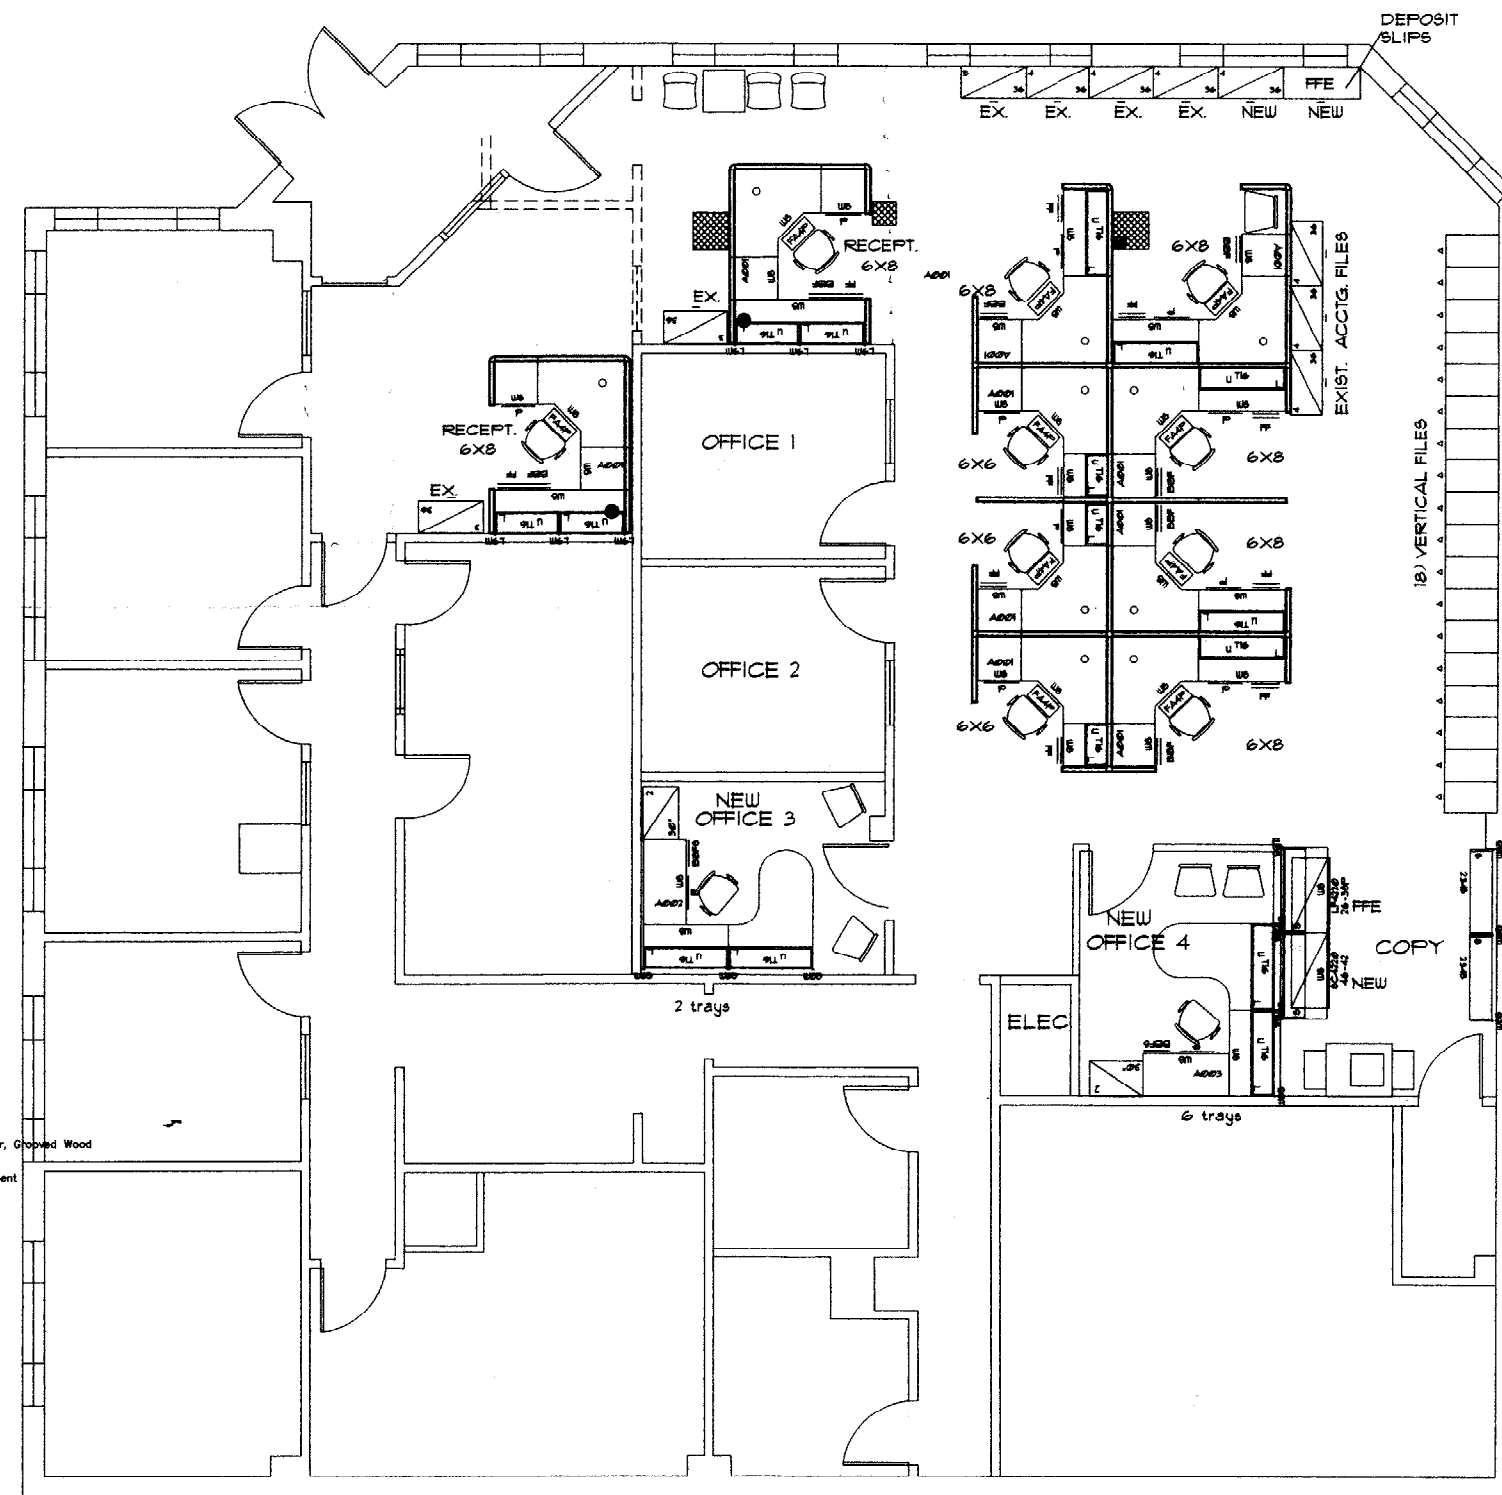USE EXISTING FLIPPER UNITS
 IN COPY AREA REMOVE DOORS
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 12\"/>

LEGEND

COMPONENTS

- U Flipper Door Unit
- F Flipper Door
- S Shelf
- E EDP Shelf
- L Low Shelf
- T (Excess) Tasklight
- B Taskboard: (Ht./Width)
- W Tool Bar
- WS Worksurface
- TF Pedestal: File/File Dr.
- BBF Pedestal: Box/Box/File Dr.
- MBF Mobil Pedestal
- SBFS Support Pedestal
- P Pencil Drawer
- SP Worksurface Support Panel
- AKB Keyboard Tray

PANELS/ELECTRICAL

- ABCD Receptacle, Duplex, Circuit A,B,C,D
- Direct Connect, base power entry
- Callout Entry, Powered
- Powerbreak
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● LOCATION FOR POWER SOURCE

C:\ACAD\Drawings\PC-5\Wishcamb.dwg Tue May 09 13:45:22 2001

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SCALE:	1/8" = 1'-0"
DATE:	2/22/01
DRAWN BY:	JBK
SALES:	
PROJECT MGR:	
REVISIONS:	2/22/01 5/2/01 5/8/01
PROJECT NAME:	WISHCAMP

FURNITURE PLAN