# APARTMENT RENOVATION

37 CASCO STREET AMBASSADOR APARTMENTS PORTLAND, MAINE

## PERMIT DRAWINGS

JULY 10, 2018

REVISED #1: 07-30-18 REVISED #2: 08-03-18



### **DRAWING LIST**

#### SHEET NUMBER

G0-0 TITLE SHEET

GENERAL NOTES, ABBREVIATIONS, AND LEGENDS G0-1

G1-0 BASEMENT CODE REVIEW PLAN G1-1

DOOR SCHEDULE

FIRST FLOOR CODE REVIEW PLAN

#### **ARCHITECTURAL**

A7-0

WALL TYPES **BASEMENT PLAN** A1-1 FIRST FLOOR PLAN STAIR DETAILS

ARCHITECT

RYAN SENATORE ARCHITECTURE

565 CONGRESS STREET, SUITE 304, PORTLAND, MAINE 04101 207-650-6414

1: DRAWING NOTES:

CONTRACTOR TO FURNISH AND INSTALL ALL NOTED LABOR AND MATERIALS UNLESS OTHERWISE NOTED.

2: CODE COMPLIANCE:
ALL WORK SHALL CONFORM TO THE LATEST EDITION OF STATE,

LOCAL AND OTHER CODES WHICH APPLY TO THIS PROJECT OR HAVE JURISDICTION.

3: COORDINATION:
IT IS THE RESPONSIBILITY OF THE CONTRACTOR TO COORDINATE
ALL DISCIPLINES AND TRADES SO THAT ALL BUILDING SYSTEMS
AND COMPONENTS CAN BE ASSEMBLED WITHOUT CONFLICTS. IN
THE EVENT THAT THE CONSTRUCTION DOCUMENTS DEFINE
CONDITIONS WHICH PROHIBIT, OR MAY PROHIBIT, SUCH
ASSEMBLY, THE CONTRACTOR SHALL BRING TO THE ARCHITECTS
ATTENTION, IN WRITING AND IN A TIMELY FASHION, SUCH
CONDITION. THE CONTRACTOR SHALL NOT PROCEED WITH
RELATED WORK WITHOUT A WRITTEN RESOLUTION

CLARIFICATION FROM THE ARCHITECT.
THE CONTRACTOR AND HIS/HER SUBCONTRACTORS SHALL BE
RESPONSIBLE FOR PROVIDING MATERIALS AND SYSTEMS SHOWN
IN THE CONSTRUCTION DOCUMENTS REGARDLESS OF WHERE
THE INFORMATION IS LOCATED. WHERE COMPONENTS OF A
SYSTEM ARE INDICATED THE CONTRACTOR SHALL BE
RESPONSIBLE FOR PROVIDING ALL LABOR AND MATERIALS

4: DISCREPANCIES & CLARIFICATIONS:

NECESSARY TO COMPLETE THE SYSTEM.

THIS PROJECT INVOLVES THE FIT-UP OF AN EXISTING BUILDING. EXISTING DIMENSIONS SHOWN ON THE DRAWINGS ARE BELIEVED TO BE ACCURATE, BUT CANNOT BE GUARANTEED, MEASURE AND VERIFY DIMENSIONS IN FIELD PRIOR TO FABRICATION AND CONSTRUCTION. IT IS THE RESPONSIBILITY OF THE CONTRACTOR TO BRING TO THE ARCHITECTS ATTENTION, IN WRITING, ANY DISCREPANCIES OR AMBIGUITIES IN THE DRAWINGS AND/OR SPECIFICATIONS. THE CONTRACTOR SHALL NOT PROCEED WITH RELATED WORK WITHOUT A WRITTEN RESOLUTION OR CLARIFICATION FROM THE ARCHITECT.

5: LAYOUT:
UNLESS INDICATED OTHERWISE, CENTER WALL FRAMING AND
PARTITION FRAMING ON COLUMN LINES. FLOOR PLAN
DIMENSIONS ARE TO CENTER OF FRAMING, FACE OF CONCRETE,
FACE OF CMU, OR FROM COLUMN CENTERLINES, UNLESS
INDICATED OTHERWISE. DOORS AND WINDOWS ARE
DIMENSIONED TO CENTERLINES UNLESS INDICATED OTHERWISE

6: CENTERING:
UNLESS INDICATED OTHERWISE, CENTER BUILDING ELEMENTS
WITHIN OR BETWEEN OTHER BUILDING ELEMENTS WHEN
CONDITIONS OR THE DRAWINGS INDICATE OR IMPLY THAT SUCH IS
THE INTENT, WHETHER OR NOT DIMENSIONS ARE INCLUDED

7: SYMMETRY:
WHERE CONDITIONS OR THE DRAWINGS INDICATE OR IMPLY THAT
SYMMETRY IS INTENDED, INFORMATION PROVIDED AT ONE SIDE
APPLIES EQUALLY TO BOTH SIDES, UNLESS CONDITIONS CLEARLY
PRECLUDE SUCH APPLICATION.

8: ACCESSIBILITY:
ALL HANDICAPPED ACCESSIBLE BATHROOMS, GRAB BARS, AND DOOR OPENINGS SHALL MEET THE REQUIREMENTS OF TITLE 94-348, CHAPTER 5 OF THE MAINE HUMAN RIGHTS COMMISION TITLE LATEST EDITION & THE DEPARTMENT OF JUSTICE ADA STANDARDS FOR ACCESSIBLE DESIGN.

9: DRAWING SCALES:
WORK FROM THE GIVEN DIMENSIONS ONLY. SCALE IS INDICATED
ON THE DRAWINGS FOR CONVENIENCE ONLY. IT IS NOT INTENDED
THAT INFORMATION BE DETERMINED BY SCALING THE DRAWINGS
SINCE SOME ITEMS MAY NOT BE TO SCALE.

10: WATER-RESISTANT GWB:
INSTALL WATER-RESISTANT GYPSUM WALL BOARD IN ALL REST

ROOMS & TOILET ROOMS OR AT ANY WALL WITH PLUMBING FIXTURES.

10A: HIGH IMPACT GWB:

11: INTERIOR ELEVATIONS:
INTERIOR ELEVATIONS MAY BE REVERSED FROM AND/OR SIMILAR
TO ACTUAL CONDITIONS. SEE FLOOR PLANS FOR WINDOW AND
DOOR QUANTITIES AND LOCATIONS, FOR CASEWORK LAYOUTS,

INSTALL HIGH IMPACT GYPSUM WALL BOARD IN ALL STAIRWELLS

AND FOR MONITOR LOCATIONS.

12: BUILDING INSULATION:
PROVIDE AS INDICATED IN WALL SECTIONS AND IN ACCORDANCE WITH PARTITION TYPES, WHETHER OR NOT SHOWN IN DETAILS AND OTHER DRAWINGS. FOR CLARITY, INSULATION MAY NOT BE

13: BLOCKING:
INSTALL BLOCKING BEHIND ALL SURFACE-APPLIED FIXTURES
TRIM, CASEWORK, SHELVES, BRACKETS, TOILET ACCESSORIES,
CHAIR RAILS, PICTURE RAILS, GRAB BARS, BASE MOLDINGS, AND
AS OTHERWISE REQUIRED, WHEN SUCH ITEMS ARE APPLIED ON

SHOWN IN SOME CASES, EVEN IF IT IS TO BE PROVIDED.

14: PENETRATIONS AT STRUCTURAL MEMBERS:
BEFORE PENETRATING JOISTS, BEAMS OR OTHER STRUCTURAL
MEMBERS, CONSULT WITH THE ARCHITECT.

STUD WALLS.

15: DAMAGED WORK:
BUILDING OR SITE COMPONENTS WHICH ARE AFFECTED BY NEW
WORK, DEMOLITION, OR WHICH MAY BE DAMAGED BY THE
GENERAL CONTRACTOR OR ANY SUB-CONTRACTOR SHALL BE
REPLACED OR RESTORED TO ORIGINAL CONDITION AND COLOR
TO MEET THE APPROVAL OF THE ARCHITECT.

16: UTILITIES:
VERIFY THE SIZE AND LOCATION OF ALL UNDERGROUND UTILITIES
AND REPORT ANY DISCREPANCIES TO THE ARCHITECT IN
WRITING. DO NOT PROCEED WITH WORK UNTIL THE
DISCREPANCY HAS BEEN RESOLVED TO THE SATISFACTION OF
THE ARCHITECT.

17: RATED CONSTRUCTION:
PROVIDE RATED CONSTRUCTION AS REQUIRED BY CODE, AS SPECIFIED, AND AS INDICATED ON DRAWINGS. IT IS THE RESPONSIBILITY OF THE CONTRACTOR TO PROVIDE AND INSTALL ALL COMPONENTS REQUIRED TO CREATE SUCH RATED CONSTRUCTION, REGARDLESS OF WHETHER OR NOT SUCH COMPONENTS ARE INDICATED. PROVIDE CONTINUITY OF SUCH RATED CONSTRUCTION AROUND AND BETWEEN SPACES, INCLUDING AT CHASES AND AT FLOORS, TO MAINTAIN COMPLETE SEPARATIONS, EVEN IF NOT SPECIFICALLY INDICATED.

18: SHOP DRAWINGS:
SUBMIT SHOP DRAWINGS TO THE ARCHITECT FOR REVIEW PRIOR
TO FABRICATIONS. SUBMITTALS REQUIRED INCLUDE, BUT ARE
NOT LIMITED TO, SHOP DRAWINGS FOR ALL PREFABRICATED
CONCRETE, STEEL, MILLWORK & SIGNAGE, SAMPLES OF ALL
PROPOSED PAINTS, METALS, WALL COVERINGS, LAMINATES,
SOLID SURFACE MATERIALS, CERAMIC TILE, AND HARDWARE.
SUBMIT MANUFACTURERS' DATA FOR ALL LIGHTING SYSTEMS,
AND HARDWARE.

19: PERMITS:
THE GENERAL CONTRACTOR SHALL OBTAIN AND P

**20: INTERIOR FINISHES:** 

(INTERIOR FLAME SPREAD).

THE GENERAL CONTRACTOR SHALL OBTAIN AND PAY FOR ANY BUILDING PERMITS REQUIRED AND CARRY ANY INSURANCE COVERAGES REQUIRED.

ALL INTERIOR FINISHES AND FURNISHINGS ARE TO BE CLASS 'A'

21: ELECTRICAL DESIGN:
REFER TO ELECTRICAL DRAWINGS AND SPECIFICATIONS

FIRE-RATED AND ARE TO COMPLY WITH IBC CHAPTER-8

22: WASTE REMOVAL:
THE GENERAL CONTRACTOR SHALL DISPOSE OF ALL WASTE AND DEBRIS OFF THE PREMISES.

23: LANDLORD COORDINATION:
THE GENERAL CONTRACTOR MUST COORDINATE WITH THE
BUILDING OWNER ALL ACTIVITIES INCLUDING BUT NOT LIMITED
TO WORK WHICH WILL GENERATE EXCESSIVE NOISE AND
MODIFICATION TO UTILITIES. WORK MUST NOT INTERFERE
WITH EXISTING SMOKE DETECTORS, ALARMS OR BUILDING
SYSTEM MANAGEMENT.

24: TEMPORARY FACILITIES:
PROVIDE ALL TEMPORARY FACILITIES AND SERVICES,
CONSTRUCTION AND SUPPORT FACILITIES, AND SECURITY AND
PROTECTION AS NEEDED TO PROTECT NEW AND EXISTING
CONSTRUCTION FOR THE DURATION OF A COMPLETE
INSTALLATION.

25: FINAL CLEANING:
EMPLOY EXPERIENCED WORKERS FOR FINAL CLEANING.
CLEAN EACH SURFACE TO THE CONDITION EXPECTED IN A
COMMERCIAL BUILDING CLEANING PROGRAM.

26: MANUFACTURERS INSTRUCTIONS:
ALL MATERIALS & EQUIPMENT SHALL BE INSTALLED
ACCORDING TO MANUFACTURER'S SPECIFICATIONS.

27: GUARANTEE:
GUARANTEE: ALL MATERIALS AND WORKMANSHIP SHALL BE
GUARANTEED FOR A PERIOD OF ONE YEAR FROM THE DATE OF
FINAL ACCEPTANCE UNLESS OTHERWISE SPECIFIED FOR A
LONGER PERIOD OF TIME ON A CERTAIN ITEM.

28: ASBESTOS:
ALL MATERIAL USED FOR THE CONSTRUCTION OF THIS PROJECT, WHETHER BUILDING MATERIALS OR APPURTENANCES, SHALL BE NON-ASBESTOS CONTAINING MATERIAL.

29: HAZARDOUS FUMES:
THE GENERAL CONTRACTOR SHALL CONFIRM THAT ALL
MATERIAL AND FINISHES SPECIFIED AND THEIR FABRICATION
OR INSTALLATION WILL NOT RELEASE FUMES OR AROMAS
DURING CONSTRUCTION WHICH MAY BE A HAZARD OR
NUISANCE TO PERSONNEL.

30: PEST CONTROL:
SEAL AND CAULK AROUND ALL PENETRATIONS, CRACKS AND CREVICES AND ANY OPENINGS CAPABLE OF HARBORING INSECTS/RODENTS.

31. EXPOSED UTILITIES:
ALL EXPOSED UTILITY WIRES AND PIPES (ELE

ALL EXPOSED UTILITY WIRES AND PIPES (ELECTRICAL, PLUMBING, ETC.) SHALL BE INSTALLED IN A WAY THAT DOES NOT OBSTRUCT OR PREVENT THE CLEANING OF FLOORS, WALLS, AND CEILING AREAS. THEY SHALL BE INSTALLED A MINIMUM OF 6" OFF FLOORS AND 1" OFF WALLS, CEILINGS AND ADJACENT PIPES.

32. OWNER SUPPLIED EQUIPMENT: EQUIPMENT SUPPLIED BY THE OWNER AND INSTALLED BY THE GENERAL CONTRACTOR:I EQUIPMENT INFORMATION AND SPECIFICATIONS ARE TO BE THE MOST CURRENT AVAILABLE AT THE TIME OF DOCUMENTATION PREPARATION. THE GENERAL CONTRACTOR SHALL BE RESPONSIBLE FOR VERIFYING WITH THE OWNER THE EXACT DIMENSIONS AND EQUIPMENT CONNECTION REQUIREMENTS (INCLUDING ELECTRICAL CIRCUIT REQUIREMENTS) OF EQUIPMENT TO BE SUPPLIED. THE GENERAL CONTRACTOR SHALL MAKE ALL FINAL CONNECTIONS AS NOTED ON THE DRAWINGS, INSTALL THE SET UP IN WORKING ORDER, CHECK WARRANTIES, TEST AND NOT VOID WARRANTIES. THE GENERAL CONTRACTOR SHALL COORDINATE WITH THE OWNER DELIVERY, STORAGE AND INSTALLATION OF ALL OWNER SUPPLIED EQUIPMENT. THE GENERAL CONTRACTOR SHALL STORE EQUIPMENT IF REQUESTED BY THE OWNER UNTIL INSTALLATION. SEE DRAWINGS FOR OTHER OWNER SUPPLIED/GENERAL

CONTRACTOR INSTALLED ITEMS.

33: FIRE PROTECTION NOTE:
EXISTING SPRINKLERHEADS, ALARM SYSTEM AND DETECTORS
ARE TO BE MODIFIED TO CONFORM. WITH THE PROPOSED
PLAN. COORDINATE WITH THE ARCHITECT, ANY MODIFICATION
OR LOCATIONS WHERE EXISTING SYSTEMS ARE AFFECTED BY
THE NEW DESIGN.

34: SOILS AT FOOTINGS:
REPORT THE LOCATION OF ALL UNSUITABLE SOILS AND
MATERIALS BELOW ANTICIPATED LEVEL OF FOOTING TO THE
ARCHITECT PRIOR TO THE SETTING OF FORMS.

35: ACCESS PANELS:
CONTRACTOR IS RESPONSIBLE FOR COORDINATING QUANTITY
AND LOCATION OF ALL REQUIRED ACCESS PANELS FOR ALL
MEP CONTROLS, CLEANOUTS, DAMPERS, PULL BOXES, ETC.

36: EXISTING HAZARDOUS MATERIALS
ALL HAZARDOUS MATERIALS INCLUDING BUT NOT LIMITED TO
ASBESTOS AND LEAD PAINT ARE TO BE HANDLED,
ENCAPSULATED, ABATED AND DISPOSED OF IN ACCORDANCE
WITH ANY AND ALL FEDERAL, STATE AND LOCAL
REQUIREMENTS AND REGULATIONS.

37: INDUSTRY STANDARDS:
ALL WORK SHALL BE PERFORMED IN ACCORDANCE WITH INDUSTRY STANDARDS. STANDARDS INCLUDE BUT ARE NOT LIMITED TO THE FOLLOWING:

AAMA AMERICAN ARCHITECTURAL MANUFACTURERS ASSOCATION

ASSOCATION
ACI AMERICAN CONCRETE INSTITUTE
ANSI AMERICAN NATIONAL STANDARDS INSTITUTE
ASTM AMERICAN SOCIETY FOR TESTS AND MATERIALS
AWI ARCHITECTURAL WOODWORK INSTITUTE
"CUSTOM GRADE"

AWS AMERICAN WELDING SOCIETY

IGMA INSULATING GLASS MANUFACTURERS ALLIANCE


NAAMM NATIONAL ASSOCIATION OF ARCHITECTURAL METAL

MANUFACTURERS

NRCA NATIONAL ROOFING CONTRACTORS ASSOCIATION
NTCA NATIONAL TILE CONTRACTORS ASSOCIATION
SMACNA SHEET METAL AND AIR CONDITIONING NATIONAL
ASSOCIATION


ASSOCIATION
WDMA WINDOW AND DOOR MANUFACTURERS ASSOCIATION

**ABBREVIATIONS** AIR CONDITIONING LAB LAM LABORATORY AMINATED ACOUSTICAL CEILING TILE ARFA DRAIN AMERICANS WITH DISABILITIES ACT ADAAG LEFT-HAND CCESSIBILITY'S GUIDELINES LCC LEAD COATED COPPER ADDENDUM ABOVE FINISHED FLOOR MACH AIR-HANDLING UNIT **MASONRY** ALUMINUM MATERIAL ARCHITECT/ARCHITECTURAL ACOUSTIC WALL PANEL MAXIMIIN MEDIUM-DENSITY OVERLAY MECHANICAL **BACK-TO-BACK ANGLES** MEMBRANE ASE BUILDING GENERAL CONTRACTOR MEZZANINE MANUFACTURER BLOCKING MINIMUM BASEMENT **MISCELLANEOUS** TWEEN MO MTD MASONRY OPENING BY OTHERS MOUNTED COURSE (MASONRY) MARKER BOARD ORNER GUARD COAT HOOK NUMBER CONTROL JOINT **NOT IN CONTACT** ENTER LINE NOT TO SCALE CONCRETE MASONRY UNIT CONCRETE ON CENTER CONDITION OUTSIDE DIAMETER/OUTSIDE DIMENSION CONNECT/CONNECTION **OPNG** OPENING CONTINUOUS OPP OPP H OSB OZ CORRIDOR ORIENTED STRAND BOARD CABINET UNIT HEATER PBOIBC PURCHASED BY OWNER INSTALLED BY DRINKING FOUNTAIN CONTRACTOR PRECAST DIMENSION PLASTIC LAMINATE PREFABRICATE DRY STAND PIPE POUNDS PER SQUARE FOOT POUNDS PER SQUARE INCH PVC PWD POLYVINYL CHLORIDE PLYWOOD ENTRANCE PRESSURE TREATED PERFORATED QUIPMENT EXPANSION XPANSION BOLT **QUARRY TILE** QUARTER QTR EXPANSION JOINT THYLENE PROPYLENE DIENE MONOMER R ELECTRIC WATER COOLER RISER/RADIUS RUBBER BASE REFLECTED CEILING PLAN FIRE EXTINGUISHER AND CABINET REINFORCING BAR REFRIGERATOR FIRE EXTINGUISHER SEINIEORCED FIRE EXTINGUISHER CABINET FIRE TREATED WOOD RES RESILIENT **REVERSE** FACE OF BRICK ROUGH OPENING FACE OF CONCRETE RIGHT OF WAY FACE OF STUDS FIRE SUPPRESSION SYSTEM CHEDULE SQUARE FEET FIBER REINFORCED GYPSUM SPECIFICATION FIN TUBE RADIATION FUME HOOD STAINLESS STEEL SOUND TRANSMISSION CLASS STANDARD GALVANIZED STORAGE GRAB BAR STRUCTURE/STRUCTURAL SENERAL CONTRACTOR SUSPENSION GROUND-FAULT INTERRUPTER GLASS/GLAZING/GLAZED SLUE-LAMINATED WOOD TONGUE&GROOVE TELEPHONE GYPSUM WALL BOARD TOD TOS TOP OF DECK TOP OF STEEL TYPICAL **HANDICAP** TELEVISION HOLLOW METAL TACK BOARD HORIZ HORIZONTAL TOP OF CONCRETE HORSE POWER/HIGH POINT/HEAT PUMP HOT WATER JNDERWRITERS LABORATORIES, INC. HEATING VENTILATION AIR CONDITIONING UNIT VENTILATOR INSIDE DIMENSION/INSIDE DIAMETER INCHES VCT VINYL COMPOSITION TILE VERIFY IN FIELD INFO INSUL INFORMATION INSULATION VOL WITHOUT WOOD KILN-DRIED WIDE FLANGE 1000 POUNDS **WORK POINT** 

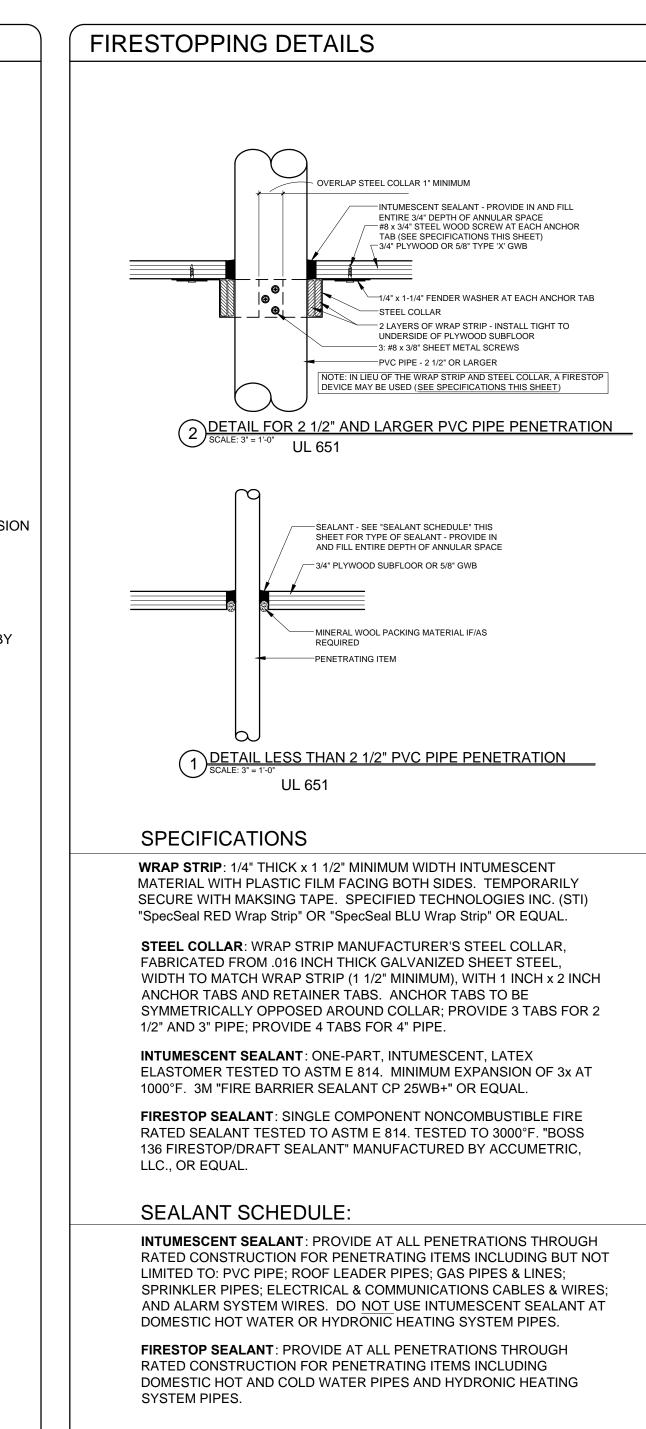

FOR LOCATIONS OF RATED CONSTRUCTION, SEE ARCHITECTURAL

FLOOR PLANS AND SECTIONS

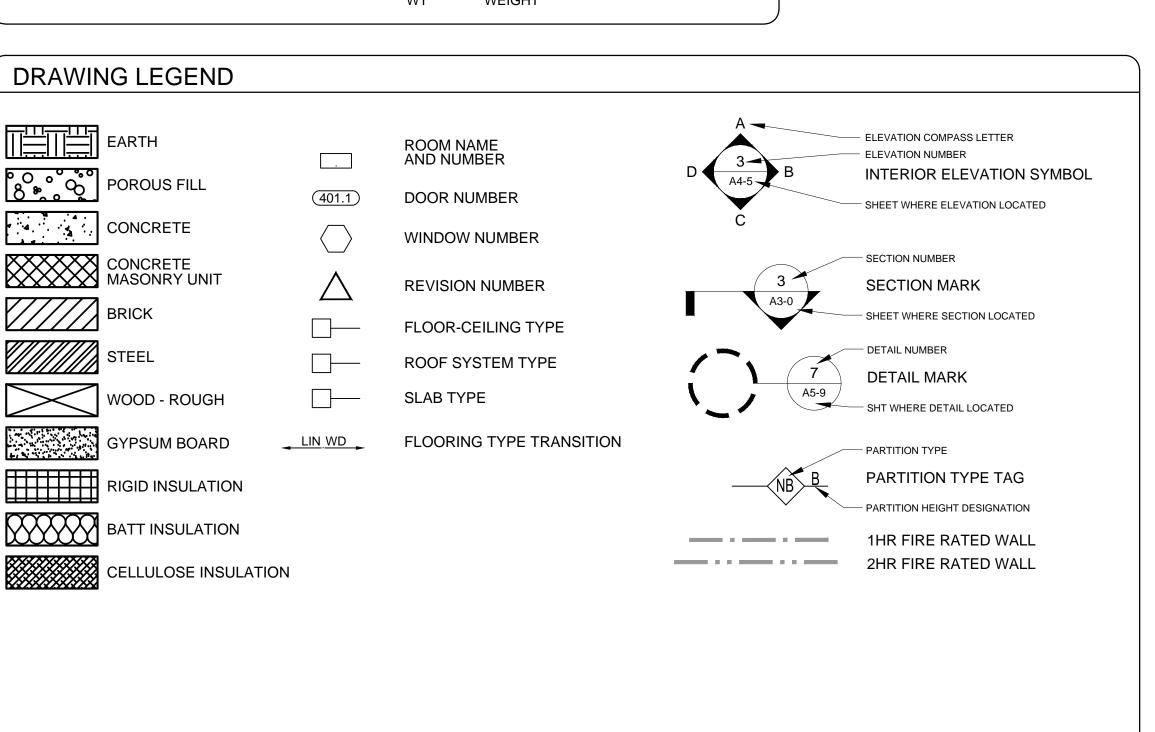



© 2018 RYAN SENATORE ARCHITECTURE

Reviewed for Code Compliance

Reviewed for Code Compliar ermitting and Inspections Deparaments Approved with Conditions 08/2 0/2018

EET - AMBASSADOR APARTME

TR

RYAN SENATORE
ARCHITECTURE
565 CONGRESS STREET
PORTLAND, MAINE 04101
207-650-6414
senatorearchitecture.com

CONSULTANTS:

REVISIONS:

DATE: JULY 10, 2017
PROJECT No. 1843
DRAWN BY: RRT
CHECKED BY: RJS
SCALE: AS NOTED

SHEET TITLE:

GENERAL NOTES

ABBREVIATIONS

G0-1





1 HOUR SEPARATION

FIRE EXTINGUSHER



SENATORE No. 3322

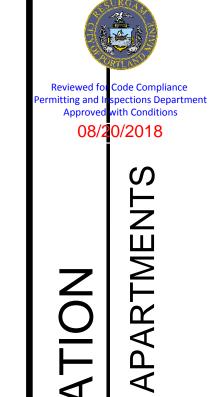

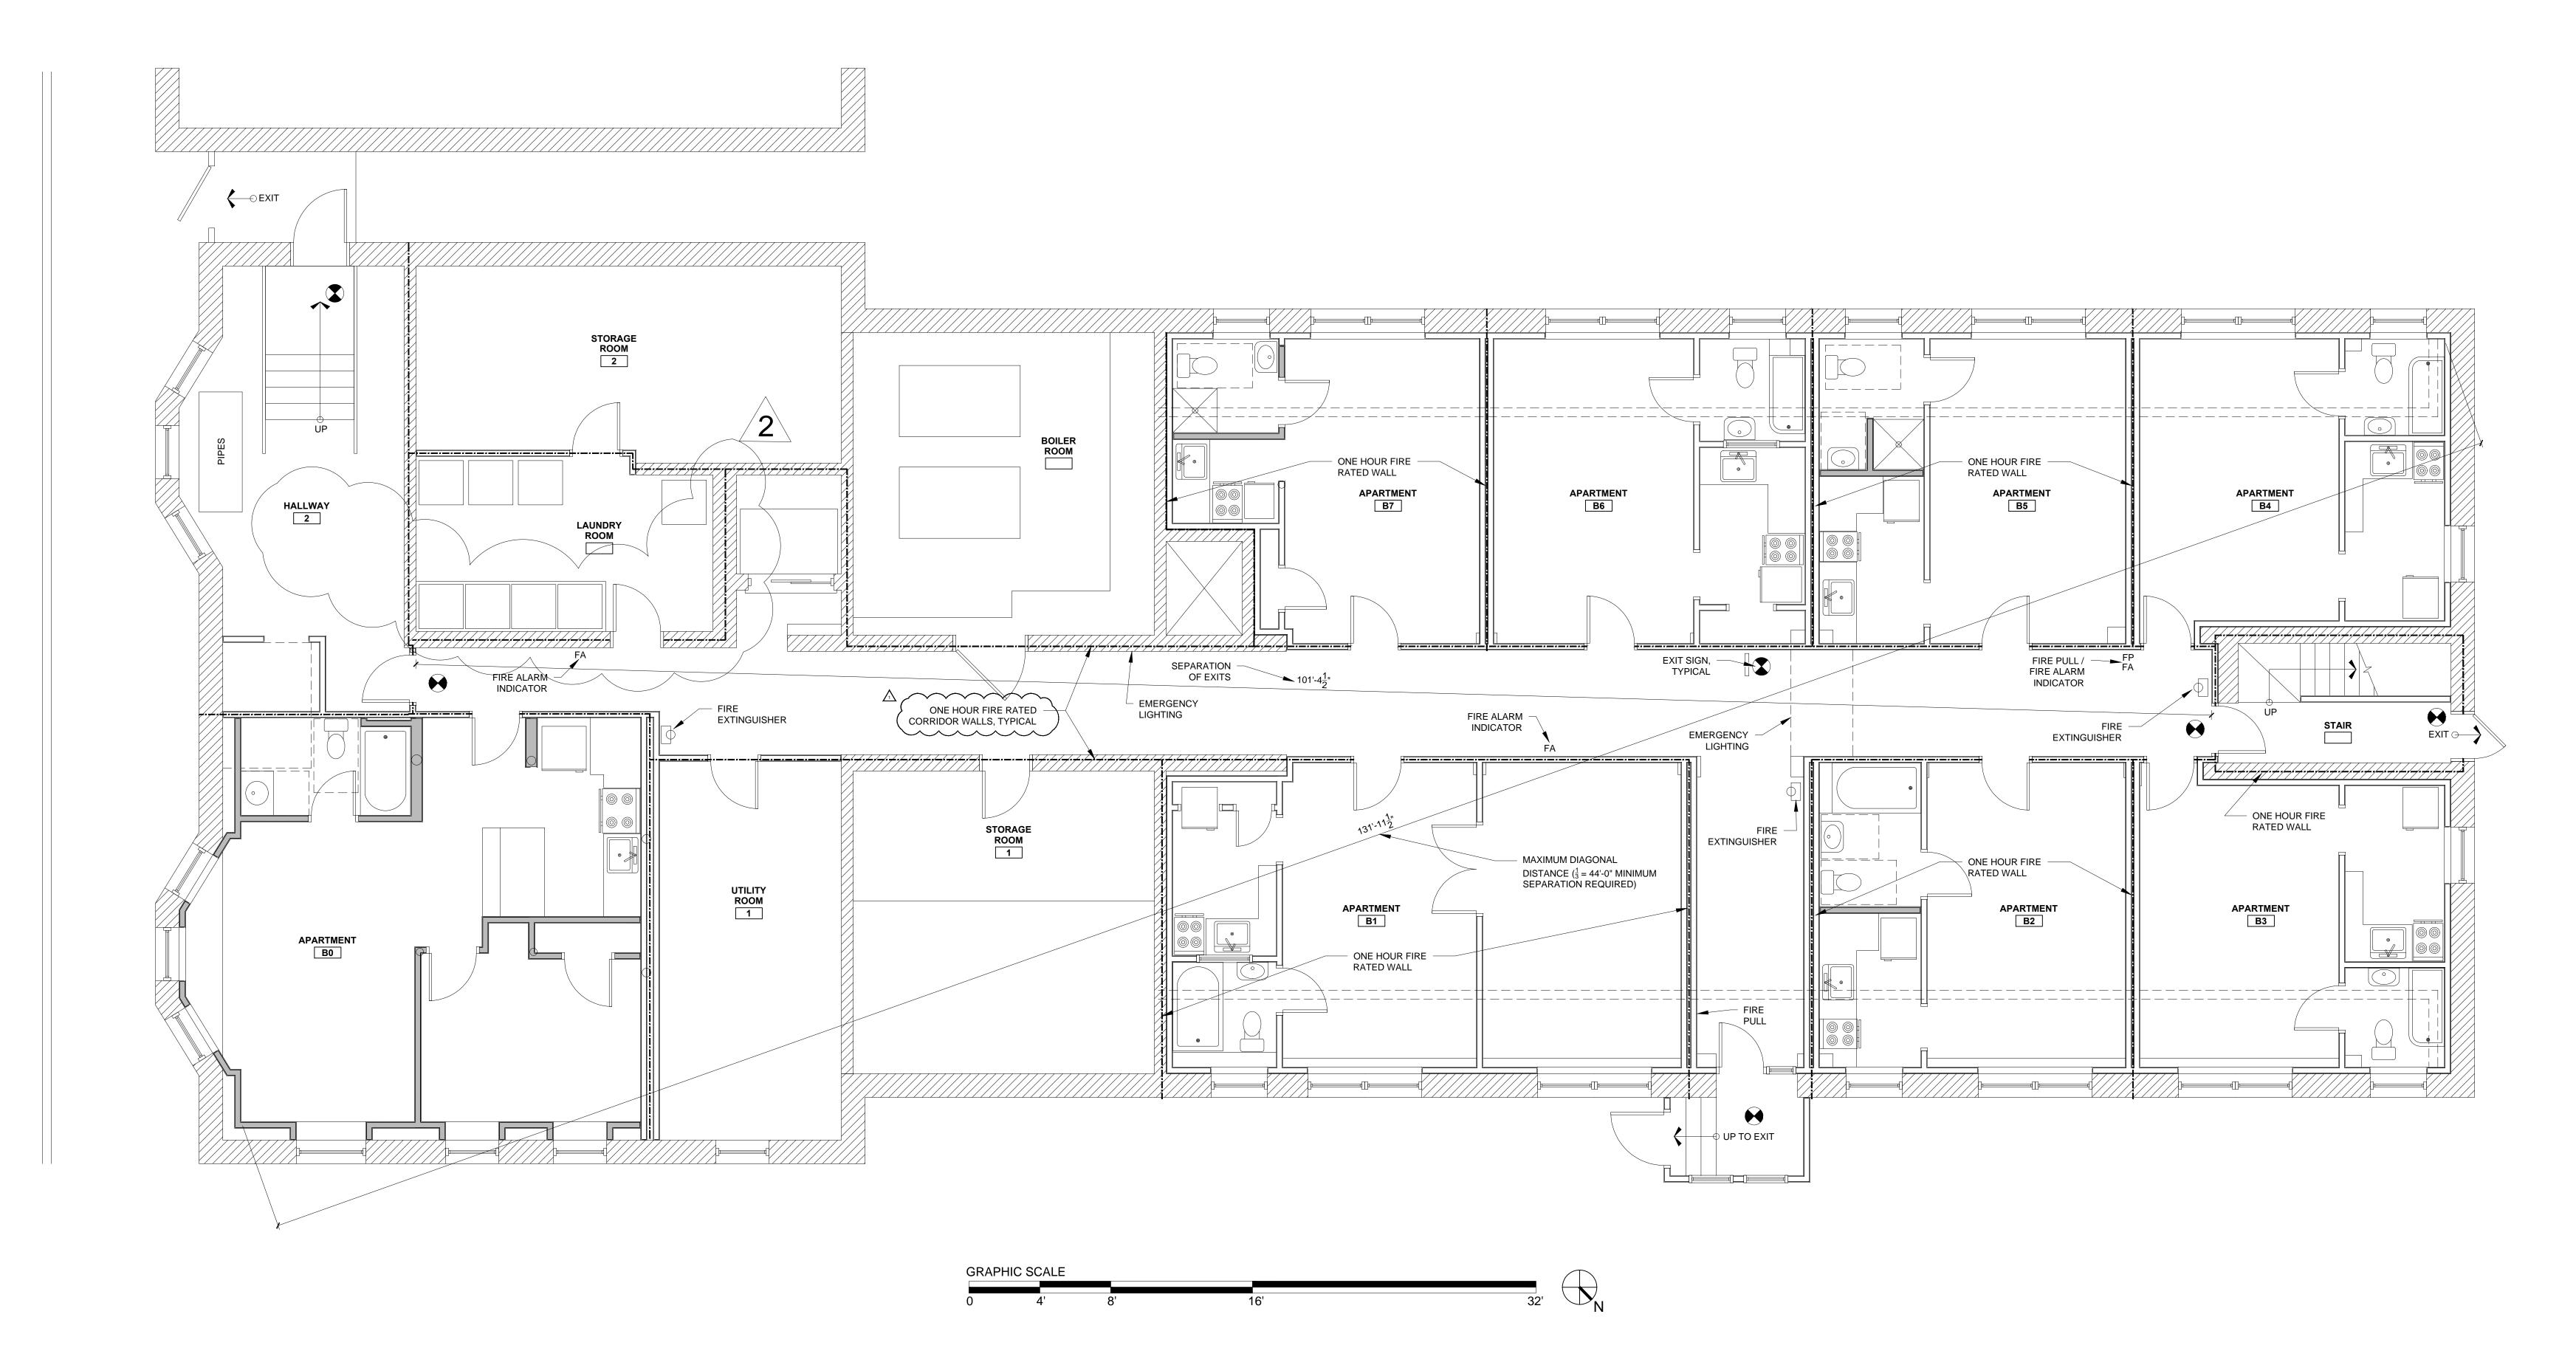

RYAN SENATORE ARCHITECTURE 565 CONGRESS STREET PORTLAND, MAINE 04101 207-650-6414 senatorearchitecture.com CONSULTANTS:

STREE

REVISIONS: REVISED #1: 07-30-18 REVISED #2: 08-03-18

DATE:	JULY 10, 2017						
PROJECT No.	1843						
DRAWN BY:	RRT						
CHECKED BY:	: RJS						
SCALE:	AS NOTED						
SHEET TITLE:							
BASEMENT							

CODE REVIEW PLAN

Port Property
MANAGEMENT

BASEMENT CODE REVIEW PLAN

1/4" = 1'-0" (WHEN PRINTED AT 30" X 42")

G1-0


FIRE EXTINGUSHER

RYAN J. SENATORE No. 3322

X

MENT RENOVA ET - AMBASSADOR A PORTLAND, ME

STREE

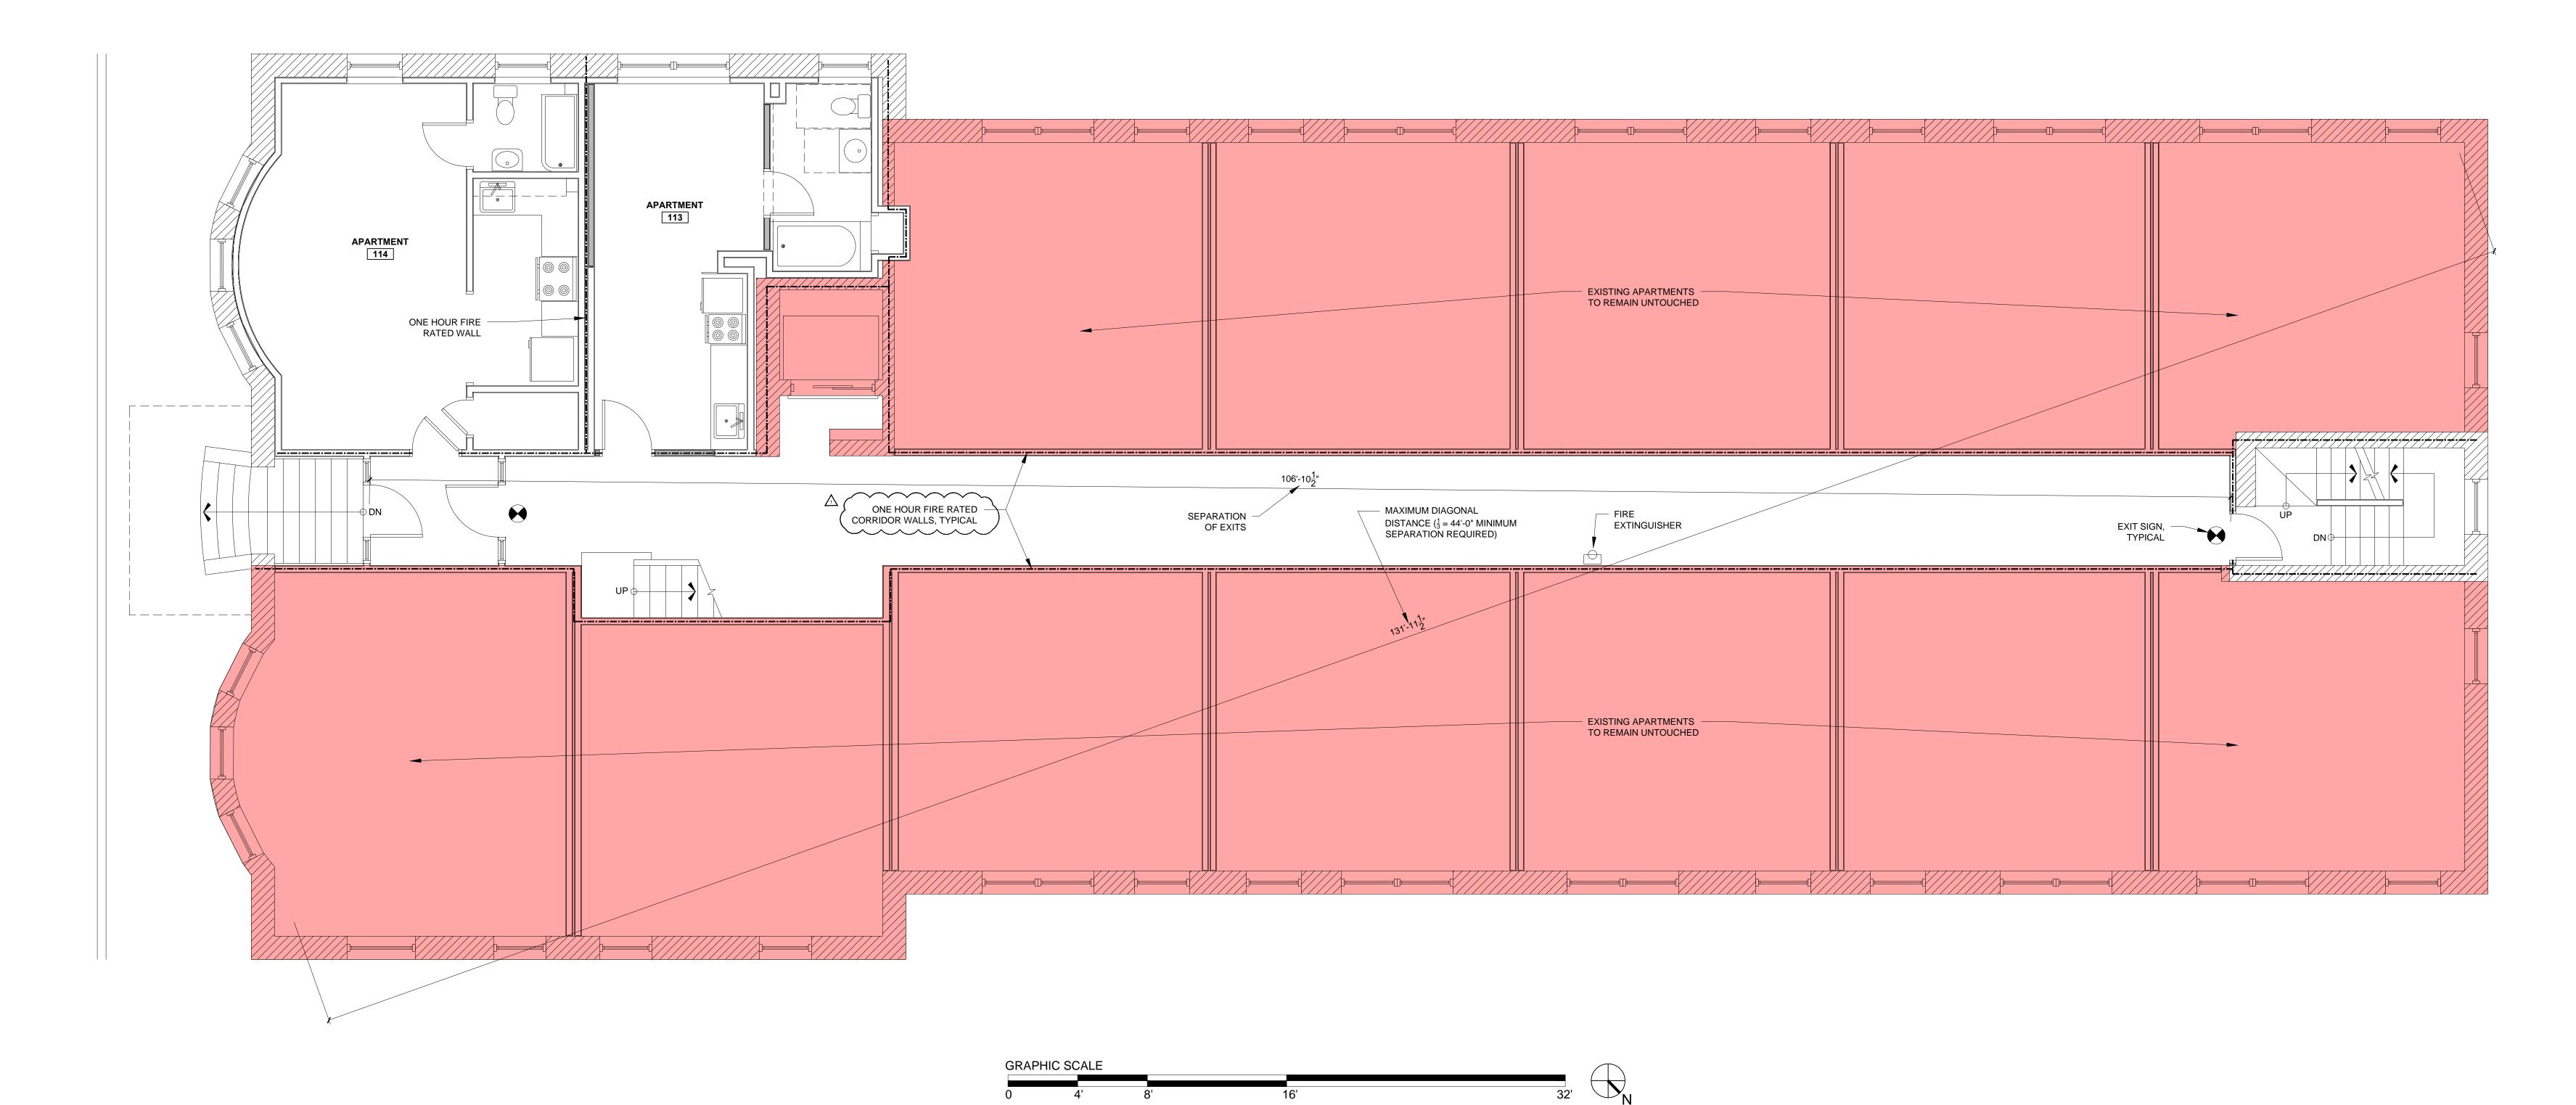

ARCHITECTURE 565 CONGRESS STREET PORTLAND, MAINE 04101 207-650-6414 senatorearchitecture.com CONSULTANTS:

REVISIONS:

REVISED #1: 07-30-18

DATE: JULY 10, 2017 PROJECT No. DRAWN BY:

SCALE: SHEET TITLE:


FIRST FLOOR CODE REVIEW PLAN

G1-1

1 FIRST FLOOR CODE REVIEW PLAN
1/4" = 1'-0" (WHEN PRINTED AT 30" X 42")



	GRAPHIC DEPICTION	DESCRIPTION
		- LAYER OF 5/8" GWB - 2X6 WOOD STUDS AT 24" O.C.
		- 5-1/2" SOUND BATT INSULATION - LAYER OF 5/8" GWB
	1	
	TYPE FIRE RATING UL NUME	BER STC RATING IIC RATING
	NC N/A N/A	A 35-39 N/A
G	GRAPHIC DEPICTION	DESCRIPTION
		- LAYER OF 5/8" GWB - 2X4 WOOD STUDS AT 24" O.C. - LAYER OF 5/8" GWB
	l l	
	TYPE FIRE RATING UL NUME	BER STC RATING IIC RATING
	NB N/A N/A	
	GRAPHIC DEPICTION	DESCRIPTION
		- LAYER OF 5/8" GWB
		- 2X4 WOOD STUDS AT 24" O.C. - 3-1/2" SOUND BATT INSULATION - LAYER OF 5/8" GWB
	TYPE FIRE RATING UL NUME	BER STC RATING IIC RATING
GRAPHIC DEPICTION DESCRIPTION	N/A N/A	
W	NALL TYPE NOTES  .) REFER TO STRUCTURAL DRAWINGS FO	OR STUD SIZE AND SPACING
	2.) WHEN TWO ADJACENT WALL TYPES HA GWB, THE FINISHED FACE OF GWB MU	
	B.) HOLD BOTTOM OF GWB UP 1/2" FROM	
- LAYER OF 5/8" TYPE-X GWB		
- 2X6 WOOD STUDS AT 16" O.C. - 5-1/2" ACOUSTICAL FIRE BATT INSULATION		
A   A   A   A   A   A   A   A   A   A		
A   A   A   A   A   A   A   A   A   A		
- 5-1/2" ACOUSTICAL FIRE BATT INSULATION - LAYER OF 5/8" TYPE-X GWB		
TYPE  FIRE RATING UL NUMBER STC RATING IIC RATING		
- 5-1/2" ACOUSTICAL FIRE BATT INSULATION - LAYER OF 5/8" TYPE-X GWB		
TYPE  FIRE RATING UL NUMBER STC RATING IIC RATING		

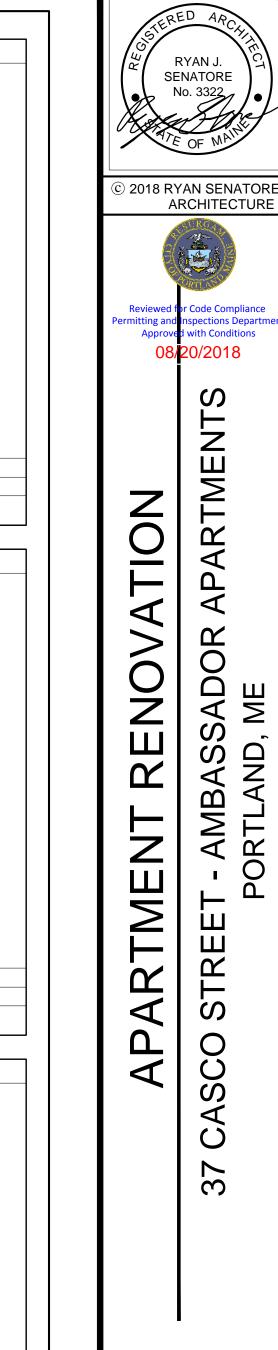



CONSULTANTS:

REVISIONS:

DATE: JULY 10, 2017

PROJECT No. 1843

DRAWN BY: RRT

CHECKED BY: RJS

SCALE: AS N
SHEET TITLE:


WALL TYPES

A0-1



NOTE:

- DIMENSIONS ARE FROM FACE OF GWB ON EXISTING WALLS AND FACE OF STUDS ON NEW WALLS

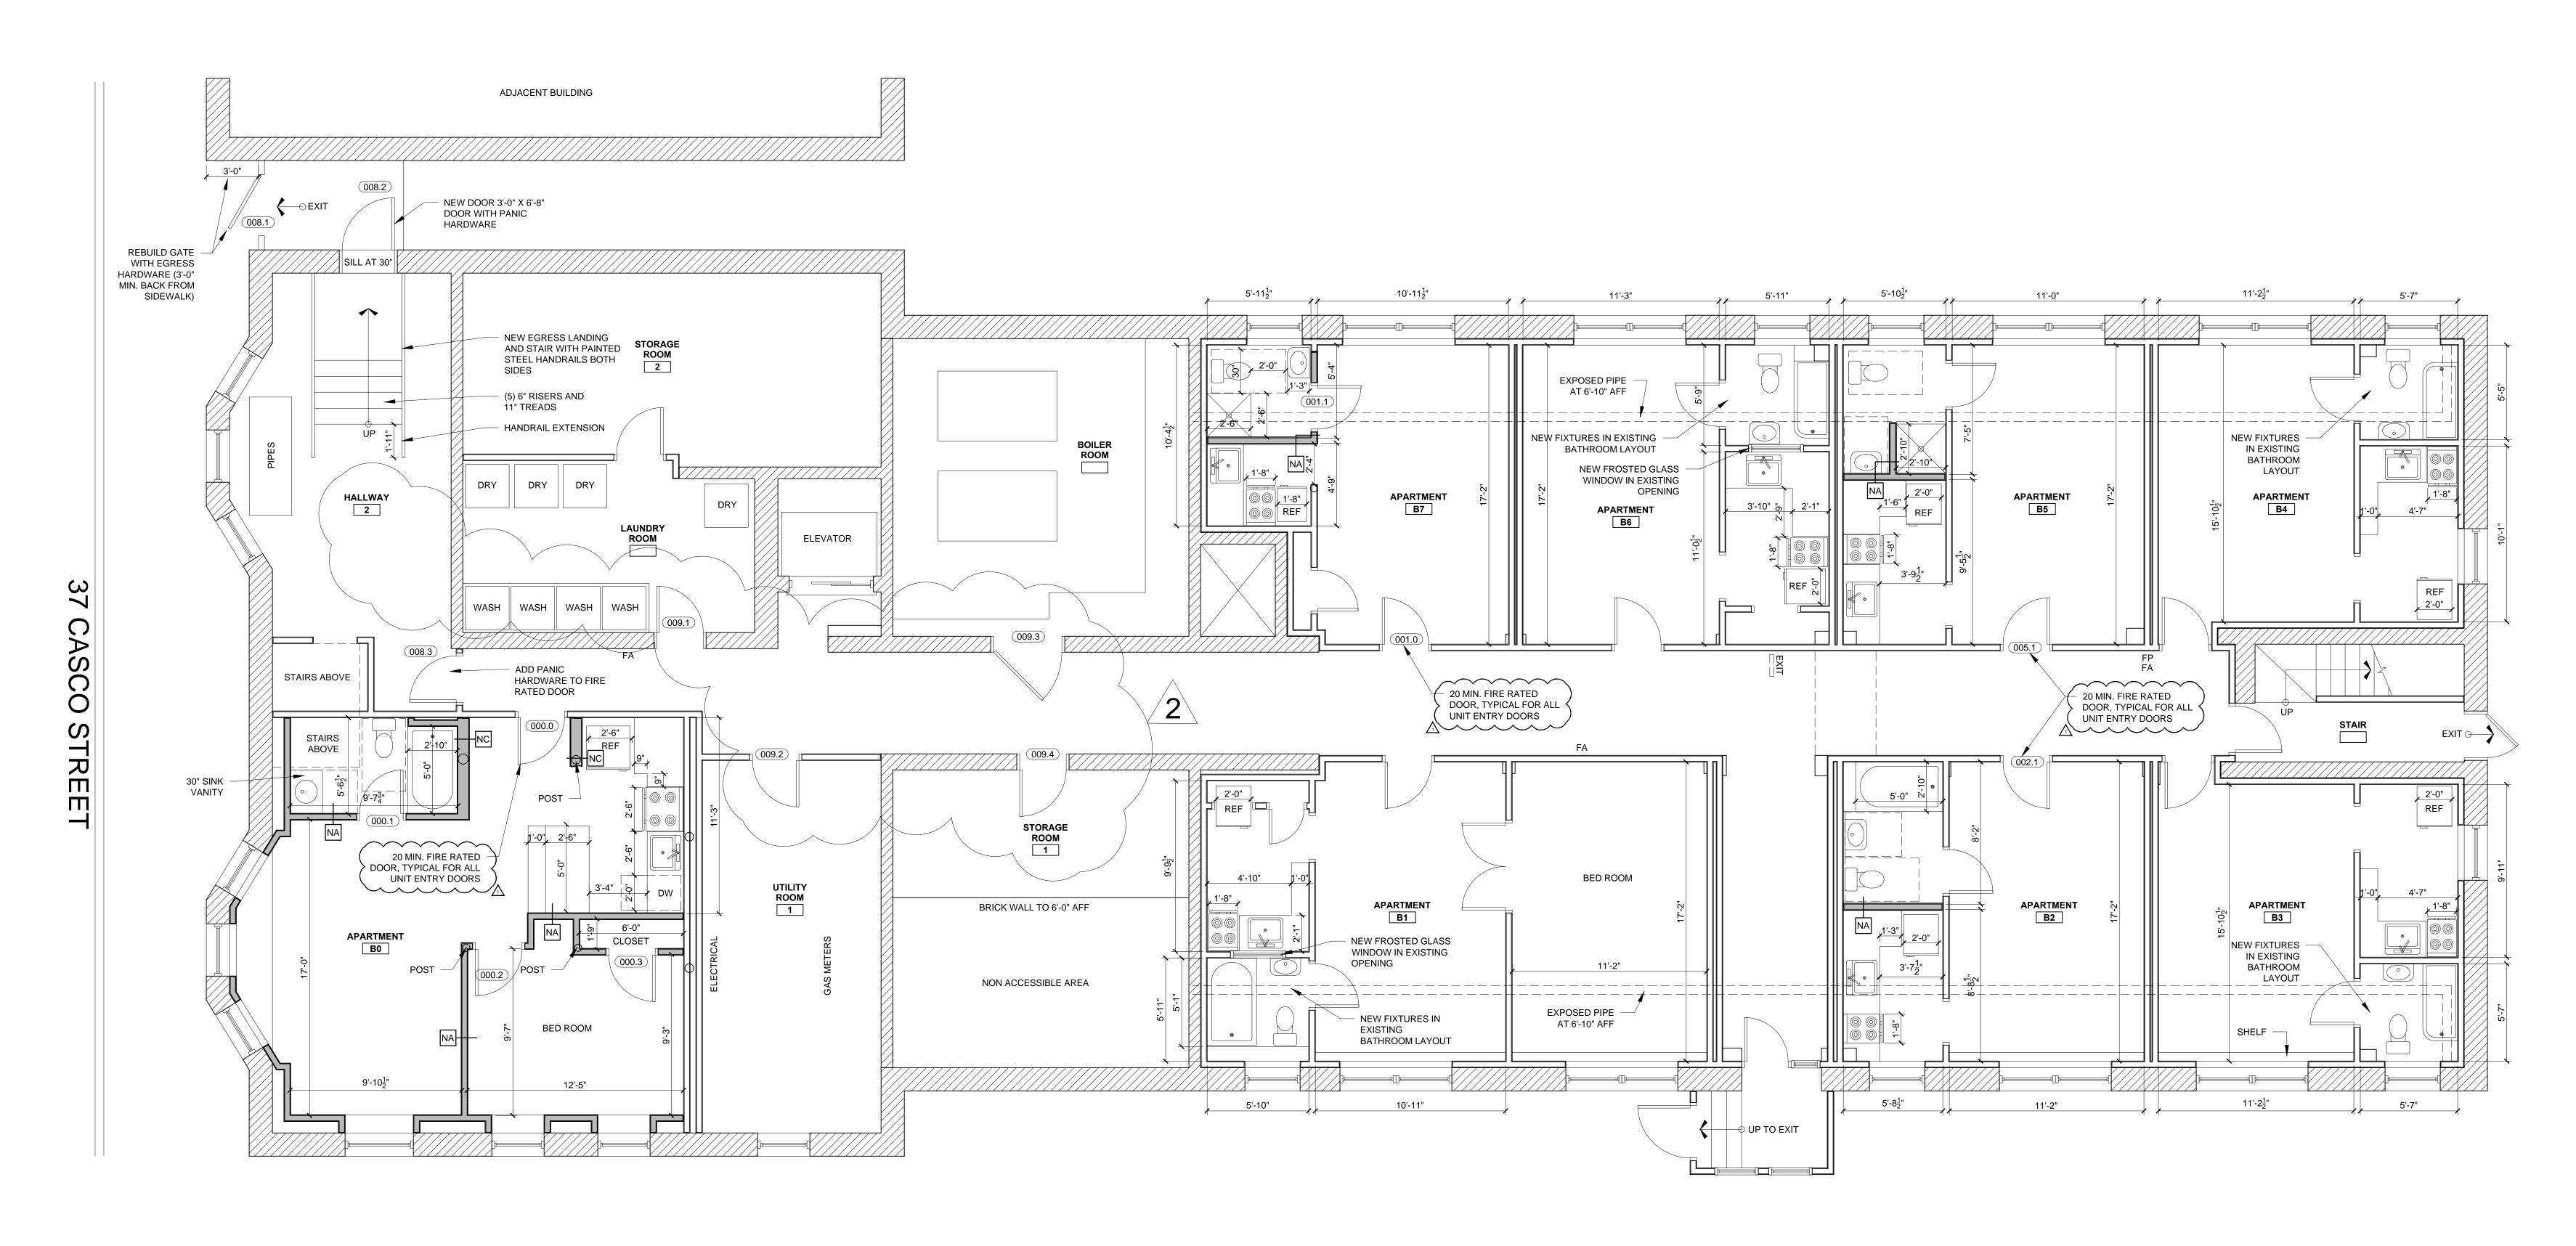



© 2018 RYAN SENATORE ARCHITECTURE

RYAN SENATORE ARCHITECTURE 565 CONGRESS STREET PORTLAND, MAINE 04101 207-650-6414 senatorearchitecture.com

CONSULTANTS:

REVISIONS: REVISED #1: 07-30-18 REVISED #2: 08-03-18

DATE: JULY 10, 2017 PROJECT No. DRAWN BY:

SHEET TITLE:

BASEMENT PLAN

A1-0


NOTE: - DIMENSIONS ARE FROM FACE OF GWB ON EXISTING WALLS AND FACE OF STUDS ON NEW WALLS


© 2018 RYAN SENATORE ARCHITECTURE



APARTMENTS

STREE

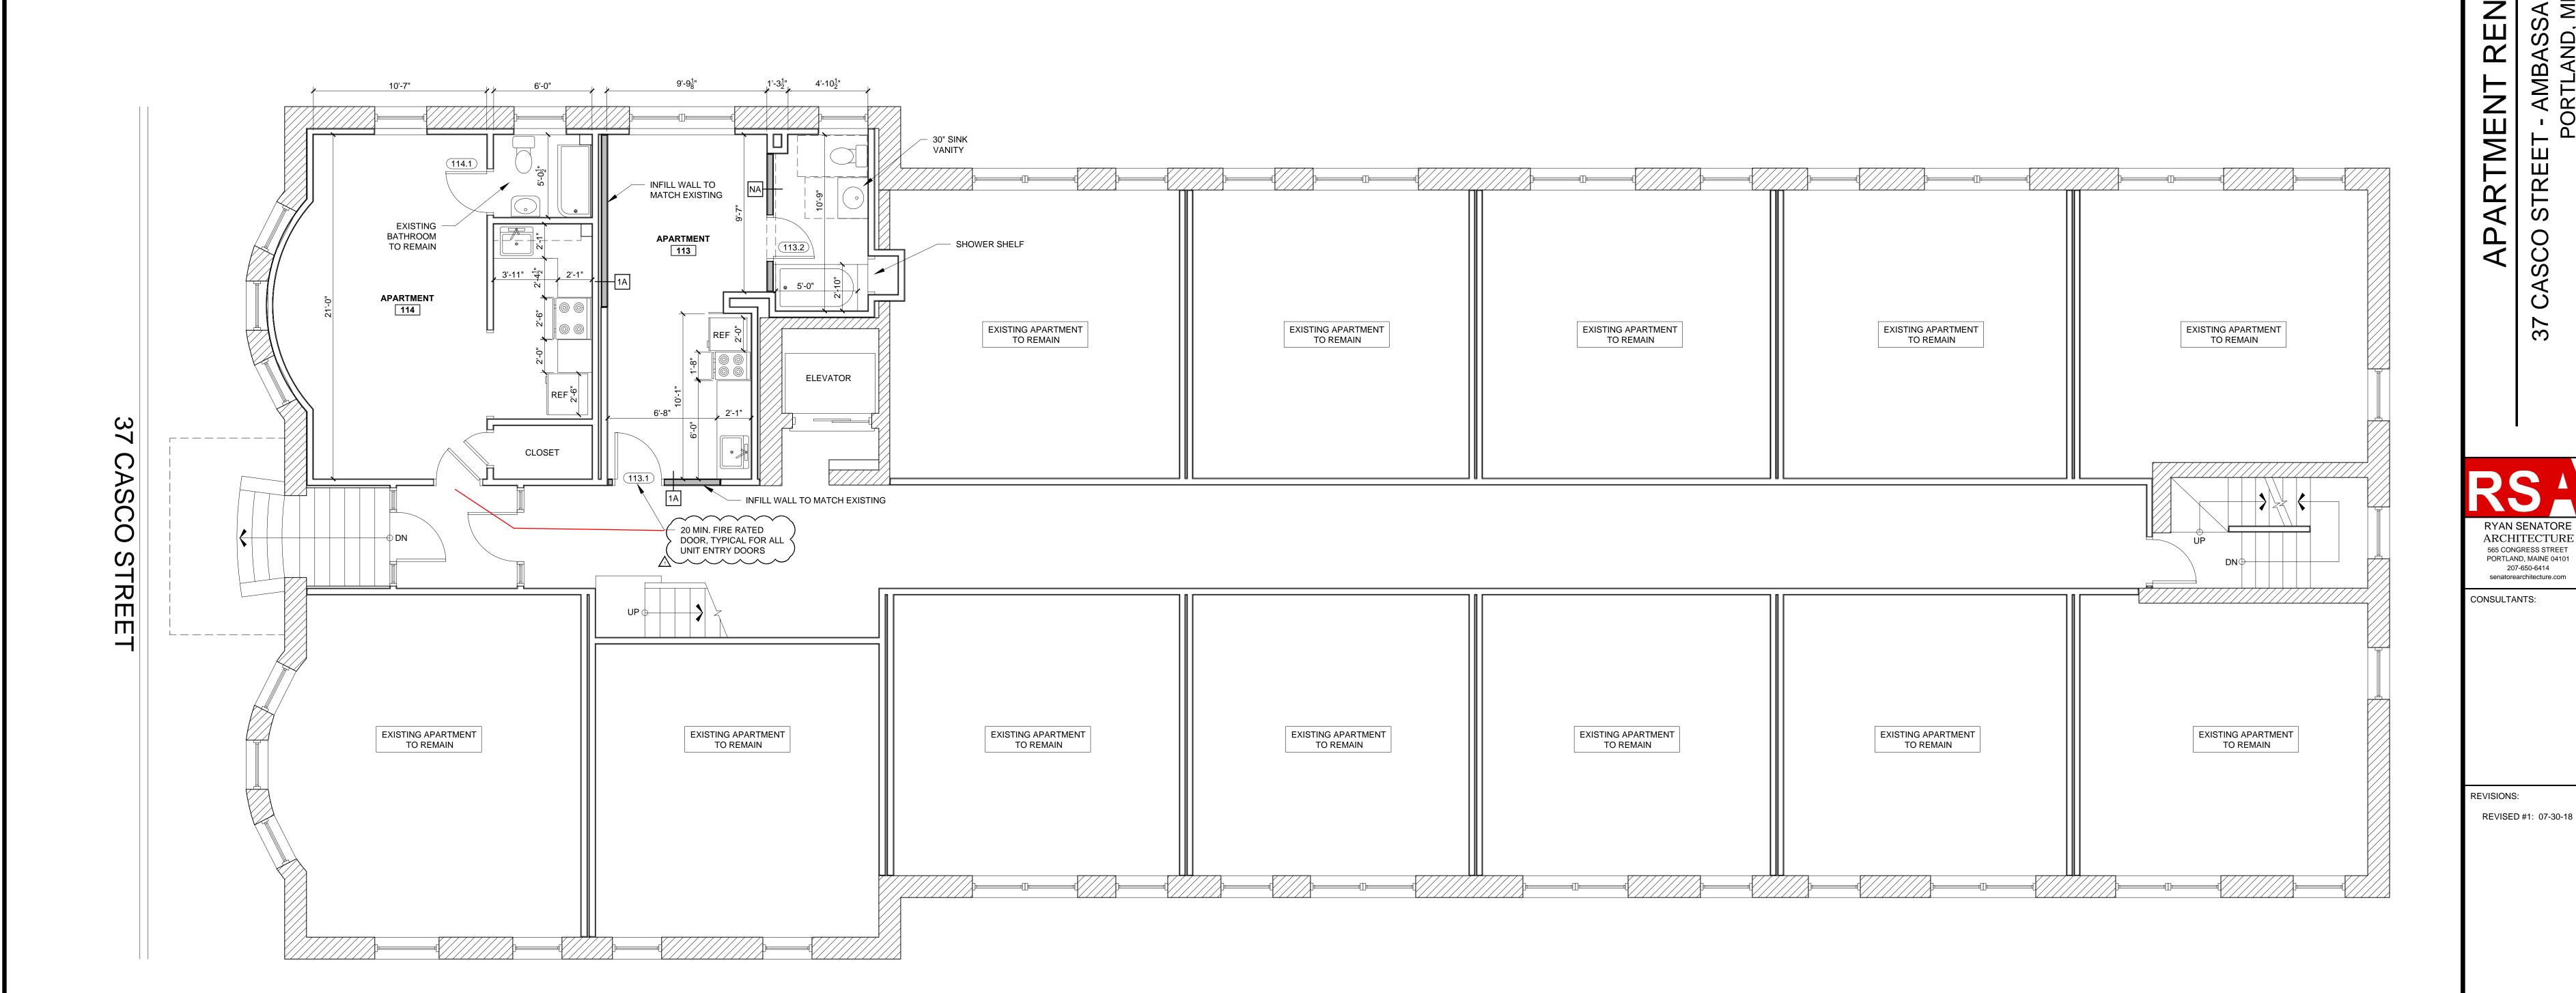

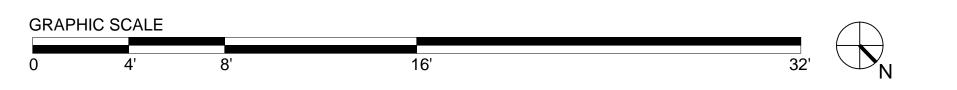




1 PROPOSED FIRST FLOOR PLAN
1/4" = 1'-0" (WHEN PRINTED AT 30" X 42")

PROJECT No. DRAWN BY: SHEET TITLE:

DATE: JULY 10, 2017

FIRST FLOOR PLAN

A1-1

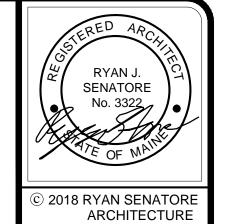



RYAN SENATORE ARCHITECTURE
565 CONGRESS STREET
PORTLAND, MAINE 04101 207-650-6414 senatorearchitecture.com

37

CONSULTANTS:

REVISIONS:


JULY 10, 201 PROJECT No. DRAWN BY:


SCALE: SHEET TITLE: STAIR DETAILS


CHECKED BY:


A5-0

LANDING FRAMING 2X8s AT 16" O.C. WITH 3/4" ADVANTECH SHEATHING —1-1/2" O.C. PAINTED STEEL HANDRAILS BOTH SIDES OF STAIR 2X12 STAIR STRINGERS AT 12" O.C. 2X4 WALL AT 16" O.C.

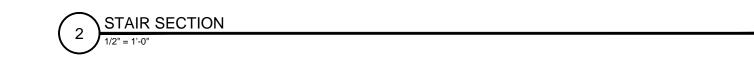


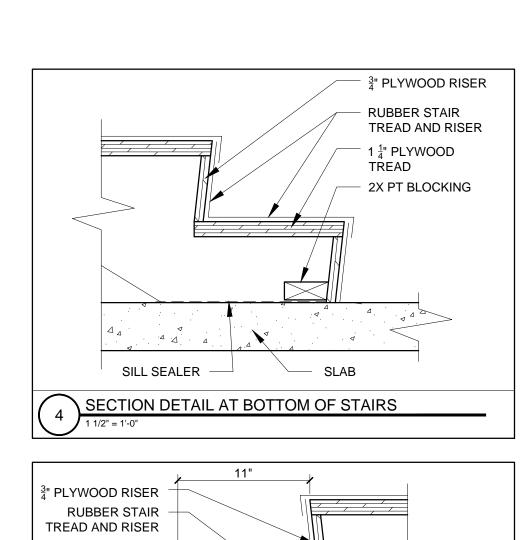

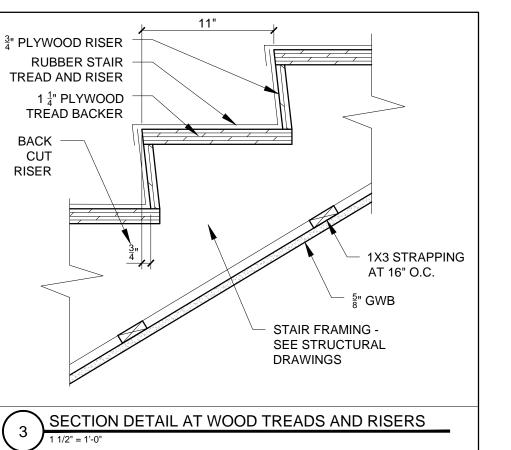

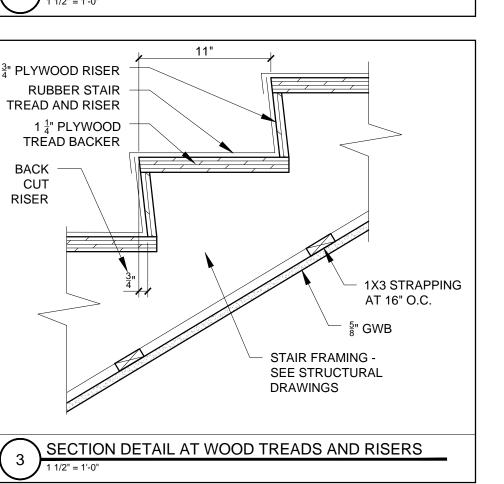



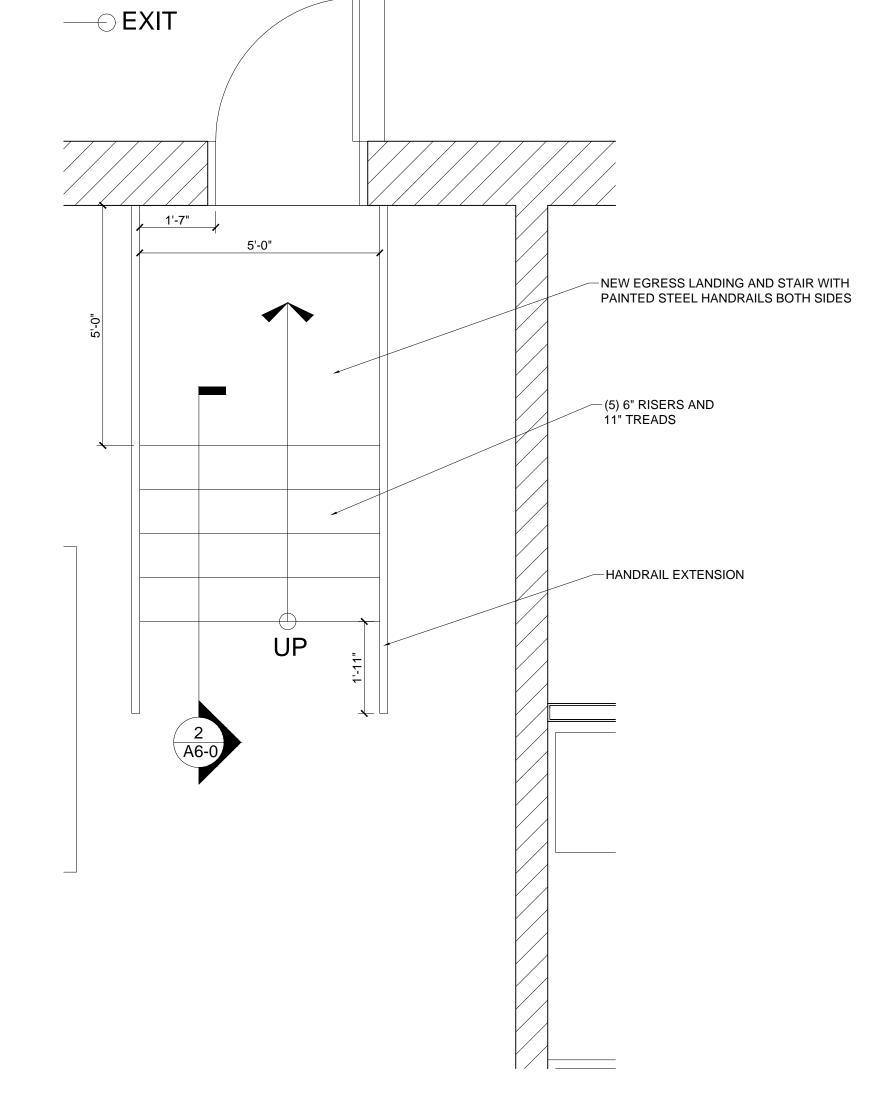

1 STAIR PLAN
1/2" = 1'-0"

REVISED #2: 08-03-18

DATE:	JULY 10, 2017
PROJECT No.	1843
DRAWN BY:	RRT
CHECKED BY:	RJS
CCALE.	AC NOTED


SHEET TITLE:
DOOR
SCHEDULE


A7-0

**DOOR SCHEDULE** 

DOOR TO MATCH
TYPICAL EXISITNG
INTERIOR DOOR STYLE

PEEPHOLE

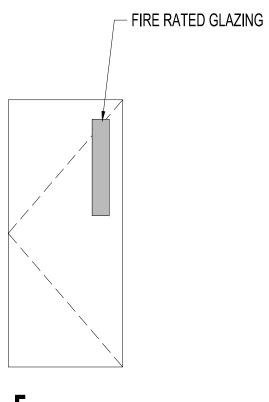

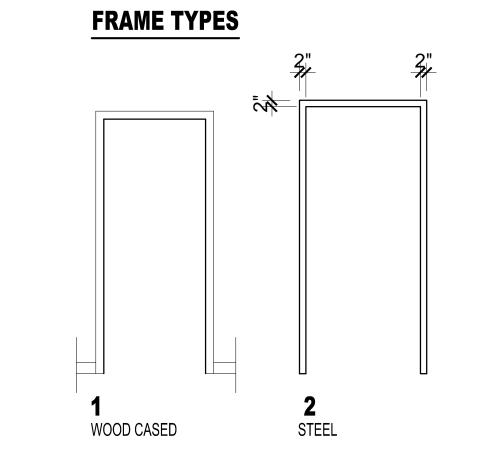

1. ALL DOORS TO BE SOLID CORE 2. ALL DOOR HARDWARE TO BE LEVER TYPE 'ACCESSIBLE'

NOTES:

KEY GLAZING TYPE GL-1 INSULATED CLEAR GLAZING GL-2 FIRE RATED INSULATED GLAZING GL-3 CLEAR TEMPERED GLASS GL-4 CLEAR INSULATED TEMPERED GLASS

GL-5 FIRE RATED GLAZING

**GLAZING SCHEDULE** 

1	DOOR TYPES
l	

DOOR SCHEDULE																	
		DOOR FRAME										AME					GENERAL
				SIZE									ETAILS	3			HARDWARE KEY MLS - MORTISE LOCK SET NOTE: FOR DOOR HARDWARE SEE DOOR HARDWARE SPECIFICATION SECTION 08710
	DOOR NO.	TYPE	WIDTH	HEIGHT	THICKNESS	MATERIAL	FINISH	INSULATED	TYPE	MATERIAL	THRESHOLD	HEAD	JAMB	SILL	CLOSER	FIRE RATING (MINUTES)	LS - LOCK SET PR - PRIVACY SET PS - PASSAGE SET LP - LEVER PULL PH - PEEPHOLE LENSE REMARKS
-	000.1		2'-10"		1-3/8"		PTD	-	1	WD	-	-	-	-	-	-	
	000.2	Α			1-3/8"	WD	PTD	-	1	WD	-	-	-	-	-	-	
F	000.3	A		6'-8"	1-3/8"		PTD	-	1	WD	-	-	-	-	-	-	
-	001.1	A	2'-10"	6'-8"	1-3/8"	WD	PTD	=	1	WD	-	-	-	=	-	-	
	008.1	D	3'-0"	7'-0"	1-3/4"	STL	PTD	=	-	STL	-	-	-	=	-	-	EXTERIOR GATE WITH PANIC HARDWARE
	008.2	С	3'-0"	7'-0"	1-3/4"	STL	PTD	Υ	2	STL	AL	-	-	İ	Υ	-	NEW EXTERIOR DOOR WITH PANIC HARDWARE
	008.3	EX	3'-0"	7'-0"	1-3/4"	STL	PTD	Υ	2	STL	AL	-	-	=	Υ	-	ADD PANIC HARDWARE TO EXISTING FIRE DOOR, G.C. TO CONFRIM EXISITNG DOOR HAS 60 MNIUTE FIRE RATED LISTING
$\frac{1}{2}$		~															
	009.1	F	3'-0"	7'-0"	1-3/4"	STL	PTD	Υ	-	STL	-	-	-	=	Υ	60	
	> 009.2	EX	3'-0"	7'-0"	1-3/4"	STL	PTD	Υ	2	STL	AL	-	-	-	Υ	-	G.C. TO CONFRIM EXISITNG DOOR HAS 60 MNIUTE FIRE RATED LISTING
[	009.3	D	EX	EX	1-3/4"	STL	PTD	Υ	_	STL	-	-	-	-	Υ	60	
	009.4	EX	3'-0"	7'-0"	1-3/4"	STL	PTD	Υ	2	STL	AL	-	-		Υ	-	G.C. TO CONFRIM EXISITNG DOOR HAS 60 MNIUTE FIRE RATED LISTING
						<u> </u>											
	113.2	Α	2'-10"	6'-8"	1-3/8"	WD	PTD	-	1	WD	-	-	-	-	-	-	
	114.1	Α	2'-10"	6'-8"	1-3/8"	WD	PTD	_	1	WD	-	-	-	-	-	-	
$\triangle$																	
	0.000	Е	3'-0"	7'-0"	1-3/8"	WD	PTD	N	2	STL	AL	-	-	=	Υ	20 -	- APARTMENT ENTRY DOOR WITH SPRING HINGES (TO MATCH EXISTING APARTMENT ENTRY DOORS)
7	001.0	Е	3'-0"	7'-0"	1-3/8"	WD	PTD	N	2	STL	AL	-	-	=	Υ	20 -	- APARTMENT ENTRY DOOR WITH SPRING HINGES (TO MATCH EXISTING APARTMENT ENTRY DOORS)
	002.1	Е	3'-0"	7'-0"	1-3/8"	WD	PTD	N	2	STL	AL	-	-	-	Υ	20 -	- APARTMENT ENTRY DOOR WITH SPRING HINGES (TO MATCH EXISTING APARTMENT ENTRY DOORS)
Π	005.1	Е	3'-0"	7'-0"	1-3/8"	WD	PTD	N	2	STL	AL	-	-	_	Υ	20 -	- APARTMENT ENTRY DOOR WITH SPRING HINGES (TO MATCH EXISTING APARTMENT ENTRY DOORS)
	113.1	Е	3'-0"	7'-0"	1-3/8"	WD	PTD	N	2	STL	AL	-	-	=	Υ	20 -	- APARTMENT ENTRY DOOR WITH SPRING HINGES (TO MATCH EXISTING APARTMENT ENTRY DOORS)
													$\wedge$				



