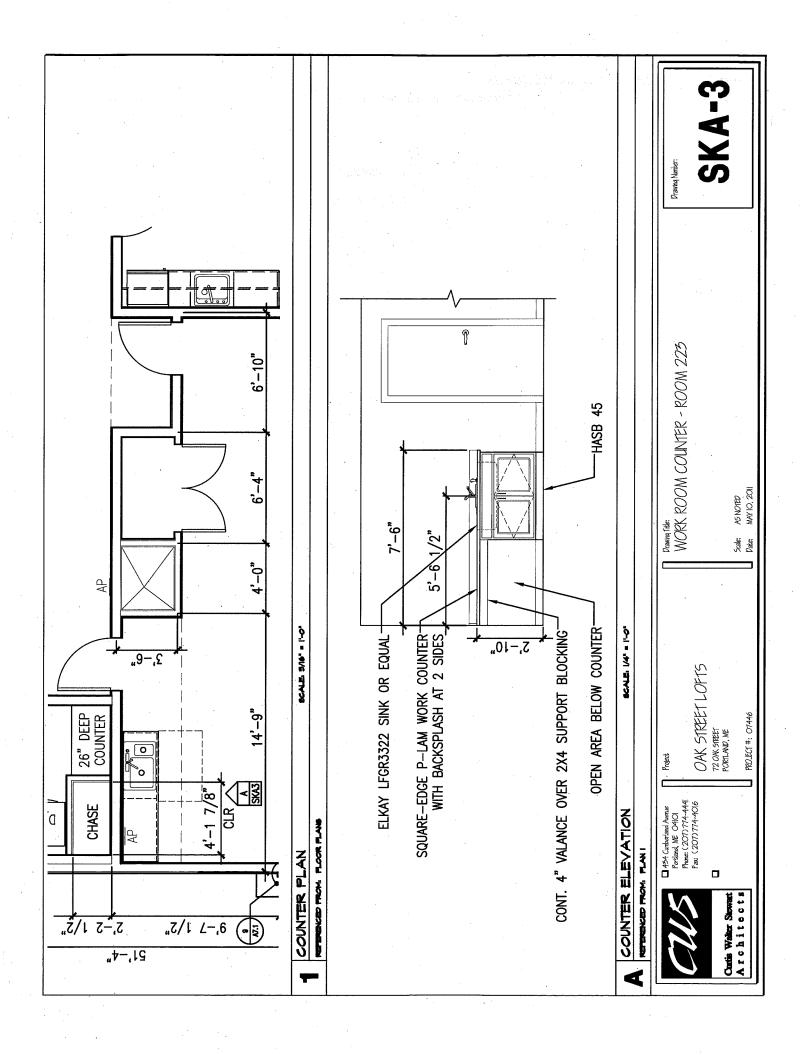
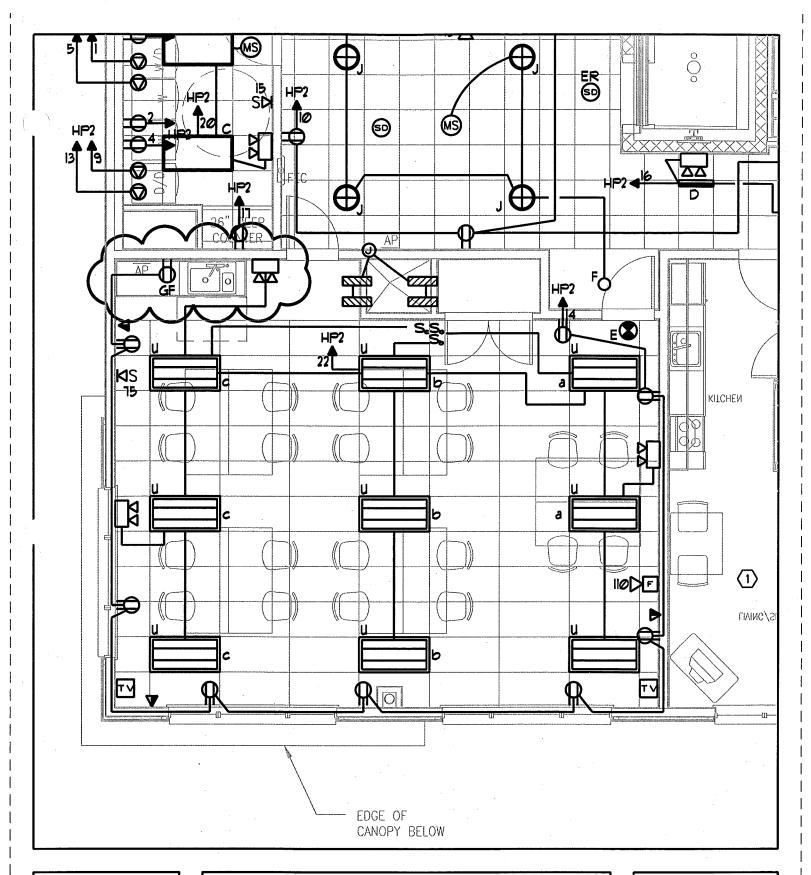
(Signature)

Work Change Proposal R PROJECT: (Name and address)	PROPOSED REQUEST NUMBER:	1	OWNER:
Oak Street Lofts			ARCHITECT:
72 Oak Street		. •.	CONSTRUCTION MANAGER:
Portland, ME 04101	·		CONTRACTOR:
			FIELD:
OWNER: (Name and address)	DATE OF ISSUANCE:	5/20/2011	OTHER:
Avesta Oak Street LP	CONTRACT FOR: (Damaini sallam	
307 Cumberland Ave Portland ME 04101	CONTRACT FOR: (Sonstruction	
Tottalia ME 04101			
FROM ARCHITECT: (Name and address)	CONTRACT DATE:	1/14/2011	
CWS Architects			
434 Cumberland Avenue			
Portland, ME 04101			
	ABOUTTOTO DDO ITOT NUMBER	07.440	
TO CONTRACTOR: (Name and address)	ARCHITECT'S PROJECT NUMBER:	07.446	
Wright-Ryan Construction			
10 Danforth Street Portland, ME 04101			
Foldand, ME 04101			
to the Contract Documents described herein. V notify the Architect, in writing, of the date on THIS IS NOT A CHANGE ORDER, A CONSTRUC WORK DESCRIBED IN THE PROPOSED MODIFI	which proposal submission is anticipated. TION CHANGE DIRECTIVE OR A DIRECTION TO	* * * * * * * * * * * * * * * * * * * *	HE
WORK DESCRIBED IN THE PROPOSED MODIFI	oanona.		
DESCRIPTION:	•		
Provide and install all components of a v	work country with sink on book schingt a	o nor	
the attached SKA-3, SKE-2 and SKM-3.		s pei	
	·		
ATTACHMENTS:			
01/4 0 01/5 0 1 01/44 0			
SKA-3, SKE-2 and SKM-3			
DECUEST BY THE ABOUTEST.			
REQUEST BY THE ARCHITECT:			
\mathcal{N} .			
Ly Lan		Goorgo Levia	no
(グラリーフ		George Lavig	
v v		Maine License	eu Alchilect

(Printed name and title)

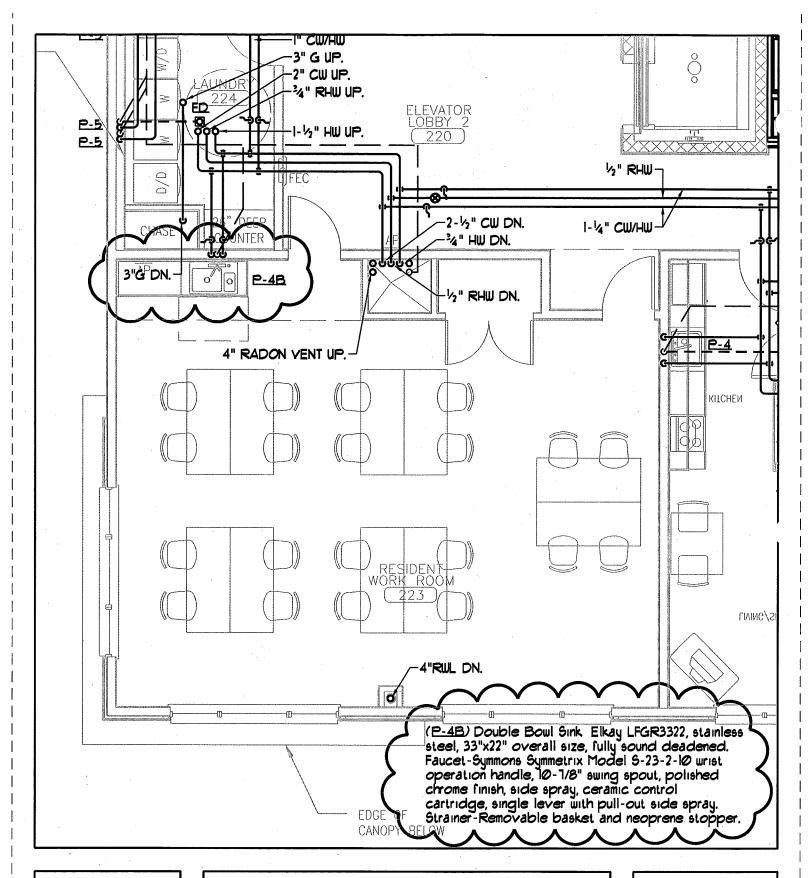






DRAWING TITLE - PARTIAL 2nd FLOOR ELECT PLAN
DESIGNED/CHECKED BY - SMR / WSBJR
DATE - 5/18/11
SCALE - 3/16"=1'-0"


SKE-2





DRAWING TITLE -	PARTIAL	2nd FLOOR PLUMB PLAN
DESIGNED/CHECKED BY	-	SMR / SPD
DATE -		5/18/11
SCALE -		3/16"=1'-0"


	PROPOSED REQUEST NUMBER:	2	OWNER: L
Oak Street Lofts	•		ARCHITECT:
72 Oak Street	•		CONSTRUCTION MANAGER:
Portland, ME 04101			CONTRACTOR:
			FIELD:
OWNER: (Name and address)	DATE OF ISSUANCE:	6/6/2011	OTHER:
Avesta Oak Street LP			
307 Cumberland Ave	CONTRACT FOR:	Construction	
Portland ME 04101			
FROM ARCHITECT. Ol	CONTRACT DATE	4/4.4/004.4	
FROM ARCHITECT: (Name and address)	CONTRACT DATE:	1/14/2011	
CWS Architects			
434 Cumberland Avenue			
Portland, ME 04101			
TO CONTRACTOR: (Name and address)	ARCHITECT'S PROJECT NUMBER:	07.446	
Wright-Ryan Construction		0,,,,,	
10 Danforth Street			
Portland, ME 04101	•		
Please submit an itemized proposal for change			
to the Contract Documents described herein. Venotify the Architect, in writing, of the date on THIS IS NOT A CHANGE ORDER, A CONSTRUCTION OF THE C	Within Zero (0) days, the Contractor must sub- which proposal submission is anticipated. TION CHANGE DIRECTIVE OR A DIRECTION T	mit this proposal or	
to the Contract Documents described herein. Venotify the Architect, in writing, of the date on THIS IS NOT A CHANGE ORDER, A CONSTRUCTION OF THE C	Within Zero (0) days, the Contractor must sub- which proposal submission is anticipated. TION CHANGE DIRECTIVE OR A DIRECTION T	mit this proposal or	
to the Contract Documents described herein. Notify the Architect, in writing, of the date on THIS IS NOT A CHANGE ORDER, A CONSTRUCTION OF THE PROPOSED MODIFIED IN THE PRO	Within Zero (0) days, the Contractor must sub- which proposal submission is anticipated. TION CHANGE DIRECTIVE OR A DIRECTION T	mit this proposal or	
to the Contract Documents described herein. Notify the Architect, in writing, of the date on THIS IS NOT A CHANGE ORDER, A CONSTRUCT WORK DESCRIBED IN THE PROPOSED MODIFIESCRIPTION:	Within Zero (0) days, the Contractor must subwhich proposal submission is anticipated. CTION CHANGE DIRECTIVE OR A DIRECTION TICATIONS.	mit this proposal or	HE
to the Contract Documents described herein. Notify the Architect, in writing, of the date on THIS IS NOT A CHANGE ORDER, A CONSTRUCTURE DESCRIPTION. Provide and install Sterling ceiling mounted.	Within Zero (0) days, the Contractor must subwhich proposal submission is anticipated. CTION CHANGE DIRECTIVE OR A DIRECTION TICATIONS. I cabinet unit heater Model C1140-03 (2GP)	mit this proposal or O PROCEED WITH T M) at Stair Two Fir	HE rst floor ceiling in
Please submit an itemized proposal for change to the Contract Documents described herein. In notify the Architect, in writing, of the date on THIS IS NOT A CHANGE ORDER, A CONSTRUCT WORK DESCRIBED IN THE PROPOSED MODIFUL DESCRIPTION: Provide and install Sterling ceiling mounted lieu of the specified wall mounted unit. Mod	Within Zero (0) days, the Contractor must sub- which proposal submission is anticipated. CTION CHANGE DIRECTIVE OR A DIRECTION T ICATIONS. I cabinet unit heater Model C1140-03 (2GP)	mit this proposal or O PROCEED WITH T M) at Stair Two Fir	HE rst floor ceiling in
to the Contract Documents described herein. Notify the Architect, in writing, of the date on THIS IS NOT A CHANGE ORDER, A CONSTRUCTURE OF THE PROPOSED MODIFUL DESCRIPTION. Provide and install Sterling ceiling mounted lieu of the specified wall mounted unit. Modern	Within Zero (0) days, the Contractor must sub- which proposal submission is anticipated. CTION CHANGE DIRECTIVE OR A DIRECTION T ICATIONS. I cabinet unit heater Model C1140-03 (2GP)	mit this proposal or O PROCEED WITH T M) at Stair Two Fir	HE rst floor ceiling in
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to the Contract Documents described herein. Notify the Architect, in writing, of the date on THIS IS NOT A CHANGE ORDER, A CONSTRUCT WORK DESCRIBED IN THE PROPOSED MODIF DESCRIPTION: Provide and install Sterling ceiling mounted lieu of the specified wall mounted unit. Mod ATTACHMENTS: SKM-4, SKM-5	Within Zero (0) days, the Contractor must sub- which proposal submission is anticipated. CTION CHANGE DIRECTIVE OR A DIRECTION T ICATIONS. I cabinet unit heater Model C1140-03 (2GP)	mit this proposal or O PROCEED WITH T M) at Stair Two Fined SKM-4 and SK	HE rst floor ceiling in M-5.
to the Contract Documents described herein. Notify the Architect, in writing, of the date on THIS IS NOT A CHANGE ORDER, A CONSTRUCT WORK DESCRIBED IN THE PROPOSED MODIF DESCRIPTION: Provide and install Sterling ceiling mounted lieu of the specified wall mounted unit. Mod ATTACHMENTS: SKM-4, SKM-5	Within Zero (0) days, the Contractor must sub- which proposal submission is anticipated. CTION CHANGE DIRECTIVE OR A DIRECTION T ICATIONS. I cabinet unit heater Model C1140-03 (2GP)	mit this proposal or O PROCEED WITH T M) at Stair Two Finded SKM-4 and SK	rst floor ceiling in M-5.

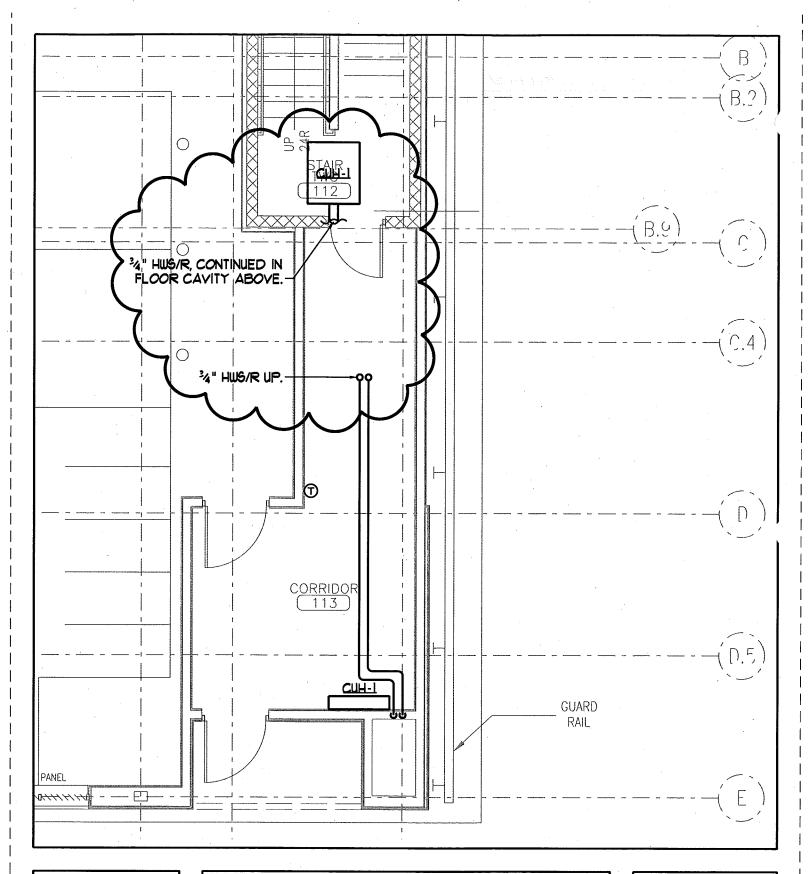



DRAWING TITLE - PARTIAL 1st FLOOR MECH PLAN
DESIGNED/CHECKED BY - SMR / SPD

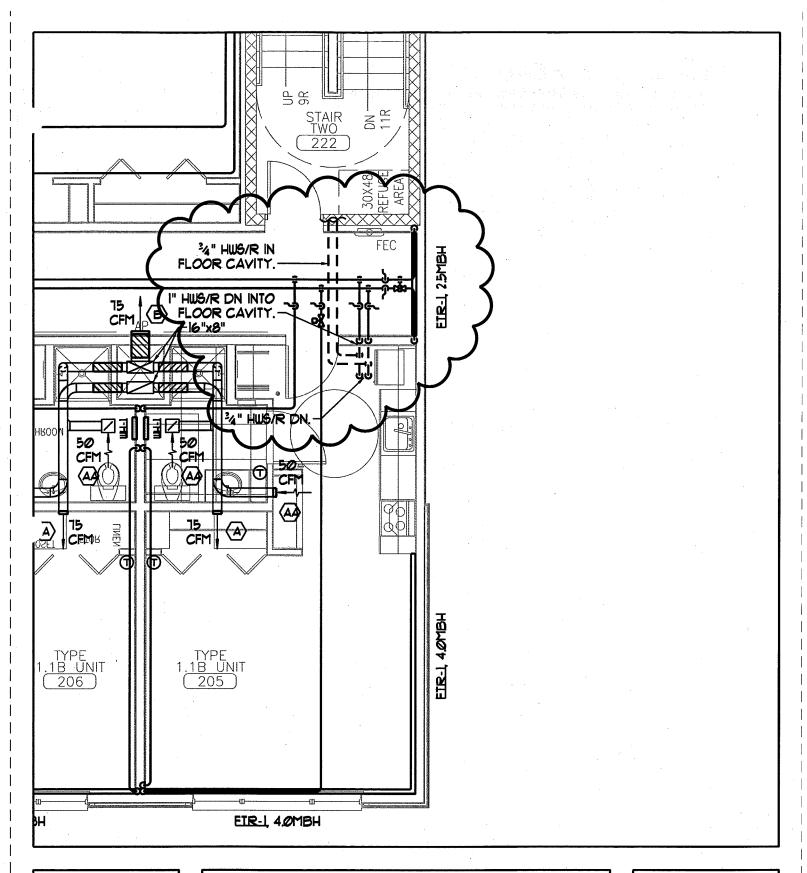DATE - 6/7/II
SCALE - 3/16"=1"-0"






DRAWING TITLE - PARTIAL 2nd FLOOR MECH PLAN
DESIGNED/CHECKED BY - SMR / SPD
DATE - 6/7/II
SCALE - 3/16"=1"-0"


CABINET UNIT HEATER SUBMITTAL DATA


CBS-C-10

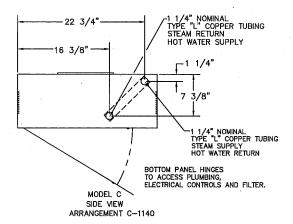
Ceiling Mounted Units (Non Recessed Only) - Models C
PIPING AND MOUNTING CONNECTIONS SHOWN ARE TYPICAL FOR ALL AIR FLOW ARRANGEMENTS SEE OTHER SIDE.




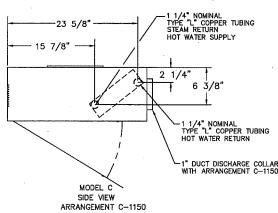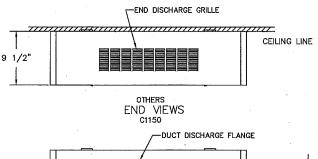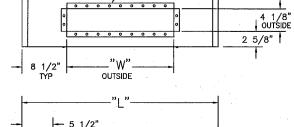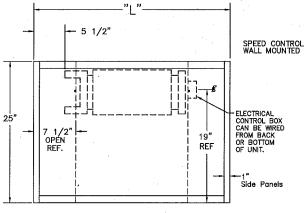STANDARD ONE ROW COIL PIPING DIMENSIONS. (SHOWN ABOVE)










MODEL C

FRONT/BOTTOM VIEW

TWO ROW COIL PIPING DIMENSIONS (SHOWN ABOVE)

THIS DATA SHEET SHOWS CEILING MOUNTED UNITS (Non Recessed ONLY) MODELS "C".

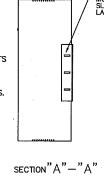PIPING AND MOUNTING CONNECTIONS SHOWN ARE TYPICAL FOR ALL AIR FLOW ARRANGEMENTS. SEE PAGE 6 for other air flow arrangements.



MOUNTING BRACKET SLOTS ALLOW FOR 7/16" LATERAL ADJUSTMENT 15 1/8" 12 1/8" 9 1/8" -"A" " MOUNTING BRACKET SLOTS ALLOW FOR 1" (Mounting Dimensions) VERTICAL ADJUSTMENT

♦ MAXIMUM RECESS DEPTH MODELS C1140, C1150, C1160, C1180 ONLY.

CAT00202

- 6 1/2" (TYP.)

PROJECT: **LOCATION** ARCHITECT: **ENGINEER:**

CONTRACTOR: PO NUMBER:

DATE:



260 NORTH ELM STREET / WESTFIELD, MA 01085 TEL: (413) 568-9571 FAX: (413) 568-9613

www.mestek.com



CABINET UNIT HEATERS RATINGS AND SPECIFICATIONS

TABLE I						E	NTERING W ENTERIN	ATER - 200° IG AIR - 60°
UNIT SIZE	02	03	04	06	08	10	12	14
HEATING CAP HOT								
WATER M8H	16.4	22.8	29.8	48.0	54.5	62.0	75.6	78.5
20 WTD GPM	1.64	2.28	2.98	4,80	5.46	6.20	7.56	7.85
HIGH CAP COIL 2 ROW								
HEATING CAP. MBH	25.8	35.4	46.3	69.8	87.6	101.8	119,8	128.6
HOT WATER GPM	2.58	3,54	4.63	6,98	8.76	10.18	11.98	12.86
20 WTD.								
HEATING CAP STEAM								
2 PSIG MBH	22.6	31.4	41.0	66.1	75.1	85.4	104.1	108.2
STANDARD EDR	94	131	171	276	313	356	434	451
COIL COND, LB/HR	23.4	32.5	42.4	68.4	77.7	88.4	107.7	112
COIL:								
NUMBER FINS PER INCH	12	. 12	12	12	12	12	12	12
FACE AREA-FT ²	.97	1.5	1.8	2.6	2.8	3,1	3.6	4.4
COIL CONNECTIONS	1-1/4CU	1-1/4CU						
BLOWERS:								
NUMBER	1	1	2	2	3	3	4	. 4
DIAMETER/WIDTH	5-3/4 / 7	5-3/4 / 7	5-3/4 / 7	5-3/4 / 7	5-3/4 / 7	5-3/4 / 7	5-3/4 / 7	5-3/4 / 7
DRIVE	DIRECT	DIRECT						
RPM - HI	1050	1050	1050	1050	1050	1050	1050	1050
LOW	875	875	875	875	875	875	875	875
CFM:								
HIGH	230	335	430	630	860	1060	1230	1410
LOW	185	270	345	505	685	845	985	1130
MOTOR: H.P.	1/15	1/15	1/10	. 1/10	1@1/10	1@1/10	1/10	1/10
					1@1/15	1@1/15		
NUMBER	1	1	1	1	2	2	2	2
VOLTS/PHASE/HERTZ	115/1/60	115/1/60	115/1/60	115/1/60	115/1/60	115/1/60	115/1/60	115/1/60
AMPERES	.8	.8	1.4	1.4	2.2	2.2	2.8	2.8
CONTROLS - STD.	VAR.	VAR.						
FILTER: NO.	1 -	1	11	1	1	1	11	1
TYPE	PERM.	PERM.						
LENGTH	19-3/4	27-3/4	31-3/4	43-3/4	45-3/4	50-3/4	57-3/4	69-3/4
WIDTH	8-11/16	8-11/16	8-11/16	8-11/16	8-11/16	8-11/16	8-11/16	8-11/16
THICKNESS	1/2	1/2	1/2	1/2	1/2	1/2	1/2	1/2
dB. LEVEL 18" FROM								
UNIT	50	52	53	54	55	55	56	. 56
LENGTH	35	43	47	59	61	66	73	85
HEIGHT	25	25	25	25	25	25	25	25
DEPTH	9-1/2	9-1/2	9-1/2	9-1/2	9-1/2	9-1/2	9-1/2	9-1/2


F	ILTER IDENTIF	ICATION AND DATA
SIZE	Part No.	FILTER SIZE
02	PC1297-2	15/32" x 8 11/16" x 19 3/4"
03	PC1297-3	15/32" x 8 11/16" x 27 3/4"
04	PC1297-4	15/32" x 8 11/16" x 31 3/4"
06	PC1297-6	15/32" x 8 11/16" x 43 3/4"
08	PC1297-8	15/32" x 8 11/16" x 45 3/4"
10	PC1297-10	15/32" x 8 11/16" x 50 3/4"
12	PC1297-12	15/32" x 8 11/16" x 57 3/4"
14	PC1297-14	15/32" x 8 11/16" x 69 3/4"

SIZE	DIM "L"	DIM "W"
02	35"	18 1/8"
03	43"	26 1/8"
04	47"	30 1/8"
06	59"	42 1/8"
08	61"	44 1/8"
10	66"	49 1/8"
12	73"	56 1/8"
14	85"	68 1/8"

CABINET UNIT HEATERS SHIPPING WEIGHT

SHIPPING WEIGHT (LBS)

					SIZE			
STYLE	02	03	04	06	08	10	12	14
С	97	115	128	157	175	185	207	234

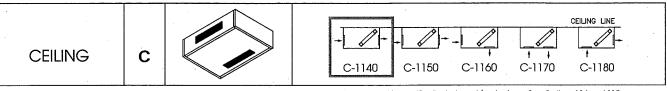

CABINET UNIT HEATERS HEATING CAPACITIES

TABLE II — STANDARD COIL

ENTERING WATER - 200°F ENTERING AIR - 60°F

UNIT	GPM	WATER		HIGH FA	N SPEEC)		LOW	AN SPEE)
SIZE	GFW	P.D./FT.	CFM	MBH	WTD	FAT	CFM	MBH	WTD	FAT
	.5	.02		12.8	51.2	- 111		11.8	47.2	119
	1.0	.06		15.1	30.2	120		13.8	27.6	129
02	1.5	.15	230	16.2	21.6	125	185	15.0	20.0	135
	2.0	.24		17.4	17.4	130		16.1	16.1	140
	2.5	.36		18.8	15.0	135		17.3	13.8	146
	1.0	.07		21.3	42.6	118		19.1	38.2	125
Contraction Contraction	1.5	16	-	22.0	26.6	120	Action to the second second second	19.8	26,4	128
L_03	2.0 2.5	.26	335	22.7	22.7	122	270	20.1	20.1	129
	2.5	.39		23.5	18.8	125		20.7	16.6	131
	3.0	.55		23.8	15.8	126		21.1	14.1	132
1	1.0	.07		21.8	43.6	106	l	19.0	38.0	111
	2.0	.27		26.6	26.6	117		23.9	23.9	124
04	2.5	.41	430	29.0	23.2	122	345	25.8	20.5	129
	4.0 5.0	1.00 1.45		30.9 32.3	15.4	126 129		27.4 28.3	13.7 11.3	133 136
	2.0	1.45		40.4	12.9 40.4	119		35.7	35.7	125
	3.0	.30 .63		44.8	29.8	125		39.8	26.5	133
06	4.0	1.10	630	47.2	23.6	129	505	41.9	20.0	136
00	5.0	1.60	030	49.4	19.8	132	505	43.6	21.0 17.5	140
	6.0	2.25		50.7	16.9	134		44.6	15.0	140
	6.0 2.0	.31		47.1	47.1	110		42.0	42.0	117
	3.0	.64		52.2	34.8	115		46.5	31.0	123
08	4.0	1.10	860	53.9	26.9	117	685	48.3	24.2	125
""	6.0	2.25		56.0	18.6	120	000	49.1	16.4	126
	8.0	3.85		57.8	14.4	122	l	51.2	12.8	129
	3.0	.65		55.8	32.7	109		50.2	12.8 33.5	115
	4.0	1.15		60.4	30.2	112		53.5 54.7	26.8 18.2	118
10	6.0	2.35	1060	62.2	20.7	114	845	54.7	18.2	120
	8.0	4.00		64.1	16.0	116		56.3	14.1	121
	10.0	6.00		66.0	13.2	117		58,9 65.1	11.8 32.6	124
1	4.0	1.20		71.5	35.7	113		65.1	32.6	131
	6.0	2.50		74.5	24.8	116	İ	66.6	22.2	133
12	8.0	4.20	1230	76.7	19.1	117	985	68.0	17.0 13.8	134
	10.0	6.30		77.7	15.5	118		69.0	13.8	135
	12.0	8.85		78.6	13.1	119		69.7	11.6 37.9	136
	3.5	1.00		71.0	40.6	106		66.3	37.9	114
l	4.0	1.30		74.1	37.0	108		68.4	34.2	116
14	6.0	2.70	1410	77.6	25,9	111	1130	69.9	23,3	117
	10.0 12.0	6.80 9.55		80.9	16.2	113		72.5 73.0	14.5	119
	12.0	7,55		81.7	13.6	113	l	/3,0	12,2	120

CABINET UNIT HEATERS HEATING CAPACITIES

TABLE III — HIGH CAPACITY - 2 ROW COIL

ENTERING WATER - 200°F ENTERING AIR - 60°F

UNIT	CDM	WATER		HIGH FA	N SPEED)		LOW F	AN SPEE	D .
GPM WALLEY		MBH	WTD	FAT	CFM	MBH	WTD	FAT		
SIZE GPM P.D./FT. CFM MBH V		71.6	133		16.5	66.0	144			
					43.4	149		19.9	39.8	162
02			225		31.1	155	180	21.4	28.5	170
					24.8	162		22.5	22.5	175
					20.6	165		23.5	18.8	180
					60,2	144		28.3	56.6	158
	1.5	.25		31.9	42.5	149		28.9	38.5	161
03	2.0	.38	330	33.1	33.1	152	265	29.7	29.7	163
	2.5	.56		34.3	27.4	156		30.3	24.2	165
	3.0	.77		34.9	23.3	157		30.8	20.5	167
	1.0	.11		31.5	63.0	129		29.5	59.0	141
	2.0	.44		39.5	39.5	147	1.0	35.8	35.8	158
04	2.5	.59	420	42.4	33.9	153	335	37.8	30.2	164
	4.0	1.41		45.4	22.7	160		39.7	19.9	169
	5.0	2.04		46.8	18.7	163		40.8	16.3	· 172
	2.0	.45		57.6	57.6	146		52.7	52.7	158
	3.0	.93		63.1	42.1	154	1	57.0	38.0	166
06	4.0	1.60	620	66.0	33.0	158	495	59.7	29.9	171
٠.	5.0	2.30		69.1	27.6	163		61.2	24.5	174
	6.0	3.30		69.5	23.2	164	ļ	62.0	20.7	175
	2.0	.46		67.1	67.1	133	Į.	58.1	58.1	139
	3.0	.95		75.8	50.5	143		68.2	45.5	153
08	4.0	1.65	845	79.3	39.7	146	675	71.6	35.8	158
	6.0	3.35		82.6	27.5	150		73.4	24.5	160
	8.0	5.60		86.5	21.6	154	·	75.8	19.0	163
	3.0	1.00		84.6	56.4	135		75.9	50.6	144
	4.0	1.75		90.6	45.3	140		81.2	40.6	150
10	6.0	3.50	1040	94.6	31.5	144	830	84.0	28.0	153
	8.0 10.0	5.90		98.6	24.7	147		86.3	21.6	156
		8.85		101.6	20.3	150		88.9	17.8	159
	4.0 6.0	1.85 3.75		105.3 111.6	52.7 37.2	140 145		93.3	46.7 33.5	149
. ,,	8.0	6.30	1010				070	100,4		155
12	10.0	9.45	1210	115.3 118.1	28.8 23.6	148 150	970	102.8 105.0	25.7 - 21.0	158 160
	12.0	13.20		118.1	20.0	150	1	106.0	17.8	161
	4.0	2.05		109.8	54,9	133	-	100.7	50.1	143
	5.0	3.00		114.8	54.9 45.9	136	ŀ	100.2	41.4	143
14	6.0	4.15	1385	118.3	45.9 39.4	139	1110	103.5	35.5	140
14	10.0	10.45	1385	125.8	25.2	144	1110	111.4	22.3	152
	12.0	14.55		127.9	21.3	144	l	112.2	18.7	153

SPECIFICATIONS & WARRANTY*

*STANDARD CABINET UNIT ONLY

The contractor shall furnish and install Sterling Cabinet Unit Heaters as selected to meet or exceed job requirements. The Cabinet Unit Heaters will conform to the items listed below and be certified under CSA guidelines.

CABINETS

All cabinets will be constructed with 18 gauge electro galvanneal steel internal cabinets, side panels and top. The front panel shall be furnished in 16 gauge electro galvanneal steel. Adequate work area for installation of control valves or electrical equipment shall be provided on both sides of the internal cabinet.

The cabinet shall be provided with a neutral eggshell baked enamel prime coat as standard. (Available if specified) Powder coated baked enamel, color selected from Sterling Color Chart.

All cabinets shall be supplied with adjustable rear mounting brackets which will provide adjustment to correct alignment of the unit at installation to non square or out of true walls, joists, studs or surfaces. Adjustable leveling legs (two each base leg) are available when specified.

RECESSED UNITS

All recessed units shall be supplied with a "Wall Seal" assembly. This assembly shall provide protection to the wall or ceiling construction material. The "Wall Seal" shall be supplied in an eggshell baked enamel prime coat as standard. (When specified) Baked enamel colors may be selected from Sterling Color Chart.

CEILING MOUNT OR RECESSED UNITS

All "RC" units shall be supplied with a continuous hinged front panel. The continuous hinge shall provide full swing through 90°. A safety chain shall be provided as standard to prevent the face panel from swinging fully open accidentally. This chain must be easily detached to allow full access for servicing. Speed control switch will be shipped with wiring diagram for installation where desired.

FILTERS

All filters supplied as standard shall be reusable aluminum media with a 69% arrestance level. Filters shall be slide in type which are locked into position with two cotter pins.

ANS

Fan wheels shall be centrifugal, forward curved, double width of electro galvanneal steel. Fan housings shall be of formed, galvanized sheet metal.

MOTORS

All motors shall have integral thermal protection and start at 78 per cent of rated voltage. All motors shall be of p.s.c. design and be capable of operating in high static conditions. All motors shall be factory run-tested and assembled in unit prior to shipping.

ELECTRICAL

All primary internal wiring shall be done at the factory and every unit shall be factory tested for reliability.

FRESH AIR DAMPERS

When desired specify either of the following:


- 1. Where noted 25% Manual Outside Air Dampers shall be provided. A manually operated damper quadrant shall provide from 0% to 25% outside air through the use of a single blade damper.
- 2. Where noted 25% Motorized Outside Air Dampers shall be provided. A synchronous motor (115/60/1) interlocked with the blower shall automatically open the outside air damper when blower starts. The single blade damper shall be adjustable from 0% to 25% outside air. When the blower stops or there is a loss of power, the damper shall return to the closed position. A damper override switch shall be provided to prevent damper operation when desired.

WARRANTY

The products in this catalog are warranted by Sterling, to be free from defects in material and workmanship for a period of one (1) year from the date of shipment from Sterling's plant. Sterling's liability under this warranty is limited to replacing or repairing at our option, F.O.B. our plant any defective component or assembly returned to our factory prepaid and with proper return authorization document. All repairs or replacements are made subject to factory inspection. In the interest of product improvement, Sterling reserves the right to make changes without notification.



Work Change Proposal Red	quest		
PROJECT: (Name and address)	PROPOSED REQUEST NUMBER:	3	OWNER:
Oak Street Lofts			ARCHITECT:
72 Oak Street			CONSTRUCTION MANAGER:
Portland, ME 04101			CONTRACTOR:
			FIELD:
OWNER: (Name and address)	DATE OF ISSUANCE:	6/7/2011	OTHER:
Avesta Oak Street LP			
307 Cumberland Ave	CONTRACT FOR:	Construction	
Portland ME 04101			
FROM ARCHITECT: (Name and address)	CONTRACT DATE:	1/14/2011	
CWS Architects	•		
434 Cumberland Avenue			
Portland, ME 04101			
TO CONTRACTOR: (Name and address)	ARCHITECT'S PROJECT NUMBER:	07.446	
Wright-Ryan Construction			
10 Danforth Street		•	•
Portland, ME 04101			
Please submit an itemized proposal for changes in to the Contract Documents described herein. With notify the Architect, in writing, of the date on whi	nin Zero (0) days, the Contractor must sub		
THIS IS NOT A CHANGE ORDER, A CONSTRUCTIO WORK DESCRIBED IN THE PROPOSED MODIFICAT		O PROCEED WITH THE	
DESCRIPTION:			
Provide and install conduit from the northeast c	corner of the alley to the mechanical room	m as indicated on the	attached CSK-
4. This conduit shall be a substitution for the 1	1/2" conduit shown in CSK-1 and SKE-	1.	
ATTACHMENTS.			
CSK-4			
REQUEST BY THE ARCHITECT:			
LEGOLOT DI TILL ANCHILLOT.			
n .1 -			
/ lu dan		George Lavigne	
() () T		Maine Licensed Arcl	nitect
		CWS Architects	
(Signature)		(Printed name and t	itle)

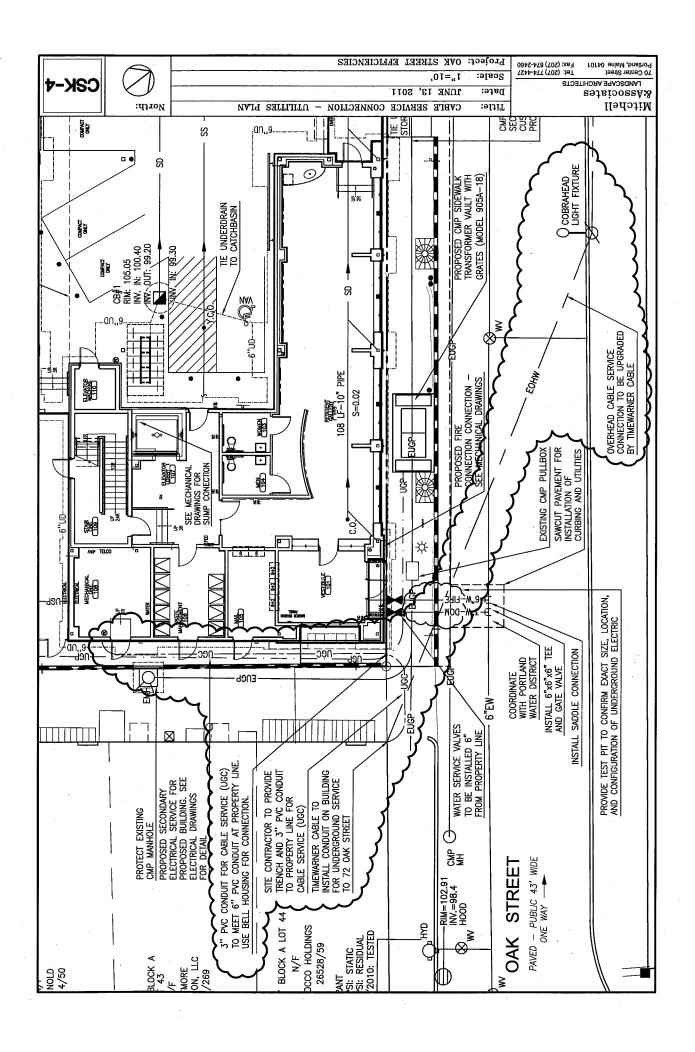

	kequest		
PROJECT: (Name and address)	PROPOSED REQUEST NUMBER:	4	OWNER:
Oak Street Lofts			ARCHITECT:
72 Oak Street		CONS	TRUCTION MANAGER:
Portland, ME 04101			CONTRACTOR:
OWNED: (Name and address)	DATE OF ISSUANCE:	6/43/3044	FIELD:
OWNER: (Name and address) Avesta Oak Street LP	DATE OF ISSUANCE:	6/13/2011	OTHER:
307 Cumberland Ave	CONTRACT FOR: C	Construction	
Portland ME 04101	CONTRACTION. C	CONSTRUCTION	
Totalia ME 04101			
FROM ARCHITECT: (Name and address)	CONTRACT DATE:	1/14/2011	
CWS Architects			
434 Cumberland Avenue			
Portland, ME 04101	•		
TO CONTRACTOR: (Name and address)	ARCHITECT'S PROJECT NUMBER:	07.446	
Wright-Ryan Construction			
10 Danforth Street			
Portland, ME 04101			
	which proposal submission is anticipated. CTION CHANGE DIRECTIVE OR A DIRECTION TO ICATIONS.	PROCEED WITH THE	
THIS IS NOT A CHANGE ORDER, A CONSTRUCTION WORK DESCRIBED IN THE PROPOSED MODIFIED DESCRIPTION.	CTION CHANGE DIRECTIVE OR A DIRECTION TO ICATIONS.		
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THIS IS NOT A CHANGE ORDER, A CONSTRUCT WORK DESCRIBED IN THE PROPOSED MODIFIED DESCRIPTION: Provide substitutions and modifications to the control of the	cTION CHANGE DIRECTIVE OR A DIRECTION TO ICATIONS. The light fixture schedule and layout as follows the Type J fixtures for Type Bless P-87 LED and P8071-28STR for P708 ixtures for Type Kless P7250-09EBWB for Progress P3927-ure in location as indicated on A2.1 wired	: 52-09EBWB 30EBWB with adjacent ceiling fix	25 total 37 total 37 total
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THIS IS NOT A CHANGE ORDER, A CONSTRUCT WORK DESCRIBED IN THE PROPOSED MODIFIED TO SECRIPTION: Provide substitutions and modifications to the At Women 103 and Men 104, substitute - At all Type F fixtures, substitute Progres - At all unit kitchens, substitute Type J fire - At all unit bathrooms, substitute Progres - At Elevator Lobby, provide Type Q fixt - At stair one and two, provide credit for (Note that the necessary landing lights a - At stairs one and two, substitute Progres - At Stairs one - At Stairs	cTION CHANGE DIRECTIVE OR A DIRECTION TO ICATIONS. The light fixture schedule and layout as follows the Type J fixtures for Type Blass P-87 LED and P8071-28STR for P708 extures for Type Klass P7250-09EBWB for Progress P3927-ure in location as indicated on A2.1 wired extra type B fixture shown above intermediate indicated on previous sheets) ess P7133-30EB for Type B at intermediate.	: 52-09EBWB 30EBWB I with adjacent ceiling five ediate landings on E1.4 ate landings only	25 total 37 total 37 total ctures 1 total 2 total
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	Fixture Type	Description	Model #	Cost Quar	Quantity Tota	Total Cost	Remarks		
Specs/	1	Progress Lighting,		-					
Submittal	TYPE B	Wrap-Arounds Lithonia Lighting,	P/186-30EB	\$125.70	-2	-\$251.40	Remove (2) from 1st fl. Toilets Replace Speced fixture to Type J in 1st fl.	Architectural Substitution	
Keplace	lype J	Fiush mount	11/62 PSI	\$105.00	2	\$210.00	lollets		
<u> </u>						-\$41.40			
Submittals	Type F	Progress Lighting, Wall Sconce	P7052-09EBWB	\$245.55	-25	-\$6,138.75	Remove (25) from 1st Fl.	A/E Coordination Cans Not Wall Sconces	
Replace	Type F	Led Recessed Downlight Housing	P87-LED	\$29.40	. 52	\$735.00	Replace with 6" LED Recessed Can Assembly		
Replace	Type F	Led Recessed Downlight trim	P8071-285TR	\$237.30	25	\$5,932.50			
Total						\$528.75			
Space/		Dographic Control							
Submittal	Туре Н	Soft Clouds Lithonia Lighting	P7278-60EB	\$335.25	-37	-\$12,404.25	Remove (37) from all unit kitchens Renlace Speced fixture to Type Lin all unit	A/E Coordination	
Replace	Type J	Flush mount	11762 PST	\$105.00	37	\$3,885.00	kitchens		
Total						-\$8,519.25			
Submittal	Type K	Progress Lighting, Close to Ceiling Progress Lighting.	P3927-30EBWB	\$108.30	-37	-\$4,007.10	Remove (37) from all unit Bathrooms	Required Substitution	
Replace	Туре К	Close to Ceiling	P7250-09EBWB	\$283.80	37	\$10,500.60	Replace (37) in all unit Bathrooms		
Total					,	\$6,493.50			
Add	Type Q	PLC Lighting, Pendant	PLC-7289-PC	\$593.99	↔	\$593.99	Add to Elevator Lobby	A/E Coordination	
Total						\$593.99			
Grand Total						-\$944.41			
Discuss- Typ	pe B at Stair Landing	Discuss- Type B at Stair Landing where wall mounted.							
Specified	Type F	Wall Sconce	P7089-20EBWB	\$130.95	-25	-\$3,273.75	No longer available through Progress Lighting.		
Specified	Type k	Progress Lignting, Close to Ceiling	P2858-09EBWB	\$400.20	-37	-\$14,807.40	No longer avallable through Progress Lighting.		
		3							

Work Change Proposal Request

PROJECT: (Name and address)	PROPOSED REQUEST NUMBER:	5	OWNER:
Oak Street Lofts			ARCHITECT:
72 Oak Street			CONSTRUCTION MANAGER:
Portland, ME 04101			CONTRACTOR:
			FIELD:
OWNER: (Name and address)	DATE OF ISSUANCE:	6/14/2011	OTHER:
Avesta Oak Street LP			
307 Cumberland Ave	CONTRACT FOR: C	Construction	
Portland ME 04101			
FROM ARCHITECT: (Name and address)	CONTRACT DATE:	1/14/2011	
CWS Architects			
434 Cumberland Avenue			
Portland, ME 04101			•.
TO CONTRACTOR: (Name and address)	ARCHITECT'S PROJECT NUMBER:	07.446	
Wright-Ryan Construction			
10 Danforth Street			
Portland, ME 04101			

Please submit an itemized proposal for changes in the Contract Sum and Contract Time for proposed modifications to the Contract Documents described herein. Within Zero (0) days, the Contractor must submit this proposal or notify the Architect, in writing, of the date on which proposal submission is anticipated.

THIS IS NOT A CHANGE ORDER, A CONSTRUCTION CHANGE DIRECTIVE OR A DIRECTION TO PROCEED WITH THE WORK DESCRIBED IN THE PROPOSED MODIFICATIONS.

DESCRIPTION:

5a) Construction documents specify both plastic laminate counters (architectural) and 25" wide vanity tops with integral sinks. The contractor is asked to provide pricing to substitute Elkay PSLVR-1917 stainless steel sinks installed in the plastic laminate counters in place of the specified Swan "Chesapeake" vanity top at all (37) P-2 locations. Faucet, drain and trap shall be unchanged.

5b) As a related but separate item, the owner would like to investigate pricing of solid surfacing material in place of post-formed plastic laminate vanity tops. The contractor is asked to provide pricing for Corian solid surfacing in "Sahara" finish with "Double Eased" edge and backsplash consistent with detailing and elevations of Oct 25 contract drawings. Sinks shall be Elkay PSLVR-1917 as indicated above. Contractor's pricing shall address the counter substitution only.

ATTACHMENTS:

None


REQUEST BY THE ARCHITECT:

George Lavigne Maine Licensed Architect CWS Architects

(Printed name and title)

(Signature)


PROJECT: (Name and address)	PROPOSED REQUEST NUMBER:	6	•	OWNER:
Dak Street Lofts				ARCHITECT:
2 Oak Street		•	CONSTRUCTION	ON MANAGER:
ortland, ME 04101			C	CONTRACTOR:
VNER: (Name and address)	DATE OF ISSUANCE:	7/26/2011		FIELD:
vesta Oak Street LP				
07 Cumberland Ave	CONTRACT FOR:	Construction		
ortland ME 04101				
OM ARCHITECT: (Name and address)	CONTRACT DATE:	1/14/2011		
NS Architects				
4 Cumberland Avenue	•			
ortland, ME 04101				
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CONTRACTOR: (Name and address)	ARCHITECT'S PROJECT NUMBER:	07.446	•	
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Danforth Street				
ortland, ME 04101				4
HIS IS NOT A CHANGE ORDER, A CONSTRUC	CTION CHANGE DIRECTIVE OR A DIRECTION TO	nit this proposal or		
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Work Change Proposal Request PROPOSED REQUEST NUMBER: 7 OWNER: ARCHITECT: Oak Street Lofts CONSTRUCTION MANAGER: 72 Oak Street CONTRACTOR: Portland, ME 04101 FIELD: **OWNER:** (Name and address) DATE OF ISSUANCE: OTHER: 10/14/2011 Avesta Oak Street LP 307 Cumberland Ave **CONTRACT FOR:** Construction Portland ME 04101 FROM ARCHITECT: (Name and address) **CONTRACT DATE:** 1/14/2011 **CWS Architects** 434 Cumberland Avenue Portland, ME 04101 ARCHITECT'S PROJECT NUMBER: TO CONTRACTOR: (Name and address) 07.446 Wright-Ryan Construction 10 Danforth Street Portland, ME 04101 Please submit an itemized proposal for changes in the Contract Sum and Contract Time for proposed modifications to the Contract Documents described herein. Within Zero (0) days, the Contractor must submit this proposal or notify the Architect, in writing, of the date on which proposal submission is anticipated. THIS IS NOT A CHANGE ORDER, A CONSTRUCTION CHANGE DIRECTIVE OR A DIRECTION TO PROCEED WITH THE WORK DESCRIBED IN THE PROPOSED MODIFICATIONS. Metal DESCRIPTION: At unit 204 (only) provide wood framed enclosure with GWB finish at sprinkler standpipe as per the attached SKA-14. Adjust electrical outlet location as necessary. ATTACHMENTS: SKA-14 **REQUEST BY THE ARCHITECT:** George Lavigne Maine Licensed Architect CWS Architects

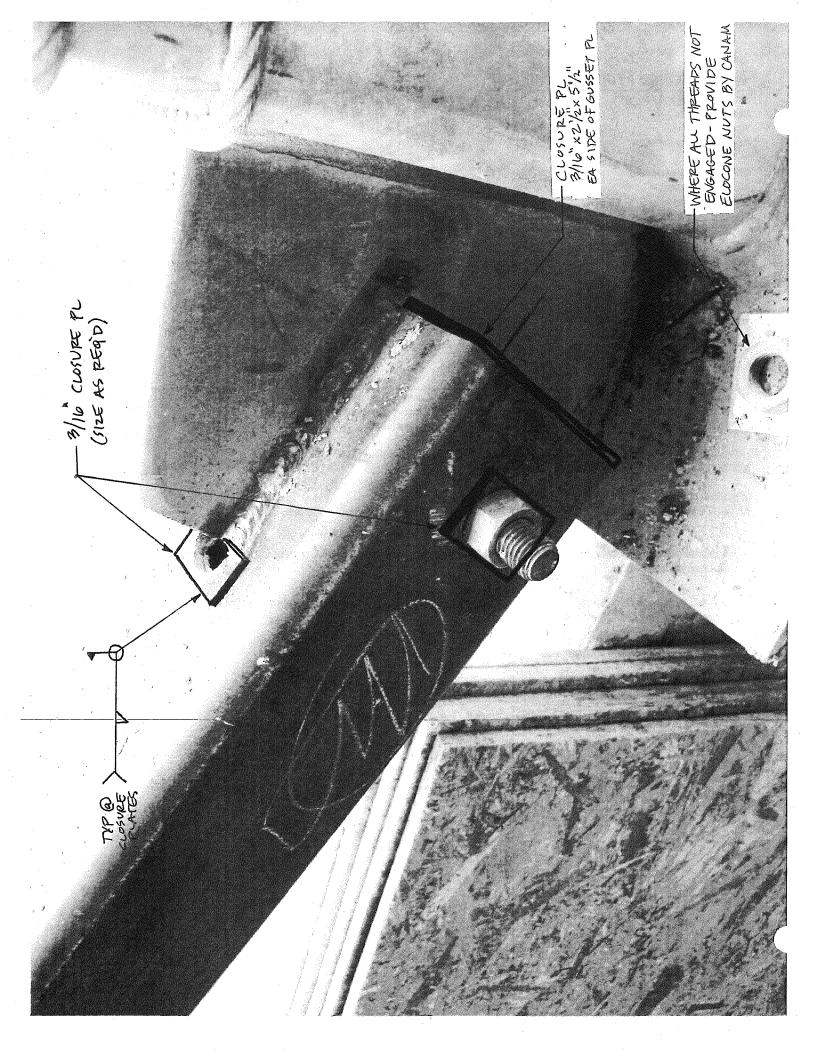(Printed name and title)

(Signature)



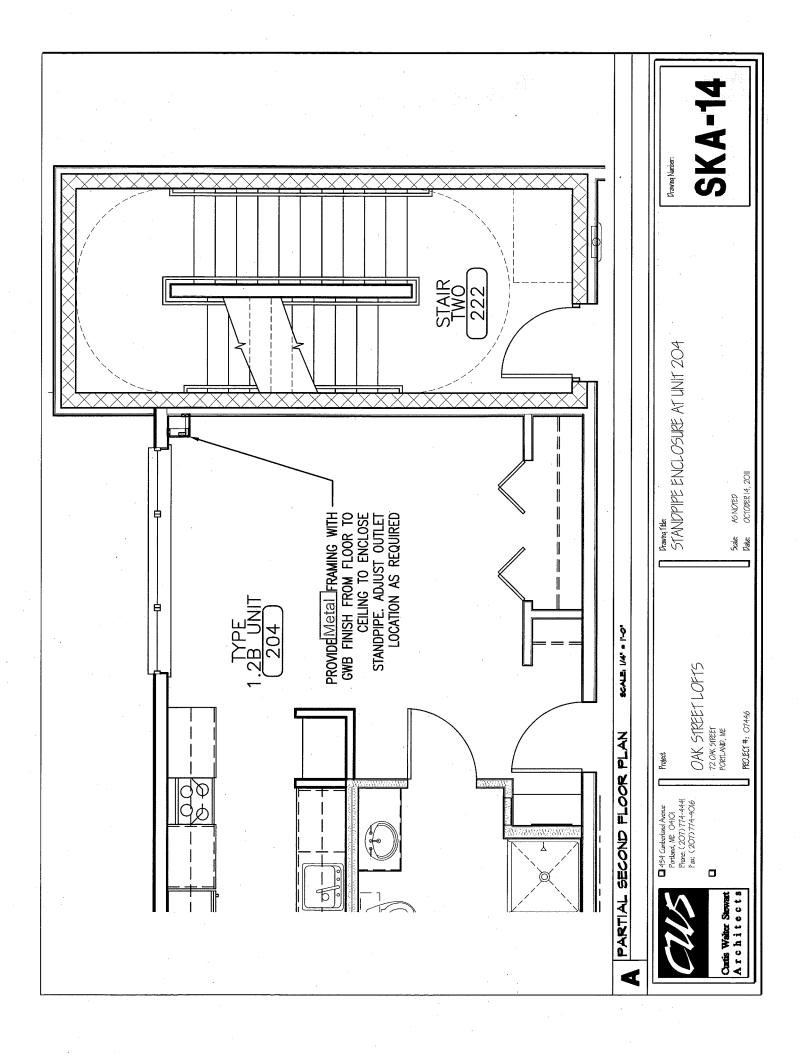Work Change Proposal Request PROPOSED REQUEST NUMBER: 8 OWNER: Oak Street Lofts ARCHITECT: 72 Oak Street CONSTRUCTION MANAGER: Portland, ME 04101 CONTRACTOR: FIELD: OWNER: (Name and address) **DATE OF ISSUANCE:** 10/14/2011 Avesta Oak Street LP **CONTRACT FOR:** Construction 307 Cumberland Ave Portland ME 04101 FROM ARCHITECT: (Name and address) **CONTRACT DATE:** 1/14/2011 **CWS Architects** 434 Cumberland Avenue Portland, ME 04101 TO CONTRACTOR: (Name and address) **ARCHITECT'S PROJECT NUMBER:** 07.446 Wright-Ryan Construction 10 Danforth Street Portland, ME 04101 Please submit an itemized proposal for changes in the Contract Sum and Contract Time for proposed modifications to the Contract Documents described herein. Within Zero (0) days, the Contractor must submit this proposal or

notify the Architect, in writing, of the date on which proposal submission is anticipated.

THIS IS NOT A CHANGE ORDER, A CONSTRUCTION CHANGE DIRECTIVE OR A DIRECTION TO PROCEED WITH THE WORK DESCRIBED IN THE PROPOSED MODIFICATIONS.

DESCRIPTION:

At Resident Work Room 223: in lieu of the design indicated on the October 25, 2010 drawings; provide supply and return ducts above the suspended acoustical celing and locate the grills as indicated on the attached SKM-8

ATTACHMENTS:

SKM-8

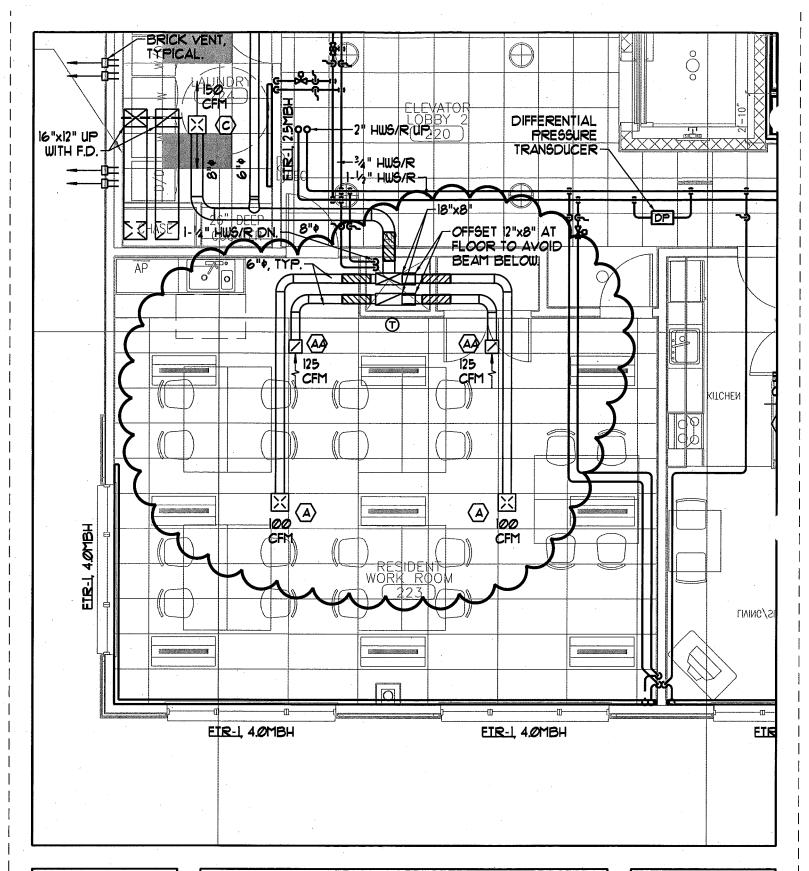
REQUEST BY THE ARCHITECT:

George Lavigne Maine Licensed Architect

CWS Architects

(Signature)

(Printed name and title)







DRAWING TITLE - PARTIAL 2nd FLOOR MECH PLAN
DESIGNED/CHECKED BY - SMR / SPD

DATE - I@/I4/II

SCALE - 3/I6"=1'-@"

Work Change Proposal	Poruset		
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PROJECT: (Name and address)	PROPOSED REQUEST NUMBER	9	OWNER: L
Oak Street Lofts	•		ARCHITECT:
72 Oak Street		1 - 1 - 1 - 1 - 1 - 1 - 1 - 1 - 1 - 1 -	CONSTRUCTION MANAGER:
Portland, ME 04101			CONTRACTOR:
OWNER: (Name and address)	DATE OF ISSUANCE	: 10/25/2011	FIELD:[OTHER:[
Avesta Oak Street LP	DATE OF ISSUANCE	10/25/2011	OTHER
307 Cumberland Ave	CONTRACT FOR	Construction	
Portland ME 04101	CONTRACTION	Construction	
Folliand ME 04101			
FROM ARCHITECT: (Name and address)	CONTRACT DATE	: 1/14/2011	
CWS Architects		. 1/1-7/2011	
434 Cumberland Avenue			
Portland, ME 04101			
1 Ottana, ME 04101			
TO CONTRACTOR: (Name and address)	ARCHITECT'S PROJECT NUMBER:	07.446	
Wright-Ryan Construction	ANOTHE OF NOVE OF NOMBER	07.440	
10 Danforth Street			
Portland, ME 04101			
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154 George and Assuce Partland, INE OHICH Page (207) 774-444 Fax: (207) 774-4016

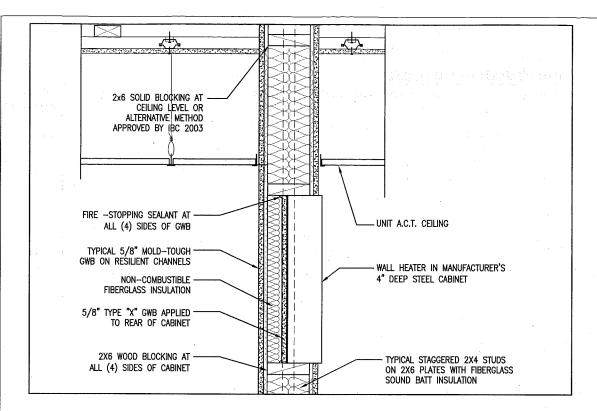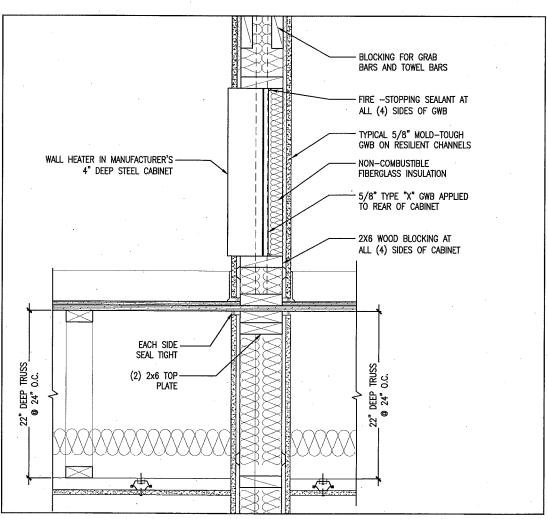AVESTA OAK STREET LP 307 GUNBERLAND ANE PORLAND NE OAIOI Project OAK STREET LOFTS

72 OAK SIPEET PORILAND, NE PROJECT #1 07.446 24E UNIT HEATER BLOCKING AT BATHROOM COMMON WALLS

5cale: 11/2" × 1'-0" Date: 10-25-11 vrzemu Nuroer;

SKA-15

Work Change Proposal Request PROJECT: (Name and address) PROPOSED REQUEST NUMBER: OWNER: 10 Oak Street Lofts ARCHITECT: 72 Oak Street CONSTRUCTION MANAGER: Portland, ME 04101 CONTRACTOR: FIELD: **OWNER:** (Name and address) **DATE OF ISSUANCE:** OTHER: 10/25/2011 Avesta Oak Street LP 307 Cumberland Ave **CONTRACT FOR:** Construction Portland ME 04101 FROM ARCHITECT: (Name and address) **CONTRACT DATE:** 1/14/2011 **CWS Architects** 434 Cumberland Avenue Portland, ME 04101 TO CONTRACTOR: (Name and address) **ARCHITECT'S PROJECT NUMBER:** 07.446 Wright-Ryan Construction 10 Danforth Street Portland, ME 04101 Please submit an itemized proposal for changes in the Contract Sum and Contract Time for proposed modifications to the Contract Documents described herein. Within Zero (0) days, the Contractor must submit this proposal or notify the Architect, in writing, of the date on which proposal submission is anticipated. THIS IS NOT A CHANGE ORDER, A CONSTRUCTION CHANGE DIRECTIVE OR A DIRECTION TO PROCEED WITH THE

WORK DESCRIBED IN THE PROPOSED MODIFICATIONS.

DESCRIPTION:

At rear yard, modify fence design as indicated and install stabilized surface pavers as indicated.

ATTACHMENTS:

CSK-5, Stabilized Surface Paver data.

REQUEST BY THE ARCHITECT:

George Lavigne

Maine Licensed Architect

CWS Architects

(Signature)

(Printed name and title)



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>:

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PRODUCTS

Duragreen

The open grid design of Duragreen makes them the natural choice for projects where erosion control, soil stabilization and the maintenance of green areas are important. Use for boat ramps, driveways, slopes, golf paths and more.

Product Type: Genest Eco Paver

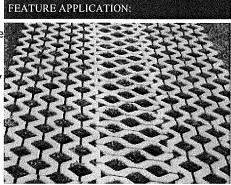
Manufacturer: Genest

Color: Smoke


Dimensions: 23.7" x 15.7" x 3.5"

Pieces per cube: 28 Weight per cube: 1710 Pieces per cube: 28 Square feet per cube: 72

Installation Guide: install.pdf



PRODUCT VIEW:

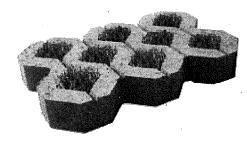

Add

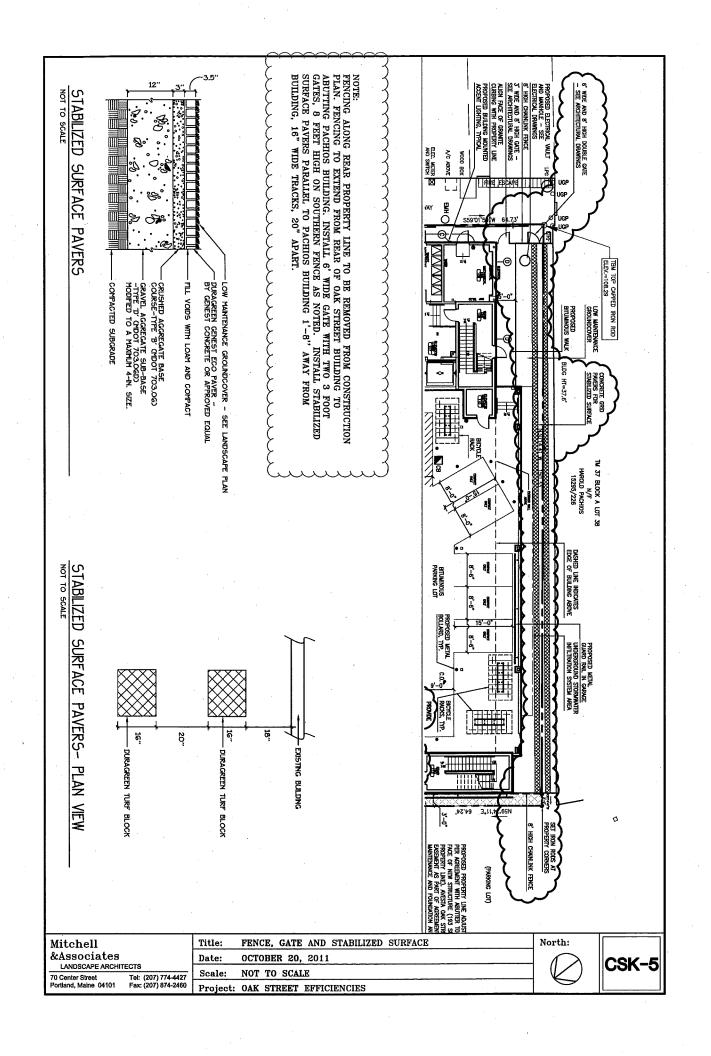
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PROJECT: (Name and address)	PROPOSED REQUEST NUMBER:	11	OWNER:
Oak Street Lofts	Comp indicate in itemperior		ARCHITECT:
72 Oak Street			CONSTRUCTION MANAGER:
Portland, ME 04101			CONTRACTOR:
OUNIED OF THE	DATE OF IOUVANOE	10/0/0044	FIELD:
OWNER: (Name and address) Avesta Oak Street LP	DATE OF ISSUANCE:	12/9/2011	OTHER:
307 Cumberland Ave	CONTRACT FOR:	Construction	
Portland ME 04101		OUT DE COUCH	
FROM ARCHITECT: (Name and address)	CONTRACT DATE:	1/14/2011	
CWS Architects			
434 Cumberland Avenue			
Portland, ME 04101			
TO CONTRACTOR: (Name and address)	ARCHITECT'S PROJECT NUMBER:	07.446	
Wright-Ryan Construction		57.7.5	
10 Danforth Street			
Portland, ME 04101			
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