
Deering Oaks Rehabilitation

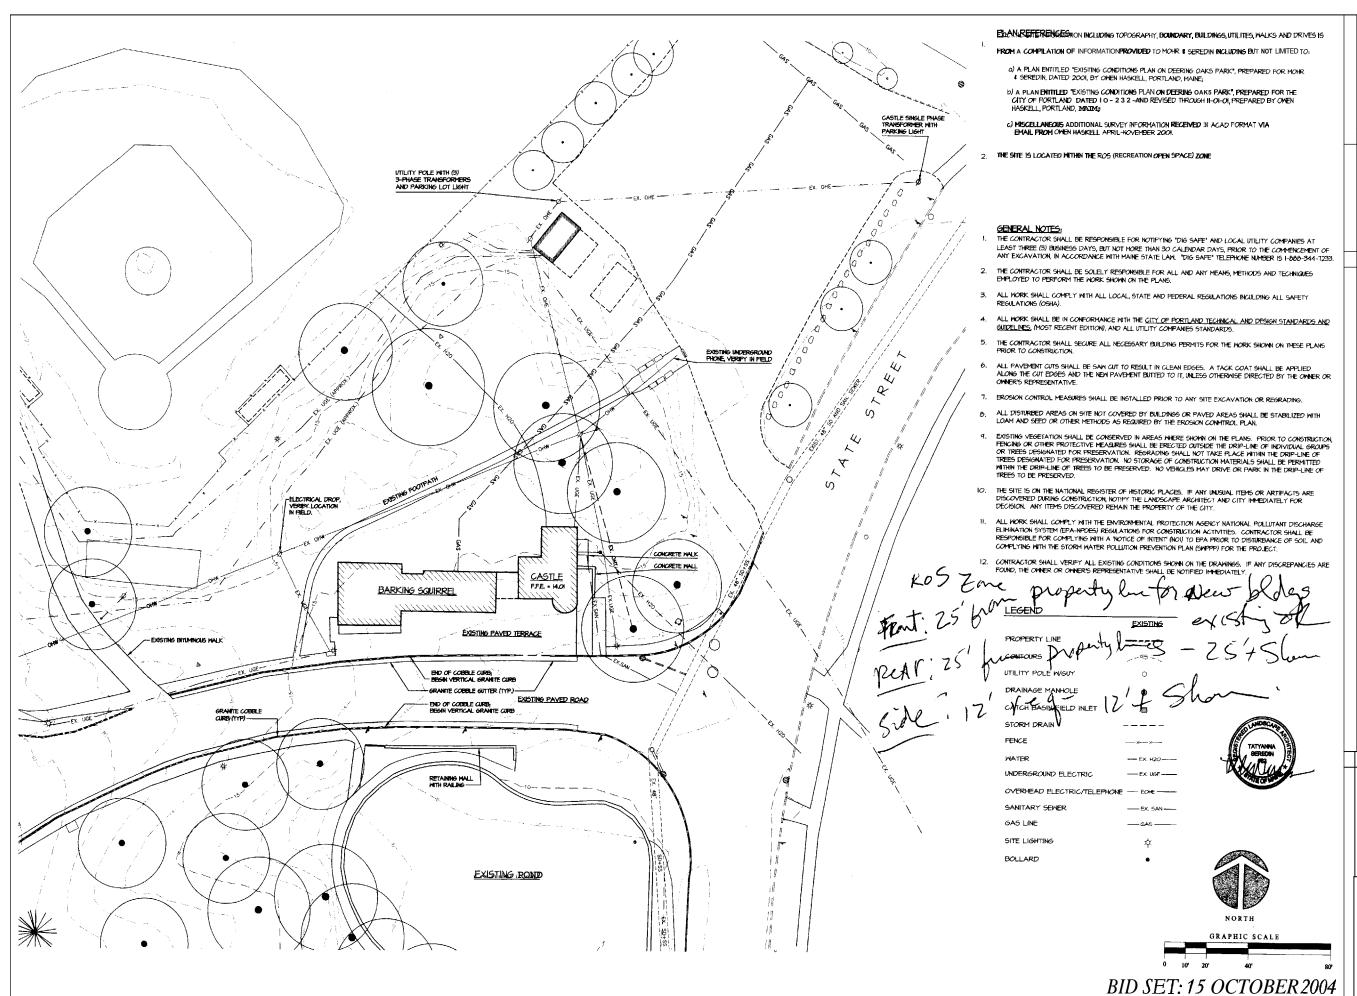

EI

Electrical Plan



TURK TRACEY & LARRY ARCHITECTS, LLC 92 EXCHANGE STREET PORTLAND, MAINE 04101

TEL. 207.761.9662 FAX. 207.761.9696


AND SURROUNDING GROUNDS Deering Oaks Rehabilitation

CITY OF PORTLAND PORTLAND, MAINE CASTLE

ALE: 1"@C20DBER 2004 RAWNBY: TS/MK

3VISIONS:

TLE: XISTING ONDITIONS

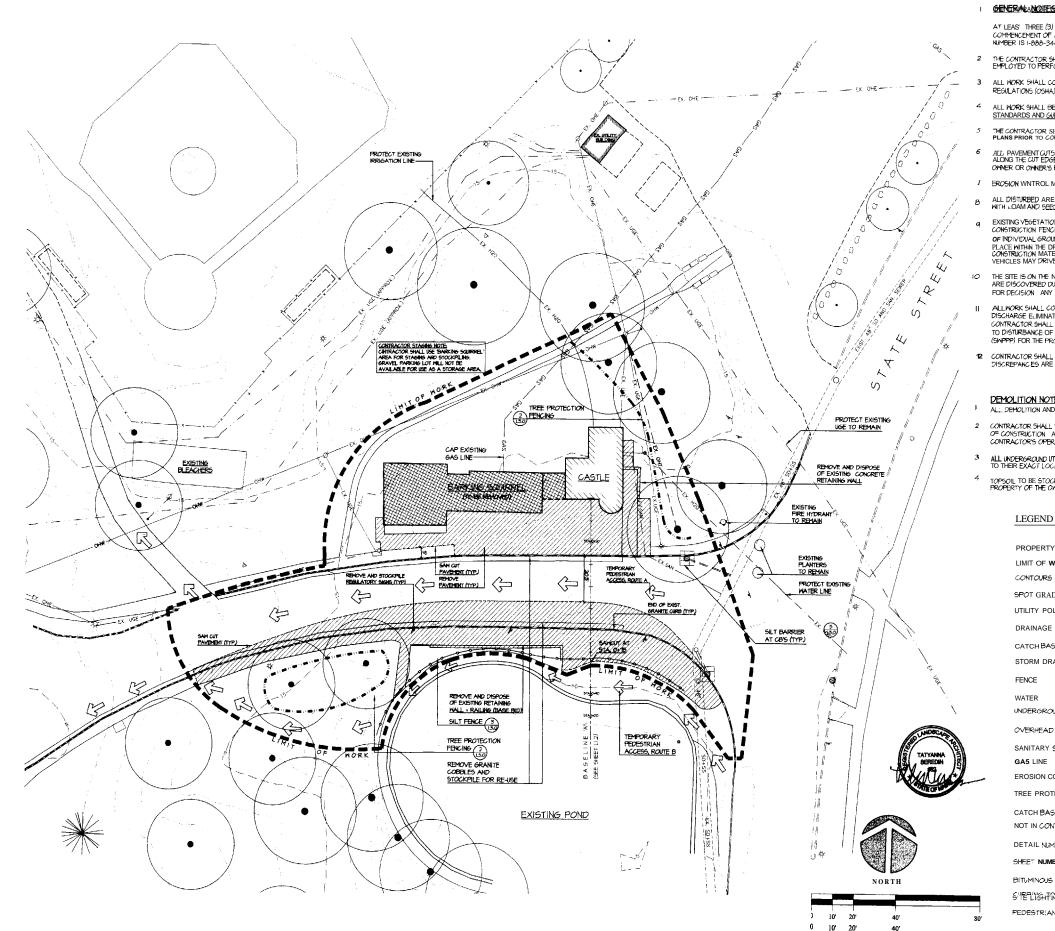

GENERALANCORFIGALL BE RESPONSIBLE FOR NOTIFYING DIG SAFE AND LOCAL UTILITY COMPANES

AT LEAS: THREE (3) BUSINESS DAYS BUT NOT MORE MAN 30 CALMDAU DAYS PRIM? TO THE COMMENCEMENT OF ANT EXCAVATION IN ACCORDANCE WITH MAINE STATE LAW. "DIG SAFE" TELEPHONE NUMBER IS 1-888-344 1233

- THE CONTRACTOR SHALL BE SOLELY RESPONSIBLE FOR ALL AND ANY MEANS METHODS AND TECHNIQUES EMPLOYED TO PERFORM T K WORK SHOWN ON THE PLANS
- ALL MORK SHALL COMPLY WITH ALL LOCAL STATE AND FEDERAL REGULATIONS INCULDING ALL SAFETY
- ALL WORK SHALL BE IN CONFORMANCE WITH THE CITY OF <u>PORTLAND</u> TECHNICAL <u>AND DESIGN</u> <u>STANDARDS AND GUIDELINES</u> (MOST RECEN) <u>EDITION</u>, AND ALL UTILITY COMPANIES STANDARDS
- THE CONTRACTOR SHALL SECURE ALL NECESSARY BUILDING PERMITS FOR THE MORK SHOWN ON THESE PLANS PRIOR TO CONSTRUCTION
- ALL PAVEMENT CUTS WALL BE SAN CUT TO RESULT IN CLEAN EDGES. A TACK WAT SHALL BE APPLIED ALONG THE CUT EDGES AND THE NEW PAVEMENT BUTTED TO IT UNLESS OTHERWISE DIRECTED BY THE OWNER OR OWNER'S REPRESENTATIVE
- EROSION WINTROL MEASURES SHALL BE INSTALLED PRIOR TO ANY SITE EXCAVATION OR REGRADING
- ALL DISTURBED AREAS OLD SITE NOT COVERED BY BUILDINGS OR PAVED AREAS SHALL BE STABILIZED WITH LOAM AND SEED OR OTHER METHODS AS REQUIRED BY THE EROSION CONMITTAL PLAN
- EXISTING VEGETATION WALL BE CONSERVED IN AREAS WHERE SHOWN ON T K PLANS PRIOR TO CONSTRUCTION FENCING OR OTHER PROTECTIVE MEASURES SHALL BE ERECTED OUTSIDE THE DRIP-LINE OF INDIVIDUAL GROUPS OR TREES DESIGNATED FOR PRESERVATION. REGRADING SHALL WITTAKE PLACE WITHIN THE DRIPLINE OF TREES DESIGNATED FOR PRESERVATION NO STORAGE OF COMBINED FOR PRESERVATION AND STORAGE OF COMBINED FOR PRESERVED ON STORAGE OF COMBINED FOR PRESERVED OF TREES TO BE PRESERVED NO VEHICLES MAY DRIVE OR PARK IN MEDRIPLINE OF TREES TO BE PRESERVED.
- THE SITE IS ON THE NATIONAL REGISTER OF HISTORIC PLACES IF A WUNGUAL ITEMS OR ARTIFACTS ARE DISCOVERED DURING CONSTRUCTION NOTIFY THE LANDSCAPE ARCHITECT AND CITY IMMED ATFLY FOR DECISION. ANY ITEMS DISCOVERED REMAIN THE PROPERTY OF THE CITY.
- ALLWORK SHALL COMPLY WIN THE ENVIRONMENTAL PROTECTION AGENCY NATIONAL POLLUTANT DISCHARGE ELIMINATIONSYSTEM (EPA NPDES) REGILATIONS FOR CONSTRUCTION ACTIVITIES CONTRACTOR SHALL BE RESPONSIBLE FOR COMPLYING WITH A NOTICE OF INTENT (NO!) TO EPA PRIOR TO DISTURBANCE OF MILL AND COMPLYING WITH THE STORM MATER POLLUTION PREVENTION PLAN
- 12 CONTRACTOR SHALL YERIFY ALL EXISTING CONDITIONS SHOWN ON THE DRAWINGS OF ANT DISCREPANCES ARE FOUND THE OWNER OR OWNER'S REPRESENTATIVE SHALL BE NOTIFIED IMMEDIATELY

DEMOLITION NOTES:

- ALL DEMOLITION AND REMOVALS SHALL CONFORM TO LOCAL STATE AND FEDERAL STANDARDS
- CONTRACTOR SHALL VERIFY LOCATIONS OF EXISTING LOCATIONS WITH DIG SAFE PRIOR TO THE STAR-OF CONSTRUCTION. A M EXISTING UNDERGROUND UTILITIES THAT ARE DAMAGED AS A RESULT OF THE CONTRACTOR'S OPERATIONS SHALL BE REPAIRED AT NO ADDITIONAL COST TO OWNER(S)
- ALL UNDERGROUND UTILITIES SHOWN ON THE PLANS ARE APPROXIMATE ONLY. NO WARRANTY IS MADE TO THEIR EXACT LOCATION
- TOPSOIL TO BE STOCKPILED SCREEENED AND RE-USED ON THE SITE $_{\rm N}$ L TOPSOIL TO REMAIN ON THE PROPERTY OF THE OWNER AND SHALL NOT BE REMOVED FROM THE SITE

	EXISTING	PROPOSED
PROPERTY LINE		
LIMIT OF WORK		
CONTOURS	-95~	
SPOT GRADE		
UTILITY POLE W/G/Y	0	
DRAINAGE MANHOLE	•	
CATCH BASIN/FIELD NLET	圝	
STORM DRAIN	~	

FENCE WATER --- EX H20---UNDERGROUND ELECTRIC

OVERHEAD ELECTRIC/TELEPHONE SANITARY SEMER GA5 LINE EROSION CONTROL FENCING

TREE PROTECTIONFENCING CATCH BASIN/FIELD INLET PROTECTION

NOT IN CONTRACT DETAIL NUMBER

SHEET NUMBER BITUMINOUS PAVEMENT TO BE REMOVED

SHEPLIGHTING DEMOVED

PEDESTRIAN ACCESS ROUTE

BID SEE 15 OCTOBER 2004

M.I.C.

(15.2)

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Architect

TURK TRACEY & LARRY ARCHITECTS, LLC 92 EXCHANGE STREET PORTLAND, MAINE 04101 TEL. 207.761.9662 FAX. 207.761.9696


GROUND AND SURROUNDING Deering Oaks Rehabilitation CITY OF PORTLAND PORTLAND, MAINE

ATE: 15 OCTOBER 2004 VISIONS: MSIONS:

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TE PREPARATION ND DEMOLITION PLAN

SHEET:

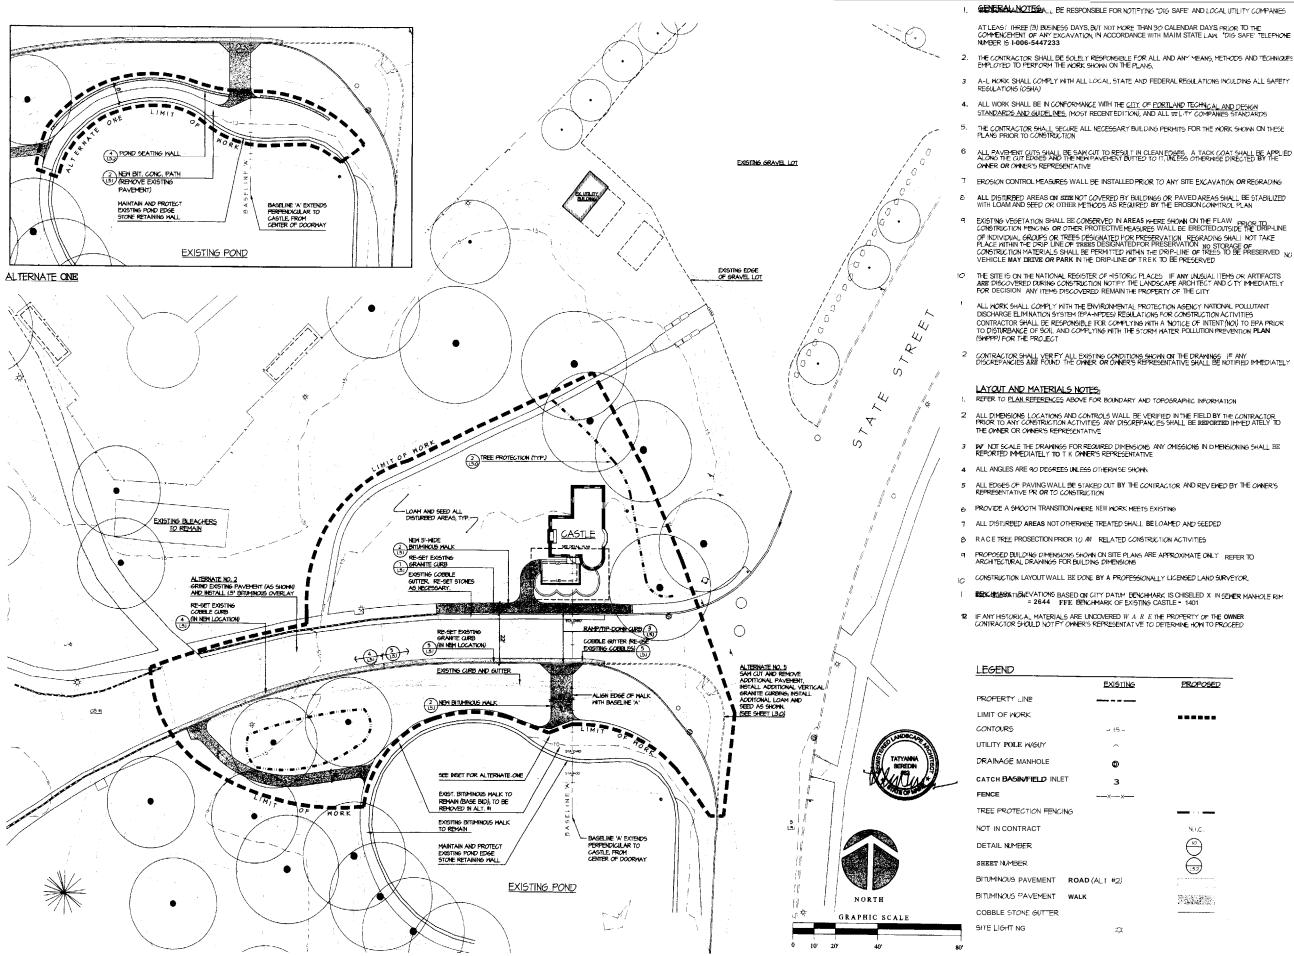

BID SET: **15** OCTOBER2004

ph: 1.207.871.0003 fax: 1.207.871.1419

TURK TRACEY & LARRY ARCHITECTS, LLC 92 EXCHANGE STREET PORTLAND, MAINE 04101

GROUNDS

SURROUNDING

AND

ATE: 15 OCTOBER 2004 `ALE: 1" = 20' RAWN BY: TS/MK


3VISIONS:

AYOUT AND

IATERIALS PLAN

Oaks Rehabilitation

TEL, 207.761.9662 FAX, 207.761.9696

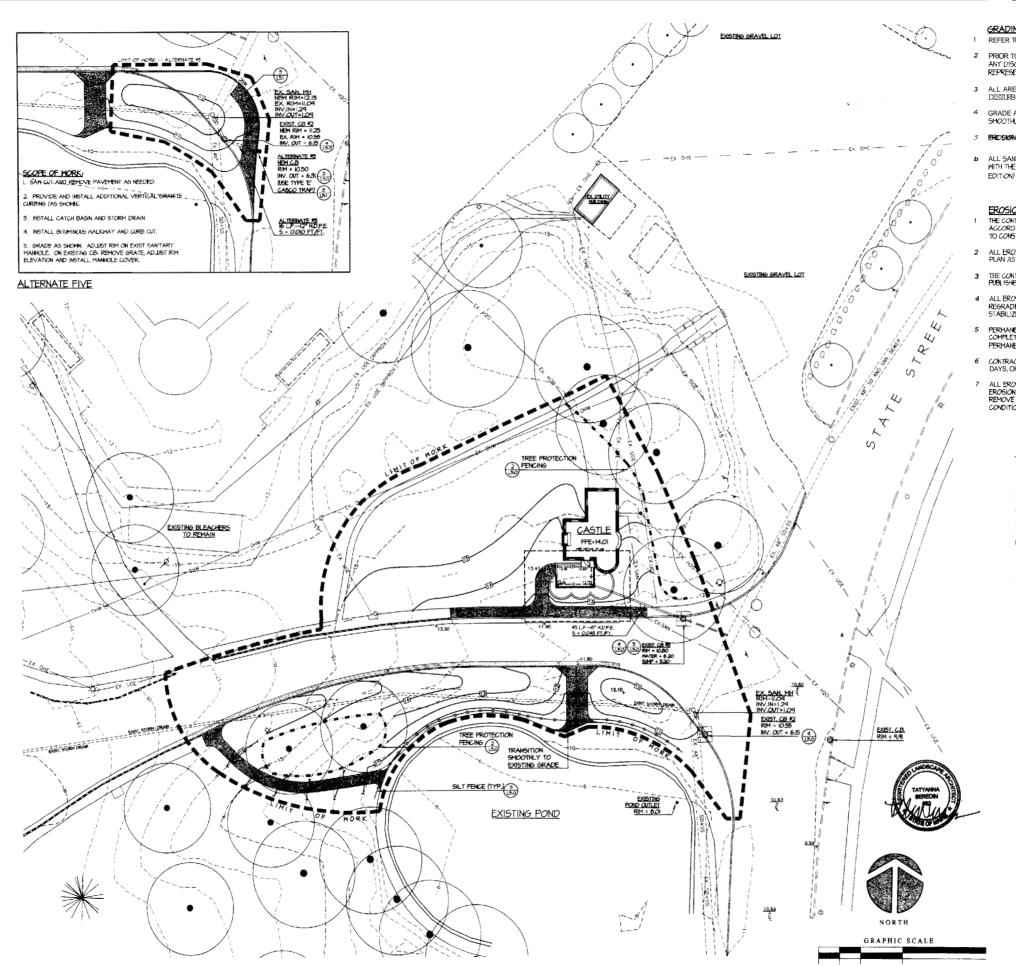

GRADING AND UTILITIES NOTES:

- REFER TO SHEET L. 2.0 FOR GENERAL NOTES
- PRIOR TO ANY CONSTRUCTION ACTIVITIES CONTRACTOR WALL VER FY ALL AFFECTED GRADES ANY DISCREPANCIES SHALL BE REPORTED IMMEDIATELY TO THE OWNER OR OWNER'S REPRESENTATIVE
- 3 ALL AREAS NOT REQUIRING GRADING SHALL BE LEFT UNDISTURBED CONTRACTOR SHALL NOT DISTURB THESE AREAS AND SHALL PRESERVE EXISTING VEGETATION
- 4 GRADE ALL NEW WORK FOR POSITIVE DRAINAGE AND NO PUDDLING MATCH EXISTING GRADES SMOOTHLY AND CONTINUOUSLY
- ENCOMMADON TROUT MEASUREMENT OUTLETS OF ALL STORM DRAINS SHALL REMAIN IN PLACE FOR
- b ALL SANITARY SEWER GLEAN OUT LOCATIONS WORK, AND MATERIALS SHAUBE IN CONFORMANCE WITH THE CITY OF PORTLAND TECHNICAL AND DESIGN STANDARDS AND GUIDE, INES (MOST RECENT

- EROSION CONTROL:
 THE CONTRACTOR SHALL INSTALL ALL EROSION AND SEDIMENTATION CONTROL MEASURES IN
 ACCORDANCE WITH THE 'EROSION CONTROL PLAN' AS SHOWN ON DRAWINGS AND AS SPECIFIED PRIOR
- 2 ALL EROSION CONTROL MEASURES SHALL BE INSTALLED IN ACCORDANCEWITH THE EROSION CONTROL PLAN AS OUTLINE IN THE PROJECT MANUAL
- 3 THE CONTRACTOR SHALL WMPLY WITH THE MAIM EROSION AND SEDIMENT CONTROL EMPS MANUAL AS PUBLISHED BY THE MAIM DEPARTMENT OF ENVIRONMENTAL PROTECTION 2003 OR LATEST EDITION
- 4 ALL EROSION CONTROL MEASURES SHALL BE INSTALLED PRIOR TU ANY 5 TE EXCAVATION OR REGRADING ALL DISTURBED AREAS ON SITE NOT COVERED BY BUILDINGS OR PAVED AREA? SHALL BE STABILIZED WITH LOAM AND SEED OR OTHER METHOD'S AS REQUIRED BY THE EROSION CONTROL RAN
- PERMANENT SEEDING OR STABILIZATION SHALL BE CARRIED OUT IMMEDIATELY AFTER FINAL GRADING IS COMPLETED OR TEMPORARY MEASURES SHALL BE APPLIED SUCH AS MIJ CHING OR SEEDING LIVIL PERMANENT MEASURE ARE IN W E
- 6 CONTRACTOR SHALL STABILIZE ANY SOIL STOCKPILES WHICH WILL REMAIN UNUSED FOR MORE THAN 1 DAYS, OR PRIOR TO A STORM EVENT
- ALL EROSION CONTROL SHALL BE ROUTINELY INSPECTED AND REPAIRED IN ACCORDANCE WITH THE EROSION CONTROL PLANFOR THE DURATION OF THE PROJECT UNTIL, ALL AREAS ARE STABILIZED REMOVE ACCUMULATED SILT AND SEDIMENT AS SPECIFIED AND MAINTAIN SILT FENCE IN GOOD CONDITION

LEGEND		
	EXISTING	PROPOSED
PROPERTY LINE		
LIMIT OF WORK		
CONTOURS	-45 \	<u> </u>
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UTILITY POLE WGUY	•	
DRAINAGE MANHOLE	0	● SD MH#
CATCH BASIN/FIELD INLET	皇	■ CB #I
STORM DRAIN	- 	STORM DRAIN
UNDERDRAIN		
FENCE	 _~~-	
WATER	EX H2O	
UNDERGROUND ELECTRIC	—Ex E	
OVERHEAD ELECTRIC/TELEPHONE	EOHE	
SANITARY SEWER	E%AN	
6 A 5 LINE	GAS	—GAS—
CLEANOUT		· C.O.
EROSION CONTROL FENCING		
TREE PROTECTION FENCING		
CATCH BASIN/FIELD INLET PROTE	ECTION	
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SHEET NUMBER		(L5.2)
BITUMINOUS PAVEMENT NALK		
COBBLE STOYE CUTTER		
SITE LIGHTING	\$	



ATCHIRCT:
TURK TRACEY & LARRY
ARCHITECTS, LLC
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PORTLAND, MAINE 04101
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FAX. 207.761.9696


AND SURROUNDING GROUNDS Deering Oaks Rehabilitation CITY OF PORTLAND PORTLAND, MAINE CASTLE

EVISIONS:

TLE:

RADING AND RAINAGE PLAN

BID SET: IS OCTOBER 2004

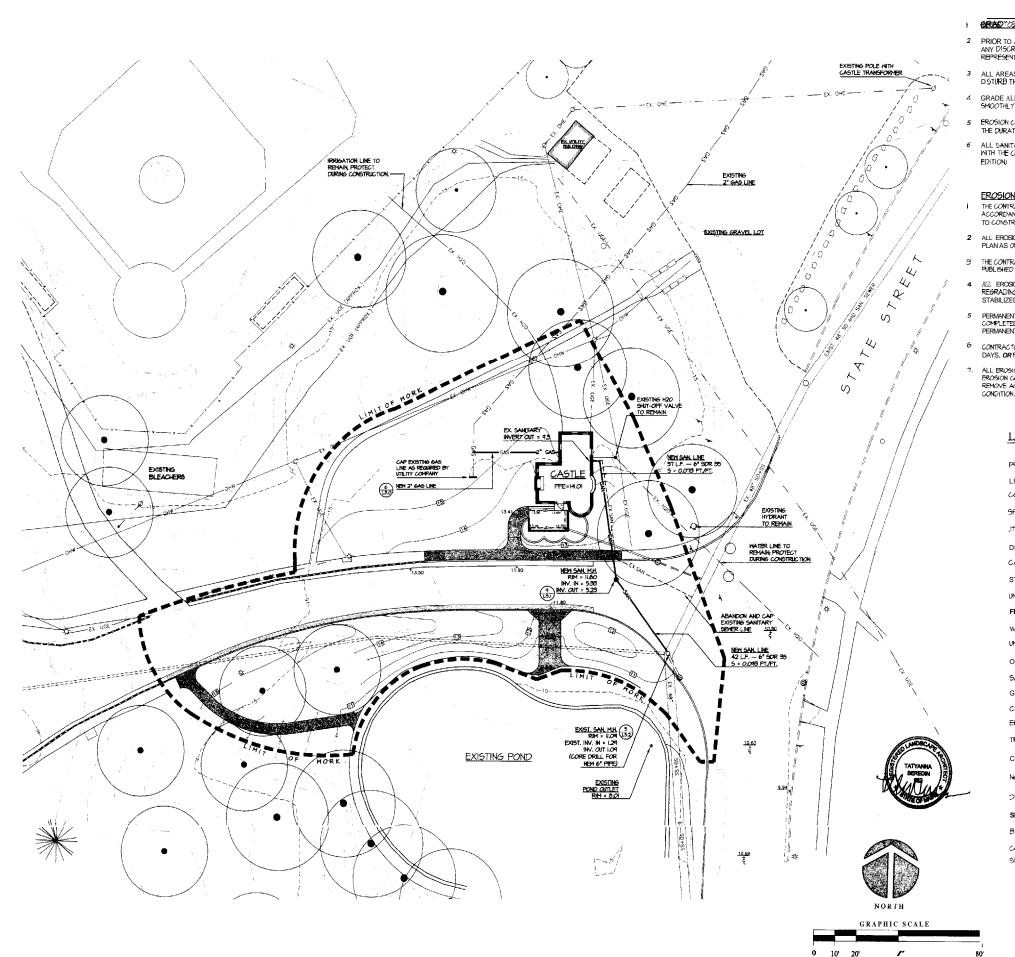

GRAD "OSSAND ILZILI INTIRSINDIRES NOTES

- PRIOR TO ANT CONSTRUCTION ACTIVITIES CONTRACTOR SHALL VERIFY ALL AFFECTED GRADES ANY DISCREPANCIES SHALL BE REPORTED IMPEDIATELY TO THE OWNER OR OWNERS REPRESENTATIVE
- ALL AREAS NOT REQUIRING GRADING SHALL BE LEFT UNDISTURBED. CONTRACTOR SHALL NOT DISTURB THESE AREAS AND SHALL PRESERVE EXISTING VEGETATION
- GRADE ALL NEW WORK FOR POSITIVE DRAINAGE AND NO PUDDLING WATCH EXISTING GRADES SMOOTHLY AND CONTINUOUSLY
- EROSION CONTROL MEASURES AT OUTLETS OF ALL STORM DRAINS SHALL REMAIN IN PLACE FOR THE DURATION OF THE PROJECT
- ALL SANITARY SEMER CLEAN OUT LOCATIONS WORK AND MATERIALS SHALL BE IN CONFORMANCE WITH THE CITY OF PORTLAND TECHNICAL AM) DESIGN STANDARDS AND GUIDELINES (MOST RECENT

- EROSION CONTROL:
 THE CONTRACTOR WALL INSTALL ALL EROSION AND SEDIMENTATION CONTROL MEASURES IN
 ACCORDANCE WITH THE EROSION CONTROL PLAN' AS SHOWN ON DRAWINGS AMP AS SPECIFIED PRIOR
 TO CONSTRUCTION
- 2 ALL EROSION CONTROL MEASURES SHALL AI INSTALLED IN ACCORDANCE WITH THE EROSION CONTROL PLAN AS OUTLINE IN THE PROJECT MANUAL.
- 3 THE CONTRACTOR SHALL COMPLY WITH THE MAINE EROSION AND SEDIMENT CONTROL BMPS MANUAL AS PUBLISHED BY THE MAINE DEPARTMENT OF ENVIRONMENTAL PROTECTION 2003 OR LATEST EDITION
- ALL EROSION CONTROL MEASURES SHALL BE INSTALLED PRIOR TO ANY SITE EXCAVATION OR REGRADING ALL DISTURBED AREAS ON SITE NOT COVERED BY BUILDINGS OR PAVED AREAS SHALL BE STABILIZEDWITH LOAM AND SEED OR OWR METHODS AS REQUIRED BY THE EROSION CONTROL PLAN
- PERMANENT SEEDING OR STABILIZATION SHALL BE CARRIED OUT MMEDIATELY AFTER FINAL GRADING IS COMPLETED OR TEMPORARY MEASURES WALL BE APPLIED SUCH AS MULCHING OR SEEDING UNTL PERMANENT MEASURES ARE IN PLACE
- CONTRACTOR WALL STABILIZE ANY 501: STOCKPILES WHICH WILL REMAIN UNISED FOR MORE THAN 7 DAYS, OR PRIOR TO A STORM M N T
- ALL BROSION CONTROL SHALL BE ROUTINELY INSPECTED AND REPAIRED IN ACCORDANCE WITH THE BROSION CONTROL PLAN FOR THE DURATION OF THE PROJECT WITH, ALL AREAS ARE STABILIZED, REMOVE ACCUMULATED SILT AND SEDIMENT AS SPECIFIED AND MAINTAIN SILT FENCE IN 6000

LEGEND	Fidemia	
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PROPERTY LINE		
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EROSION CONTROL FENCING		
TREE PROTECTION FENCING		
CATCH BASIN/FIELD INLET PROT	ECTION	匠
NOT IN CONTRACT		N.I.C.
DETAIL NUMBER		(i)
SHEET NUMBER		(3.2)
BITUMINOUS PAVEMENT WALK		
COBBLE STONE GUTTER		
SITE LIGHTING	*	



ph: 1.207.871.0003 fax: 1.207.871.1419


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AND SURROUNDING GROUNDS Deering Oaks Rehabilitation CITY OF PORTLAND PORTLAND, MAINE


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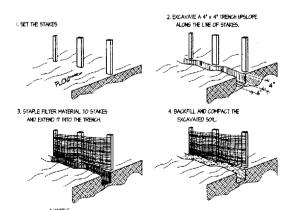


TREE PROTECTIVE PLANKING
1 DO NOT 10 SALE



NOTE: ERECT TIREE PROTECTIVE FENCING AROUND ALL TREES SHOWN ON THE PLANS TO BE PROTECTED. TAKE SPECIAL CARE NOT TO COMPACT OR STORE MATERIAL INDER DRIP LINE OF ENSITING TREES.

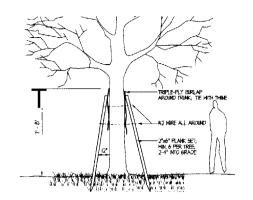

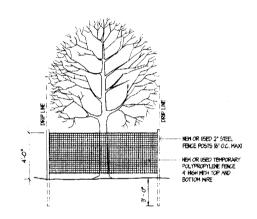


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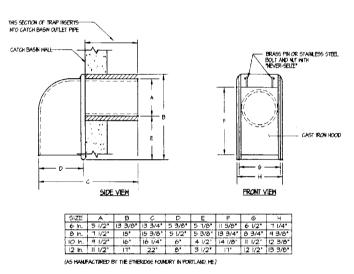
1 USE 4 TO 4 1/2" STAKES EMBEDDED TO A MINIMUM OF I FOOT

2 EXTRA-STREMSTH FILTER FABRIC REQUIRED

3 PREFABRICATED SILTATION FENCING MAY BE SUBSTITUTED
WHERE APPROVED AND INSTALLED IN ACCORDANCE WITH MANUFACTURERS
RECOMMENDATIONS AND INSTALLATION INSTRUCTIONS.






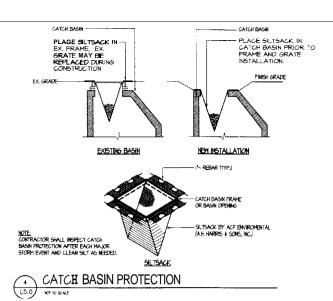



NOTE:
COMPRACTOR UTILIZE THE "CASCO TRAP" AS MANIFACTURED BY THE ETHERIDGE FOUNDRY.
APPROVED EQUIVALENT AS SUPPLIED BY THE LEBARON FOUNDRY, MODEL # IL, 202. "STANDARD CATCH BASIN TRAP



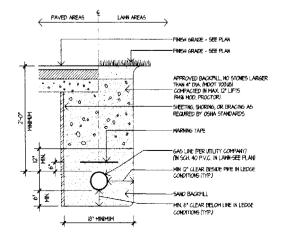

6 GAS LINE TRENCH L5.0 NOT TO SCALE

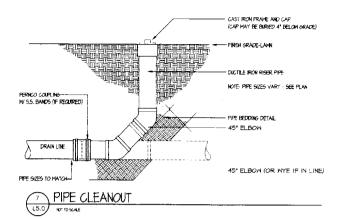

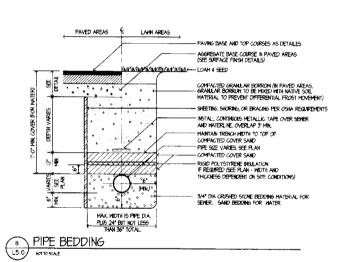

SITE DETAILS

DATE: 15 OCTOBER 2004 CALE: ASSHOWN DRAWN BY: TS/MK

EVISIONS:

ph: 1.207.871.0003 fax: 1.207.871.1419

TURK TRACEY & LARRY ARCHITECTS, LLC 92 EXCHANGE STREET PORTLAND, MAINE 04101


AND SURROUNDING GROUNDS


CITY OF PORTLAND PORTLAND, MAINE


Deering Oaks Rehabilitation


TEL. 207,761.9662 FAX. 207,761.9696


BID SEE 15 OCTOBER 2004

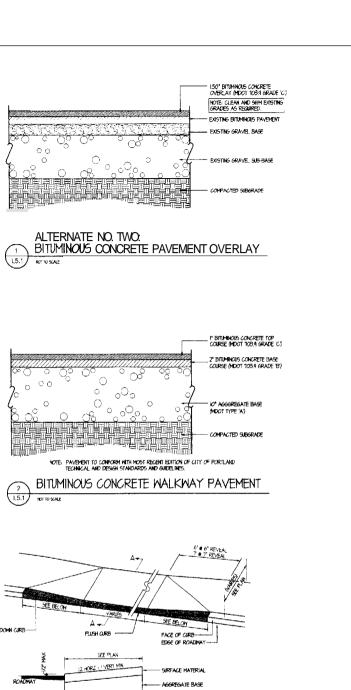

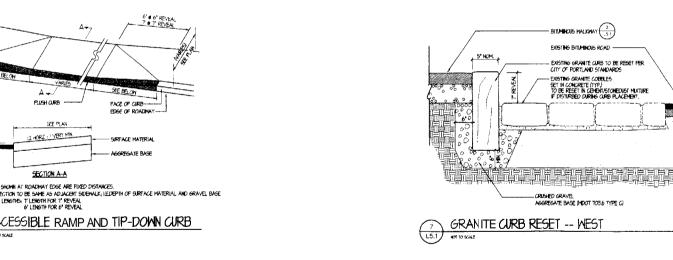

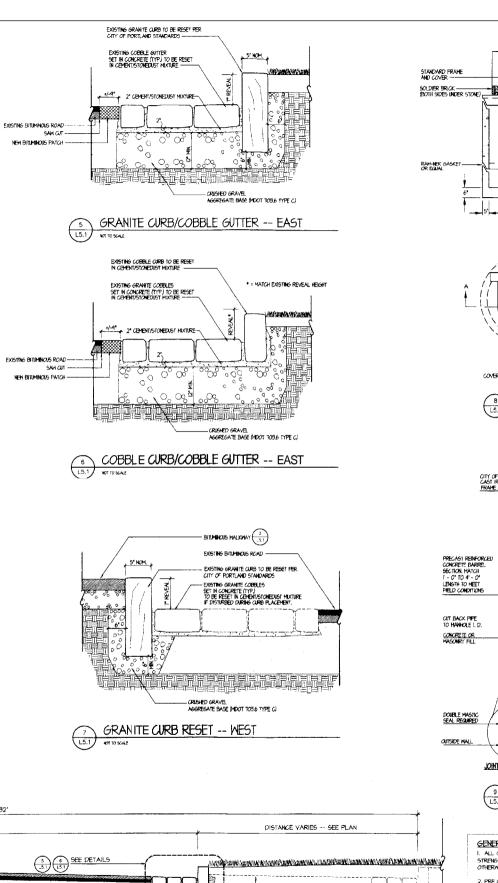


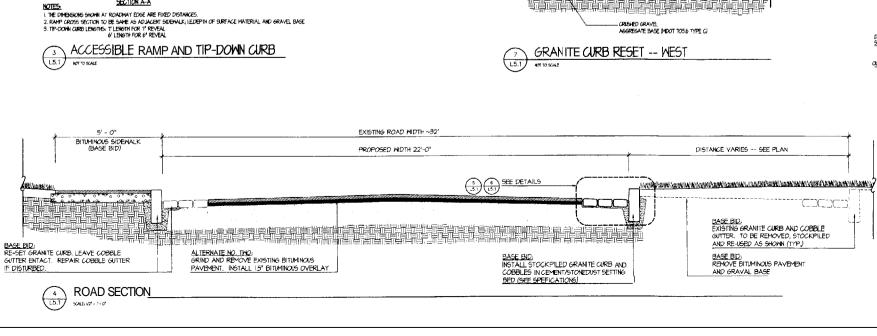

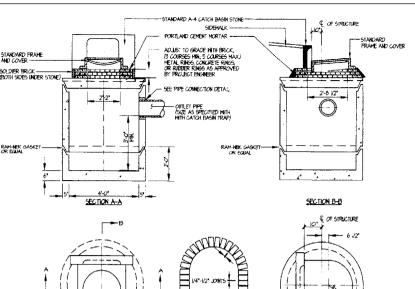

141-1/2* JOHTS |-PLAN VIEW BRICK/JOINT DETAIL PLAN VIEW

PRECAST CONCRETE CATCH BASIN - TYPE "E" (ALTERNATE #5)

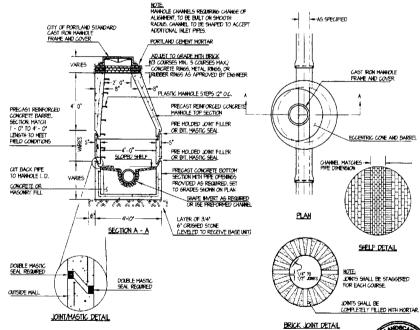

9 SANITARY SEWER MANHOLE



GENERAL NOTES FOR CATCHBASINS AND MANHOLES: I. ALL CONCRETE SHALL BE A CLASS "A" AND HAVE A MINIMUM ULTIMATE STRENGTH OF 4000 lbs. PER 90. INCH AT THE END OF 26 DAYS, UNLESS OTHERWISE NOTED.

2. PRE CAST REINFORCED CONE BARREL MANUFACTURE PER ASTIMSPEC C-418-61.

3. SEMER BRICK TO CONFORM TO ASTM SPEC, DESIGNATE ON C-32-63, GRADE MA AND SA.

4. ALL MANHOLES SHALL HAVE A BITUMINOUS WATERPROOFING APPLIED TO THE EXTERIOR SURFACE, IF CONSTRICTION OF BRICK MASONRY, THE SHOOTH MORTAR SURFACE SHALL BE PLASTERED WITH A SHOOTHMORTAR FINISH 3/6* 5. CASTINGS SHALL CONFORM TO ASTM DESIGNATION A48-CLASS 35. ALL PARTS OF CASTINGS, EXPECT FINISHED SURFACE, SHALL RECEIVE A COAT OF COAL TAR PITCH VARNISH OR ASPHALTIM PAINT WHICH SHALL BE SMOOTH AND TOUGH BUT NOT BRITTLE,

6. MANHOLES MAY BE CONSTRUCTED OF MASONRY, PRE CAST REINFORCED CONCRETE, OR CAST IN PLACE.

7. ALL PRE CAST MANHOLES AND CATCH BASINS SHALL BE IDENTIFIED BY \$\$NSTATIONS\$N, AND \$NNOFFSET\$NN, PAINTED ON THE SIDE OF THE STRUCTURE BY THE MANUFACTURER.

8. STORM AND SEMER MANHOLES SHALL HAVE SOLID COVERS WITH ONE DRILLED HOLE.

9. EXISTING MANHOLES AND CATCH BASING FRAMES AND COVERS SHALL BE SALVAGED BY THE CONTRACTOR, AND REMAIN THE PROPERTY OF THE CITY OF PORTLAND.

BID SET: 15 OCTOBER 2004

ph: 1.207.871.0003 fax: 1.207.871.1419

TURK TRACEY & LARRY ARCHITECTS, LLC 92 EXCHANGE STREET PORTLAND, MAINE 04101 TEL 207 1619662 FAX 207 761 9696


AND SURROUNDING GROUNDS Deering Oaks Rehabilitation CITY OF PORTLAND PORTLAND, MAINE H

DATE: 15 OCTOBER 2004 SCALE: AS SHOWN DRAWN BY: TS/MK

REVISIONS:

יא דרדר: SITEDETAILS

SHEET:

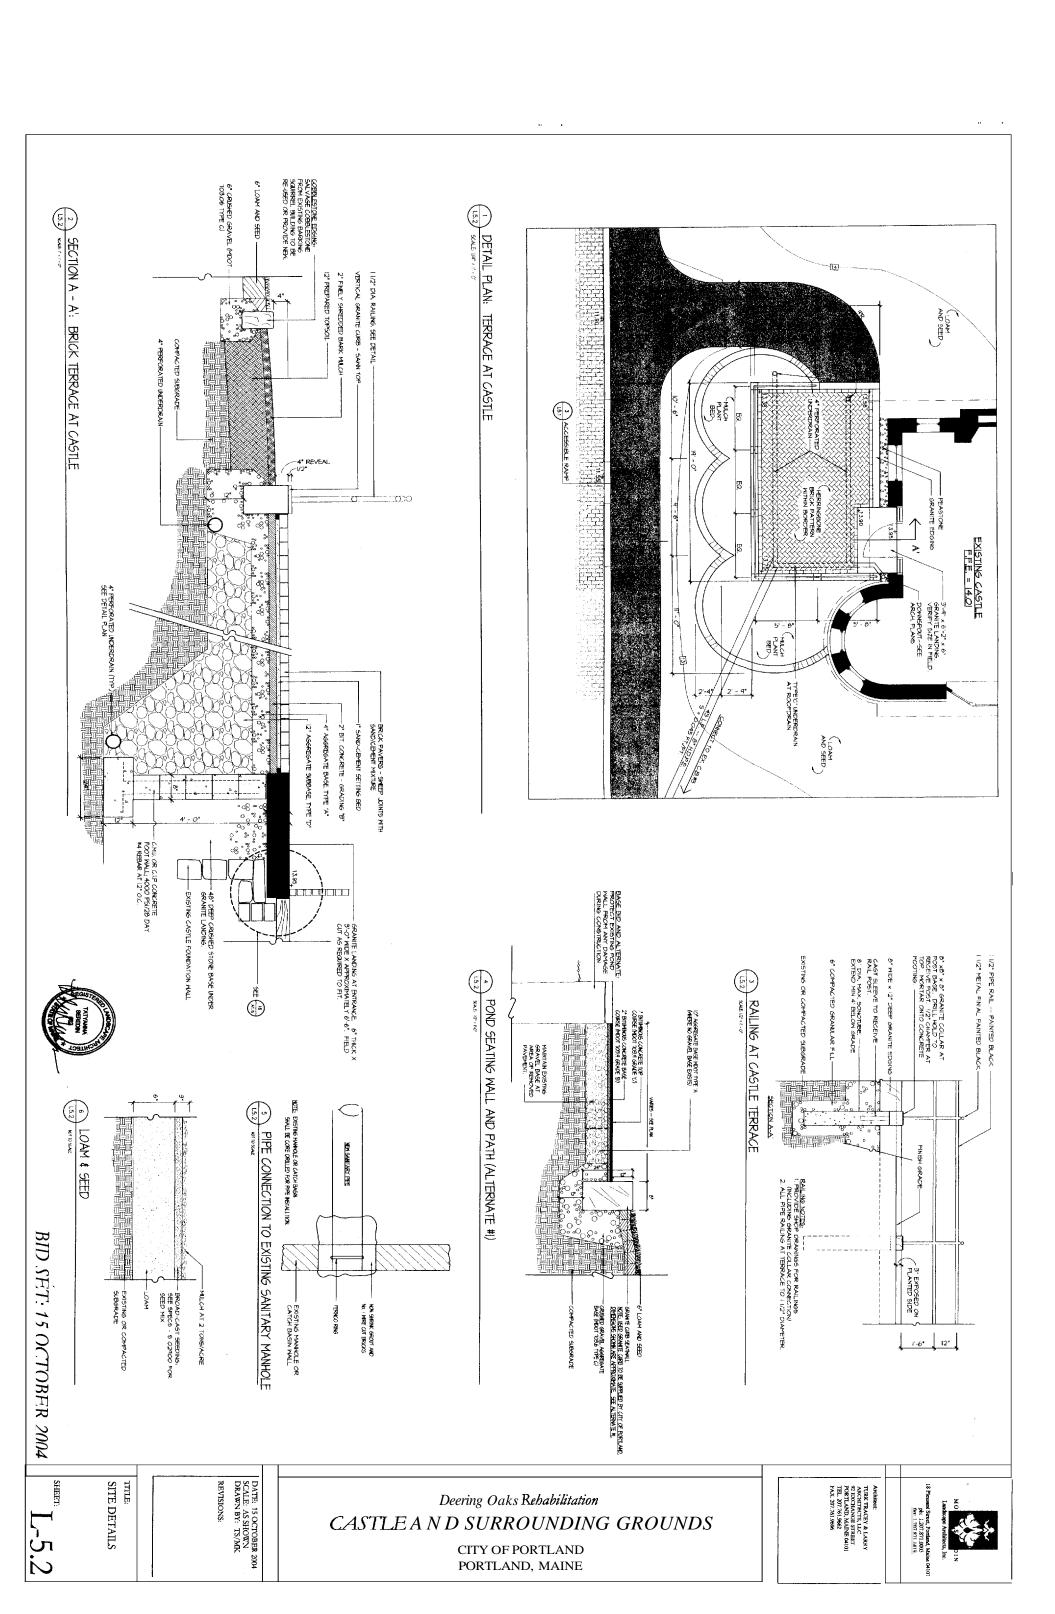

GENERAL NOTES:

1. IT IS THE INTENT OF THE DRAWINGS AND SPECIFICATIONS TO HAVE THE CONTRACTOR PROVIDE A COMPLETE BUILDING. THE DRAWINGS SHOW THE DESIGN AND LAYOUT, DESCRIBE THE CULLITY LEVEL, MO CONSTRUCTION TECHNICOUS IN A CENERAL SENSE ONLY. ALL DETAILS ARE TYPICAL. WHAT IS SHOWN IN ONE CONDITION IS APPLICABLE TO ALL OTHER SBBILLAR CONDITIONS.

3. THE GENERAL CONTRACTOR SHALL VERIFY ALL DIMENSIONS AND REPORT ANY DISCREPENCIES TO THE ARCHITECT PRIOR TO PROCEEDING WITH THE WORK

4. THE GENERAL CONTRACTOR SHALL VERIFY THE SIZE AND LOCATION OF ALL UTILITIES AND REPORT ANY DISCREPENCIES TO THE ARCHITECT PRIOR TO PROCEEDING WITH THE WORK.

5. THE GENERAL CONTRACTOR SHALL WORK FROM GIVEN DIMENSIONS AND LARGE SCALE DETAILS ONLY. DO NOT SCALE DRAWINGS.

6. ALL DIMENSIONS ARE TO FACE OF STUD U.N.O.

7. INSTALL SOLID 2X6 BLOCKING BEHIND ALL SURPACE-APPLIED FIXTURES, TRIM, HANDRAILS, AND MISCELLANEOUS ACCESSORIES WHERE MOUNTED ON STUD

8. ALL HANDRAILS SHALL SUPPORT A DEAD WEIGHT OF 250 POUNDS AT ANY POINT.

9. TANCE PARTICULAR CARE TO INBURIE THAT EXISTING MATERIALS, COMPONENTS, OR FARRIC OF THE BUILDING TO REMAIN IN PLACE, TO BE REFUSED, OR TO BE RESTORED AYE NOT DAMAGED OR DETERIORATED IN ANY WAY BY SELECTIVE DEMOLITION AND RESTORATION OPERATIONS. ALL WORKINGS SHALL ACCORD THE AGE AND HISTORIC SIGNAFICANCE OF THE BUILDING THE BAME RESPECT NORMALLY GIVEN TO A NEWLY COMPLETED STRUCTURE.

10. GENERAL CONTRACTOR SHALL BE RESPONSIBLE FOR COORDINATION OF STRUCTURAL, MECHANICAL/PLUMBING AND ELECTRICAL SYSTEMS COMPONENTS.


11. ALL WORK INCLUDED IN THIS CONTRACT SHALL CONFORM TO ALL NATIONAL, STATE AND LOCAL CODES, ORDINANCES AND AGENCY REQUIREMENTS.

12. ADD & DEDUCT ALTERNATES ARE DESCRIBED IN THE PROJECT MANUAL.

13.THE CONTRACTOR SHALL SECURELY ATTACH TO MASONRY STRUCTURE ALL BLOCKING BEHAND BURFACE APPLIED PICTURES, CABINETRY, TRIM, AND MISCELLANEOUS ACCESSORIES WHERE MOUNTED ON MASONRY WALL 14.THE CONTRACTOR SHALL VERIFY ALL DIMENSIONS AND EXISTIN CONDITIONS, BRANGIN ANY SUBSTANTIVE CHANGES TO THE ARCHITECTS ATTENTION.

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-OR

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DOOR NUMBER
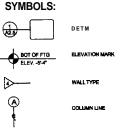
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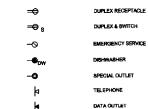
SMOKE DETECTOR

LIGHT FIXTURE

THERMOSTAT

DOUBLE DUPLEX RECEPTACLE

RECEPTACLE W/ GROUND FAULT INTERRUPTING



exil 🛣

FACP

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MASTER BOX

TIMED EWITCH FIRE EXTINGUISHER CABINE

OCCUPANCY SENSOR

PANEL BOARD JUNCTION BOX

MANUAL PULL STATION

HORN STROBE UNIT STROBE UNIT

TURK TRACEY & LARRY

PORTLAND, MAINE 0410: TEL. 207.761.9662 FAX. 207.761.9696

GROUNDS

AND SURROUNDING

CITY OF PORTLAND PORTLAND, MAINE

Deering Oaks Rehabilitaion

ABBREVIATIONS LIST:

AB	Anchor Boll	DR	Door
ADOL.	Additional	DTL	Detail
ADJ	Activatable	DWG	Drewing
AFF	Above Finish Floor	E	East
ALT	Allemate	EA	Each
APPROX	Approximate	EL	Elevation
ARCH	Architect(ural)	ELEC	Electrical
BD	Bound	EMER	Emergency
BF	Berrier-Free	EQ	Equal
BIT	Bituminous	EQUIP	Equipment
BDLG	Building	EXIST	Existino
BLKG	Blocking	EXT	Exterior
BOT	Bottom	FBO	Furnished by Ox
BRK	Seriok	FE	Fire Extinguishe
CC	Center to Center	FFE	Finished Floor E
ã	Centerline	FIN	Finish (ed)
ČLG.	Celling	FIN GR	Finish Grade
CLR	Clear	FLR	Floor (ing)
CONC	Congrete	FO	Face of
CONT	Continuous or Continue	FRMG	Frame (Ing.)
DEMO	Demolish	FT	Foot (Feet)
DIAM		FTG	Footing
DIM	Olemeter Discounter	L1 (2	LOOMS
DN	Dimension		

SECTION KEY

Detell	
Drawing	
East	
Each	
Elevation .	
Electrical	
Emergency	
Equal	
Equipment	
Exteting	
Exterior	
Furnished by O	
Fire Extinguishe	r
Finished Floor I	- Invelor
Finish (ed)	
Finish Grade	
Floor (ing)	
Face of	
Frame (Irg.)	
Foot (Feet)	
Fooling	





EXIT SIGN

FIRE ALARM CONTROL PANEL

EMERGENCY LIGHT FIXTURE



Specification Speaker Square Square Starinaes Stael Starinaes Staepand (ed) Staet Virnji Towel Bar Tankhosert Tompare & Croove Tempared Citese Trick (reces) Trick (rece SPEC SPICR SQ SS STD STL STOR CI SUPT SUPT SUPT THE TO THE TO THE TYPE UNO UV

Varnish
Vapor Berrier
Vinyl Composition
Vortical
Vortical
Walla Coverin
Water
Closes
Without
Water
Vertical
Vortical
Vertical
Ver

WINDOW # TYPE MAT FRAME SASH HEAD JAMB SILL REMARKS 101 E WD EXIST NEW 4/A1.6 9/A1.6 14/A1.6 B WD EXIST NEW 4/A1.6 9/A1.6 7/A1.8 102 B WD EXIST NEW 4/A1.8 9/A1.6 7/A1.8 E WD EXIST NEW 4/A1.8 9/A1.8 14/A1.6 103 105 C WD EXIST NEW 4/A1.8 9/A1.8 14/A1.8 108 C WD EXIST NEW 4/A1.8 9/A1.8 14/A1.8 107 C WD EXIST NEW 4/A1.8 9/A1.8 14/A1.8 108 D WD NEW NEW 4/A1.6 9/A1.6 14/A1.6 109 F WD NEW NEW 1/A1.6 1/A1.6 1/A1.6 110 F WD NEW NEW 1/A1.6 111 F WD NEW NEW 1/A1.8 1/A1.8 1/A1.8

112 B WD EXIST NEW 8/A1.8 WAL8 8/A1.8 113 B WD EXIST NEW 6/A1.8 6/A18 6/A1.8 114 E WD EXIST NEW 8/A1.8 8/A1.8 6/A1.8 WAD NEW NEW 8/A1.8 6/A1.8 6/A1.8 116 A WD NEW NEW 8/A1.8 6/A1.8 6/A1.8 117 A WD NEW NEW 6/A1.8 6/A1.8 6/A1.8


WINDOW SCHEDULE NTS


SCALE:25 August 2004

DRAWN BY: JAL

TITLE:

GENERAL NOTES & SYMBOLS

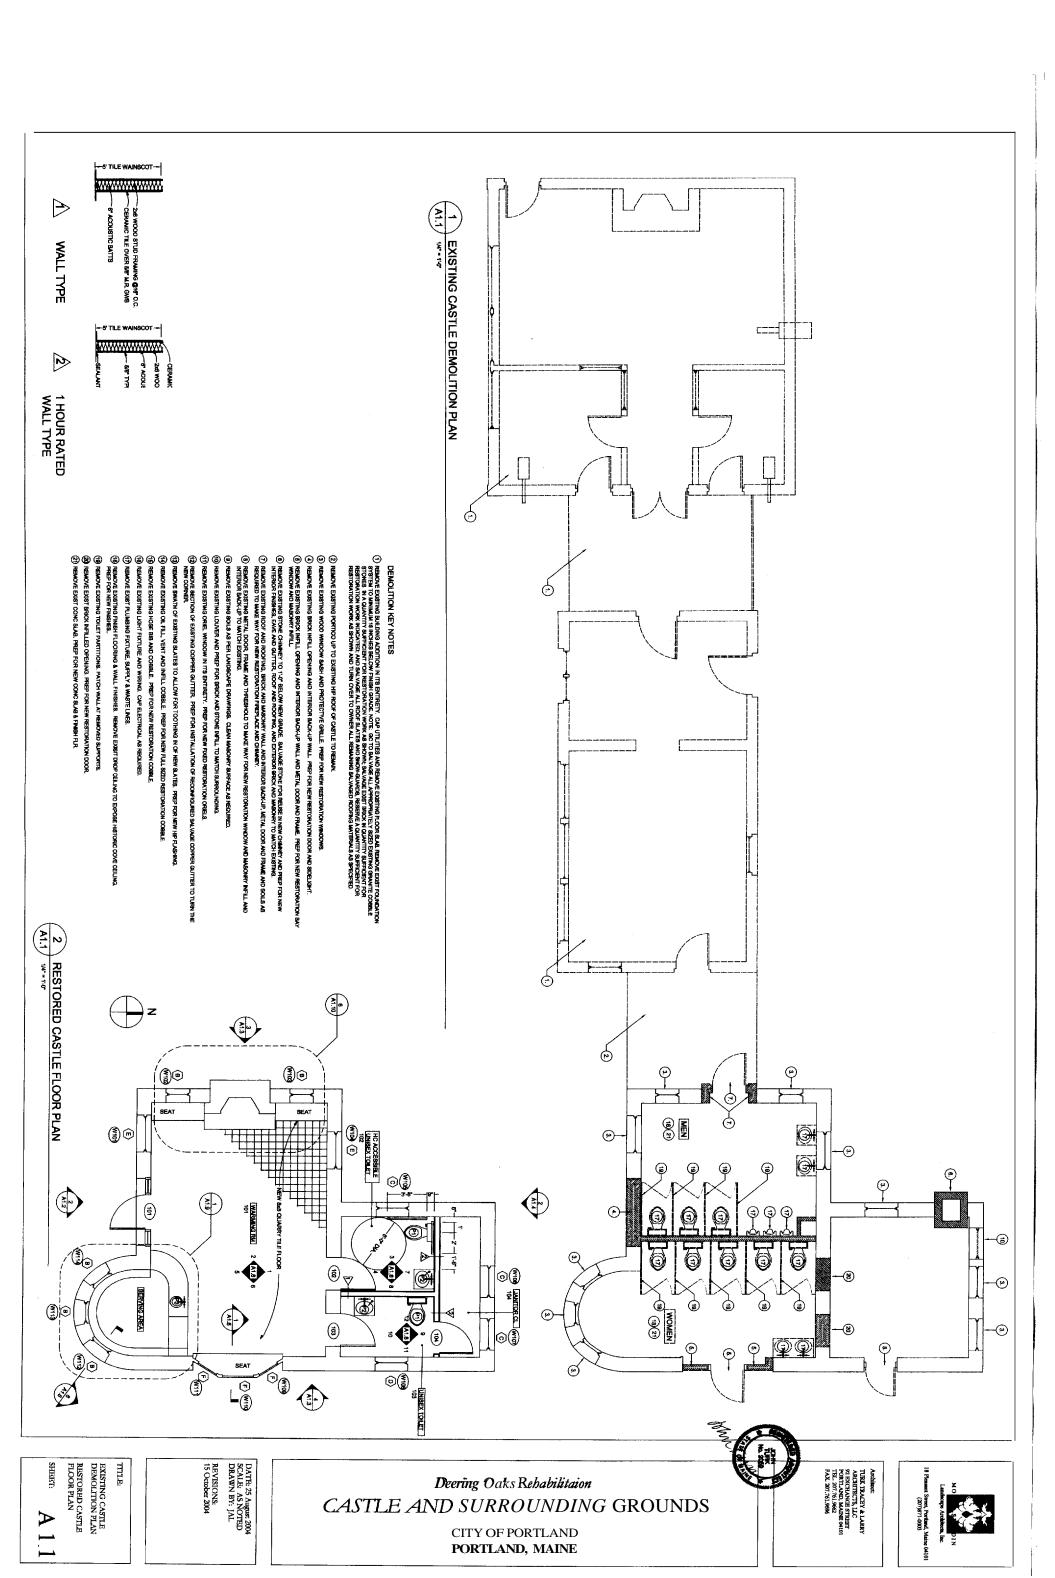

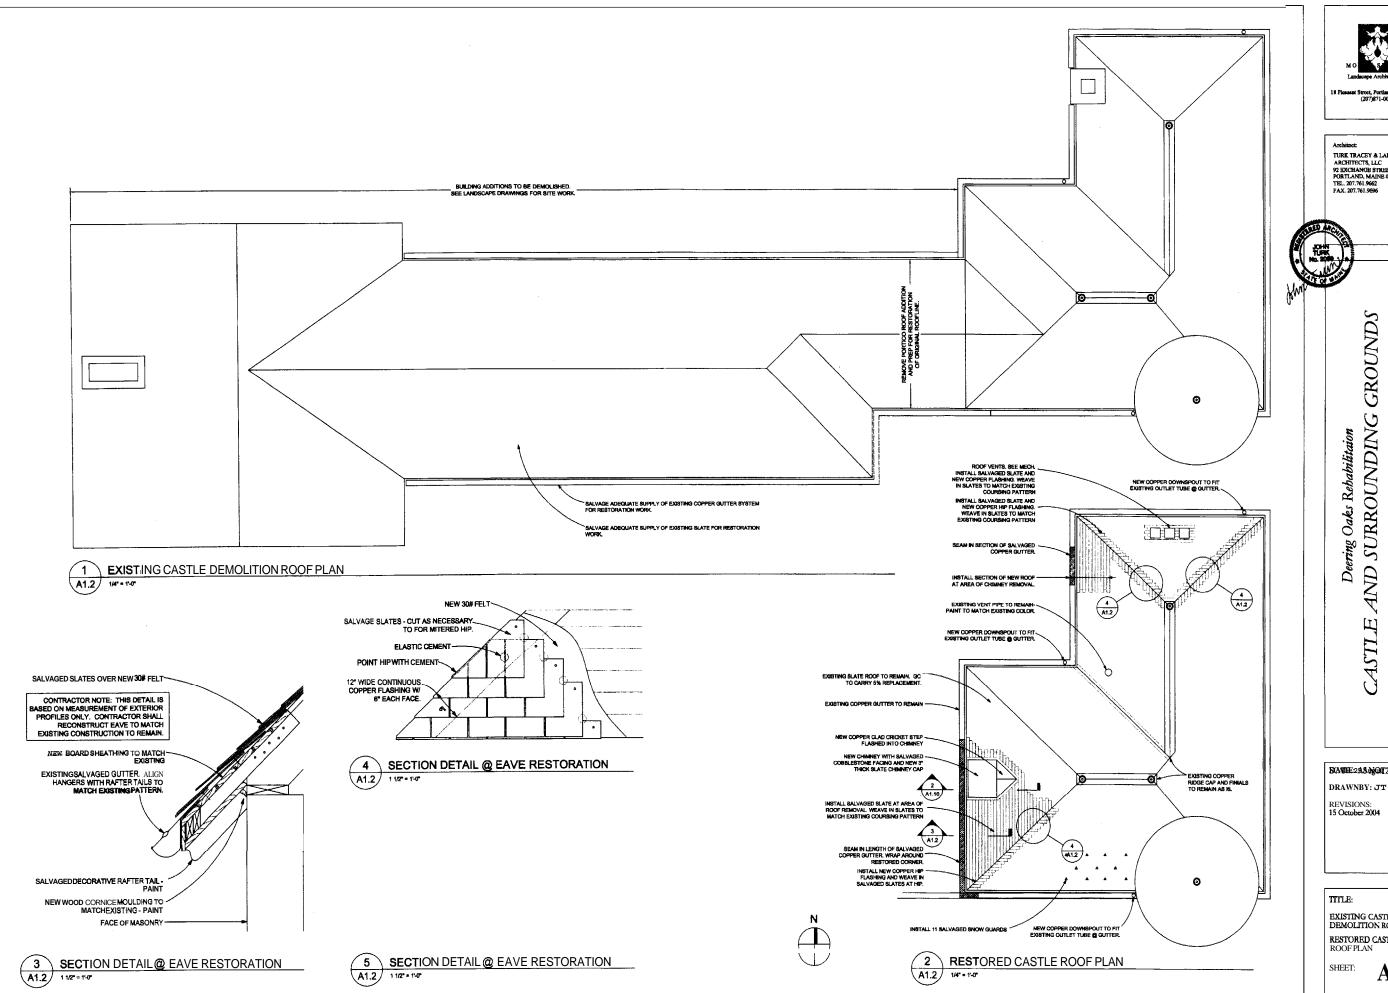



ATCHINGE:
TURE TRACEY & LARRY
ARCHITECTS, LLC
92 EXCHANGE STREET
PORTLAND, MAINE 04101
TEL. 207.761.9662
FAX. 207.761.9696


AND SURROUNDING GROUNDS CITY OF PORTLAND PORTLAND, MAINE

BCATHE 2 A.S. IN COT 2004

EXISTING CASTLE DEMOLITION ROOF PLAN RESTORED CASTLE ROOF PLAN

A 1.2

INSTALL NEW COPPER HIP FLASHING AND WEAVE IN SALVAGE SLATES AT HIP. NEW COPPER OUTTER. WRAP AROUND, NEW CORNER. EXISTING SLATE ROOF TO REMAIN, GC.
TO CARRY 5% REPLACEMENT. NEW WOOD RESTORATION WARDOW.
SEE WINDOW SCHEDULE. SCRAPE,
SAND AND PAINT EXISTING CASING TO
REMAIN. EXISTING BRICK FIELD TO RECEIVE 100, % REPONTING AND TO BE CLEAVED. ALTERNATE #6 EXISTING COBBLESTONE FIELD TO BE CLEANED, ALTERNATE #8 INSTALL 12 SALVAGED SNOW GUARDS STING COBBLESTONE FIELD TO BE CLEANED, ALTERNATE #8 LANDSCAPE DRAWINGS.
FIN FLR
EL 14.00 GEN. NOTE: SEE WINDOW SCHEDULE FOR SPECIFIC WINDOW ROUGH OPENING DIMENSIONS. ALL WINDOWS ARE TO BE CUSTOM BUILT TO FIT INTO EXISTING CONDITIONS, CONTRACTOR TO FIELD VERIFY ALL DIMENSIONS PRIOR TO FABRICATING WINDOWS. RESTORED SOLITH ELEVATION NEW WOOD INFILL DOOR AND SIDELIGHTS
NEW LIGHT FIXTURE- SEE ELECTRICAL
FUTURE SIGN (BY OWNER) **②** ◉ ◉ • 0 EXISTING COBBLESTONE FIELD TO BE CLEANED. ALTERNATE #6 EXISTING COBBLESTONE FIELD TO BE CLEANED. ALTERNATE #8 EXISTING BRICK FIELD TO RECEIVE 100 % REPOINTING AND TO BE CLEANED. ALTERNATE ME.

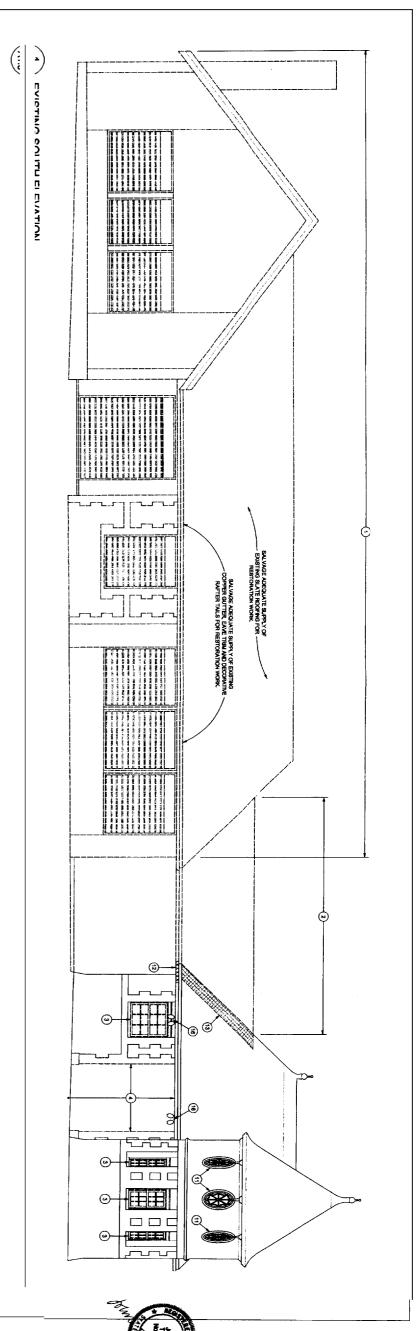

TITLE:

EXISTING CASTLE SOUTH
DEMOLITION BLEVATION
RESTORED CASTLE
SOUTH BLEVATION

SHEET:

A

3




Deering Oaks Rehabilitaion

CASTLE AND SURROUNDING GROUNDS

CITY **OF** PORTLAND PORTLAND, **MAINE**





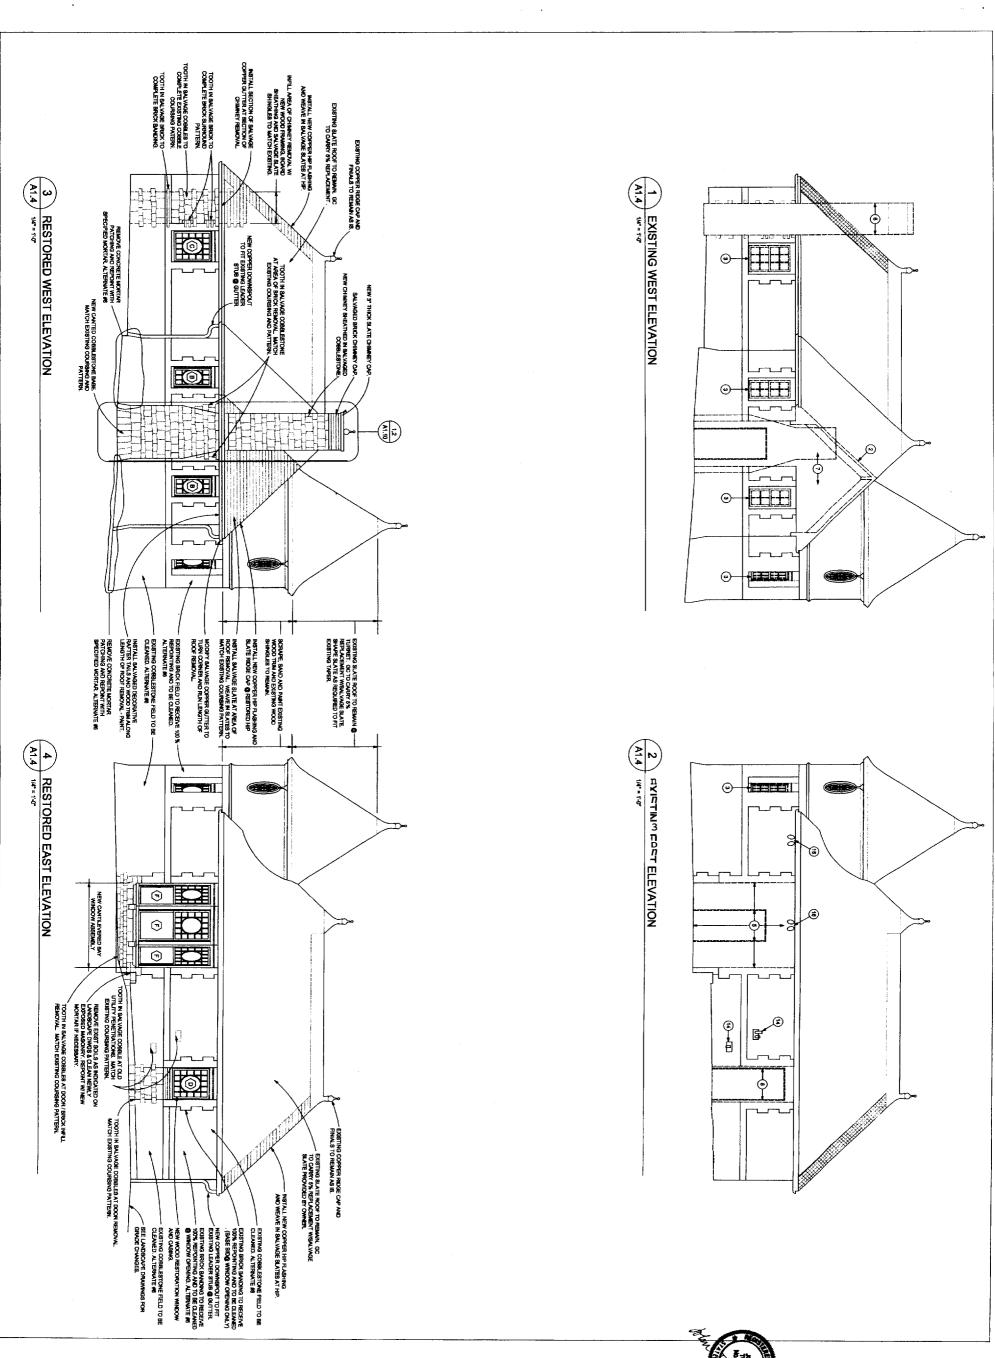

A WEST DEMOLITION
ELEVATIONS
RESTORED CASTLE EAST
& WEST ELEVATIONS
SHEET:

A 1.4

DATE: 25 August 2004 SCALE: AS NOTED DRAWN BY: JT REVISIONS: 15 October 2004


Deering Oaks Rehabilitaion


CASTLE AND SURROUNDING GROUNDS


CITY OF PORTLAND PORTLAND, MAINE





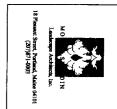

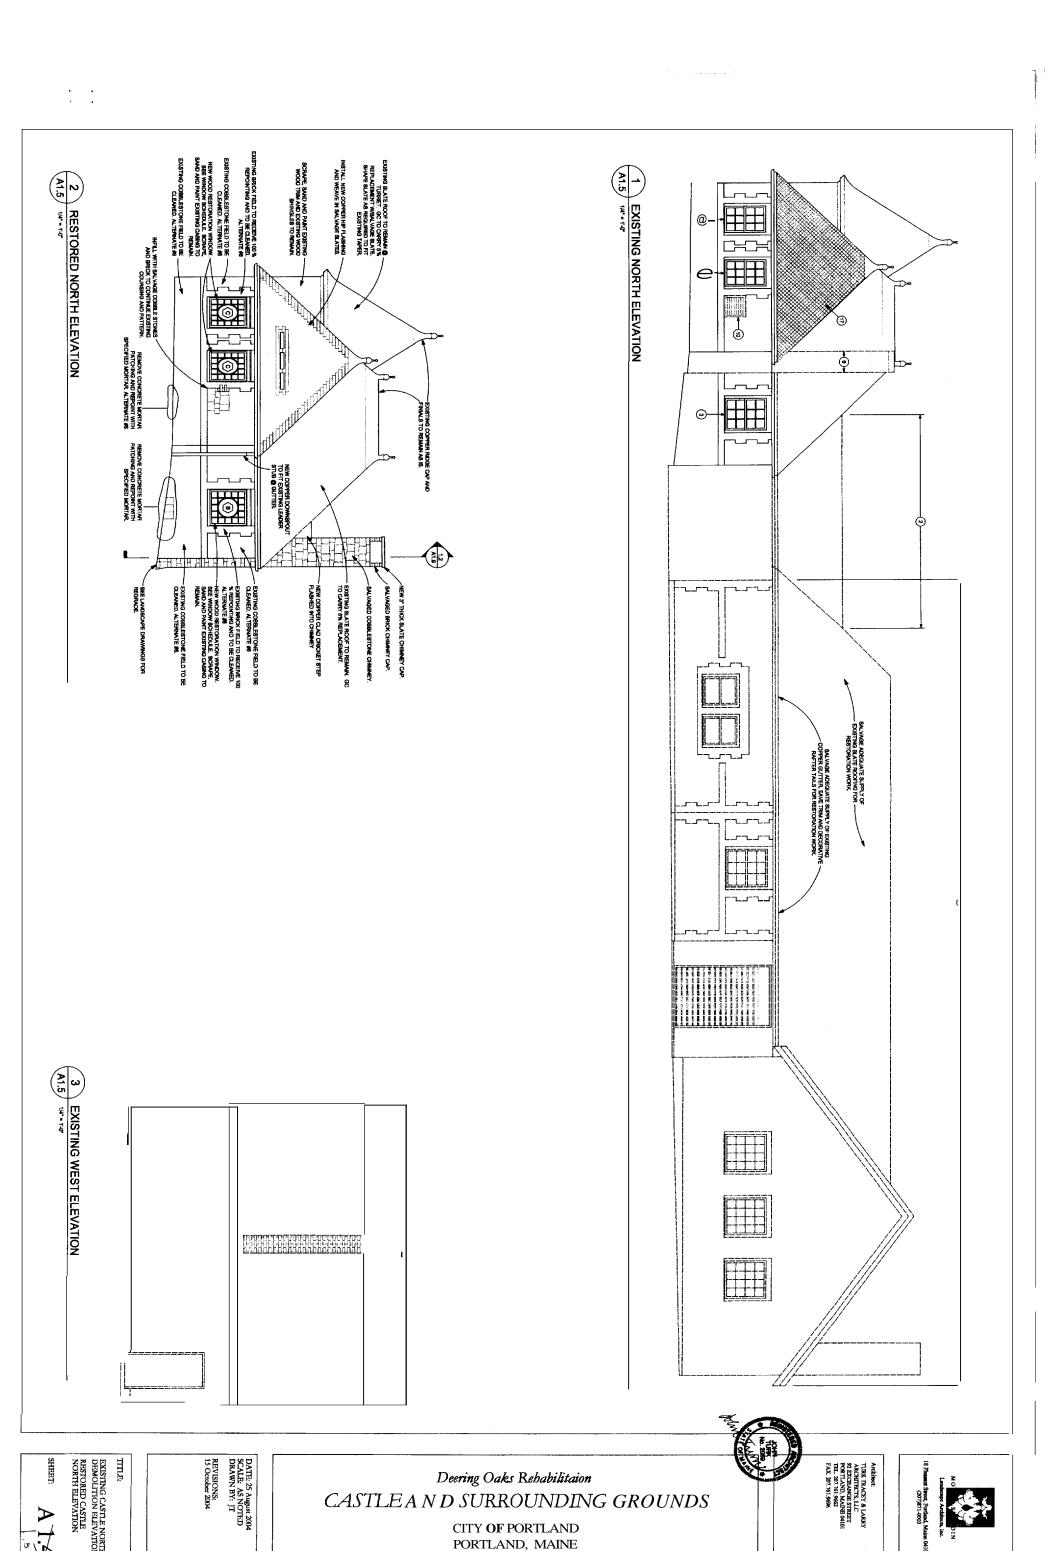

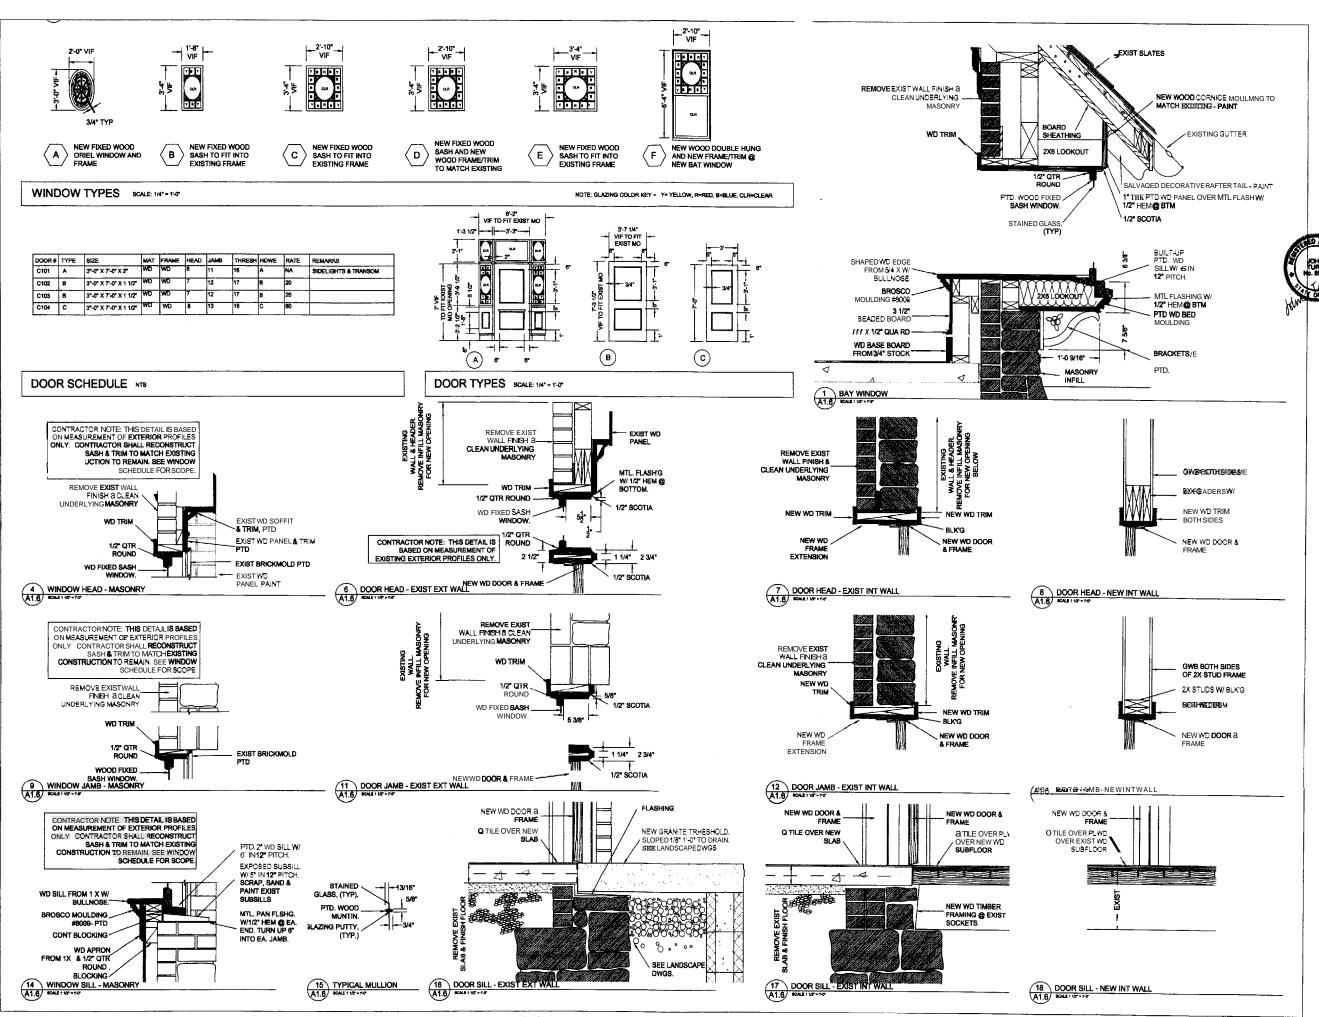



Architect TURK TRACEY & LARRY ARCHITECTS, LLC
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AND SURROUNDING GROUNDS Deering Oaks Rehabilitaion CASTLE

CITY OF PORTLAND PORTLAND, MAINE


DATE: 25 August 2004

REVISIONS: 7 September 2004 15 October 2004


TITLE: DOOR & FINISH SCHEDULES DOOR & WINDOW TYPES & DETAILS

SHEET:

A 1.6

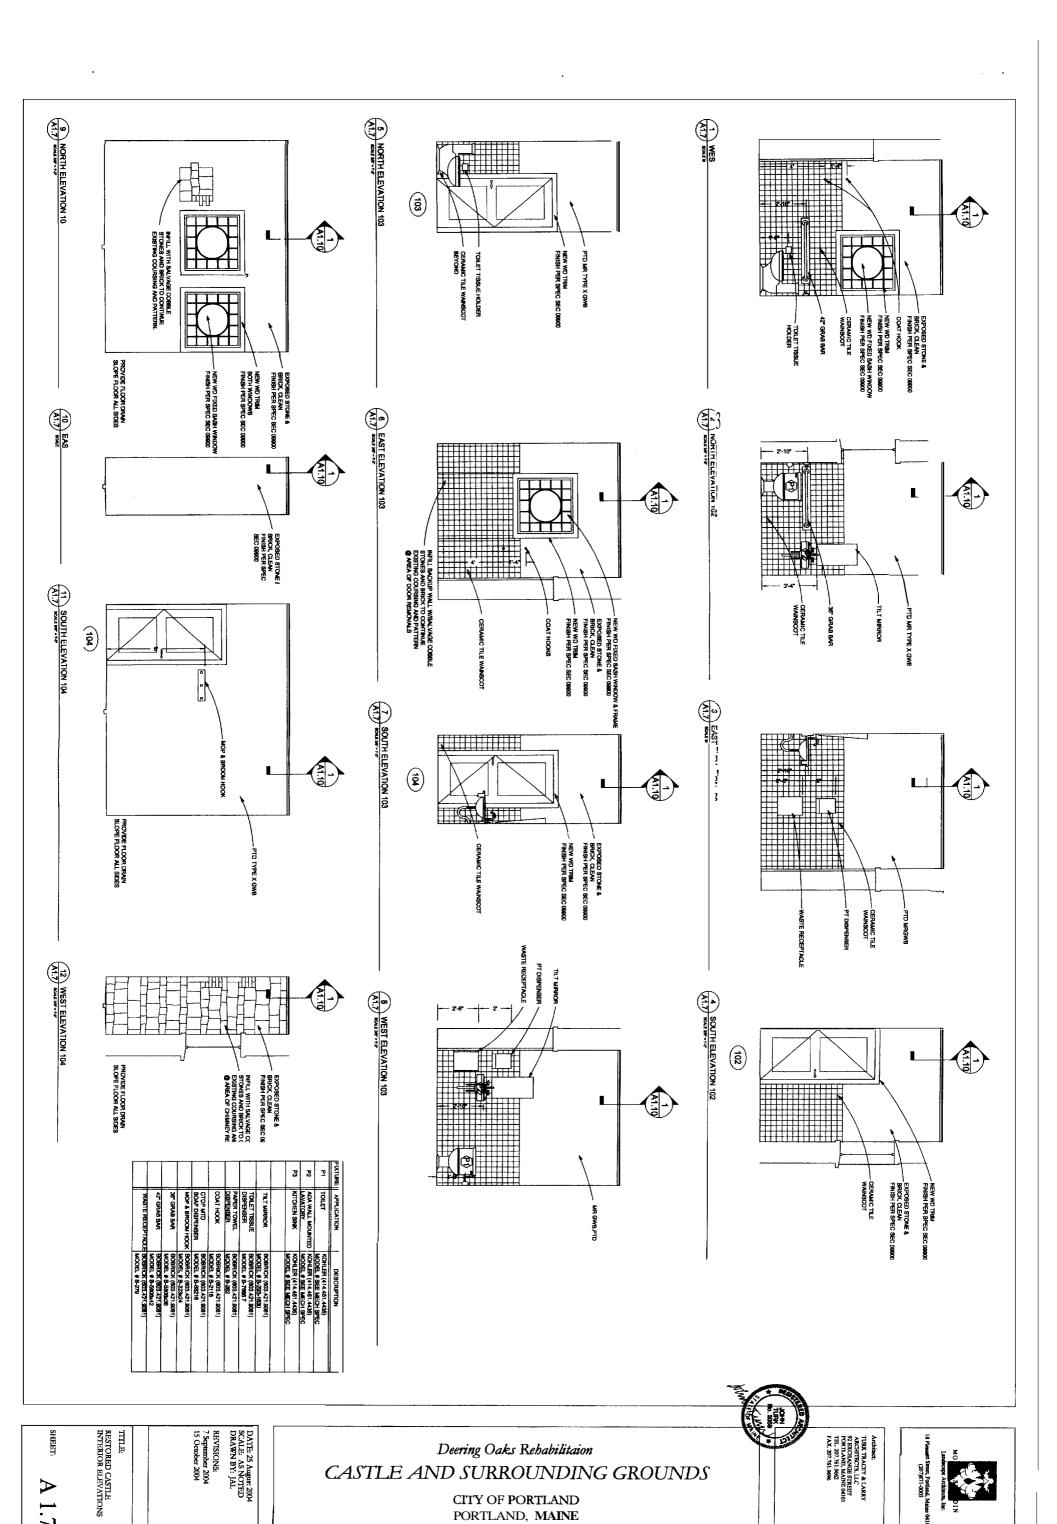

PORTLAND, MAINE

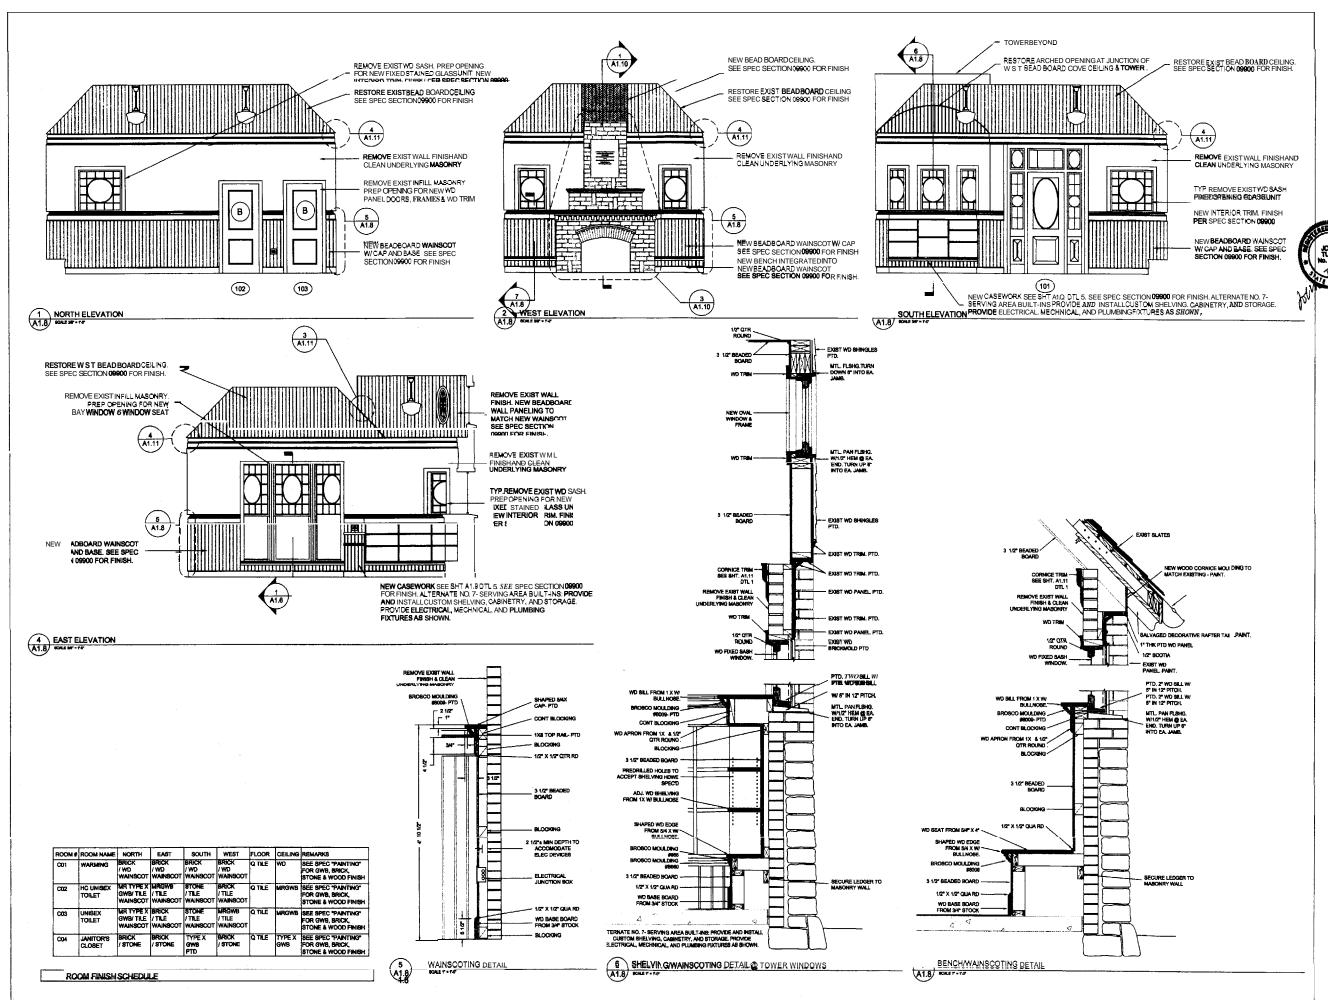

Architect

TURK TRACEY & LARRY ARCHITECTS, LLC 92 EXCHANGE STREET PORTLAND, MAINE 04101 TEL. 207.761.9662 FAX. 207.761.9696

GROUNDS


SURROUNDING Deering Oaks Rehabilitaion CITY OF PORTLAND PORTLAND, MAINE CASTLE


DATE: 25 August 2004 SOALE: AS NOTED DRAWN BY: JAL

15 October 2004

TITLE: RESTORED CASTLE INDERMINELEVATIONS

SHEET **A** 1.8

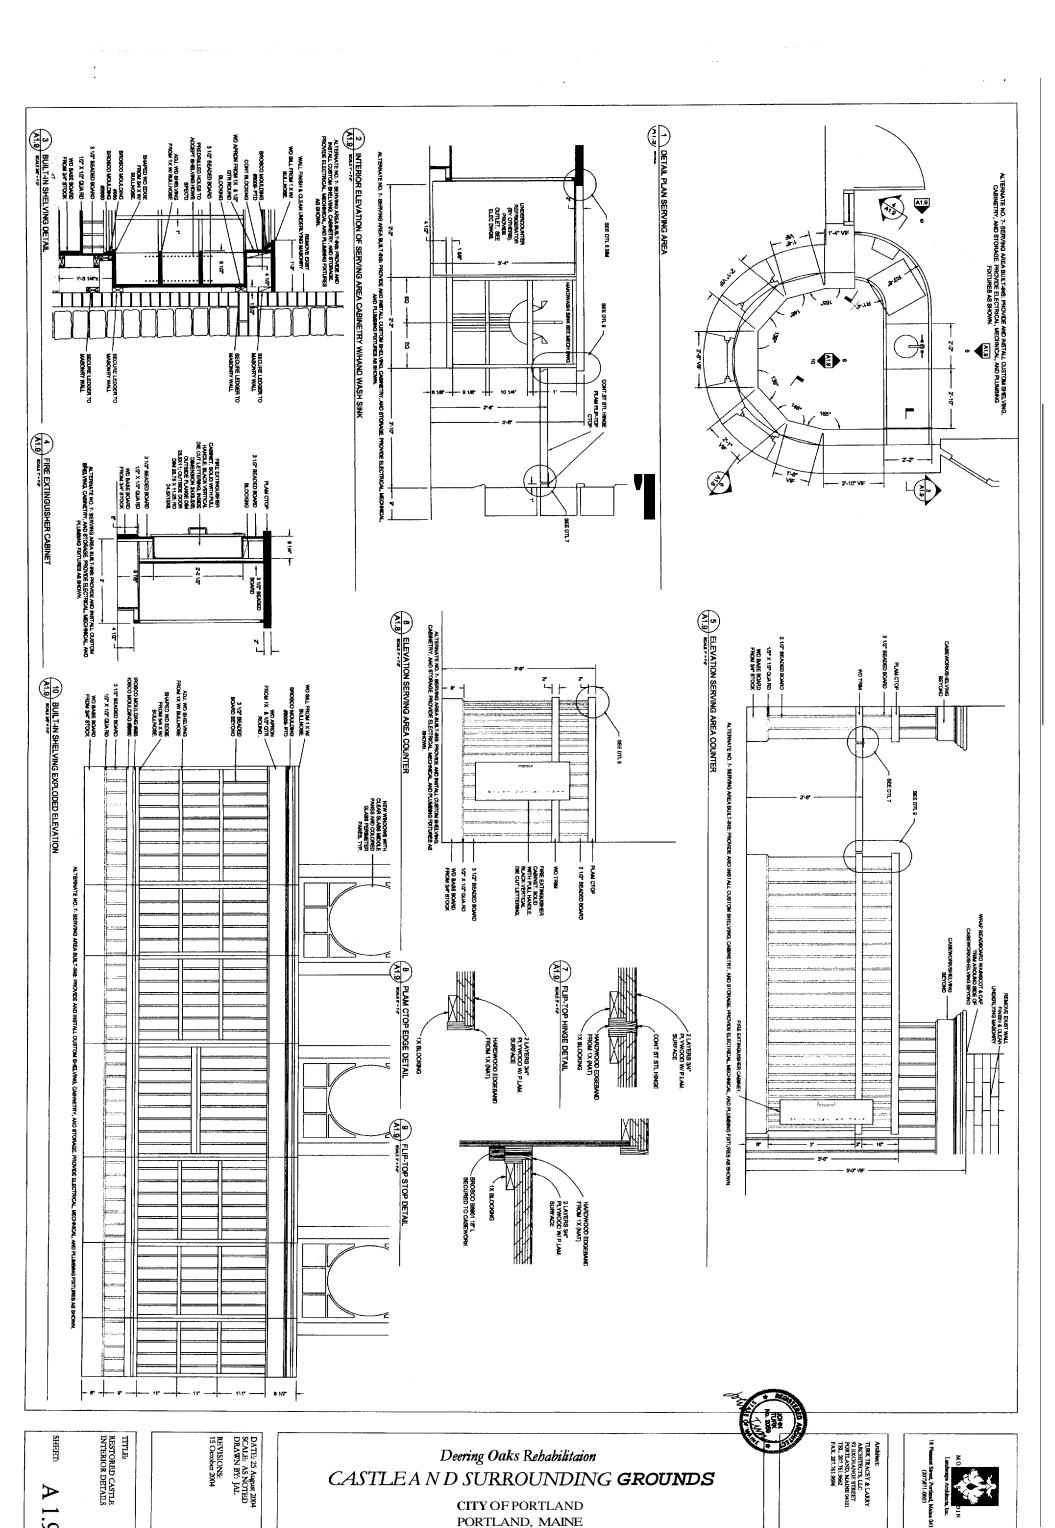

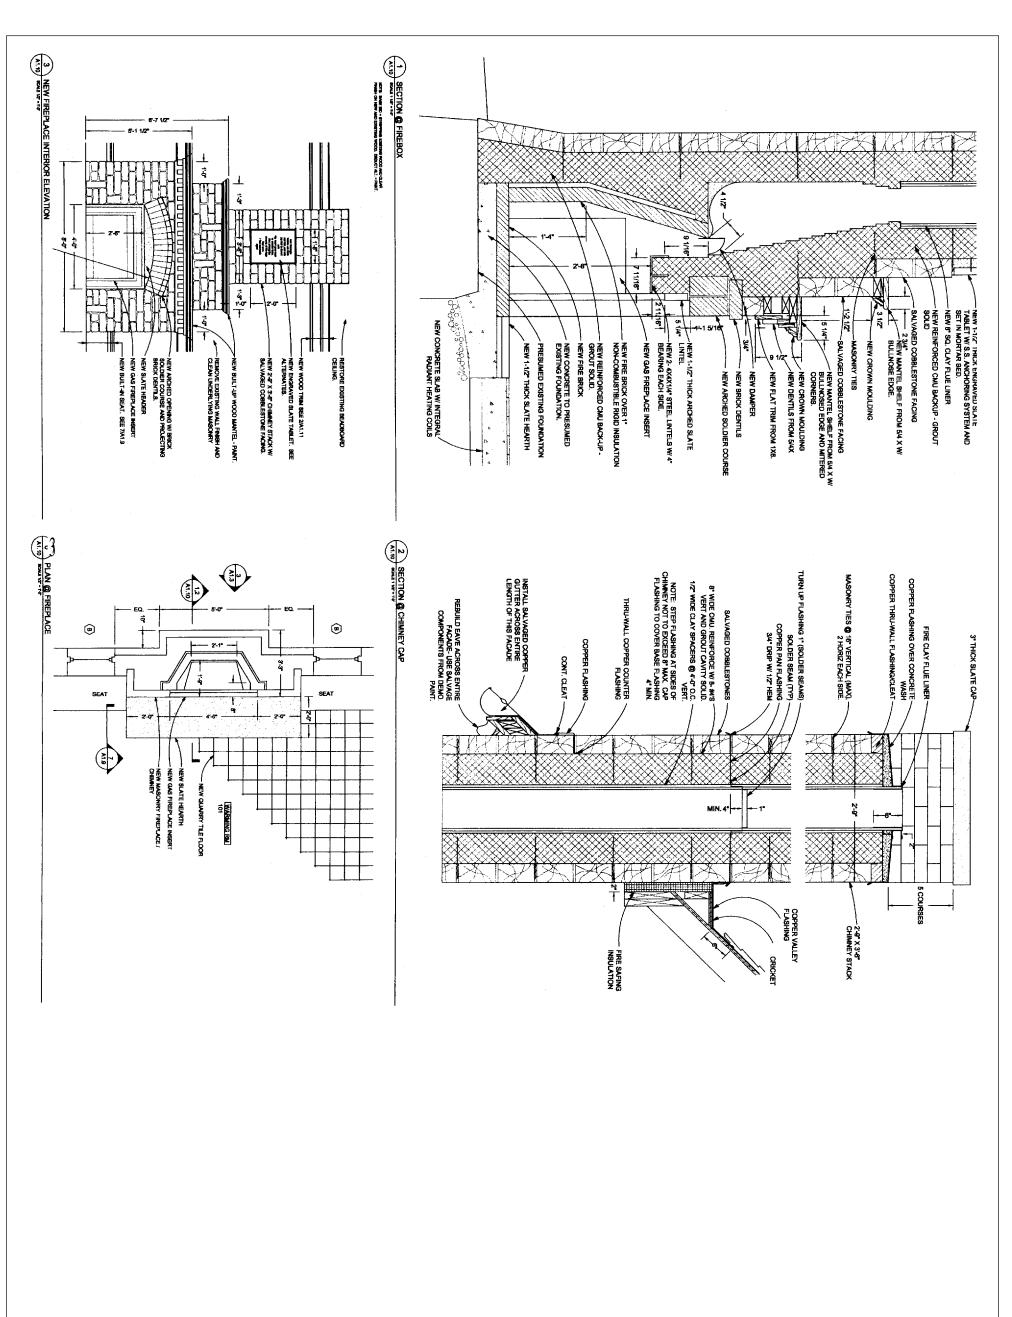

TITLE:
RESTORED CASTLE
PERPLACE & CHMNEY
DETAILS
SHEET: A 1.10

DATE: 25 August 2004
SCALE: AS NOTED
DRAWN BY: JT
REVISIONS:
15 October 2004

Deering Oaks Rehabilitaion


CASTLE AND SURROUNDING GROUNDS

CITY OF PORTLAND PORTLAND, **MAINE**








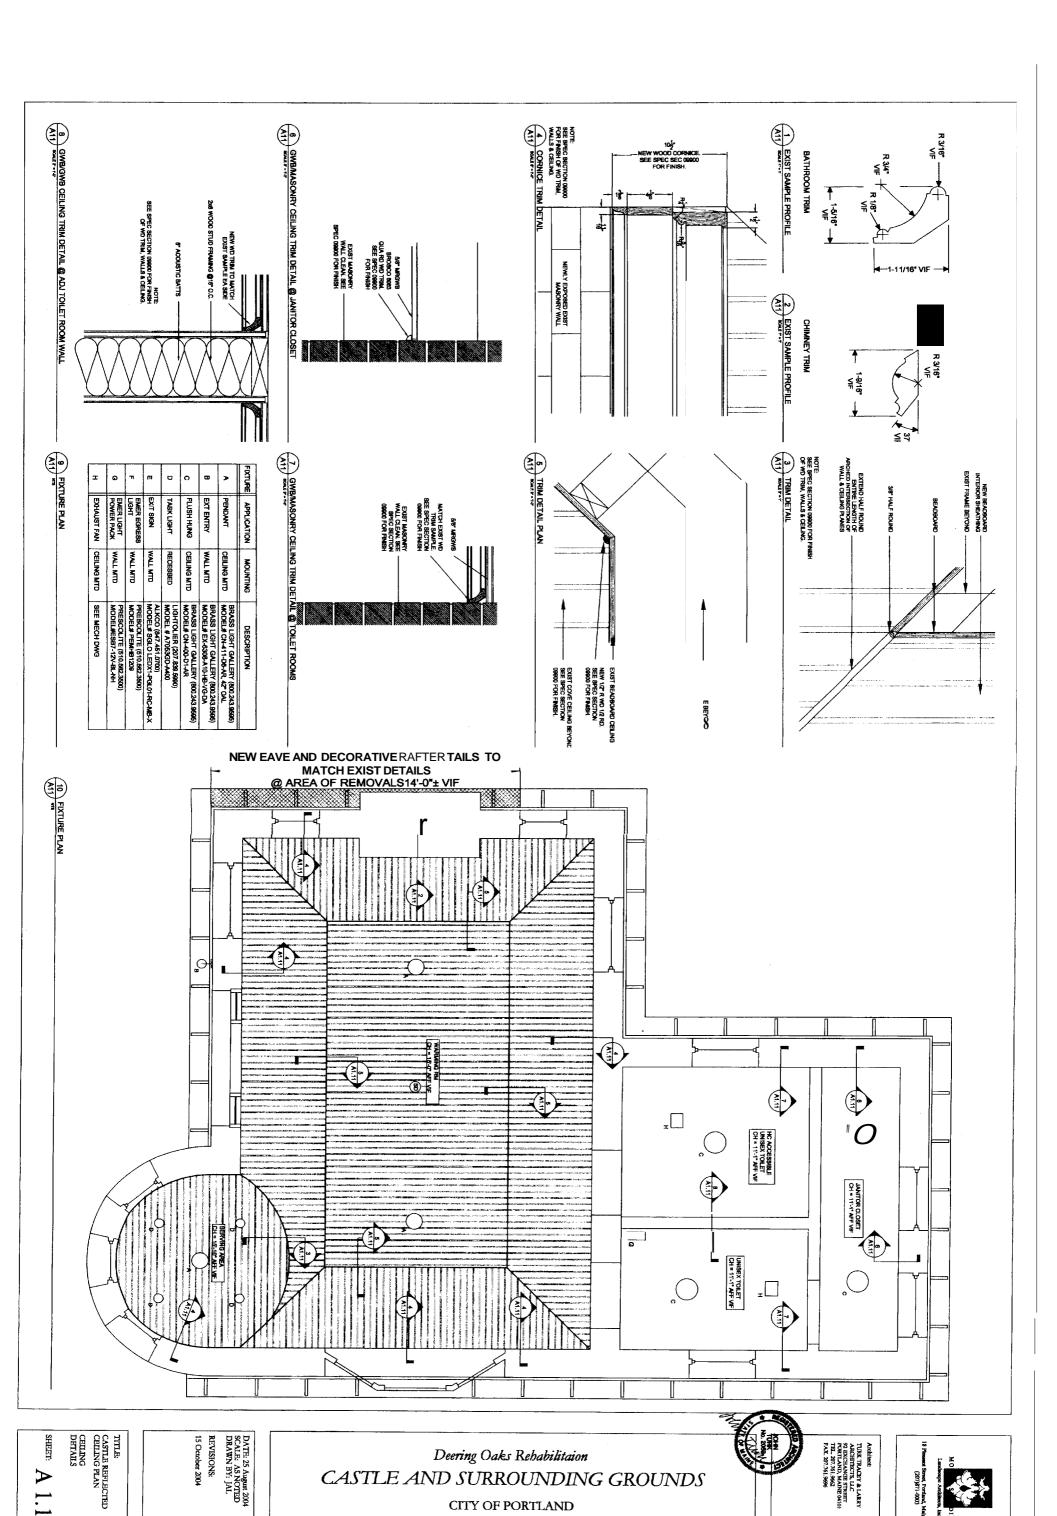

PORTLAND, MAINE

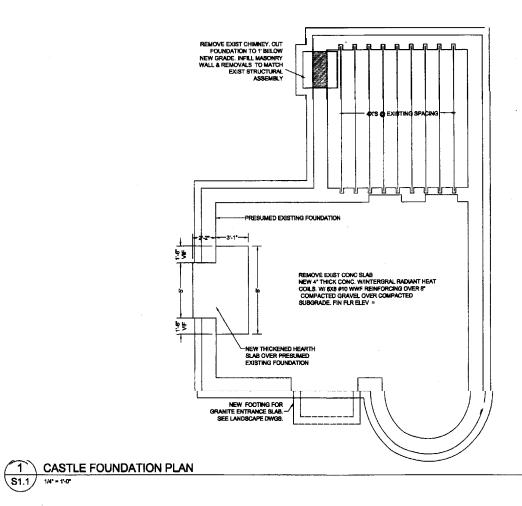


JANITOR CL REMOVE EXIST CHIMNEY INFILL MASONRY WALL & REMOVALS TO MATCH EXIST STRUCTURAL ASSEMBLY NEW 3- 2X8 WD LINTELS W/ 4" -BEARING EACH SIDE. PRESUMED EXIST LINTEL UNISEX TOILET FRAME FOR NEW WD FRAME WINDOW PRESUMED EXIST LINTEL \ PRESUMED EXIST LINTEL 3-1" VIF EXIST MO 3'-1" VIF EXIST MO REMOVE INFILL BRICKEMOVE INFILL BRICK ь<u>т</u> WARMING RM 101 FIN FLR EL. 14.00 PRESUMED EXIST LINTEL

@ NEW BAY WINDOW

SEE ARCH DWG FOR BAY

FRAMING. REMOVE EXIST

BRICK INFILL -- NEW 2- 4X4X1/4" STEEL LINTELS W/ 4" BEARING EACH SIDE. \$ 15 m PRESUMED PRESUMED EXIST LINTELS PRESUMED SERVING AREA 6'-4" VIF EXIST MO REMOVE INFILL BRICK PRESUMED EXIST LINTEL RESTORED CASTLE FRAMING PLAN

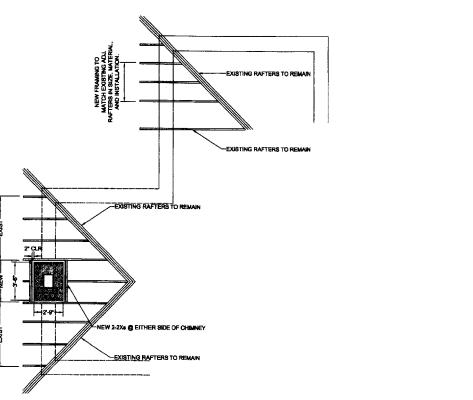

Architect: TURK TRACEY & LARRY ARCHITECTS, LLC 92 EXCHANGE STREET PORTLAND, MAINE 04101 TEL. 207.761.9662 FAX. 207.761.9696

CASTLE AND SURROUNDING GROUNDS Deering Oaks Rehabilitaion CITY OF PORTLAND PORTLAND, MAINE

DATE: 25 August 2002 SCALE: AS SHOWN DRAWN BY: JL


REVISIONS: 15 October 2002

TITLE CASTLE FOUNDATION PLAN CASTLE FRAMING PLAN &

s1.1

3 NEW FRAMING NEW CHIMNEY & REMOVED CHIMNEY

2 S1.1

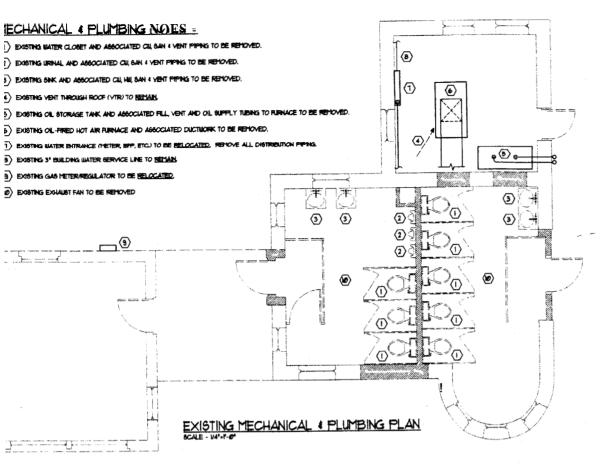

RADIANT HIXING BLOCK SEE SPECIFICATIONS FOR

BOLER VENT AND

44 DUCT UP TO ROOF CAP


610

KSH-I


ATO CIN-I

FIREPLACE THERMOSTAT

MECHANICAL PLAN

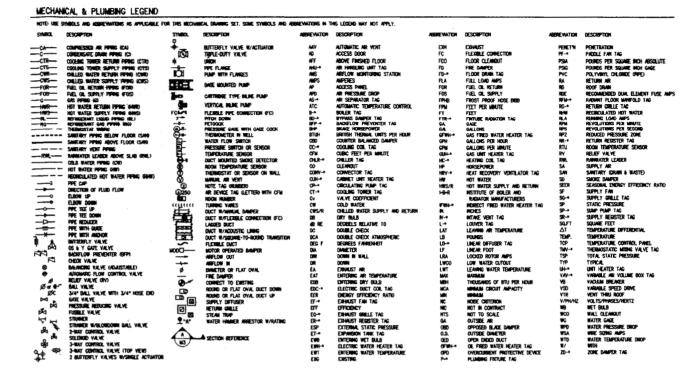



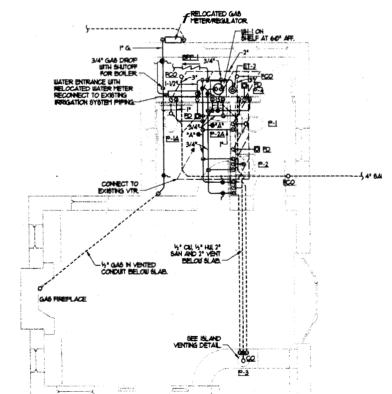

PLUMBING PLAN





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Deering Oaks Rehabilitaion
AND SURROUNDING GROUNDS
CITY OF PORTLAND
PORTLAND, MAINE

DATE 25 AUGUST 2004 SCALE: AS NOTED DRAWN BY: SMR

REVISIONS

TITLE:
MECHANICAL AND
PLUMBING PLANS

SHEET:

Ml.1

R MARIS	
A)	HISS/R WAYS.————————————————————————————————————
	CHERET COL. COL.
ABNET:-	CHE OF THE OF
	UNIT SHALL HAVE DUCTED SUPPLY AND RETURN.
*-cot.	

	PLUMBING FIXTURE CONNECTION SCHEDULE									
	TAG	DESCRIPTION	SAN	VENT	CW	HW				
HRIS/R WARS.	P-1 FLR	MINTO FV WC	3"	2"	7"	-				
o	P-1A ADA	FLR MINTD FV WC	3"	2"	ť	-				
 	P-2 WAL	L HUNG LAV	1-1/2"	1-1/2"	1/2"	1/2"				
	P-2A ADA	WALL HUNG LAV	1-1/2"	1-1/2"	1/2"	1/2"				
ø f T	P-3 HAN	DISINK	1-1/2"	1-1/2"	1/2"	1/2"				
[₩] ⊗ I	P-4 SER	VICE FAUCET	-	-	3/4"	3/4"				
*	FD FLO	OR DRAIN	3*	2"	-	-				
CELING.		ZE OF BELOW SLAB SANITA AND P-4 FAUCETS SHALL BE DRAINS SHALL HAVE TRAP				EM.				

10		ON DIONE										OUTPUT		W.P.D (FT.WG)	ARSTLOW	71.00ve	MTG.HT.	ELECTRICAL REQUIREMENTS				
								SHALL BE 2".			TAG	(MEH)	(GPA)	(FT.WG)	(CFM)	IFECOM	(FEET)	HP	WATTS	V/PH/	ΉZ	
P-2	. P-2A	AND P-	4 FAUC	ETS.	SHALL	BE PART	OF THE TR	VAP PRIMER SYS	TEM.		UH-1	11,1	1.5	0.01	395	20	- 8	I - I	8	165/1/	60	
ALL.	FLOO	C UN(ABR	D SHALL	L HAY	E IKA	- HACIMETICS	>															
F									_													
- (ELE	CTRIC	WATI	er i	ÆATE	r Perf	ORMANC	e schedule	- 1		EXF	Pansio	n ta	¥K Pl	erfori	MAN	CE SC	HEDU	LE			
ı		STORAGE	REC'VRY.	ELECT	ROCAL RE	CUREMENTS	BASES OF	DESIGN A.O. SMITH	_			TANK	ACCEPT/	MCE I	MI, REO'D. ZEPT, VOL	MAX.	WORK'G.	MAX. WO	K'G.T.	WENCHT	г	
- 1	TAG	(GALS)	€ 100°F	HP	WATTS	V/PH/HZ	SERVICE	MODEL	_		TAG	VOLUME (GAL)	VOLUM	E *	CEPT.VOL.	TEMP	WORK'S Erature Eg f)	PRESS	RE '	(LBS)	Г	
ı	WH-1	10.0	1		1500	120/1/80	DOM HW	ELSF-10			ET-1	4.4	2.5		•	-	240	100	7	14	Γ	
			•	_	•						F7.0	1 20		_		_	~~				_	

ET-2 2.0

PUMP PERFORMANCE SCHEDULE

AIR DEVICE PERFORMANCE SCHEDULE

CABINET UNIT HEATER PERFORMANCE SCHEDULE

KICKSPACE HEATER PERFORMANCE SCHEDULE

UNIT HEATER PERFORMANCE SCHEDULE

BFP PERFORMANCE SCHEDULE

BFP-2 1" 42.0 15.0 180

180

TAG SZERBO SZERBO GCFIO BR.WG.) THROWGL THROWGS N. No. DUCT CONN.GRO PATTERN MODEL

(A) T2x12 8x8 80 0.0.02 2-4 - - 8x8 4-817 500650

(B) 42x4 42x4 550 0.10 17-25 - 25 42x4 5° 2755490

(C) 48x4 48x4 670 0.10 - - 30 48x4 5° 2755490

PROVIDE ALL REGISTERS, GRELES AND DEFUSERS WITH OPOSED BLADE DAMPERS.

HEATING PERFORMANCE BASED ON 180°F ENTERING WATER & 60°F ENTERING AIR TEMPERATURE

HEATING PERFORMANCE BASED ON 180°F ENTERING WATER & 60°F ENTERING AIR TEMPERATURE

BASIS OF DESIGN: WILKINS

975XL

975XL

BODY STYLE: SERVICE

RPZ DOMESTIC WATER

RPZ BOILER FILL

BEP-2 PRE YENT TO 27 ABOVE FD,
MOUNT ON WALL AT 3"-0"MBONE FLOOR
2" SUB-HETTER —
20 Maria
TOWN THE WAY TO A STATE OF THE
POSTURE HANGE TO EMPLINE
FLOOR— BYP-3 PIPE VENT TO 2" MONE FO.

DFT-7		72.0	2.0	<u></u>	"		RFZ.		MESTIC WATER	9/3AL	
BFP-3	2-1/2"	225.0 1	5.0 180		175	Y	RPZ	IRR	IGATION SYSTEM	375	
										·	
GAS	BOIL	ER PE	RFORMAN	NCE SCI	HEDUL	.E			× - BASED ON D.C	D.E. (DEPT. OF ENER	GY) TEST PROCEDURE
	·			,	,						
TAG	A.G.A	HEATING		FUEL	A.F.U.E.	BOILER SECTIONS	FLUE	ELECT	RICAL REQUIREMEN	ITS BASIS OF	DESIGN: WEIL-MCLAIN
i Ala	(MBH)	(MBH)=	(MBH)	FUEL	(X)	SECTIONS	DIA (IN)	AMP	WATTS V/PH/H	IZ SERVICE	MODEL
	/maxis	(100)	169017								

AU WOOR'S MAC WORKS WEIGHT LESS OF DESIGN AUTRO (LBS) MOUNTED SERVICE (LBS) MOUNTED SERV

TESTABLE (Y) OR (N)

Y

Y

175

175

- 1		(MBH)	(MBH)=	(MBH)			(Z)	SECTIONS	DIA.(IN)	AMP	WATTS	V/PH/HZ	SERVICE	MODEL
- [B-1	45.0	38.0	33.0	NAT (GAS	85.3	-	-	5.0	-	120/1/60	HWS/R	AHE-45
														
1										-				
1	FAN	1 PERF	ORMAN	NCE SC	CHEDU	JLE								
	TAG	AIRFLOW	T.S.P	NOISE	RPM	DDILVE	ł	ELECT	RICAL REQU	JIREMEN	ITS		BASIS 0	F DESIGN: NUTONE
1	1/0	(000)	(81.180)	(COLICO)	KEM I	DRIVE		_		_				

FAN	N PERF	ORM/	NCE S	SCHED	ULE						R11 -		
TAG	AIRFLOW	T.S.P	NOISE	RPM DRIVE		ELECTRICAL REQUIREMENTS					BASIS OF DESIGN: NUTONE		
1740	(CFM)	(IN.WG)	(SONES)	REM	DRIVE	НP	BHP	WATTS	AMPS	V/PH/HZ	SERVICE	ARRANGEMENT	MODEL
EF-1	94	0.25	-	-	DIRECT	-	-	-	0.65	120/1/60	TOILET	CELING	QTMO
€F-2	94	0.25	-	-	DIRECT	-	-	-	0.65	120/1/60	TOLET	CEILING	QTHO
EF-3	94	0.25		-	DIRECT	-	_	-	0.65	120/1/60	MECH ROOM	CELING	QT110
PROVIDE ALL FAIS WITH NUTONE MODEL 841-BL ROOF CAP WITH BAKED ENAMEL FINISH (COLOR BY ARCHITECT)													

ALL FANS WITH NUTOR	E MODEL 841-BL	ROOF C	AP WITH BA	KED EN
		TRA	P PROBRAGO PROCED CELIN HE	VE S
PIPMS ABOVE CEILING	M	Ź→	; ~= ; ~a#	
PERS NUML				
PLIMENS PIXTURE TIME HAT VARTE		V C		MATE
CR 4 HR SEALTHEN —	11100	¥6	CEON PAREL	•
16CILATION VALVES	- ∯ i∯i	 		
_			—- {a⊌tot	

NOTE P-2 P-3A AND P-4 FORUMES SHALL HAVE TRUP PROPERS.

RADIANT FLOOR	H <u>E</u> AT	ING S	CHEC	ULE
ROOM	LOAD (MBH)	TUBE SPACING (INCHES)	MANI- FOLD	ZONE
WARMING ROOM AND TOILETS	13.1	12"	RM1	R

,	GU TO TRAP.	
TRAP PRIMER CO	NNECTION DETAIL	

TURK TRACEY & LARRY ARCHITECTS, LLC 92 EXCHANGE STREET FORTLAND, MAINE 04101 TEL, 207.761,9662 FAX. 207.761,9696

GROUNDS

SURROUNDING AND. H

Deering Oaks Rehabilitaion

DATE: 25 AUGUST 2004 SCALE: AS NOTED DRAWN BY: JMV

REVISIONS:


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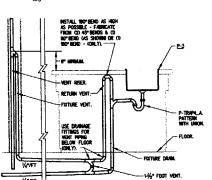
MECHANICAL AND PLUMBING SCHEDULES AND DETAILS

SHEET:


M2.1

CEILING MOUNTED CABINET UNIT HEATER PIPING DETAIL KICKSPACE HEATER PIPING DETAIL




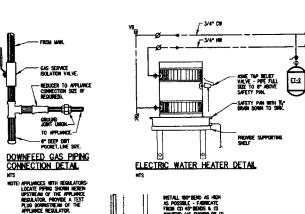


ISLAND VENTING DETAIL

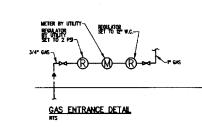

WATER ENTRANCE DETAIL

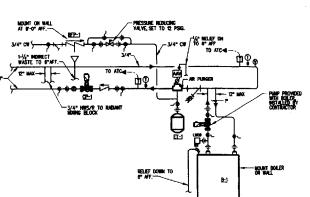

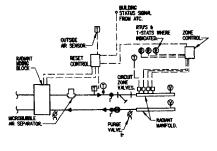


-gas service Isolation valve.

SLAB CONTROL JOINT DETAIL

NOTE: THIS DETAIL APPLIES ONLY FOR SEPARATE POUR CONTROL JOINTS, DO NOT USE FOR SAW OUT JOINTS.

RADIANT FLOOR PIPING & CONTROL SCHEMATIC

BOILER PIPING SCHEMATIC

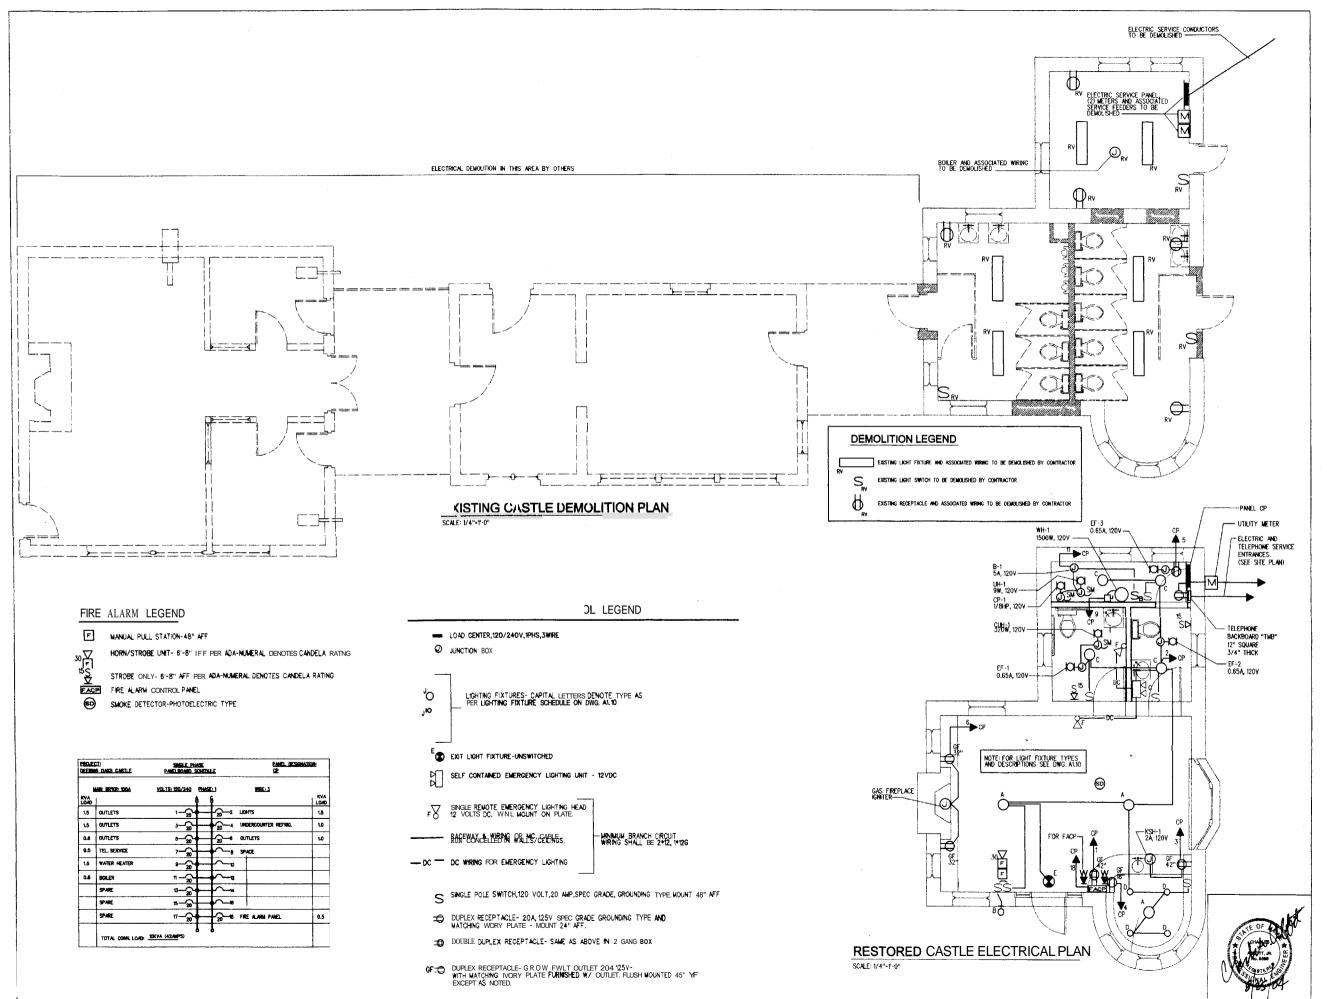



ATCHERCEY & LARRY
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GROUNDS AND SURROUNDING Deering Oaks Rehabilitaion CITY OF PORTLAND PORTLAND, MAINE

DATE: 25 AUGUS 2004 SCALE: AS NOTED DRAWN BY:

REVISIONS:

PLAOTRICAL

SHEET:

ΕI