		· · · · · · · · · · · · · · · · · · ·									_	,						
							MA	AKE UP A	IR UNIT	SCHEDI	JLE							
				SUPPL	Y FAN				GAS HEA	ATING SECT	ION				ELECT	TRICAL		
TAG	SERVES	MODEL	CFM	ESP	BHP	HP	INPUT	OUTPUT	FUEL	EFF	TURNDOWN	TYPE	WEIGHT		MAX			NOTES
				IN WC			MBH	MBH		%	RATIO		LBS	MCA	FUSE	VOLT	PHASE	
MUA-1	HOOD-H1	DGK-112-H15	3150	0.5	1.52	2	266	245	NG	92	25:1	DIRECT	521	10.1	15	208	3	1, 2, 3, 4, 5, 6, 7, 8
MUA-2	HOOD-H2	DGK-110-H15	1925	0.5	0.78	1	163	150	NG	92	20:1	DIRECT	474	6.4	15	208	3	1, 2, 3, 4, 5, 6, 7, 8
MAKE UP A	IR UNIT SCHEDULE NO	OTES:																
1	1 BASED ON GREENHECK																	
2 SCHEDULED ELECTRICAL DATA FOR SINGLE POINT POWER																		
3 PROVIDE FACTORY INSTALLED AND WIRED DISCONNECT SWITCH																		
4	PROVIDE WEATHER	HOOD WITH WASHA	BLE ALUN	IINUM MESH	FILTERS													
5	PROVIDE 18" INSULA	TED ROOF CURB.																
6	MOTORIZED OUTSIDE	E AIR DAMPER																

GENERAL NOTES

1. COORDINATE SOFFIT PENETRATIONS WITH INTERIOR DECOR PACKAGE. 2. DUCTWORK SHALL BE INSULATED OVER SOFFITS AND IN CONCEALED

3. RETURN AND SUPPLY DUCT DIMENSIONS MAY NOT BE ALTERED WITHOUT PRIOR APPROVAL FROM THE ENGINEER. 4. HORIZONTAL RUNS OF HOOD EXHAUST DUCTWORK SHALL PITCH UP IN DIRECTION

OF AIRFLOW, MINIMUM OF 1/4" PER FOOT

5. PROVIDE DUCT SMOKE DETECTORS IN THE SUPPLY DUCT OF EACH UNIT, RATED 2000 CFM OR MORE AS REQUIRED BY CODE.

6. ALL FANS TO BE 15'-0" MINIMUM FROM THE EDGE OF THE BUILDING UNLESS APPROVED SAFETY RAILS ARE PROVIDED AT ROOF EDGE. 7. MAXIMUM LENGTH OF FLEXIBLE DUCT SHALL NOT EXCEED 60", NOR BE USED IN PLACE OF ELBOWS.

8. EQUIPMENT AND WIRING SHALL COMPLY WITH LOCAL AND STATE CODES. 9. ALL DUCTWORK PASSING THROUGH FIRE RATED WALLS OR FLOORS MUST HAVE FIRE DAMPERS AT EACH PENETRATION.

							FAN	SCHEE	ULE									
TAG	MANUFACTURER	MODEL	SERVICE	AIR FLOW	ESP	FAN	DRIVE	MOTOR	MOTOR	MOTOR	MOTOR	SOUND					NOTES	REMARKS
				CFM	IN W.C.	RPM		BHP	HP	RPM	TYPE	SONES	V/P/Hz	FLA	MCA	OCPD		
HEF-1	GREENHECK	CUBE 180 -20	HOOD H-1 EXHAUST	4500	0.75	1353	BELT	1.6	2	1725	ODP		208/3	10.1	15	15A/3P	1, 4, 7	SEE DETAIL ON M501
HEF-2	GREENHECK	CUBE 180-7	HOOD H-2 EXHAUST	2750	0.75	1003	BELT	0.68	1	1725	ODP		208/3	5.0	15	15A/3P	1, 4, 7	SEE DETAIL ON M501
HEF-3	GREENHECK	CUBE 101-4	HOOD H-3 EXHAUST	600	0.50	1217	BELT	0.12	0.25	1725	ODP		120/1	5.8	15	15A/1P	1, 2, 5	SEE DETAIL ON M501
EF-1	GREENHECK	CUBE 101-4	OVEN HOOD	800	0.50	1394	BELT	0.08	0.25	1725	ODP		120/1	9.8	12.3	15A/1P	1, 2, 4, 5	SEE DETAIL ON M501
EF-2	GREENHECK	G-075-D	PROOFER EXHAUST	300	0.25	1532	DIRECT	0.03	0.04	1550	ODP		120/1	5.8	15	15A/1P	1, 2, 3, 4, 5	SEE DETAIL ON M501
GENERAL	NOTE: THE MECHANICAL CON	NTRACTOR SHALL BE	RESPONSIBLE FOR THE S	TART-UP OF	FANS. FANS	SHALL DE	EMONSTRA	TE ACCEF	PTABLE PE	RFORMAN	ICE (MEET	OR EXCE	ED THE DE	SIGN PER	RFORMANO	E LISTED	HERE-IN)	
	AT THE TIME OF	COMMISSIONING AN	ND THROUGH THE WARRAN	NTY PERIOD.														
KEYED NO	OTES:																	
	1. PROVIDE NEMA 1 DISCONN																	
	2. PROVIDE RUSKIN BACKDRA																	
	3. PROVIDE SOLID STATE SPE	500 January Co. 80 E. 10 C. 10																
	4. PROVIDE THERMAL OVERL	OAD FOR MOTOR																
	5. PROVIDE 14" ROOF CURB																	
	6. PROVIDE 1/2" MESH GALVA																	
	6. PROVIDE 1/2" MESH GALVA 7. PROVIDE ROOF CURB HEIG			ARGE IS 40",	MINIMUM, AE	OVE ROC	F LEVEL.											
	6. PROVIDE 1/2" MESH GALVA			ARGE IS 40",	MINIMUM, AE	OVE ROC	DF LEVEL.											
	6. PROVIDE 1/2" MESH GALVA 7. PROVIDE ROOF CURB HEIG			ARGE IS 40",	MINIMUM, AE	BOVE ROC	DF LEVEL.											

	KITCHEN EXHAUST HOOD SCHEDULE															
TAG	MANUFACTURER	MODEL	SERVICE	LENGTH / WIDTH / HEIGHT	COLLAR	CFM	PD (IN WC)	COLLAR	SUPPLY	PD (IN WC)	MOUNTING HEIGHT	MATERIAL (100%)	LIGHTS (QTY & TYPE)	CLOSURE COLLAR HEIGHT	DAMPER	NOTES
H-1	GREENHECK	GHFW	Ovens/Fryer/ROTT	216/72/24	(2) 22 x 9	4,500	0.49	(2) 40 x 8	3,150	0.07	7'-0" AFF	304 SS	6 CFL	60"	NONE	1, 2, 3, 4, 5
H-2	GREENHECK	GHFW	GRILLES	144/66/24	26 x 10	2,750	0.41	(1) 40 x 10	1,925	0.06	7'-0" AFF	304 SS	4 CFL	60"	NONE	2, 3, 4, 5
H-3	GREENHECK	GD2	DISHWASHER	48/48/24	14 x 12	600	0.03	N/A	N/A	N/A	7'-0" AFF	304 SS	N/A		NONE	4, 5

ELECTRICAL GAS VALVE SUPPLIED BY MECHANICAL CONTRACTOR

PULL

FINISHED FLOOR

- WALL MOUNTED FIRE PROTECTION CONTROLS LOCATED ABOVE CEILING

RUN SS SHROUD FROM HOOD
 TO ABOVE ACT, (TYP. 3 SIDES)
 DO NOT INSTALL UNTIL AFTER
 DECORATIVE APRON IS IN PLACE


PULL STATION, SEE M1 FOR LOCATION

-2"X1" SS 16 GA ANGLE TO BE SUPPLIED AND INSTALLED BY MECHANICAL CONTRACTOR


1 PROVIDE HOOD IN 2 SECTIONS 2 PROVIDE 3" STANDOFF AT BACK OF HOOD


3 PROVIDE FIRE SUPPRESSION SYSTEM. SEE DETAIL ON SHEET M501.


4 MECHANICAL CONTRACTOR IS RESPONSIBLE FOR START-UP OF THIS EQUIPMENT. 5 PROVIDE STAINLESS STEEL CLOSURE PANELS TO 6" ABOVE CEILING MATCHING HOOD FINISH.

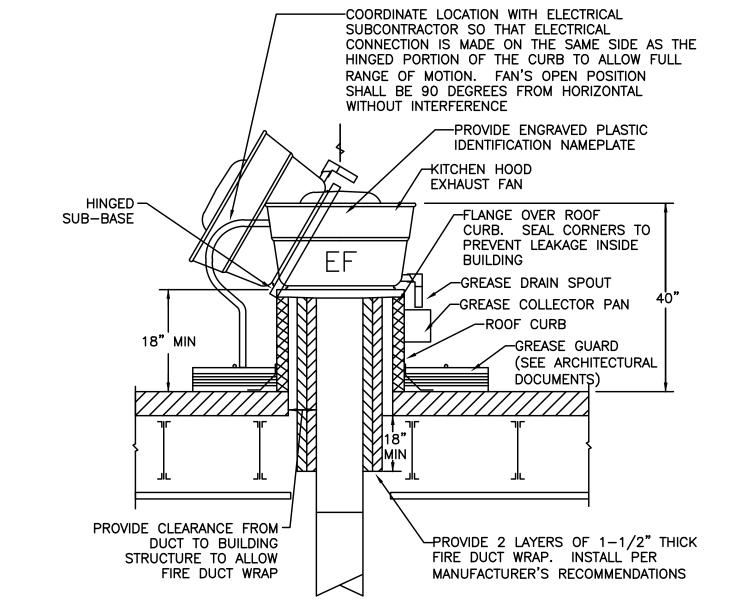



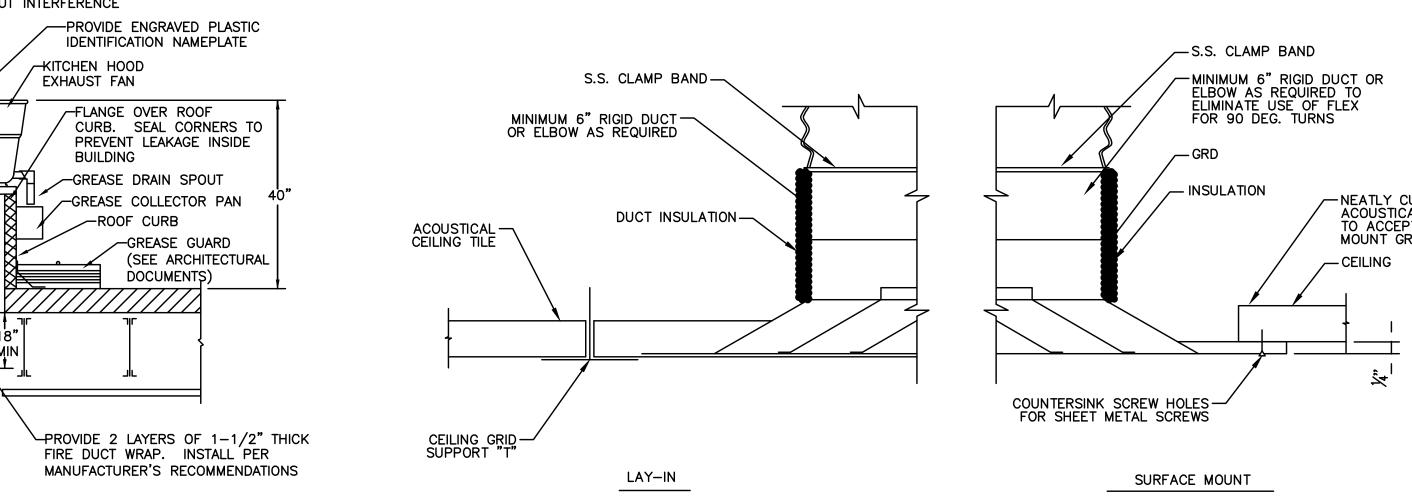

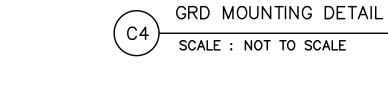

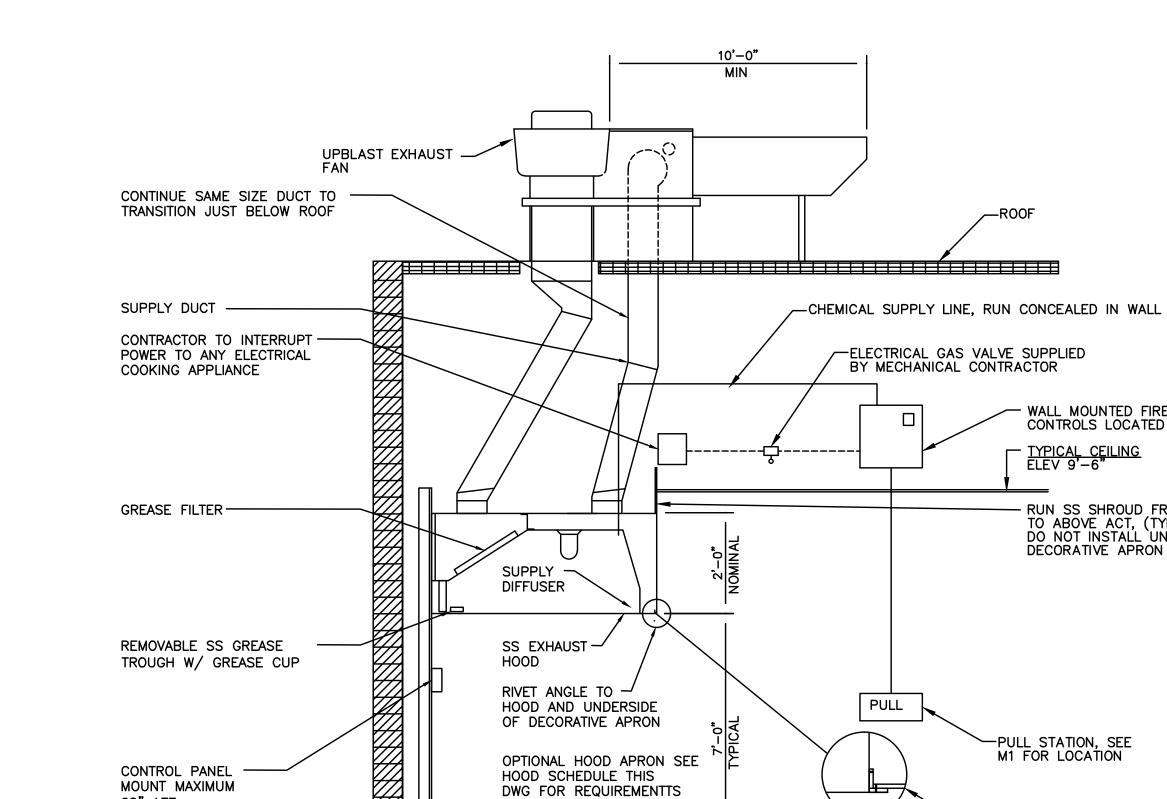

NOTES: FIRE PROTECTION SYSTEM FURNISHED BY HOOD MANUFACTURER.

60" AFF

- 5. APPROPRIATE ACCESS PANELS FOR CLEANING EXHAUST DUCT MUST BE INCLUDED. FIELD MEASUREMENT REQUIRED TO LOCATE AND FABRICATE SUPPLY & EXHAUST DUCT.
- ALL SYSTEM COMPONENTS SHOWN (EXCEPT OPTIONAL DECORATIVE APRON)SHALL BE SUPPLIED BY THE HOOD MANUFACTURER. 7. CONFIRM EXACT LOCATION OF PULL STATION
 AND FIRE PROTECTION CONTROLS WITH
 ENGINEER PRIOR TO INSTALLATION. ANSUL MUST NOT
 BE NOT BE MOUNTED TO SIDE OF HOOD WHERE DEC.
 APRONS ARE REQUIRED. 3. THE MECHANICAL CONTRACTOR SHALL FURNISH &
- INSTALL STAINLESS STEEL SIGHT SCREEN AROUND DUCTS TO FILL SPACE BETWEEN THE CEILING AND THE HOOD. TO BE INSTALLED AFTER THE DECORATIVE APRON ON 8. MECHANICAL CONTRACTOR IS RESPONSIBLE FOR FURNISHING BOTH THE GAS VALVE AND THE ELECTRICAL CONTRACTOR. HOOD WHERE REQUIRED
- 4. ANY DUCT OFFSET ANGLE FROM VERTICAL MUST BE LESS THAN 45 DEGREES. NO HORIZONTAL SECTIONS PERMITTED FOR THE EXHAUST STACK.

 9. AIR BALANCING OF THE HOOD IS THE RESPONSIBILITY OF THE AIR BALANCING CONTRACTOR.

ROOF P 8"dia WELDED 16 GA. STEAM HOOD STACK	EXHAUST FAN SEE SCHEDULE ON DWG M-601		
		NO	TES:
CEILING_		1.	REF OF
		2.	FIE BE FA
STEAM HOOD	BAKERY OVEN	3.	8" INS NE
	OVEN	4.	HO IN TO IS
FINISHED FLOOR		5.	AN ML HC FO
_ ^	VENI CTACK DETAIL		

Sheet No.

GRAVITY BACKDRAFT DAMPER AK-2, I/O ENCLOSURE 32 T.O.D. INPUT VIA LON LOOP	SALES AREA SIDE SECURE DUCT ANGLE TO WALL — SEAL ALL AROUND	
BAKERY OVEN/PROOFER EXHAUST FAN CONTROL SCHEMATIC SCALE: NOT TO SCALE	B2 DUCT PENETRATION THRU WALL SCALE: NOT TO SCALE	
MECHANICAL CONTRACTOR SHALL ENSURE THAT SUSPENDED DUCT MEETS ALL SEISMIC CODE REQUIREMENTS BY INSTALLING 3 DIMENSIONAL BRACING PER SMACNA GUIDELINES. TECH SCREW TOP REINFORCEMENT TO DUCT ANGLE OR CHANNEL STRAP TO DUCT SPIRAL DUCT HANGER APPLIES TO 18" AND LARGER NOTE: DO NOT USE AIRCRAFT CABLE TO SUPPORT DUCTWORK.	FLEX CONN. 60" LG MAX -NOT FOR 90 DEG ELBOWS ACT CEILING	ROUNDED DUCT ELBOW IS PREFERRED MITERED ELBOW ONLY IF SHOWN OR CALLED OUT ON PLAN
DUCT HANGING DETAIL	FLEX CONN. DETAIL	DUCT ELBOWS DETAIL

SCALE : NOT TO SCALE

MOUNT SPEED CONTROLLER IN FAN HOUSING

PROVIDING AND LOCATION OF STEEL ROOF PENETRATION, DECK SUPPORT, FRAMES IS THE RESPONSIBILITY OF THE MECHANICAL CONTRACTOR.

ROOFTOP EXHAUST FAN DETAIL

SCALE: NOT TO SCALE

WOOD NAILING~

PREFABRICATED-INSULATED ROOF CURB

STUFF VOIDS W/BATT — INSULATION

SCALE : NOT TO SCALE

CENTRIFUGAL EXHAUSTER

FLASHING BY OTHERS

ANGLE SUPPORTS
BETWEEN BAR JOISTS.

— SECURE DUCT ANGLE TO WALL — SEAL ALL AROUND

GRAVITY BACKDRAFT DAMPER

