

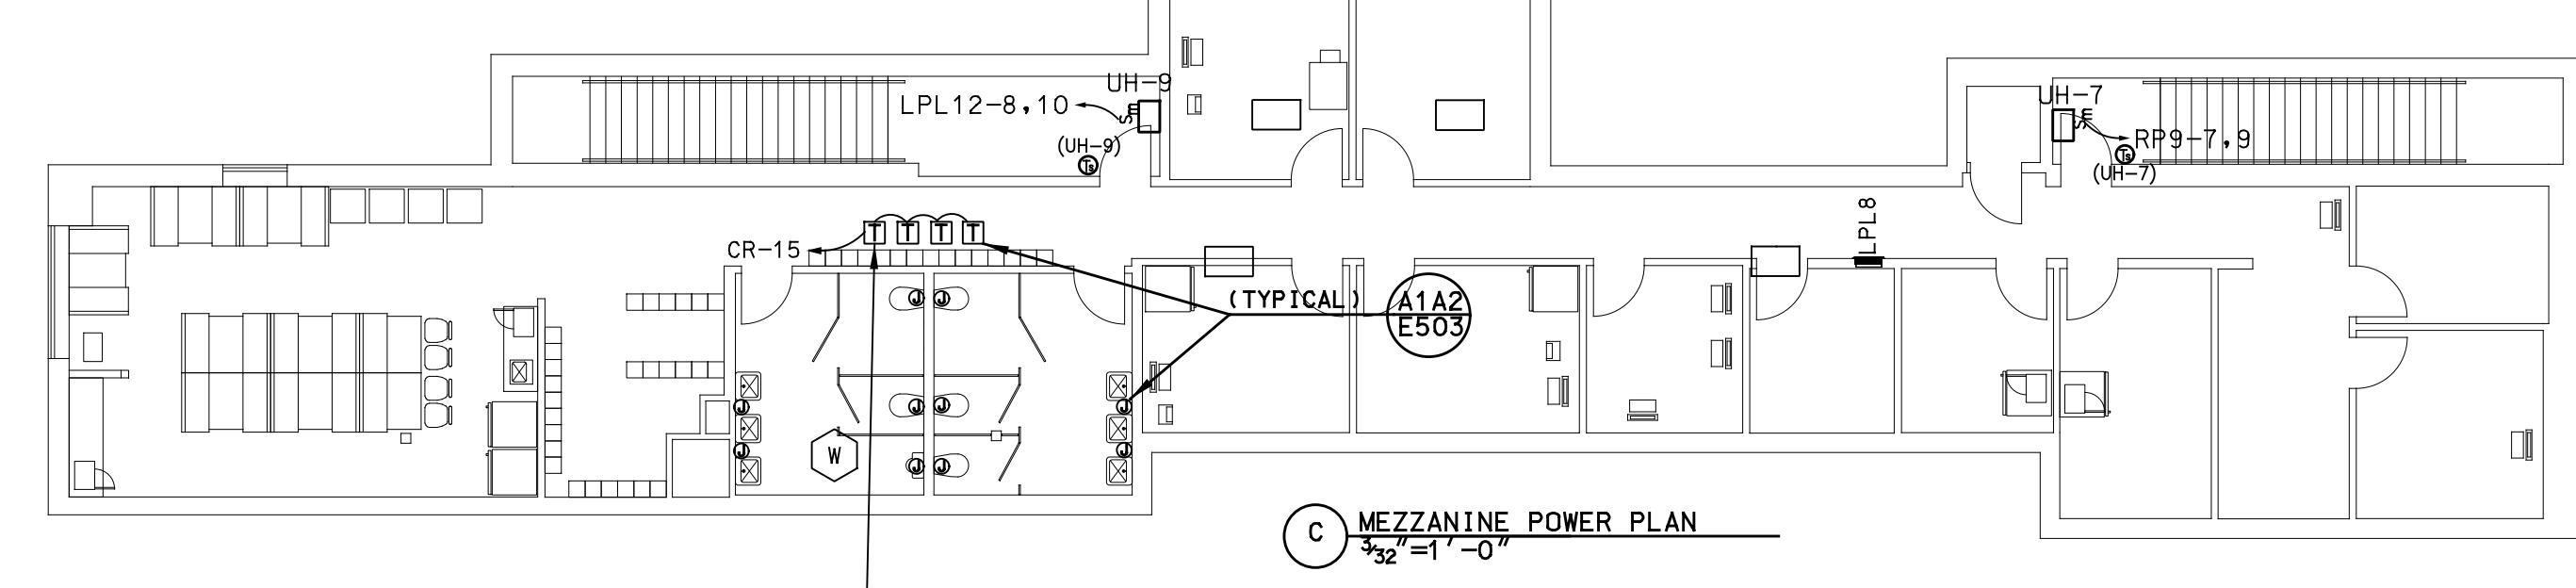


11/17/2011 9:50:23 AM
A
B
C
D
E

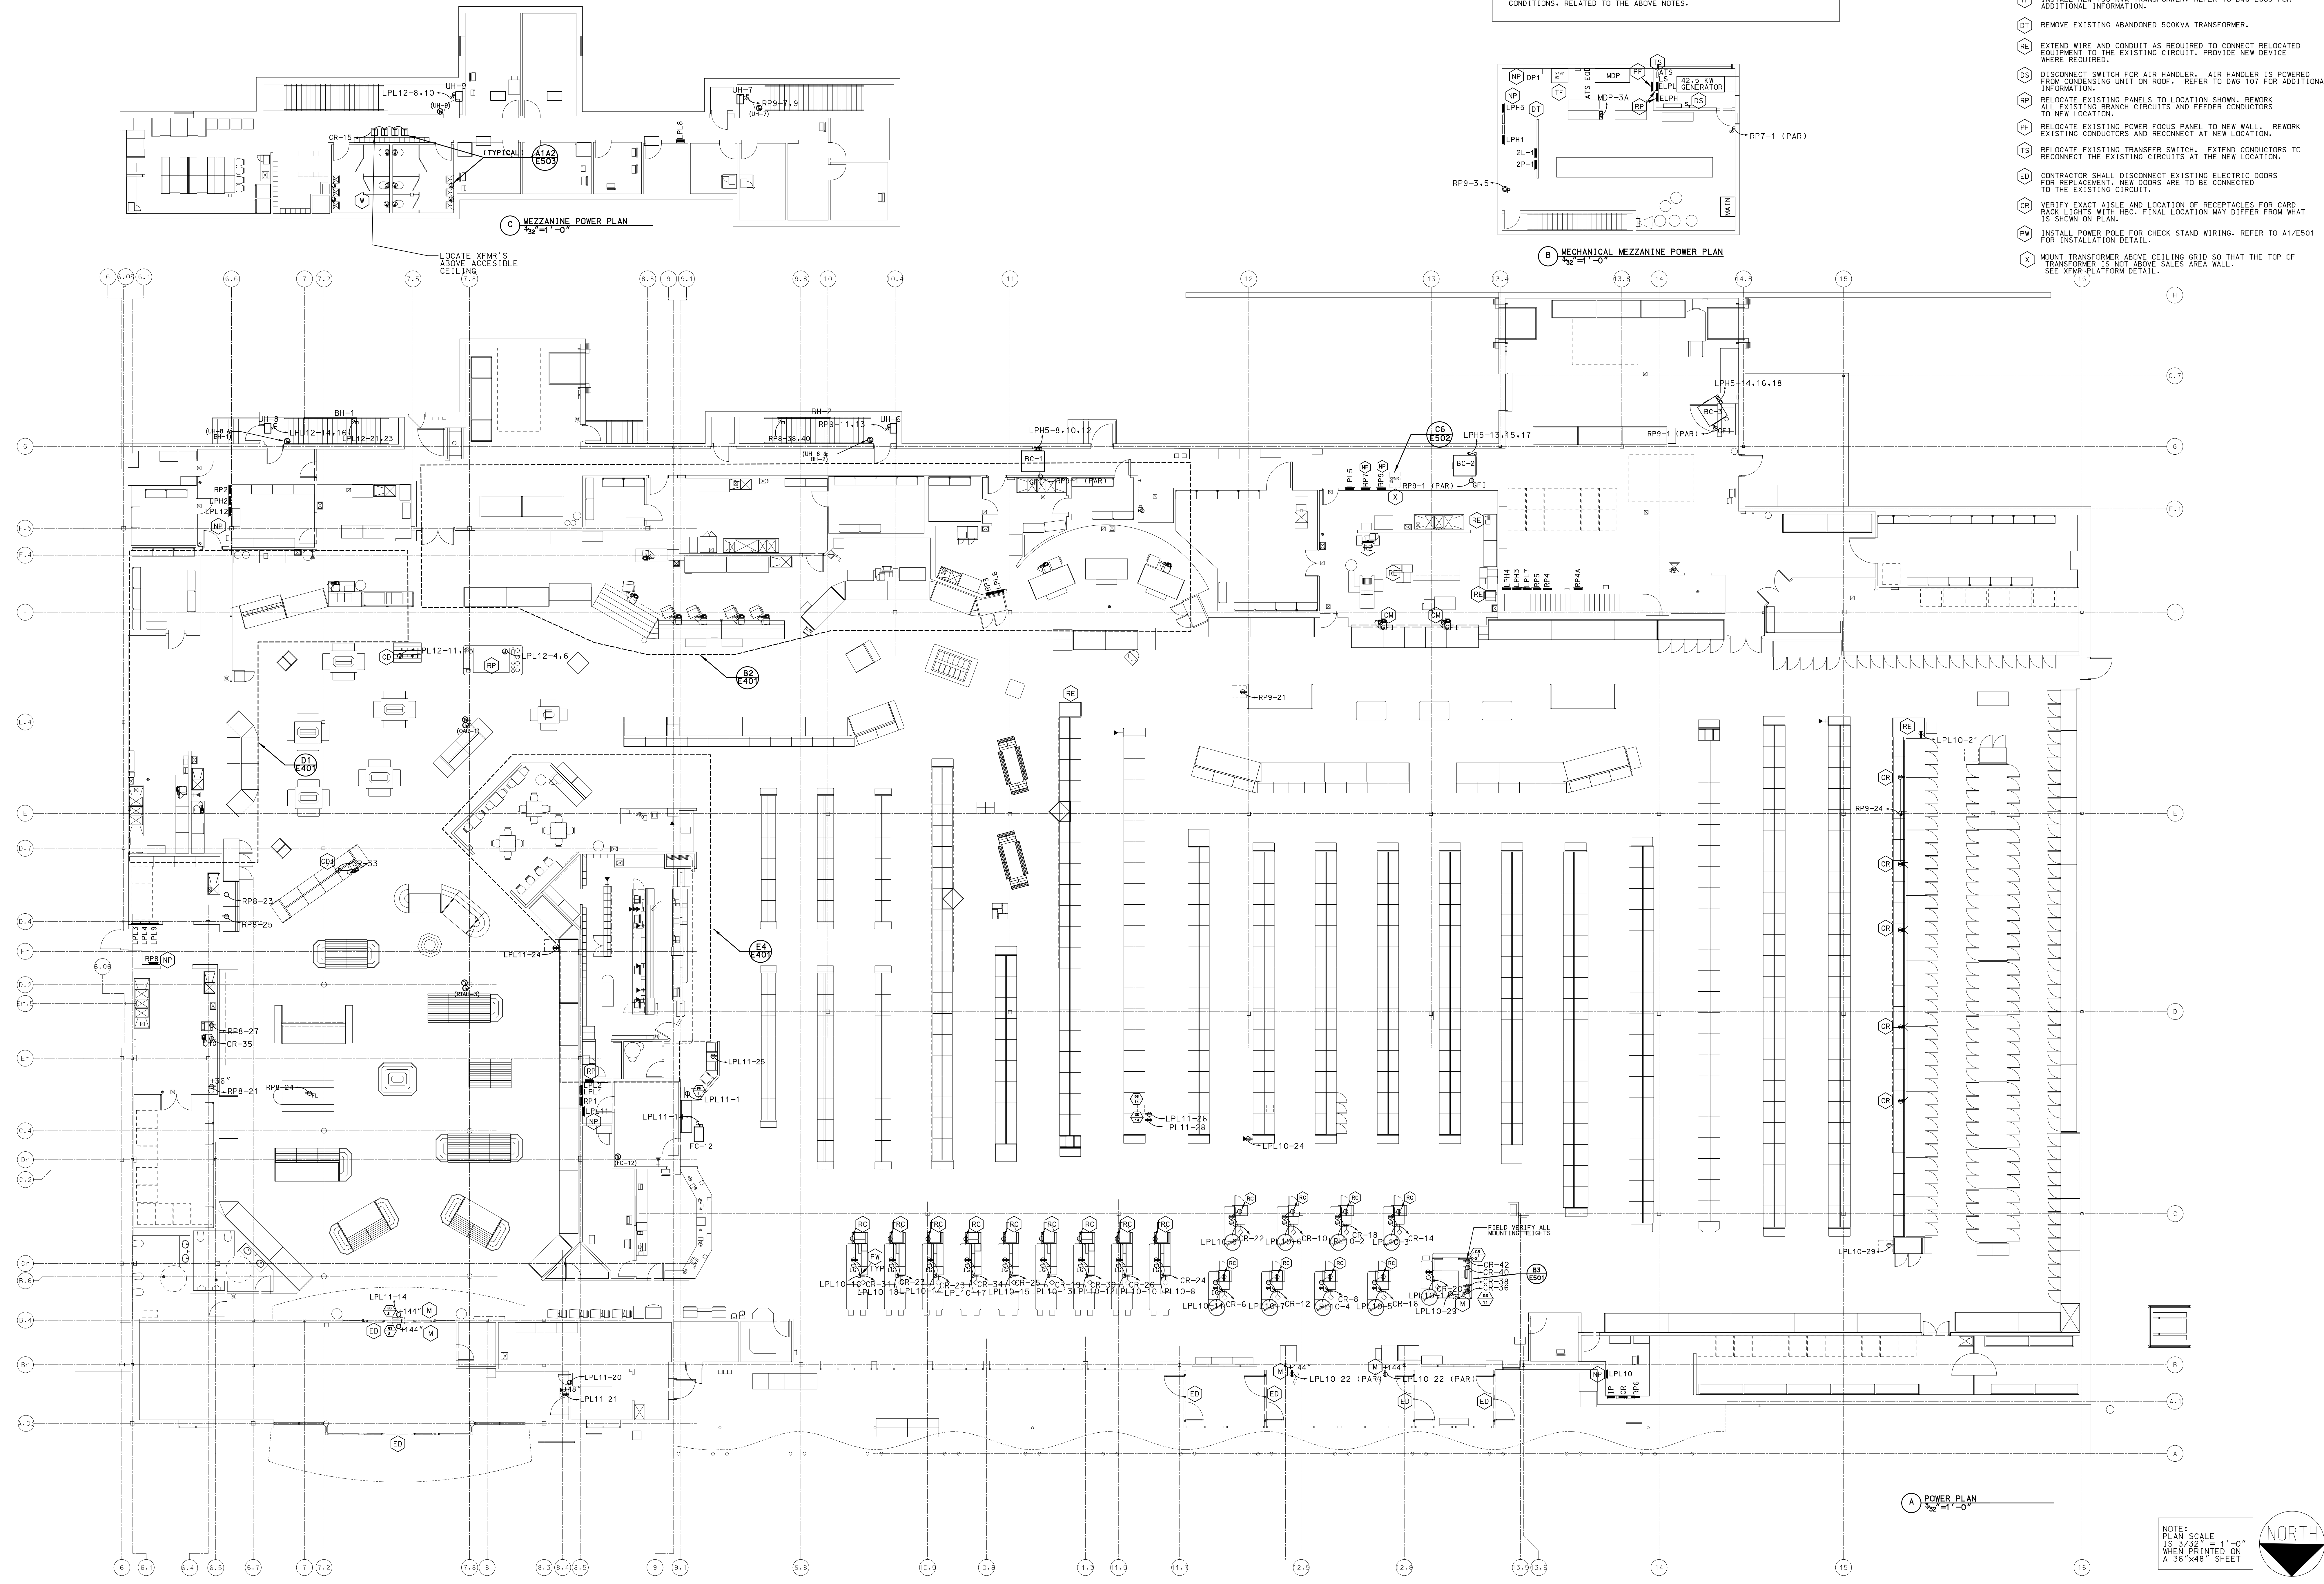


DEMOLITION NOTES:
1. REMOVE ALL NM TYPE CABLE AND REPLACE WITH MC OR AC CABLE.
2. ALL ABANDONED WIRING, NM, MC, AC CABLE AND ABANDONED CONDUCTORS IN CONDUIT SYSTEMS SHALL BE REMOVED.
3. ABANDONED LOW VOLTAGE CABLE IS TO BE REMOVED.
4. EXISTING JUNCTION BOXES SHALL BE MADE CODE COMPLIANT.
5. EXISTING TERMINATIONS SHALL BE MADE CODE COMPLIANT.
6. THE CONTRACTOR SHALL BE RESPONSIBLE TO LOCATE AND CORRECT ALL SUCH CONDITIONS, RELATED TO THE ABOVE NOTES.

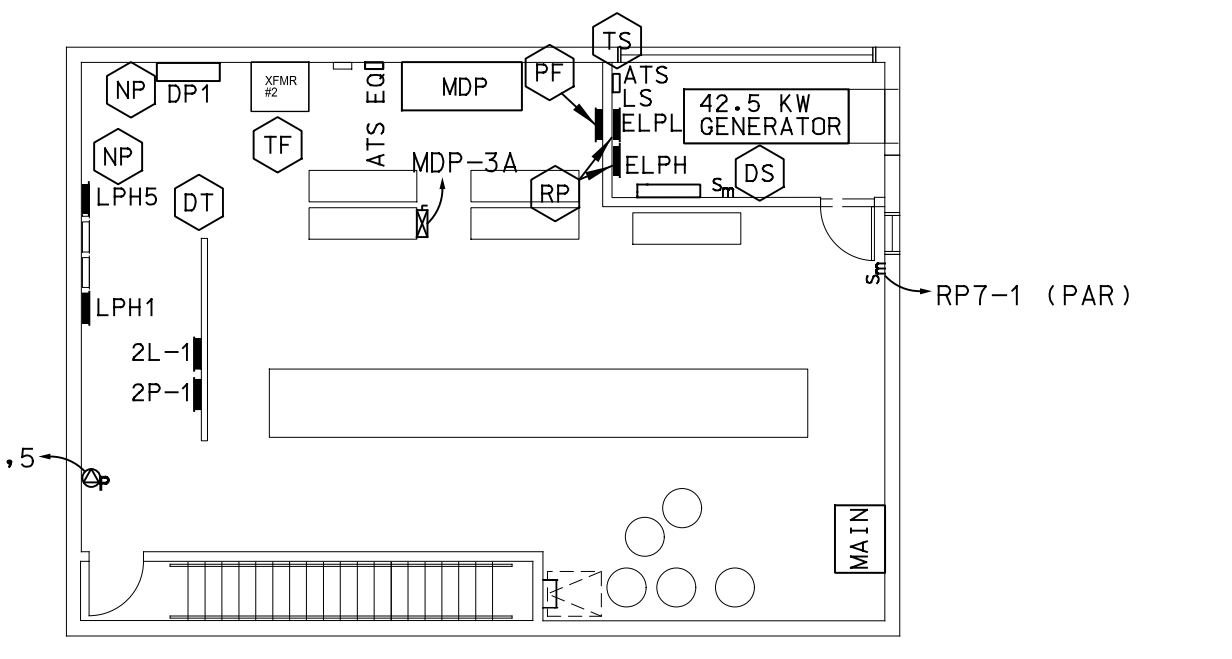

- GENERAL NOTES:
- 1) DETAIL 05-E503 APPLIES TO ALL OVERHEAD CONDUITS EXITING TOP OF WALL ADJACENT TO AND VISIBLE FROM SALES FLOOR.
 - 2) CONDUITS W/ PULLSTRINGS SHOWN ON 1-101 ARE PROVIDED UNDER G.C. SCOPE OF WORK. CABLE & WIRE IS A SEPARATE CONTRACT TO HBC.
 - 3) ALL EXTERIOR VENDING MACHINE RECEPTACLES SHALL HAVE WEATHER PROOF IN USE COVERS.
 - 4) ALL FEEDERS TO ELECTRICAL PANELS ARE TO BE ROUTED OVERHEAD.
 - 5) ABANDONED CONDUIT PENETRATIONS THROUGH STRUCTURAL FLOOR SLAB (GROUND FLOOR SLAB) SHALL BE FILLED WITH CONCRETE.
 - 6) ABANDONED CORED HOLES THROUGH STRUCTURAL FLOOR SLAB SHALL BE FILLED WITH CONCRETE.
- KEY NOTES:
- (H) HEAT TRACE PROVIDED BY PLUMBING CONTRACTOR. EC SHALL FIELD LOCATE AND WIRE TO GF1 BREAKER WITH 30 MILLAMP TRIP
 - (RC) RECEPTACLE PROVIDED BY CHECKSTAND MANUFACTURER E.C.1 TO MAKE FINAL CONNECTIONS. TYPICAL TO ALL CHECKSTANDS UNLESS NOTED OTHERWISE.
 - (W) EC TO ENSURE ALL LOW VOLTAGE WIRING FOR FLUSH-0-METERS IS CONCEALED WHEN POSSIBLE AND INSTALLED IN COMPLIANCE WITH ARTICLE 110.12 OF THE NEC.
 - (M) EC TO FURNISH FLUSH MOUNTED J-BOX WITH 1/2\"/>

No.	Date	Revision
2	11/19/11	ISSUED FOR CONSTRUCTION
1	10/21/11	ISSUED FOR HANNAFORD 100% REVIEW
0	09/26/11	ISSUED FOR HANNAFORD 100% REVIEW

REMODEL HANNAFORD SUPERMARKET & PHARMACY
STORE #8351 - 295 FOREST AVENUE
PORTLAND, MAINE 04101

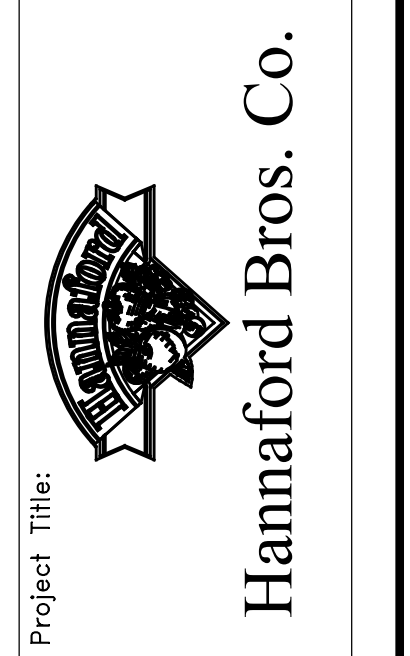

Project Title:
JACOBS
JACOBS ENGINEERING GROUP, INC.
5700 Major Boulevard, Suite 400
Portland, ME 04103-2001
Phone: 407-903-2001 Fax: 407-903-5195

Prepared By:
Swat:
ELECTRICAL ENGINEER OF RECORD
NAME: JOSEPH HARRILL, P.E.
MANE REGISTERED PEI: 17107

POWER PLAN
Scale: 3/32" = 1'-0"
Date: 10/21/11
Designed by: J. HARRILL
Drawn by: J. HARRILL
Checked by: L. PEREZ

Drawing No.
E103
Project No.
PFR0300
HBC-PORTLAND, ME

