



34A-B-1 marginal way Miss Portland Diner Tomaks, LLC. 2007-0052

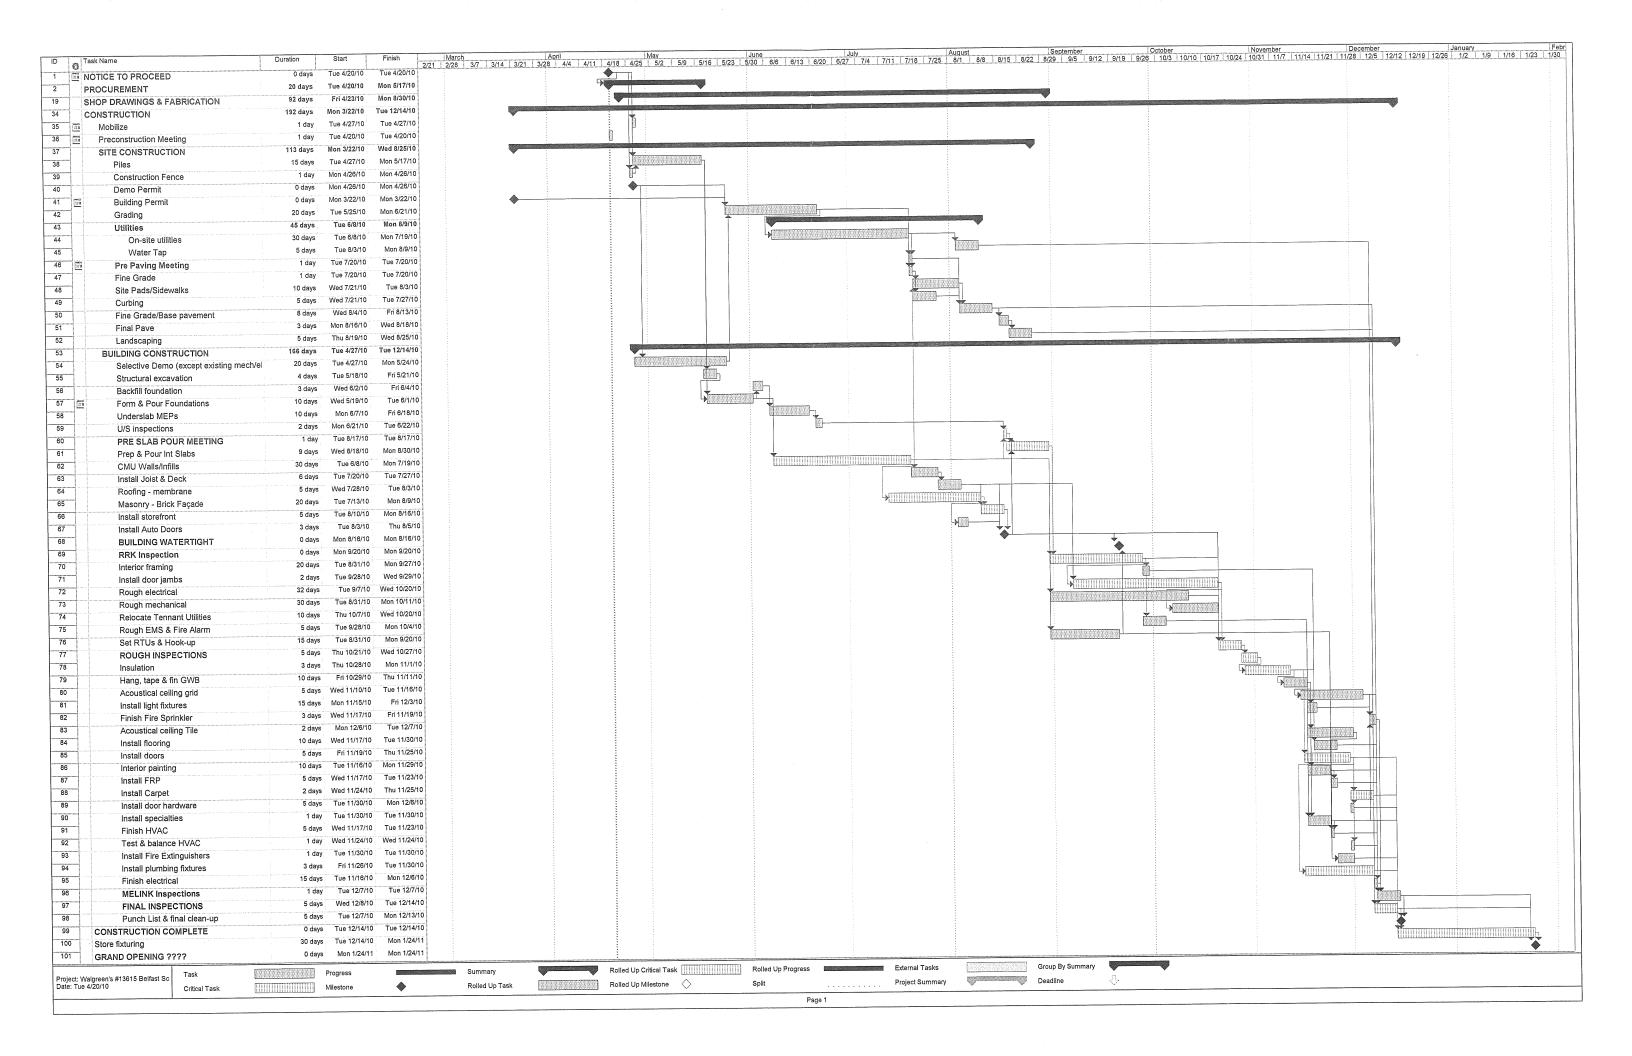

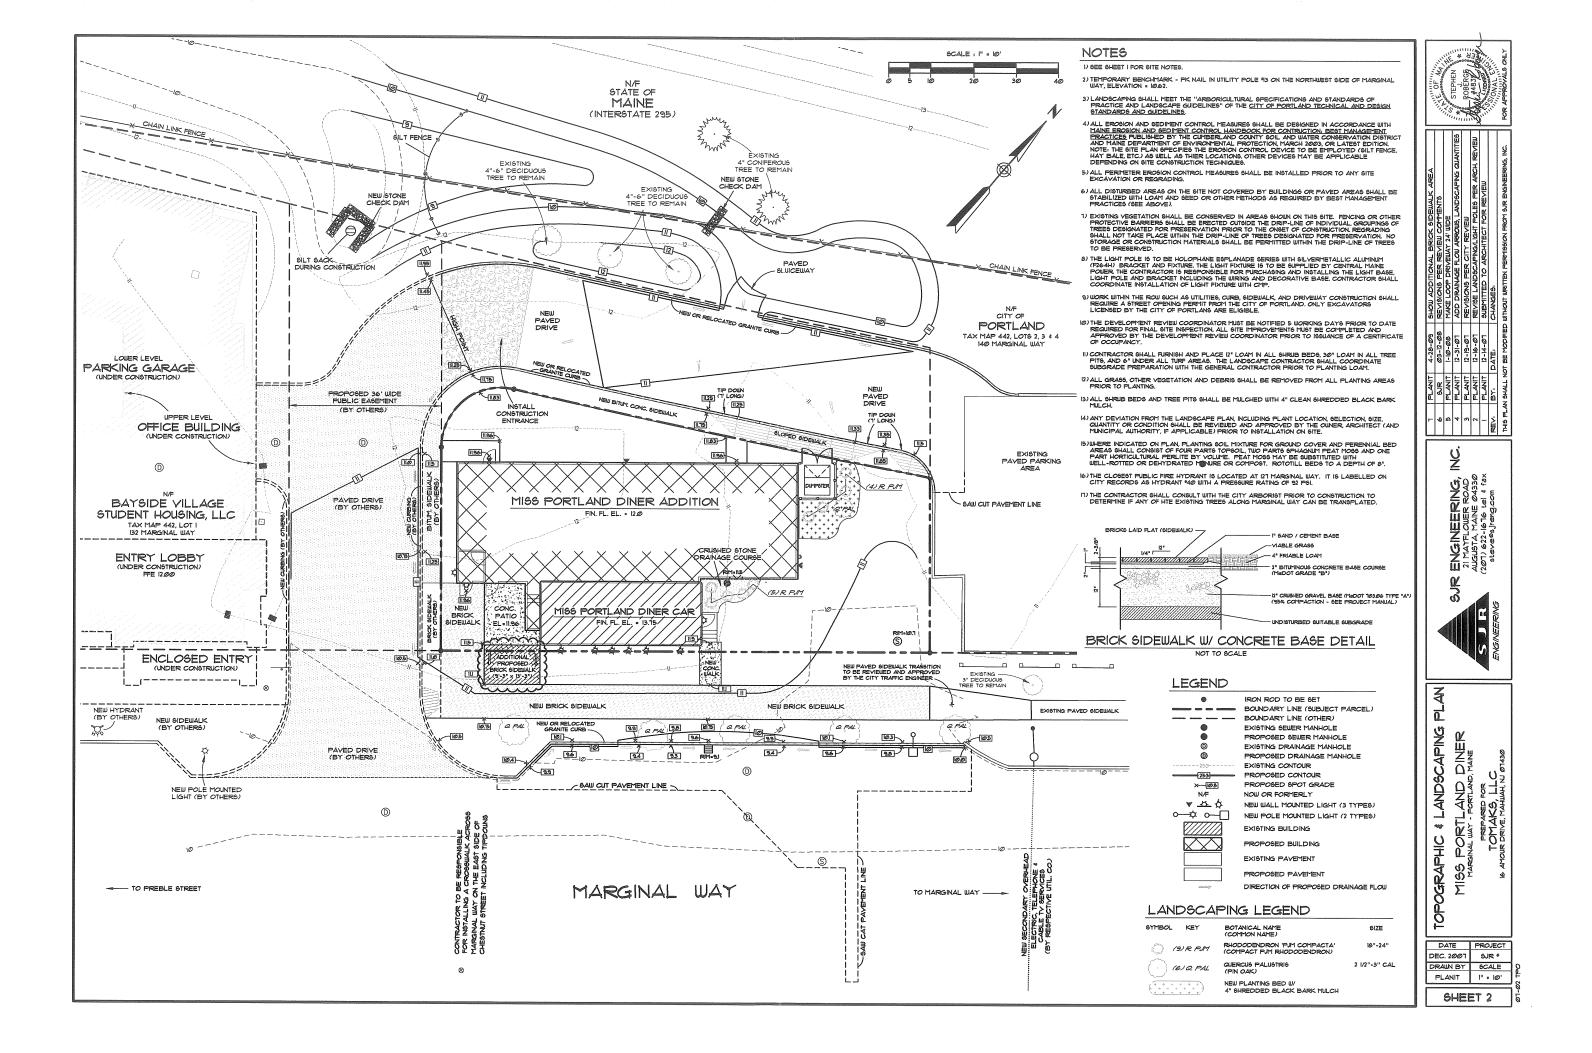

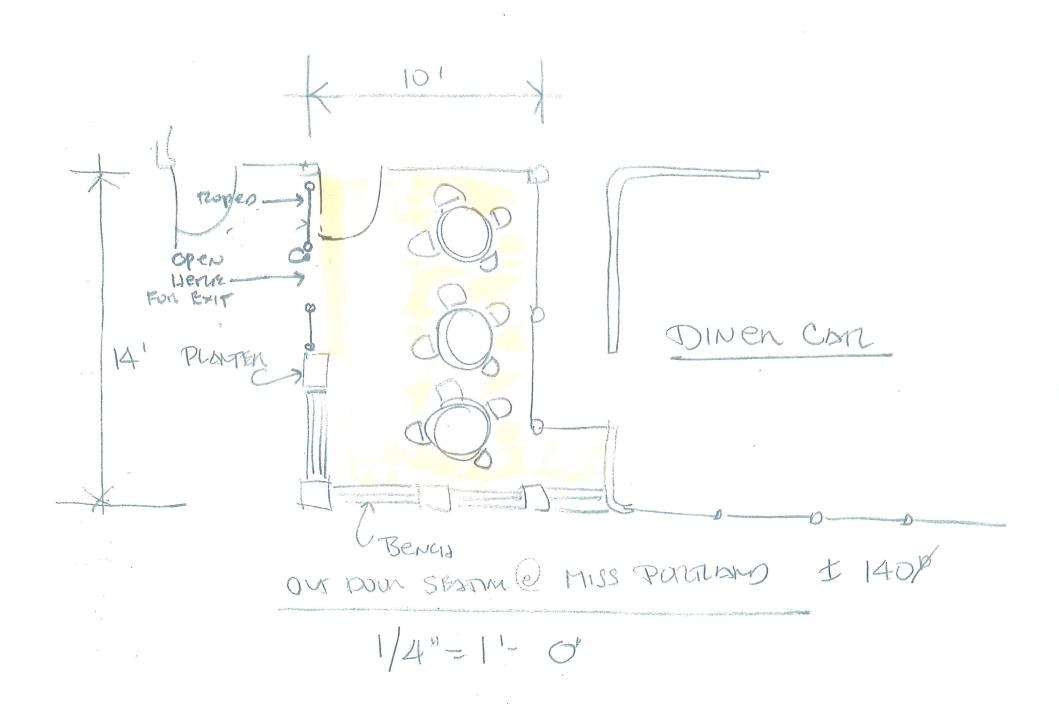

.

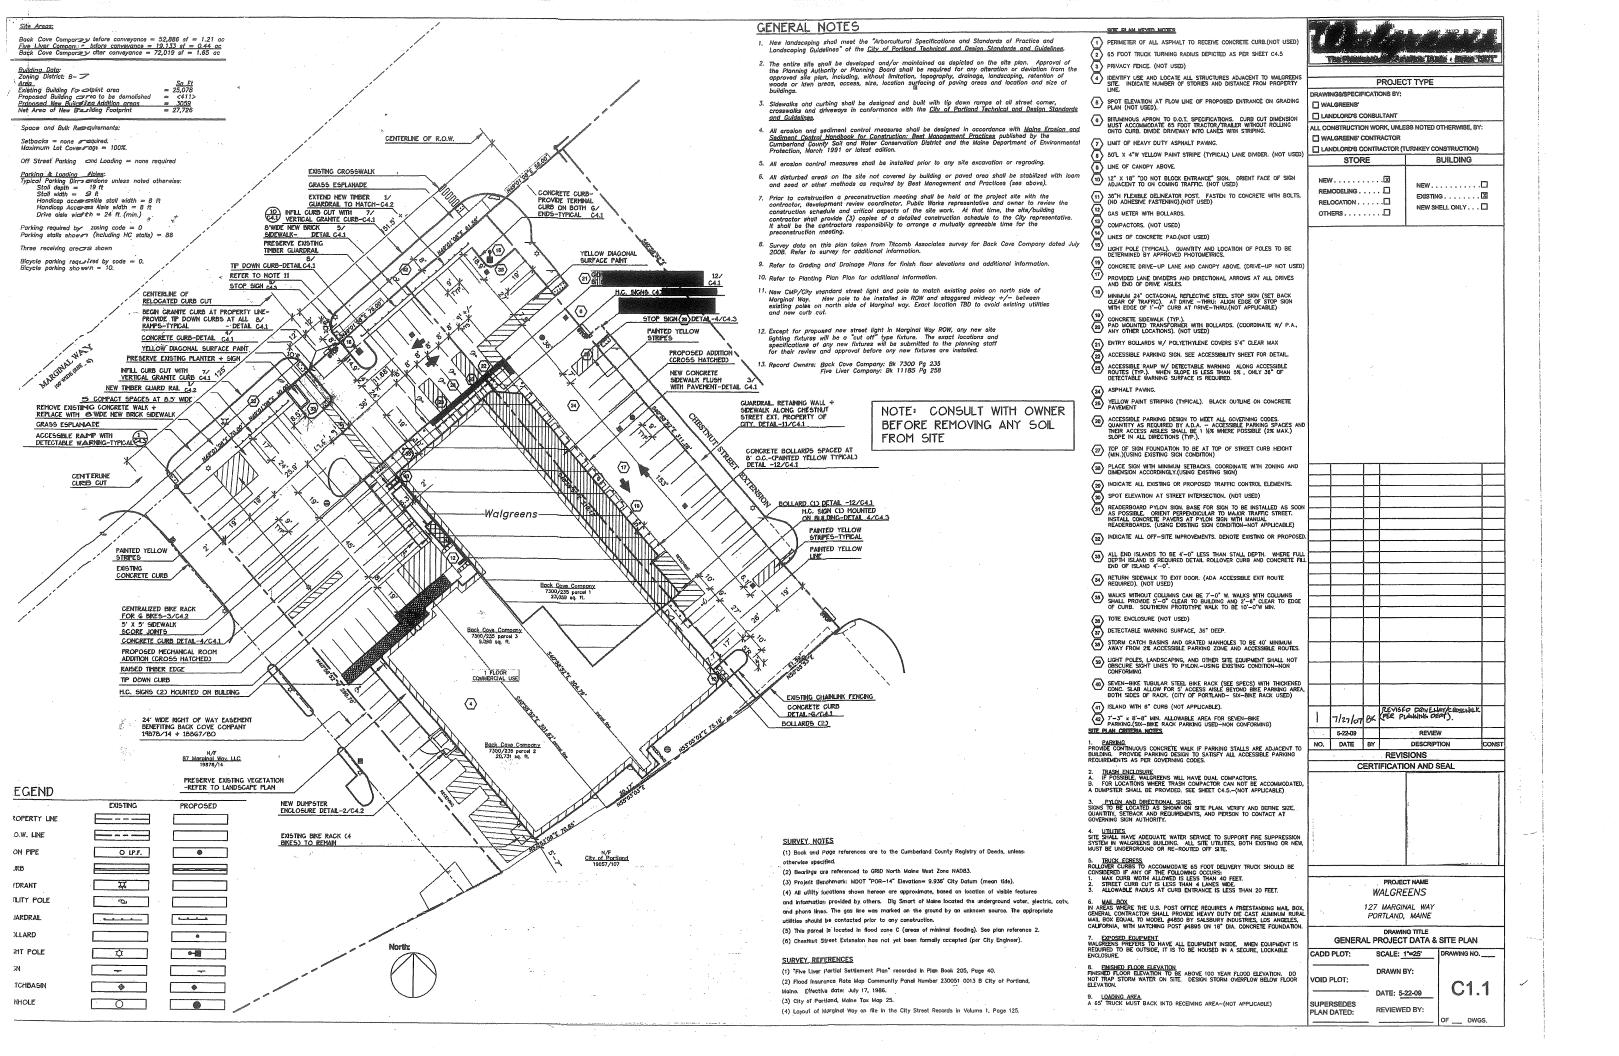

### EROSION AND SEDIMENTATION CONTROL PLAN THIS PLAN HAS— BEEN DEVELOPED AS A STRATECY TO CONTROL SOL EROSION AND SEDMENTATIONS DURING AND AFTER THE RECONSTRUCTION OF A PARTING LOT AND BUILDING WITH ADDITION LOCATED AT 127 MARCHAL WAY IN PORTLAND, MANE. THIS PLAN IS BASEED ON THE STORMWATER MANAGEMENT FOR MANNE VOLLIME II BMP6 TECHNICAL DIEESIN MANUAL DATED JANUARY 200G. A. PROPOSED DEVEELOPMENT THE PROJECT CONSISTS OF THE RECONSTRUCTION OF A PARKING LOT AND THE REMOVATION ALMO AN ADDITION TO THE EXISTING BUILDING. THE LIMIT OF EARTH MOVEMENT IS SWITHIN THE PROPERTY LINES TO THE NORTHEAST OF THE EXISTING BUILDING. B. EROSION CONTRE CL PRACTICES/TEMPORARY MEASURES THE FOLLOWING. TIMPORARY MEASURES TO CONTROL EROSION AND SEDMENTATION SHOULD BE LITLIZED. EACH GROUND AREA OFFNED OR EXPOSED, WHETHER DIRECTLY OR INDIRECTLY DUE TO THE DEVEL OPENIT, SHALL BE HINNEZED AND SHALL BE STABLIZED WITHIN 15 DAYS OF INTIAL. DISTURBANCE OF SOL AND SHALL BE FREMANENTLY STABLIZED WITHIN SEVEN DAYS. OF TIMAL GRADING, THIS STATEMENT AFFLES TO DISTURBED AREAS BEYOND THEE LITTS OF THE PROPOSED BULDING, EXPOSED AREAS SHALL BE STABLIZED PROME TO A RAIN EVENT. TEMPORARY SEEDING. FREMANENT BASE GRAVEL, OR ASPHALT BINDER COURSE AS FOLLOWS. TEMPORARY SEEDING, SEED SHALL BE ARROSSONG RYE APPLIED AT 1388/1000 SF. PETRILIZER SHALL BE ARROSLOR RYE APPLIED AT 1388/1000 SF. PETRILIZER SHALL BE ACCULTURAL GROUND LIMESTONE APPLIED AT 1388/1000 SF. PETRILIZER SHALL BE ACCULTURAL GROUND LIMESTONE APPLIED AT 1388/1000 SF. PETRILIZER SHALL BE 10-10-10 CLASSFICATION APPLIED AT 1388/1000 SF. MELCH SHALL CONSIST OF HAY AND STREAM MILCH AND SPREAD EVENLY AT A RATE OF 70-908/1000 SF. TEMPORARY SEEDING SHALL ONLY BE MADE BETWEEN AFREL 15 AND COTOBER 1. AND SHALL NOT BE PLACED OVER SHOW. TEMPORARY MILCHING, MUCH SHALL CONSIST OF CHOPPED HAY OR STRAW MULCH AND SPREAD BY MECHANICAL BLOWER EVENLY AT A RATE OF 150-2004/1000 SF. TEMPORARY MULCH HALL BE REMOVED PRIOR TO PERMANENT SOL STABLIZATION, MUCH HUST NOT BE PLACED OVER SNOW, SHOW SHALL BE REMOVED FROM TO NAME HE FOLLOWING CONDITIONS BY AND STABLIZATION, MUCH HIGH FOLLOWING CONDITIONS BY STABLIZATION HALCHING. PERMANENT SOLS STABLIZATION HERD FROM THE FOLLOWING CONDITIONS BY SICHES SHALL BELESS THAN EIGHT PERCENT. ASPHALT ERPOOPED COMPETED PAYEMENT. ASPHALT BENDER COURSE FOR THE PROPOSED COMPETED PAYEMENT. C. REOSION CONTROLL PRACTICES/PERMANT MEAGURE C. EROSION CONTROL PRACTICES PTERMANNIN HEALINE'S THE FOLLOWING PERHANNIN HEALINE'S TO CONTROL EROSION AND SEDMENTATION SHALL BE ITILIZED 1. FERNANNIN SECOND BE ITILIZED 1. FERNANNIN SECOND SHALL BE FERFORMED DURING CONSTRUCTION OPERATIONS AS EACH DISHBERD AREA HAS BEEN BROUGHT TO FINGH GRADE. FERNANENT SEEDING SHALL BE MORE AS DORMANN SECOND ATTER THE FIRST FULLING FROST. DOM-MAIN SECONG AND HULCH SHALL BE USED AT TWO TIMES THE FERNANENT SEEDING AND MULCHIN RATE SHOWN BELOW FOR BOTH LAWN SEE FULL AS EMPANKHENTS. SEED LOAN. LIFE, FERTILIZER AND MULCH ARE TO BE AS FOLLOWS.

### FOLLOWS, SEED THE SEED MATURE SHALL CONSIST OF SEED PROPORTIONED BY WEIGHT. ALL SEED SHALL BE FRESH, CLEAN, NEW CROP' SEED, HARMLESS NERT MATTER AND WEED SEEDS SHALLD E FERNITTED UP 10 ONE FRECENT OF THE GROSS WEIGHT OF EACH VALREETY OF SEED, ALL SEED SUPPLED SHALL BE PACKED IN APPROVED CONTAINERS BEARING THE MANUFACTURER'S NAME AND ANALYSIS OF CONTENTS. THE FOLL OWING MATERIALS AND APPLICATION RATES SHALL BE REQUIRED FOR PERMANENT SEEDING. LAWN

LAWN

CREEPING RED RESCUE:

CREETING RED RESCUE:

CREETING RED RESCUE:

CREETING RED RESCUE:

CO.57#/1000 SF

D.57#/1000 SF

CO.57#/1000 SF

LOAM SHALL BE FREE OF GRASSES. ROOTS, LARGE STONE AND NORGANC

DEBRIS, PLACE LOAM AT SX NCHES MENUM DEPTH OVER ALL DISTURBED AREAS,
FINAL GRADING OF ALL LAWN AREAS TO BE AFFROVED BY LANDSCAPE ARCHITECT

BEFORE SEEDING.

BEFORE SEEDING.

LIFE: LIME SHALL BE AGRICULTURAL GROUND LIMESTONE AND APPLIED AS PER RECOMMENDATION OF A STATE COMMERCIAL SOIL TESTING LABORATORY.

FERTILIZER: FERTILIZER: SHALL BE 10-20-20 CLASSFICATION AND APPLIED AS PER RECOMMENDATION OF A STATE COMMENCIAL SOIL TESTING LABORATORY.

MULCH: MULCH SHALL CONSIST OF HAY OR STRAW MULCH: MULCH SHALL BE SPEED EVENLY AT A RATE OF TWO AND ONE HALF TONS PER ACRE OVER ALL SEEDING, AFTER APPLICATION, THE MULCH SHALL BE THORNOLITY WETTED. IN STEEP AREAS C >3rt SLOPES). THE MULCH SHALL BE HILD IN PLACE BY THE USE OF JUTE ROSSION CONTROL NETTING OR APPROVED ALTERNATIVE NETTING MATERIAL. NOTE: ALL EXPOSED SOIL MUST BE COVERED REGARDLESS OF MULCHING RATES SPECIFIED. NOTE: AN EROSSION CONTROL BETAND MUST BE HALL BE HELD IN PLACE BY THE USE OF CHIEF OR SOIL MUST BE COVERED REGARDLESS OF MULCHING RATES SPECIFIED. NOTE: AN EROSSION CONTROL BEAMET SHALL BE PLACED IN ALL NEWLY CREATED OR DISTRIBED DITCHES.

THE CONTRACTOR SHALL MANTAN THE SEEDED AND MULCHED AREAS UNTIL
FINAL ACCEPTANCE OF THE WORK, MANTENANCE SHALL CONSIST OF PROVIDING
FROPER WATERING, PROTECTION ACAINST TRAFFIC AND REPARENG ANY AREAS
DAMAGED DUE TO WIND, WATER RESOLON, FRE OR OTHER CAUSES, SUCH
DAMAGED AREAS SHALL BE REPARED TO RE-ESTABLISH THE CONDITION AND GRADE
OF THE SOL PRIOR TO SEEDING AND SHALL THEN BE REFERTILIZED, RESEEDED AND
REMULCHED.

NETICIONED.

WHITER CONSTRUCTION

THE WRITER CONSTRUCTION PERIOD IS FRON NOVEMBER 1 THROUGH AFRIL 15.

WHITER EXCAVATION AND EARTHWORK SHALL BE COMPLETED SUCH THAT NO MORE THAN 1 ACRE OF THE SITE IS WITHOUT STABILIZATION AT ANY ONE THE.

LIMIT THE EXPOSED AREA TO THOSE AREAS IN WHICH WORK IS EXPECTED TO BE UNDERTRIKEN DURNG THE PROCEEDING 15 DAYS AND THAT CAN BE MILCHED IN ONE DAY FRIOR TO ANY SNOW EVENT. HAY AND STRAW MILCH RATE SHALL BE A MINIMUM OF 150 LBS-1/LOOD 5.F. (2) TONS-ACRED AND SHALL BE PROPERLY ANCHORED. THE CONTRACTOR SHALL INSTALL ANY ADDED MEASURES WHICH MAY BE NECESSARY TO CONTROL EROSION/SEDWENTATION FROM THE SITE. DEFENDENT LIPON THE ACTUAL SITE AND WEATHER CONDITIONS, CONTRULATION OF EARTHWORK OPERATIONS ON ADDITIONAL AREAS SHALL NOT BEGIN LIMIT. THE EXPOSED SOIL SURFACE ON THE AREA BERG WORKED HAS BEEN STABILIZED. IN ORDER TO HYMMELE AREAS WITHOUT EROSION CONTROL PROTECTION.

MYMTZE AREAS WITHOU EXCISION CONTROL FROTEOTION.

E. CONSTRUCTION SEQUENCE
THE CENTRAL SEQUENCE OF WORK SHALL BE AS FOLLOWS:

1. NSTALL EROSION CONTROL DEVICES, CSLT FENCE, STABLIZED CONSTRUCTION ENTRANCE AND OR SEDMENT BARRERS.

2. TEMPORARLY STABLIZE DISTURBED AREAS BY MULCHING ALL EXPOSED SOL. WITHIN 15 DAYS OF INTIAL INSTURBANCE.

3. NSTALL STORMWATER SYSTEM.

4. COMPILETE SITE CONSTRUCTION WORK


5. CONSTRUCT PAYED ACCESS AND PAINING AREA

6. NSTALL PERHAMENT VEGETATION ON ALL EXPOSED AREAS WITHIN 15 DAYS OF FINAL GRADING.

7. PERFORM CONTINUING MANTENANCE ON ALL EROSION AND SEDMENTATION CONTROL DEVICES AND HASSERES.

CONTROL DEVOCES AND MEASURES.

F. SITE NSPECTION + MANTENANCE
WEEKLY INSPECTIONS, AS WELL AS ROUTINE INSPECTIONS FOLLOWING RANFALLS
OF 1/2" OVER A CONSECUTIVE 24-HOUR PERIOD, SHALL BE CONDUCTED BY THE
SITE CONTRACTOR OF ALL TEMPORARY AND PERMANENT EROSION CONTROL
DEVICES UNTIL FINAL ACCEPTANCE OF THE PROJECT, NECESSARY REPARS SHALL
BE HADE TO CORRECT UNDERTWANG OR DETERORATION, FINAL ACCEPTANCE SHALL
NCLIDE A SITE INSPECTION TO VERRY THE STABILITY OF ALL DISTURBED AREAS
AND SLOPES, UNTIL FINAL INSPECTION ALL EROSION AND SEDIMENTATION CONTROL
MEASURES SHALL IMMEDIATELY BE CLEANED, AND REPARED BY THE SITE
CONTRACTOR AFTER STORM EVENTS, DISPOSAL OF ALL TEMPORARY EROSION
CONTROL DEVICES SHALL BE THE RESPONSBUTTY OF THE SITE CONTRACTOR.
CONTINUED TEMPORARY MANTENANCE AND LONG TEMP REVOYSIONS FOR
PERHANENT MANTENANCE OF ALL EROSION AND SEDIMENTATION CONTROL FACILITIES
AFTER ACCEPTANCE OF THE PROJECT SHALL BE THE RESPONSBUTTY OF
BACK COVE COMPANY, OR ASSIGNS.

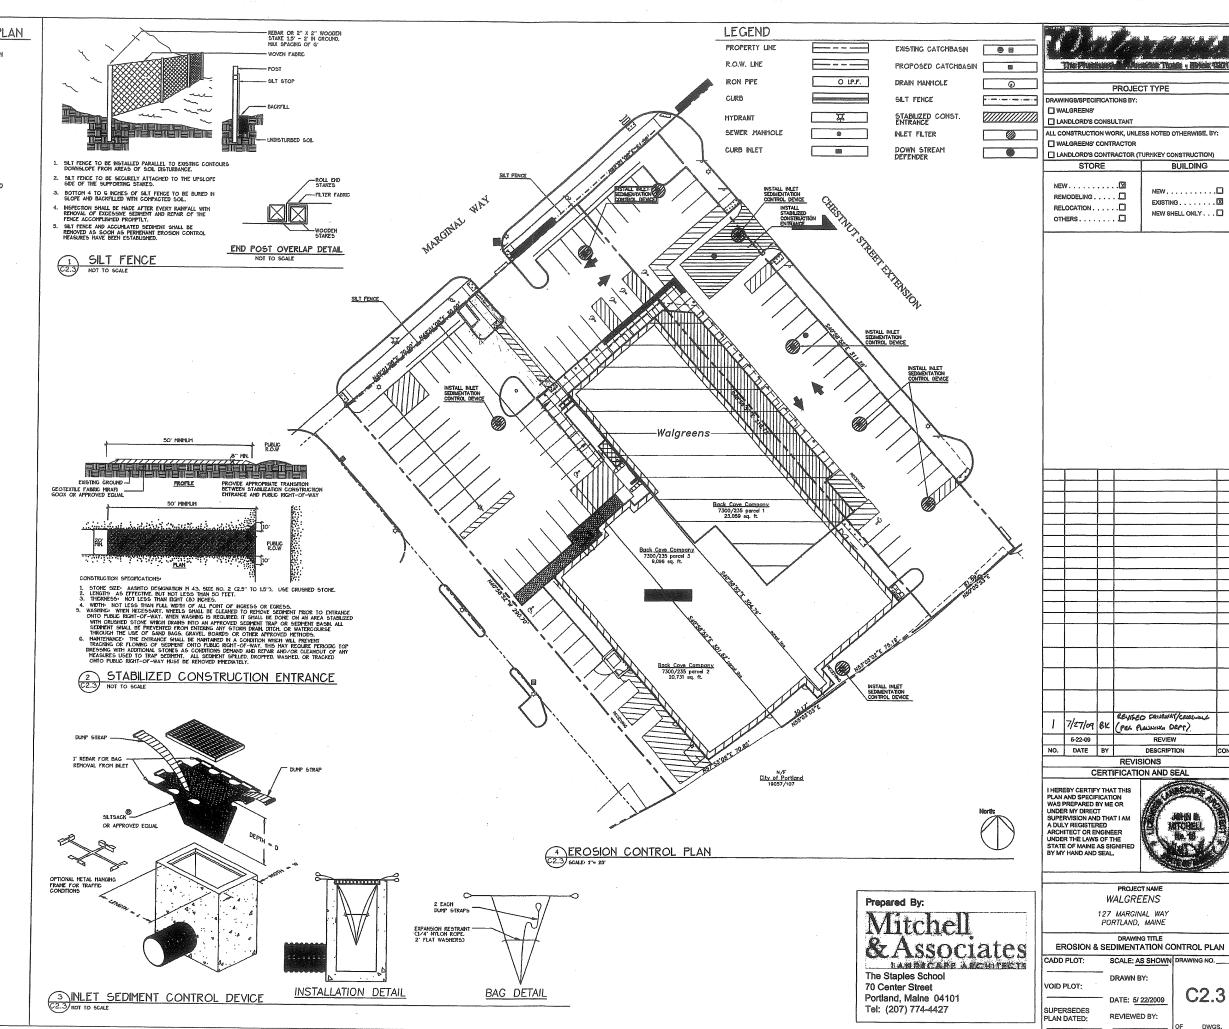

PROJECT TYPE

BUILDING

NEW.........

NEW SHELL ONLY . . . .

REVISED DRIVEWAY/COOSLING

DESCRIPTION

CONST

(PER PLANING DEPT)

REVISIONS

PROJECT NAME WALGREENS

DRAWING TITLE


DATE: 5/ 22/2009


REVIEWED BY:

SCALE: AS SHOWN DRAWING NO.


C2.3

DWGS.

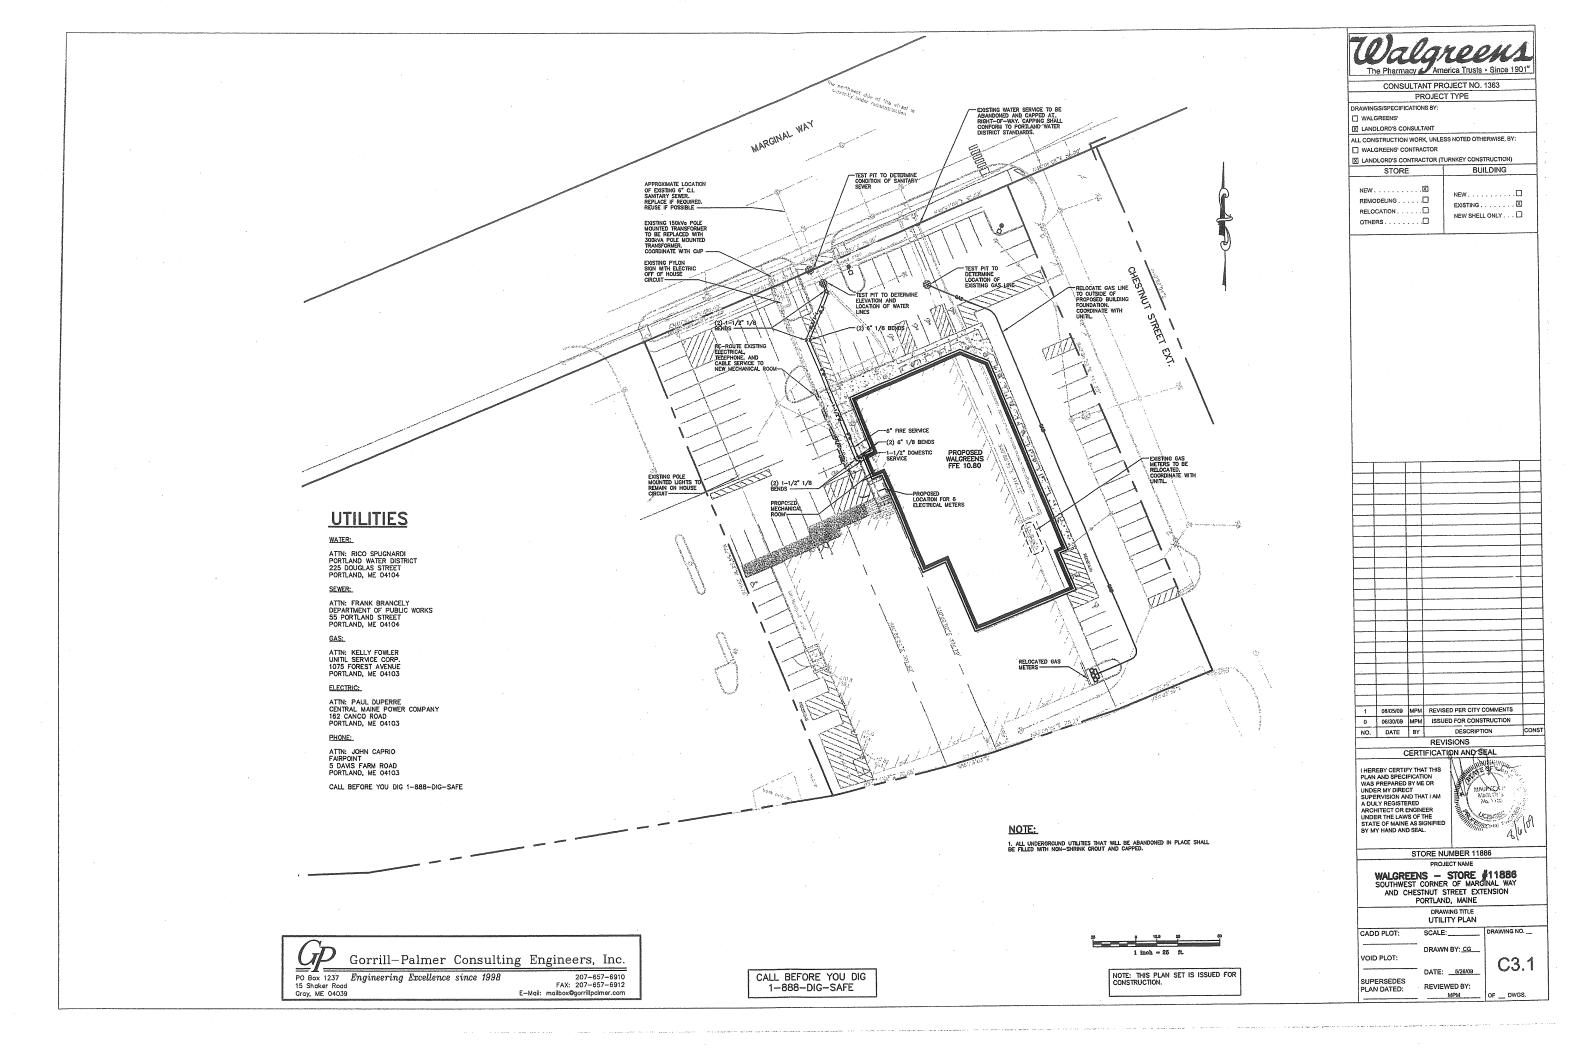

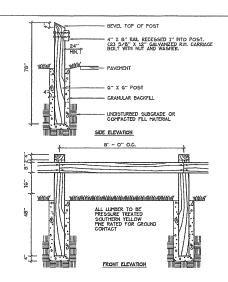



### WOOD GUARD RAIL - MATCH EXISTING

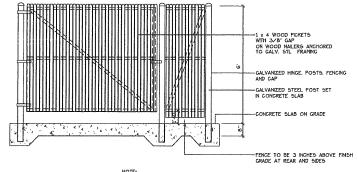

DUMPSTER ENCLOSURE TO BE 8' x 13-6"

### 2 DUMPSTER ENCLOSURE AND SLAB

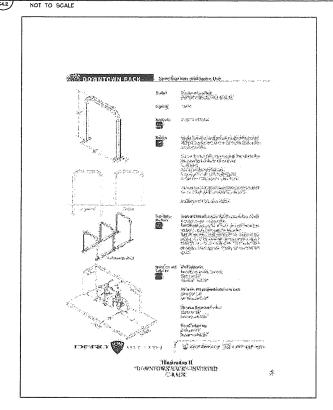

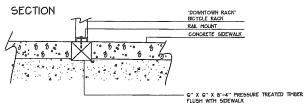

3 BICYCLE RACK- CITY OF PORTLAND



5-22-09 REVIEW
DATE BY DESCRIPTION CO
REVISIONS
CERTIFICATION AND SEAL

Prepared By:
Mitchell
& Associates

The Staples School 70 Center Street Portland, Maine 04101 Tel: (207) 774-4427 PROJECT NAME WALGREENS

127 MARGINAL WAY PORTLAND, MAINE

I HEREBY CERTIFY THAT THIS PLAN AND SPECIFICATION WAS PREPARED BY ME OR UNDER MY DIRECT SUPERVISION AND THAT I AM A DULY REGISTERED ARCHITECT OR ENGINEER UNDER THE LAWS OF THE STATE OF MAINE AS SIGNIFIED BY MY HAND AND SEAL.

DRAWING TITLE
CIVIL SECTIONS AND DETAILS
CADD PLOT: SCALE: AS SHOWN DRAWING NO.

VOID PLOT:

DATE: 5/ 22/ 2008
SUPERSEDES 2008
PLAN DATED: PEVIEWED BY:

5/ 22/ 2009 VED BY:

ANDSCAPE

JOHN B. MITCHELL No. 15

F \_\_\_ DWGS.

1. THE BEARING SURFACE OF THE THRUST BLOCK SHALL BE THE SURFACE AREA OF THE THRUST BLOCK WHICH IS CAST AGAINST THE TRENCH WALL. THE BEARING SURFACE SHALL NOT EXCEED THE FOLLOWING LOADINGS:

IN-SITU CONDITION ALLOWABLE BEDROCK 3,000 psf SAND OR OUTWASH DEPOSITS 1.500 psf


OTHER SOILS 1,000 psf THE THRUST SHALL BE COMPUTED ON THE BASIS OF 150 psi x THE CROSS SECTIONAL AREA OF THE PIPE. FOR EXAMPLE, A THRUST BLOCK FOR A 1/4 BEND ON AN 8" WATER MAIN BEARING AGAINST CLAY WOULD REQUIRE A BEARING SUFFACE OF 7.5 s.f.

150 psi x 50 sq. in. = 7.5 s.f. 1,000 psf


2. INSTALL POLY BARRIER BETWEEN PIPE AND ALL THRUST BLOCKS.

3. ANY WORK RELATED TO WATER PIPING OR DETAILS SHALL BE IN ACCORDANCE WITH THE BELFAST WATER DISTRICT SPECIFICATIONS.

### THRUST BLOCK NOTES

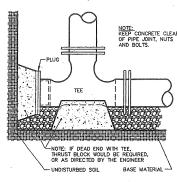


### STANDARD TEE BLOCKING

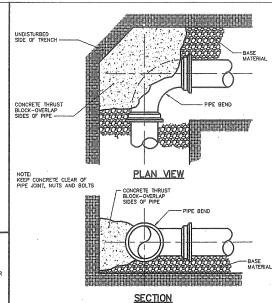

		RETAINER GLAND SCHEDULE
1/4 BEND	90.	USE POURED IN-PLACE THRUST BLOCK WITH RETAINE
1/8 BEND	45	THRUST BLOCK WITH RETAINERS
1/16 BEND	22 1/2*	THRUST BLOCK
1/32 BEND	11 1/4	THRUST BLOCK

### THRUST BLOCK PLACEMENT ON BENDS NOT TO SCALE

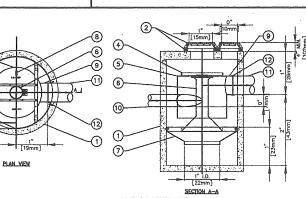

	PARTS LIST				
ITEM	SIZE		DESCRIPTION		
1	72 ln.	1829mm	I.D. CONCRETE MANHOLE		
2	24 in.	610mm	MANHOLE LID, FRAME & COVER		
	18 in.	457mm	MANHOLE LID, FRAME & COVER		
3			LEDGER ANGLE (TYP.)		
4			SUPPORT FRAME		
5			DIP PLATE		
6			CENTER SHAFT & CONE		
7			BENCHING SKIRT		
8			FLOATABLES LID W/ VENT		
9	18 ln.	457mm	OVERFLOW PIPE STUB		
10	12 in.	305mm	TANGENTIAL INLET PIPE (BY OTHERS)		
11	18 in.	457mm	OVERFLOW PIPE (BY OTHERS)		
12			PIPE COUPLING (BY OTHERS)		

EQUIPMENT PERFORMANCE

. <u>Performance objectives</u>: The unit shall be capable of treating the peak flow rate listed below.

2. Peak treatment flow: 8.0 cfs [227 |/s]

3. Depth of flow in overflow pipe at 8.0 cfs: 11 in. [280mm]


4. Estimeted headloss\* at 8.0 cfs: 39 in. [991mm]

5. Sediment storage copacity: 2.10 Cu. yd. [1.61 cu.m.]


6. Oll storage copacity: 230 Gol. [871 litera]

7. Sediment shall be storad in a zone that is sloated from the moin flow path and protected from reintrainment by a benching skirt.


### 6'Ø DOWNSTREAM DEFENDER

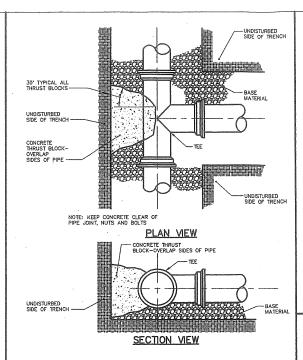

### THRUST BLOCK PLACEMENT ON TEES

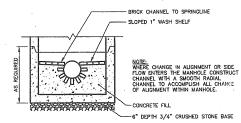

### SANITARY SEWER MANHOLE BRICK CHANNEL INSTALLATION

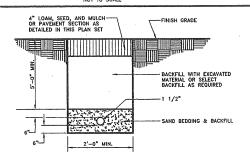



1. REFER TO TRENCH SECTION THIS SHEET FOR 6" FIRE SERVICE.


2. ALL WATER SYSTEMS SHALL BE INSTALLED IN ACCORDANCE WITH PORTLAND WATER DISTRICT STANDARDS. A PORTLAND WATER DISTRICT REPRESENTATIVE MUST INSPECT INSTALLATION PRIOR TO BACKFILL, PORTLAND WATER DISTRICT SHALL BE NOTIFIED A WINIMUM AT 5 WORKING DAYS PRIOR TO CONSTRUCTION.

### DOMESTIC WATER SERVICE TRENCH SECTION

Gorrill-Palmer Consulting Engineers, Inc. PO Box 1237 Engineering Excellence since 1998 E-Mail: mailbox@gorrillpalmer.com Grav. ME 04039

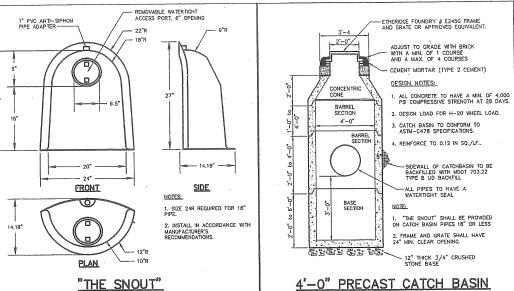

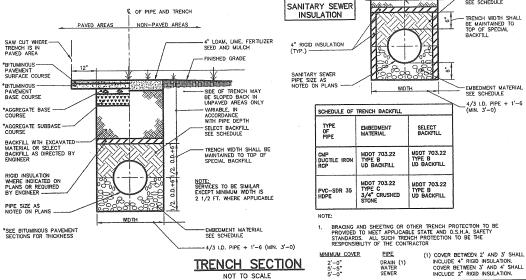

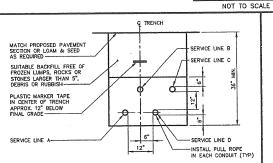


NOT TO SCALE

	CO	NDUIT TYPE	SCHEDULE	
SERVICE	CONDUIT SIZE	GRASS & PAVED AREAS	UTILITY	REMARKS
A	2-5"	SCHEDULE 40 PVC ELECTRICAL GRADE	PRIMARY POWER	SEE NOTE
В	2-4"	SCHEDULE 40	TELEPHONE	SEE NOTE
С	2-4"	SCHEDULE 40	CABLE	SEE NOTE
D	2-4"	SCHEDULE 40 PVC ELECTRICAL GRADE	SPARES	SEE NOTE

NOTE: ONE CONDUIT CAPPED FOR SPARE, PROVIDE GALVANIZED STEEL LONG SWEEP AT RISER POLE AND EXTEND GALVANIZED CONDUIT TO 10" ABOVE GRADE AT POLE WITH STAND-OFF BRACKETS.

UTILITY TRENCH - PRIMARY AND SECONDARY POWER. TELEPHONE. AND CABLE

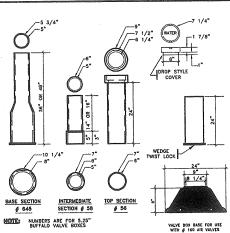

NOT TO SCALE

VALVE BOXES

NOTE: THIS PLAN SET IS ISSUED FOR CONSTRUCTION.

SEE NOTE 3 IN THRUST BLOCK NOTES DETAIL

### CONSULTANT PROJECT NO. 1363 RAWINGS/SPECIFICATIONS BY ☐ WALGREENS ALL CONSTRUCTION WORK, UNLESS NOTED OTHERWISE, BY ☐ WALGREENS' CONTRACTOR □ LANDLORD'S CONTRACTOR (TURNKEY CONSTRUCTION) STORE REMODELING . . . . . . EXISTING . . . . . . . . RELOCATION . . . . . . NEW SHELL ONLY . . . $\Box$ OTHERS.......

06/30/09 MPM ISSUED FOR CONSTRUCTION NO. DATE BY DESCRIPTION REVISIONS CERTIFICATION AND SHALL I HEREBY CERTIFY THAT THIS PLAN AND SPECIFICATION WAS PREPARED BY ME OR UNDER MY DIRECT SUPERVISION AND THAT I AM A DULY REGISTERED ARCHITECT OR ENGINEER UNDER THE LAWS OF THE STATE OF MAINE AS SIGNIFIED Y MY HAND AND SEAL. STORE NUMBER 11886

WALGREENS - STORE #11886
SOUTHWEST CORNER OF MARGINAL WAY
AND CHESTNUT STREET EXTENSION
PORTLAND, MAINE

UTILITY AND DRAINAGE DETAILS


SCALE: CADD PLOT DRAWN BY: CG

SUPERSEDES PLAN DATED:

VOID PLOT

DATE: \_\_5/26/09 REVIEWED BY: MPM

C4.3

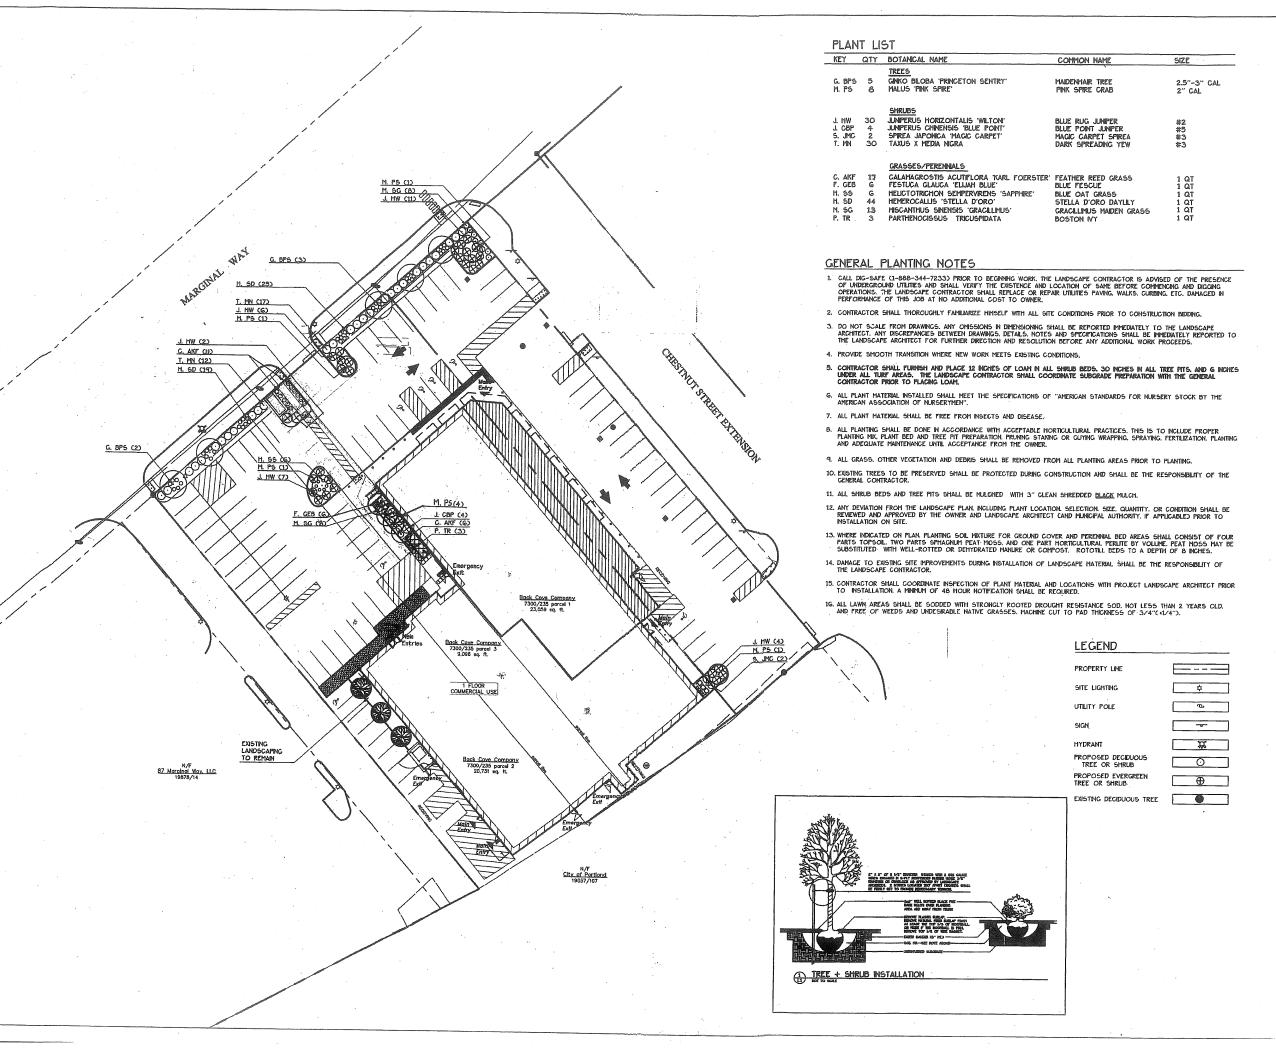




		-	~~~			-0
2041	INGS/SPEC		PROJEC	OT TYPE		- Marie and American
	ALGREENS'		HUNG BT:			
	NOLORD'S		ULTANT			
<b>PARTY AND DESCRIPTION</b>			NAME OF TAXABLE PARTY.	ESS NOTED	OTHERWISE, B	Y:
	ALGREENS'					
	TAXABLE DAY		RACTOR (	FURNKEY C	ONSTRUCTION	
	STO	RE			BUILDING	***************************************
NE	w		20			_
RE	MODELING .		. 🗖			
	LOCATION .				HELL ONLY	
OTI	HERS		. 🗖	, ALVO	I I I I I I I I I I I I I I I I I I I	
quantificani	verselle:	**********				
	T :	γ	1			т-
	<u> </u>	⊢	-			╀
	-	╁				+
						T
		$\vdash$	1	•	*****	T
					· · · · · · · · · · · · · · · · · · ·	T
		<u> </u>	ļ			_
	<b> </b>	┡	<b>_</b>			├-
	<del> </del>	-	├			╀
		┢	<del> </del>			$\vdash$
			<del> </del>			+
						+
			l			
						Г
		<u> </u>			······································	上
						1
		-				⊬
		ĺ	1			1
	<del> </del>	$\vdash$	ADDEN P	TANTIN'S	AT MILI	+-
E .	7-27-09	BE	ENTRY	ON HE	AT M.W. IT SIDE OF JING DEPT)	
-	5-22-09	-	Brng (	REVIE	W	$\vdash$
Ю.	DATE	BY		DESCRIP	TION	CON
			REVIS			
		ERT	IFICATION	ON AND	SEAL	
			i			
				ŀ		
				ŀ		
			J	ŀ		
			1	k .		
			PROJEC	T NAME		
		И	ALGRE			
			MARGIN			
			MARGIN. RTLAND,			
		L	DRAWIN ANDSCA	G TITLE PE PLAN	ı	
ADD	PLOT:		SCALE: 1		DRAWING NO.	
	. 501.		-			
י חורי	PLOT:	Ε	DRAWN B	Y:		
-,01			MTF	2001 0000	L1	
		£	ATE: 5/	221 2009	, Em 8	

SUPERSEDES PLAN DATED:

REVIEWED BY:

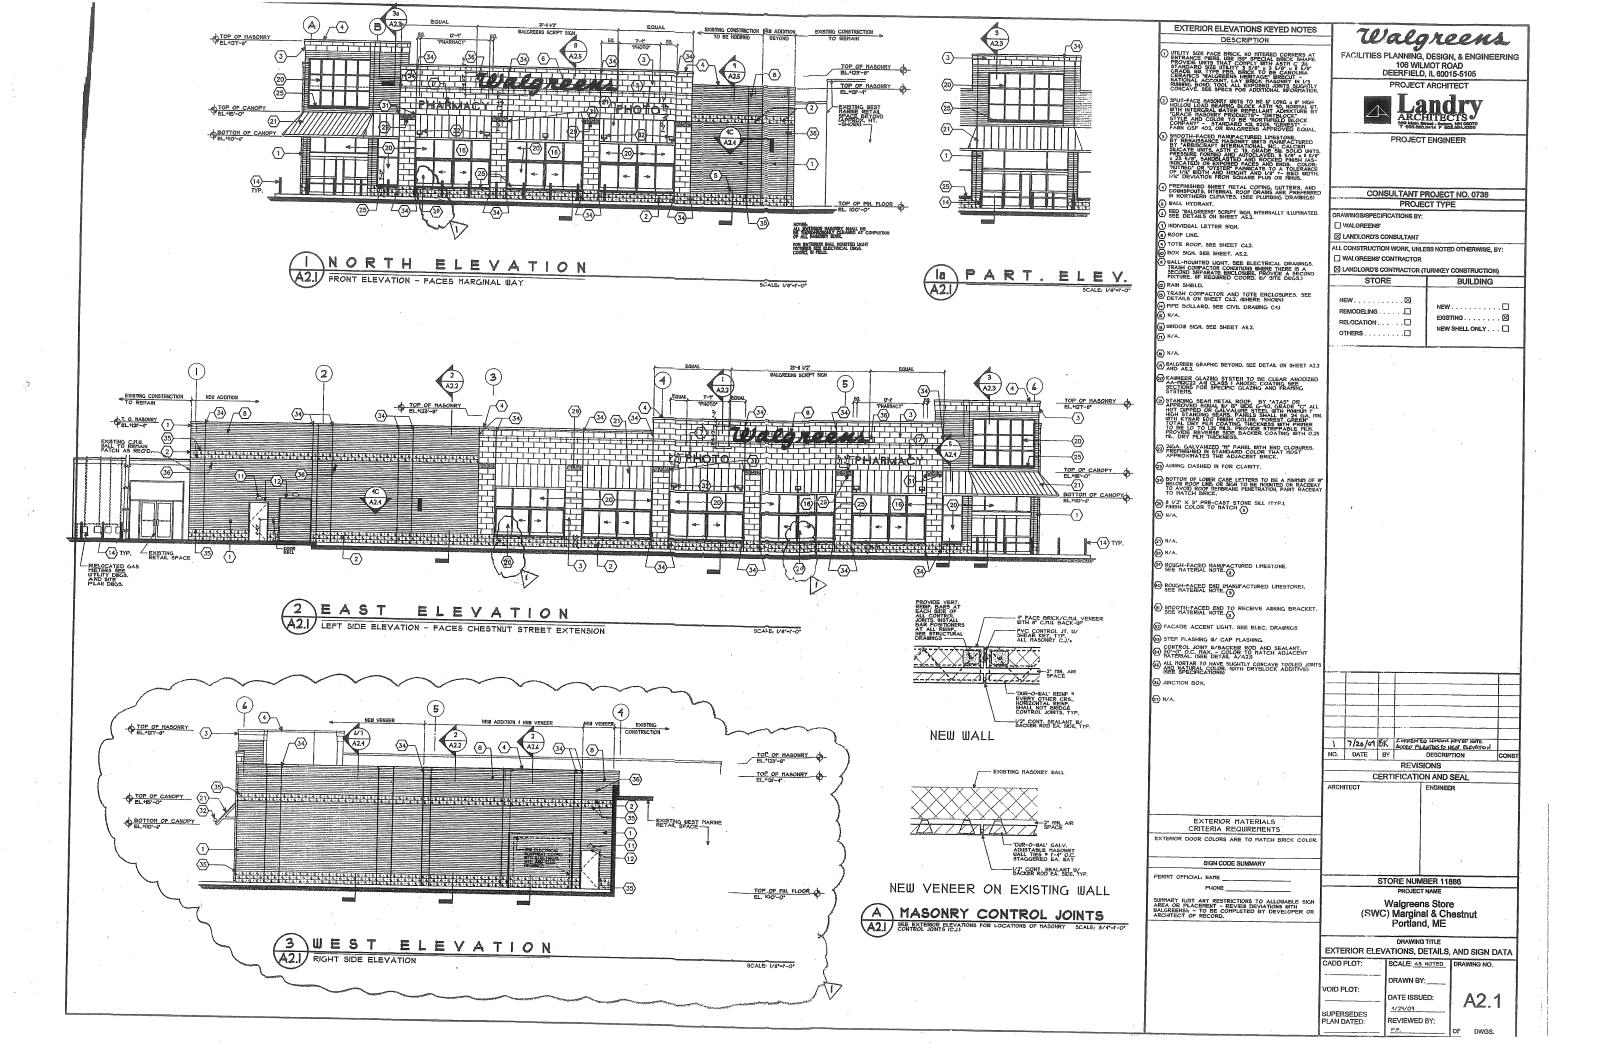

### SITE LEGEND

				DITE LL.	ODI 1D	
PROP LINE BEARING	S 23 -02'-00" E 179.26'	NEW CONTOUR	12	FRENCH DRAIN		NEW PAVED AREA
EASEMENT LINE		EXISTING CONTOUR	12	WATER SHUT-OFF VALVE	8	OVERHEAD ELEC LII
EXIST, EDGE OF VEGETATION	~ ~~~~	BENCH MARK	€L. 0.00	WATER SHUT-OFF VALVE	•	OVERHEAD TELEPH
ENOT. EDGE OF TEGETATION		SOIL BORING LOCATION	₱-302	TRANSFORMER PAD		OVERHEAD CATV
SILT/HAYBALE BARRIER		CONCRETE MONUMENT FOUND				UNDERGROUND ELE
SWALE	3-3-	IRON PIPE FOUND	•	DECIDUOUS TREE	(+)	UNDERGROUNG TE
CULVERT		UTILITY POLE	ø		-W//	UNDERGROUND CA
EXISTING GRANITE CURBING		EXISTING MANHOLE	0	CONIFEROUS TREE		STORM SEWER SANITARY SEWER
EXISTING GRANITE CURBING	=======	NEW MANHOLE	•			HOUSE SANITARY
TO BE REMOVED  NEW GRANITE CURBING		HYDRANT	- <b>ó</b> -	NEW CONCRETE SURFACE		KITCHEN SANITARY
VERTICAL GRANITE CURBING	YGC	EXISTING CATCH BASIN	0		* . * . * . * .	WATER SERVICE
SLOPED GRANITE CURBING	5 <i>G</i> C	NEW CATCH BASIN	•	NEW PLANTING BED W/ 4" SHREDDED BLACK BARK MULC	H	
FLUSH GRANITE CURBING	F <i>G</i> C	CATCH BASIN [SOIL DISPERSION TYPE]		ROUNDED STONE BED	44444444	
EMORNIC CROSS EL DIABONI	88-6			ROUNDED STONE DED	44444444	
EXISTING SPOT ELEVATION	12.5'					
NEW SPOT ELEVATION			SITE CO	<b>NSTRUCTION</b> A	AND EROSIC	ON CONTR

NEW I AVED ANDA	15.740 (A. 62 (A. 62 (A. 64 (A	LEVIMET	EK I DN. DRAIN	
		UNDERDE	RAIN	UD
OVERHEAD ELEC LINE	OHE	UNDERG	D. ELECTRIC POWER	— е —
OVERHEAD TELEPHONE	OTEL	IN 1" PVC	CONDUIT	
OVERHEAD CATV	OCATY	SANITAR	RY SEWER FORCE MAIN	FM
UNDERGROUND ELEC.	UE		(E)	EXISTING COMPONENT TO REM
UNDERGROUNG TEL.	UTEL		(-)	
UNDERGROUND CATY	UCATY		(R)	COMPONENT TO BE REMOVED
STORM SEWER	5D		(A)D	NEW COMPONENT OR DEVICE
SANITARY SEWER	55		(N)	NEW COMPONENT OR DEVICE
HOUSE SANITARY SEWER	H55			
KITCHEN SANITARY SEWER	KSS			
WATER SERVICE	w			

	OF DAVID DAVID LEASURE # 11725 FOR APPROVALS ONLY
L	FOR APPROVALS ONLY



INC.

ASSOCIATES I PH. (207) 797-8661 FAX (207)

### ROL NOTES

- THESE DRAWINGS DEPICT REQUIRED SOIL EROSION CONTROL MEASURES
  THE CONTRACTOR IS RESPONSIBLE FOR MAINTAINING THE CONSTRUCTION
  SITE IN SUCH A MANNER THAT:

  - A. SOIL ENGSION IS KEPT TO A MINIMUM
    B. NO CONSTRUCTION SEDIMENT LEAVES THE CONSTRUCTION SITE PROPER.
    C. ALL POSSIBLE MEASURES ARE REMOVED TO PREVENT SEDIMENT FROM
    ENTERING DRAINAGE COURSES AND WETLANDS EVEN BEYOND THE DETAILS
    SHOWN ON THESE DRAININGS.
- GENERAL CONTR. SHALL YERIFY LOCATIONS OF ALL UNDERGROUND UTILITIES BY CONTACTING "DIG-SAFE" (1-888-344-7233) PRIOR TO BEGINNING ANY EXCAVATION PROCEDURES.
- PROVIDE SILT FENCING AROUND ALL EARTH MOVING OR DISTURBANCE ACTIVITIES. PROVIDE SILT SACKS IN ALL ON AND OFF-SITE CATCH BASINS DURING EARTH MOVING PROCEDURES. SEE SITE PLAN FOR PROPOSED SILT FENCE LOCATIONS
- GENERAL CONTRACTOR SHALL OBTAIN ALL NECESSARY PERMITS PRIOR TO COMMENCING CONSTRUCTION.
- GENERAL CONTRACTOR SHALL BE RESPONSIBLE FOR OBTAINING AN EARTH MOVING PERMIT FROM THE CITY OF PORTLAND, MAINE
- SILTATION AND HAY BALE BARRIERS SHALL BE INSTALLED AROUND ANY EARTH MOVING OR DISTURBANCE ACTIVITY TO PREVENT MOVEMENT OF SILT INTO STREAMS, BROOKS, DRAINDER AND ROAD DITCHES, DETEXTION AND SEMIMENTATION PONDS, AND ON & OFF-SITE MUNICIPAL AND PRIVATE CATCH BASINS.
- GENERAL CONTRACTOR SHALL PROVIDE AND MAINTAIN ALL PEDESTRIAN AND VEHICULAR TRAFFIC CONTROL DEVICES DURING CONSTRUCTION, DELIVERIES, LOADING, AND ROAD OPENING PROCEDURES.
- NOTIFY ARCHITECT IMMEDIATELY IF FIELD CONDITIONS ENCOUNTERED DIFFER FROM THOSE SHOWN ON THESE DRAWINGS
- 10. PROVIDE SECONDARY PIPE SLEEVES OF SIMILAR MATERIAL WHERE PIPING, AND CONDUIT PASS THRU FOUNDATION WALLS AND SLABS.
- 11. GENERAL CONTRACTOR SHALL PERFORM ALL SITE WORK ACCORDING TO SECRETAL CONTROL ON STALL PERFORM ALL SILE WORK ACCORDING TO THE MRPA PERINT BY RULE STANDARDS AND THE STATE OF MAINE EROSION AND SEDIMENT CONTROL HANDBOOK FOR CONSTRUCTION: BEST MANAGEMENT PRACTICES - LATEST EDITION.

- PLANTING BEDS SHALL BE PREPARED WITH 4" SHREDDED BLACK BARK MULCH OVER LANDSCAPING FABRIC AND 12" MIN. FRUBLE LOAM PLANTING MIXTURE. SEE PROJECT MANUAL AND LANDSCAPING PLAN.
- 15. USE PERMANENT SEED MIXTURES AND RATES BETWEEN MAY 15 AND SEPTEMBER 30.
- USE TEMPORARY SEED MIXTURES FOR PERIODS LESS THAN 12 MONTHS. IF USING TEMPORARY SEED MIXTURES AND RATES BETWEEN 10rl AND 5/14, RE-SEED WITH PERMANENT SEED MIXTURES AFTER 5/15.
- 17. SEED MIXTURES:

PERMANENT SEED MIXTURE	APPLICATION RATE	
KENTUCKY BLUEGRASS	20 LBS, PER ACRE	
CREEPING RED FESCUE	20 LBS. PER ACRE	
PERENNIAL RYEGRASS	5 LBS. PER ACRE	
TOTAL SEED RATE	45 LBS. PER ACRE	
TEMPORARY SEED MIXTURE	APPLICATION RATE	
OATS	80 LBS. PER ACRE	4/01 - 5/14
ANNUAL RYEGRASS	40 LBS. PER ACRE	
SUDANGRASS	40 LBS. PER ACRE	5/15 - 8/14
ANNUAL RYEGRASS	80 LBS. PER ACRE	5/15 - 9/14
WINTER RYE	112 LBS. PER ACRE	9/15 - 9/30
WINTER RYE (PROTECT WITH MULH COVER)	112 LBS. PER ACRE	10/01 - 3/3

18. LIME AND FERTILIZER:

LIMING AND FERTILIZER RATES SHALL BE BASED ON FIELD SOIL TESTING OF ON-SITE TOPSOILS BY A CERTIFIED LABORATORY. SUBMIT TEST RESULTS TO ARCHITECT FOR DIRECTION.

19. MULCH:

STRAW OR HAY (ANCHORED) STRAW OR HAY (ANCHORED) SHREDDED OR CHOPPED JUTE MESH EXCELSIOR MAT

20. MULCH ANCHORING:

LIQUID ASPHALT WOOD CELLULOSE FIBER CHEMICAL TACK PEG & TWINE MULCH NETTING

INTSALL NEW STRAW MULCH ON ALL NEW SEEDING TO PREVENT SOIL COMPACTION, LIMIT RUNOFF, CONTROL WEEDS AND CONSERVE MOISTURE.

THE GENERAL CONTRACTOR SHALL NOT UNLOAD OR STORE HEAVY EQUIPMENT OR BUILDING SUPPLIES ON EXISTING PAYED SURFACES. ALL DAMAGE TO THE OWNERS OR ADJACENT PROPERTY SHALL BE IMMEDIATELY REPAIRED AND RETURNED TO THE ORIGINAL CONDITION AS DIRECTED BY THE ARCHITECT.

23. WASH CONSTRUCTION VEHICLE WHEELS TO REMOVE SEDIMENT PRIOR TO ENTRANCE ONTO PUBLIC ROADS, PERFORM WASHING ON AN AREA STABILIZED WITH CRUSHED STONE WHICH DRIVEN INTO AN A PROFOVE SEDIMENT THEY OR SEDIMENT BASIN. PREVENT ALL SEDIMENT FROM BUTTERING ANY STORM DRAIN, DITCH, OR WATERCOMES THROUGH USE OF SAND BASIS, GRAVEL, BOARDS, OR OTHER APPROVED METHODS. SEE SITE PLAN FOR PROPOSED LOCATION.

MAINTAIN THE CONSTRUCTION ENTRANCE IN A CONDITION WHICH WILL PREVENT TRACKING OF IL OWING OF SEDWENT ONTO PUBLIC RIGHTS OF WAY. THIS MAY REQUIRE FERDING TO PREVENT ONTO PUBLIC RIGHTS OF WAY. THIS MAY REQUIRE THE PROPOSE OF THE PROP

- STONE SIZE: ANSHTO DESIGNATION M.43, SIZE: (2-1/2"-1-1/2") USE CRUINED STONE
   LEINCH: A SEPECTIVE BUT NOT LESS THAN 50 FT.
   HIGKNESS: NOT LESS THAN 6"
   WIDTH: NOT LESS THAN 10 FT.
   HIGKNESS: NOT LESS THAN 10 FT.
   HIGKNESS: NOT LESS THAN 10 FT.
   WIDTH: NOT LESS TH

- 25. ALL EROSION CONTROL MEASURES SHALL BE CONSTRUCTED AND MAINTAINED IN ACCORDANCE WITH THE MAINE EROSION AND SEDIMENT CONTROL HANDBOOK FOR CONSTRUCTION-BEST MANAGEMENT PRACTICES PUBLISHED BY THE CUMBERLAND COUNTY SOIL AND WATER CONSERVATION DISTRICT AND THE DEPARTMENT OF ENVIRONMENTAL PROTECTION - MARCH 1991; REV. 2007
- 28. THE CONTRACTOR IS RESPONSIBLE FOR ALL FINES RESULTING FROM EROSION OR SEDIMENTATION FROM THE SITE ONTO SURROUNDING PROPERTIES, WATERBOOIDES, OR WETLANDS AS A RESULT OF CONSTRUCTION ACTIVITY AT THIS PROJECT SITE.
- 28. INSPECT SOIL EROSION MEASURES WEEKLY AND DIRECTLY AFTER STORM STORM EVENTS WITH RAINFALL GREATER THAN 1/2 INCH. MAKE ALL REPAIRS TO FACILITIES AND SEDIMENT CONTROL STRUCTURES AS SOON AS POSSIBLE, BUT NO LONGER THAN 2 DAYS. CLEAN AND RESET FILTER BERMS, SILT FENCES, AND STONE CHECK DAMS, WHICH ACCUMULATE SEDIMENT AND DEBRIS.
- 29. PROTECT AND STABILIZE, OR RECONSTRUCT ALL AREAS NOT SCHEDULED FOR
- 30. TEMPORARILY SEED WITHIN 7 DAYS AND AREA WHICH WILL BE LEFT DISTURBED AND UNWORKED FOR MORE THAN 14 DAYS WITH A TEMPORARY SEED MIX LISTED BELOW. DO NOT USE PERMANENT SEED MIX AFTER SEPTEMBER 15.
- 31. MULCH ALL AREAS SEEDED SO THAT SOIL IS NOT VISIBLE THROUGH THE MULCH RECARDLESS OF THE APPLICATION NATE. DURING THE GROWING SEASON (APPL. IS SET 20) JUSK MISK (ON MULCH AND FAITHING ON:

   STORES STEEPER THAN 15%, WINCE STEEPER THAN 15%, WI
- 32. BETWEEN OCTOBER 1 AND APRIL 14, USE MATS (OR MULCH NETTING) ON:
- INSTALL MATS IN ACCORDANCE WITH MANUFACTURER'S WRITTEN INSTRUCTIONS.
- INSTALL EROSION CONTROL MESH IN ACCORDANCE WITH MANUFACTURER'S WRITTEN INSTRUCTIONS, MESH TO BE NORTH AMERICAN GREEN PRODUCT C125BN OR APPROVED EQUAL. SEE SITE PLAN FOR REQUIRD LOCATIONS.
- 34. FOLLOW SILT FENCE MANUFACTURER'S WRITTEN INSTRUCTIONS FOR INSTALLATION OF SILT FENCE. SEQUIE ENTIRE BOTTOM OF FENCE TO EARTH EITHER BY BIRYING BOTTOM OF FENCE IN A TRENCH OR BERMING WITH SOIL OR CHIPPED GRUBBINGS. SEE SILT FENCE DETAILS.
- 35. PROVIDE AND MAINTAIN DUST CONTROL MEASURES AS NECESSARY TO PREVENT DUST FROM BLOWING ONTO NEGABLIORING PROPERTY OR BEING TRACKED ONTO ADJACENT AND ADJACENT ADJACENT ADJACENT ADJACENT AND ADJACENT

### **GENERAL NOTES**


- THESE SITE DRAINGS ARE DERIVED FROM A PLAN ENTITLED "BOUNDARY AND TOPOGRAPHIC SURVEY" PREPARED BY OWEN HASKELL, INC., 16 CASCO STREET PORTLAND, MAINE 04101, DATED JANUARY 03, 2006.
- 2. THE LOCATIONS OF UNDERGROUND UTILITIES AS SHOWN HEREON ARE BASED ON ABOVEGROUND STRUCTURES, RECORD DRAWNINGS, AND MARKS PROVIDED TO THE SURVEYOR, LOCATIONS OF UNDERGROUND UTILITIES AND STRUCTURES MY VARY FROM THE LOCATIONS DEPICTED HEREON, UNLESS SPECIFICALLY NOTED, NO EXCAVATIONS WERE MADE DURING THE PROCESS OF THE SURVEY, UNDER MAINE LAW, TOIG SAFE' MUST BE NOTIFIED PRIOR TO ANY EXCAVATION.
- OWNER OF RECORD IS THE CITY OF PORTLAND, MAINE, 389 CONGRESS STREET, PORTLAND, MAINE 04101.
- BENCHMARKS ARE PK NAIL IN UP#13 ON THE WESTERN AVENUE SIDE OF MARGINAL WAY WITH AN ELEVATION OF 10.82 AND NORTHERN MOST BONNET BOLT ON FIRE HYDRANT ON EASTERN SIDE OF MARGINAL WAY WAY WITH AN ELEVATION OF 12.22.
- 5. TOPOGRAPHICAL ELEVATIONS ARE BASED ON NGVD 1929.
- THE CONTRACTOR SHALL BE RESPONSIBLE FOR NOTIFYING 'DIG SAFE'
  (1-80-344-723) AND LOCAL UTILITY COMPANIES AT LEAST 3
  BUSINESS DAYS, BUT NOT MORE THAN 30 CALENDAR DAYS,
  PRIOR TO THE COMMENCEMENT OF ANY EXCAVATION, AS IN
  ACCORDANCE WITH MANIE STATE LAW.
- THE CONTRACTOR SHALL BE SOLELY RESPONSIBLE FOR ALL MEANS, METHODS AND TECHNIQUES EMPLOYED TO PERFORM THE WORK SPECIFIED ON THESE DSIGN DRAWINGS.
- ALL WORK SHALL COMPLY WITH ALL LOCAL, STATE AND FEDERAL SAFETY REGULATIONS.
- ALL WORK SHALL BE PERFORMED IN STRICT CONFORMANCE WITH THE CITY OF PORTLAND, MAINE TECHNICAL DESIGN STANDARDS -LATEST EDITION AND THE CITY'S PUBLIC WORKS DEPARTMENT ALONG WITH THE RESPECTIVE UTILITY COMPANY'S REQUIREMENTS.
- 11. THE CONTRACTOR SHALL VERIFY LOCATIONS AND DEPTHS OF ALL UTILITIES WITH THE RESPECTIVE UTILITY COMPANY PRIOR TO THE COMMENCEMENT OF CONSTRUCTION. IF ANY DISCREPANCIES OR CONFLICTS ARE FOUND, THE CONTRACTOR SHALL NOTIFY
- 13. NO BLASTING WILL BE ALLOWED WITHIN 500 FT OF ANY UTILITY WITHOUT THE NOTIFICATION AND APPROVAL OF THE APPROPRIATE UTILITY COMPANY, NO LEODE BLASTING WILL BE PERMITTED WITHIN A UTILITY COMPANY SERBIENT UNTIL WITHITEN APPROVAL FROM THE UTILITY IS GIVEN.
- 14. ALL PAVEMENT CUTS SHALL BE SAW CUT TO RESULT IN CLEAN EDGES. A SHIPLAPPED JOINT SHALL BE PREPARED AS DETAILED ON THE SITE DRAWINGS. A TACK COAT SHALL
- THE CONTRACTOR SHALL BE RESPONSIBLE TO RECLAIM OR PROPERLY DISPOSE OF ALL REMOVED BITUMINOUS MATERIALS.
- 16. INLETS AND OUTLETS OF ALL CULVERTS SHALL BE RIP-RAPPED UNLESS OTHERWISE NOTED ON THE PLANS OR
- 17. CONDUIT SHALL BE PROVIDED FOR ALL ELECTRIC, TELEPHONE AND CATY CABLING IN ACCORDANCE WITH THE SPECIFICATIONS AND THE RESPECTIVE UTILITY COMPANY'S WRITTEN REQUIREME
- 18. THE APPLICANT AGREES TO MAINTAIN THE EXISTING VEGETATION IN ITS NATURAL STATE BEYOND THE "LIMIT OF WORK" AREA.


RCHITECTURAL V SURE EA O. QIA M DA 1344 v

REL. FOR MINOR SITE PLAN REVIEW - MARCH 14, 2007 NOT FOR CONSTRUCTION

MISS PORTLAND DINER PROJECT FOR TOMAK, LLC MARGINAL WAY PORTLAND, MAINE

THE DRAWNO HAS SEEN DEVELOPED BY DAVID D. FARMING AND PRICE THE STATE OF THE AND PRICE THE STATE OF THE WRITE CONSINT OF DOLLAR COPPRIGHT (\$) 2007, DAVID D. LEASURGARCH TOP DOLLAR COPPRIGHT (\$) 2007, DAVID D. LEASURGARCH TOP THE AND STATE OF THE STATE OF THE STATE OF THE STATE OF THE STATE AND STATE OF THE STATE OF

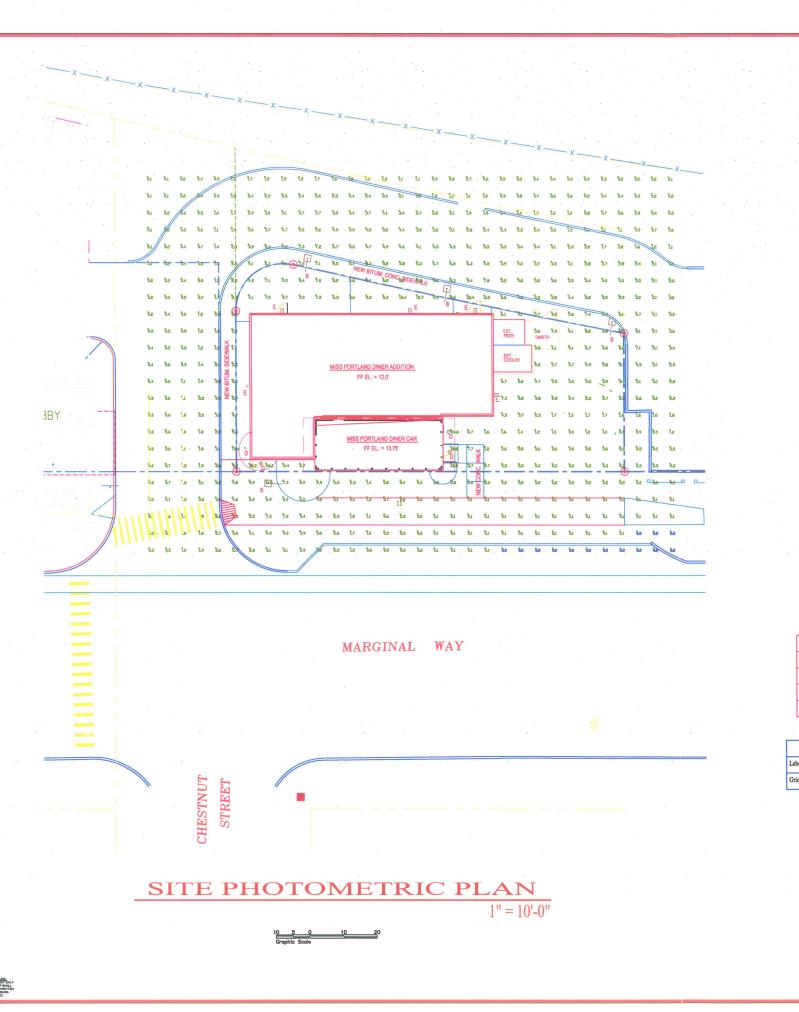

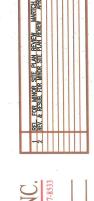

## DAVID D. LEASURE - ARCHITECTURAL ASSOCIATES INC. 1344 WASHINGTON AVENUE PORTLAND, MAINE PH. (2017) 797-8661 FAX (2017) 797-8533

RESUBMITTED FOR MINOR SITE PLAN REVIEW - APRIL 24, 2007 NOT FOR CONSTRUCTION

Mtg Ht

L5200PFX.ies

MISS PORTLAND DINER PROJECT FOR

TOMAKS, LLC MARGINAL WAY

Luminaire Schedule


Numeric Summary


0.720 PFM-H25-V5-F 0.720 pl4906 - 70WATT


0.720 695-WP-DB-MH1\_50 Type E.IES


#Pts Avg Max Min Avg/Min Max/Min CV UG Grid Spacing 593 2.85 44.1 0.0 N.A. N.A. 1.29 58.34

PORTLAND, MAINE

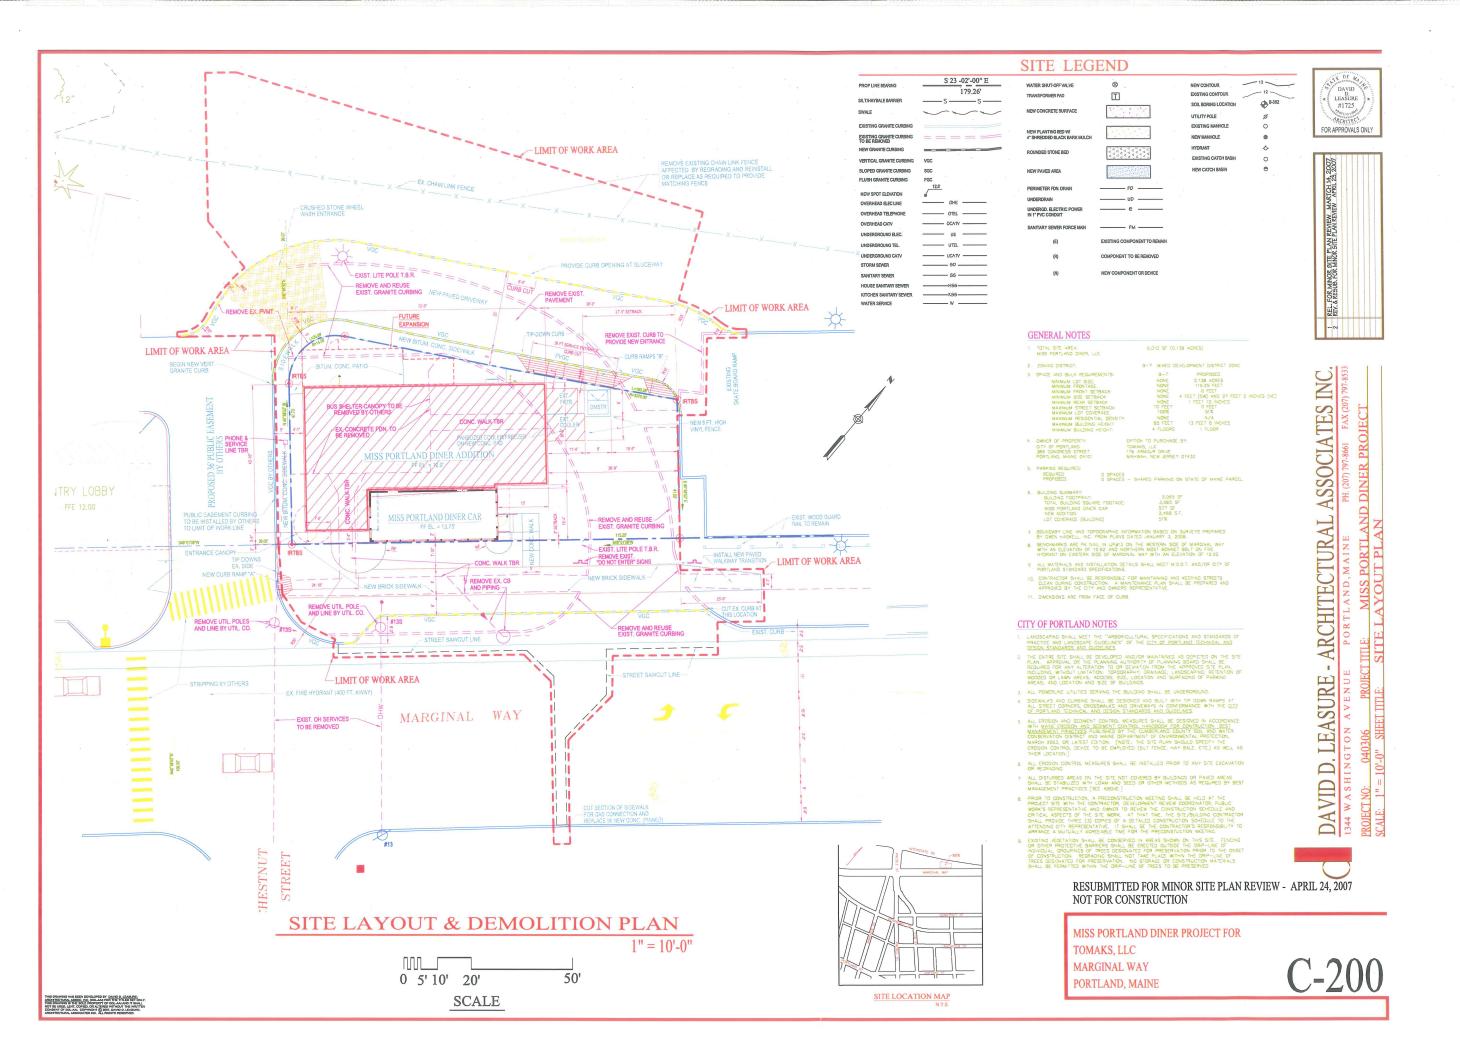


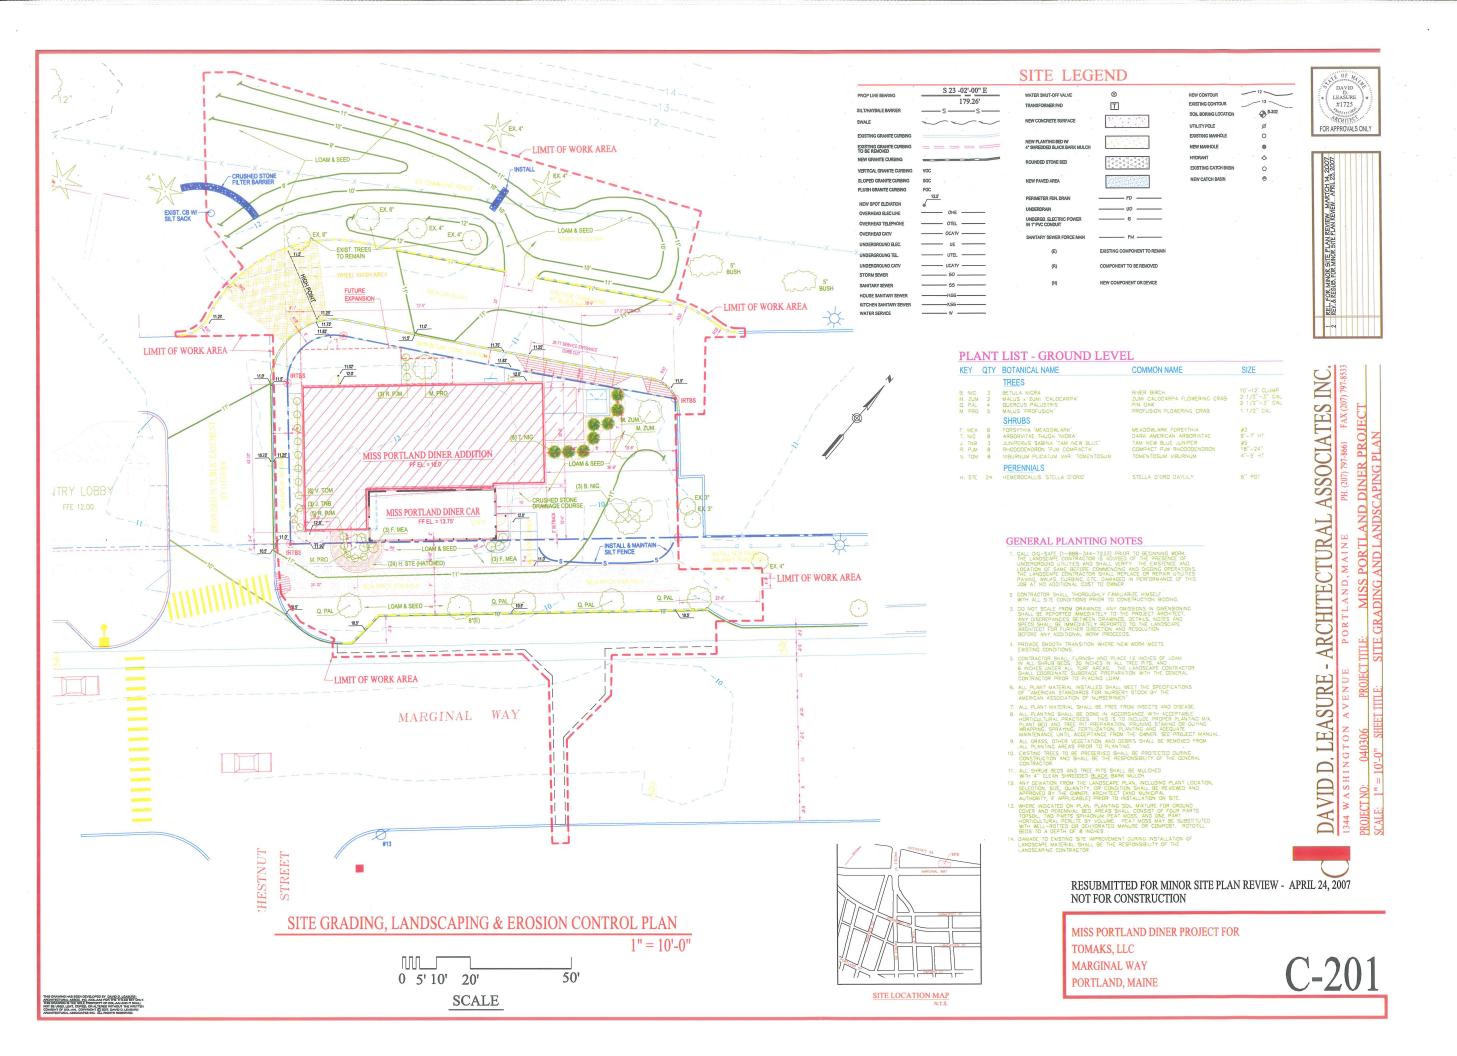

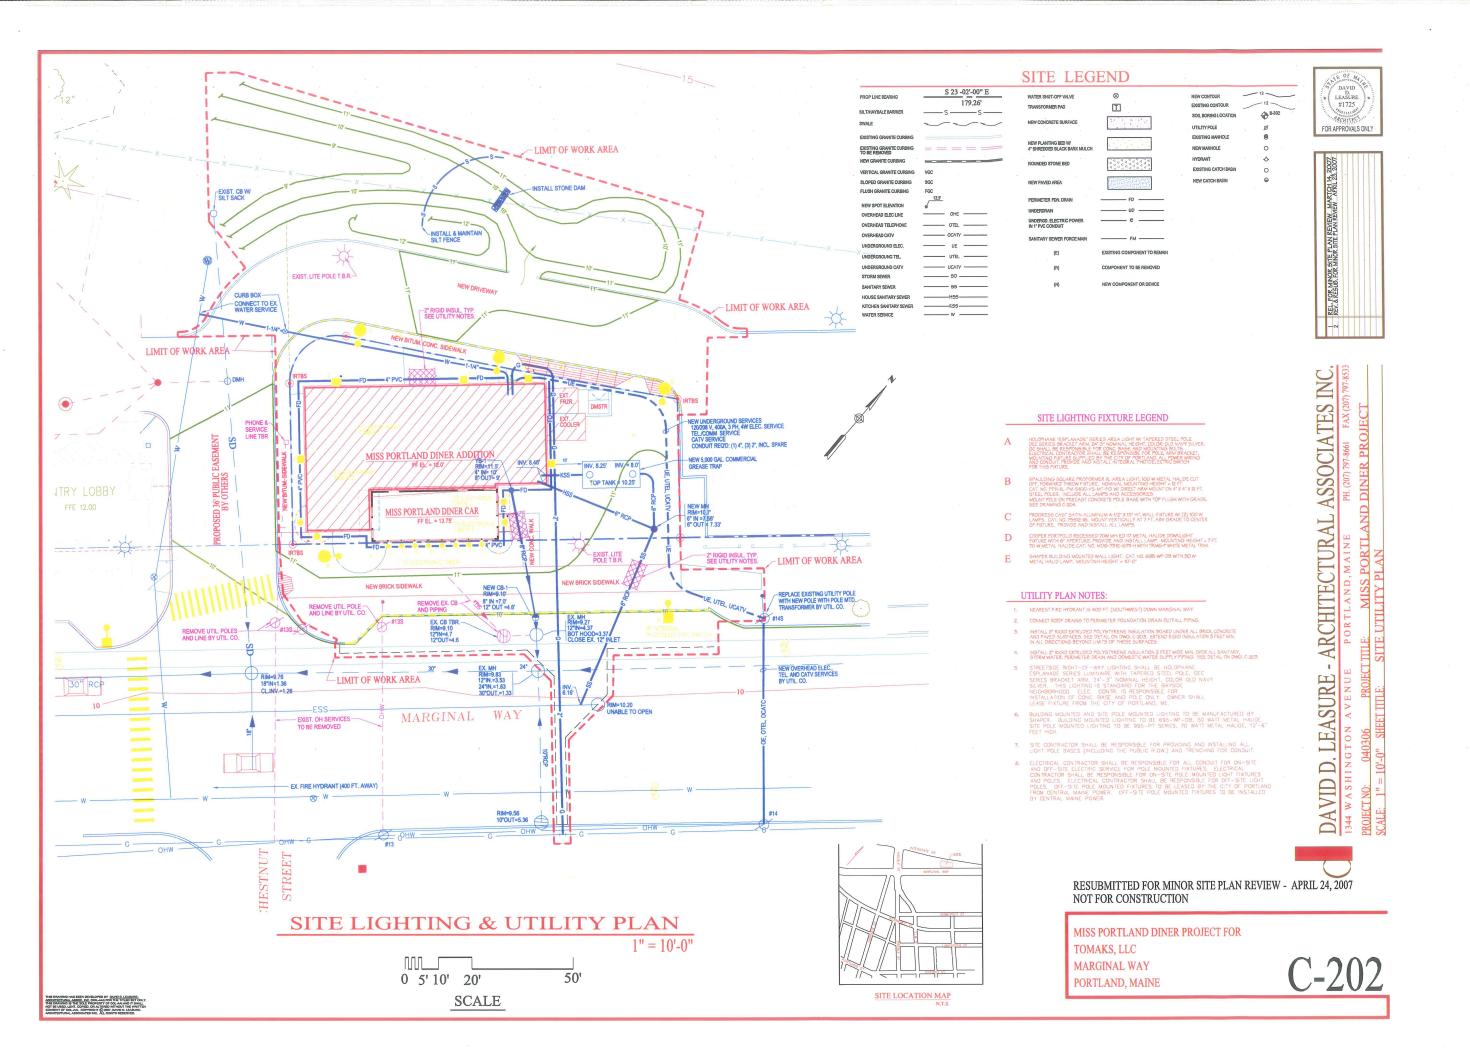

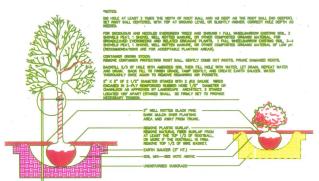


TREE AND SHRUB INSTALLATION DETAIL
NOTTO SCALE

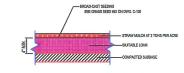


LOAM AND SEED DETAIL

NOT TO SCALE

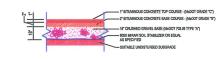


DRIVEWAY PAVEMENT DETAIL

NOT TO SCALE

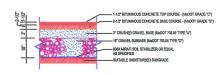


COLLECTOR STREET DETAIL


NOT TO SCALE

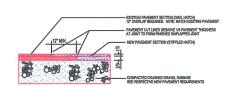


PAVEMENT SAWCUT JOINERY DETAIL

NOT TO SCALE

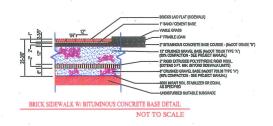

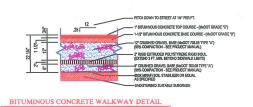


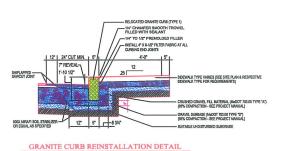



FAR HISTORY WHILE COP

FAR HISTORY TO MAL

HISTORY TO THE ANDREAD COPY OF THE ANDREAD

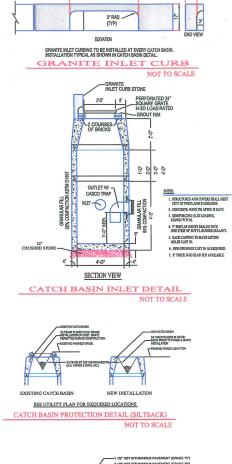

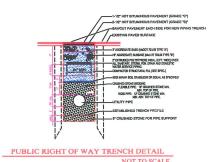

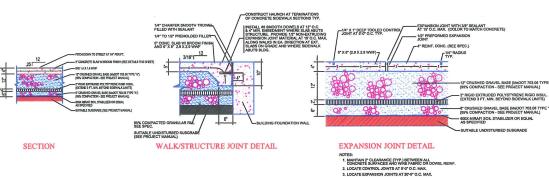

CONCRETE SIDEWALK DETAIL


WATER SERVICE TRENCH DETAIL
NOT TO SCALE

#TLOAM
A SEED

### A SEED


###

### SITE DETAILS

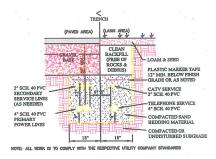


UNDERGROUND UTILITY TRENCH DETAIL

NOT TO SCALI

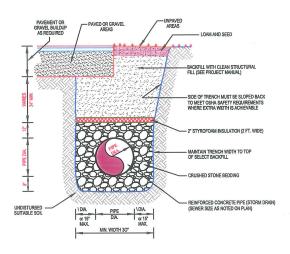

STORM DRAIN / SEWER TRENCH DETAIL

NOT TO SCALE

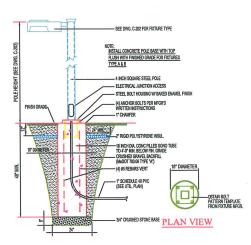

LIGHT POLE BASE DETAIL

NOT TO SCALE



INC.

ASSOCIATES I PH. (207) 797-8661 FAX (207)

ARCHITECTURAL

LEASURE-

D.


M

RESUBMITTED FOR MINOR SITE PLAN REVIEW - APRIL 24, 2007 NOT FOR CONSTRUCTION


MISS PORTLAND DINER PROJECT FOR TOMAKS, LLC MARGINAL WAY PORTLAND, MAINE

C-203


THIS DRAWING HAS BEEN DEVELOPED BY DAVID D. LEARNER.
AND THE CHAIR ASSOC, INC. (SOLLAR) FOR THE THLES BET ONLY
THIS DRAWING IS THE SULE PROPERTY OF DOLLAR AND IT SHALL.
NOT BE USED, LOY, COPIED ON A THESE WITHOUT THE WINTER
CONSENT OF DOLLAR, COPPEON TO STATE OF THE STREET
AND ASSOCIATES INC. ALL RIGHTS RESERVED.

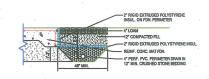

TYPICAL FOUNDATION DRAIN
NOT TO SCALE

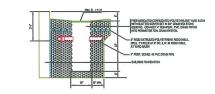


### YARD DRAIN DETAIL NOTE NOT TO SCALE NOT TO

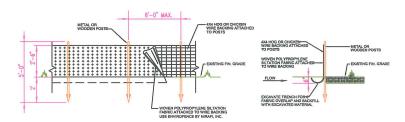


### SILTATION FENCE DETAIL


NOT TO SCALE NOTE: SILTATION FABRIC WITH INTEGRAL MESH AND POSTS MAY BE USED

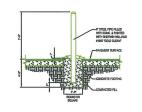


TYPICAL GUARD BOLLARD

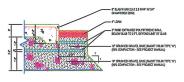


COOLER / DUMPSTER SLAB DETAIL
NOT TO SCALE

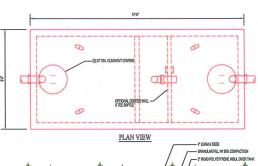

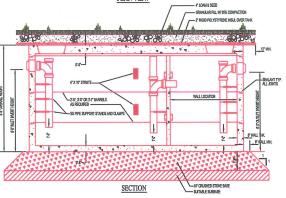


### COMMERCIAL GREASE TRAP DETAIL

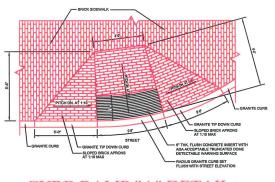

CURB RAMP "A" DETAIL

NOT TO SCALE

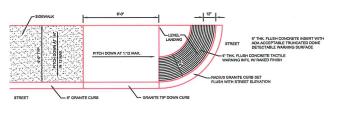

CURB RAMP "B" DETAIL NOT TO SCALE

SITE DETAILS AS NOTED






DAVID D. LEASURE - ARCHITECTURAL ASSOCIATES INC. 1344 WASHINGTON AVENUE PORTLAND, MAINE PH. (207) 797-8661 FAX (207) 797-8533

RESUBMITTED FOR MINOR SITE PLAN REVIEW - APRIL 24, 2007 NOT FOR CONSTRUCTION

MISS PORTLAND DINER PROJECT FOR

TOMAKS, LLC MARGINAL WAY

PORTLAND, MAINE

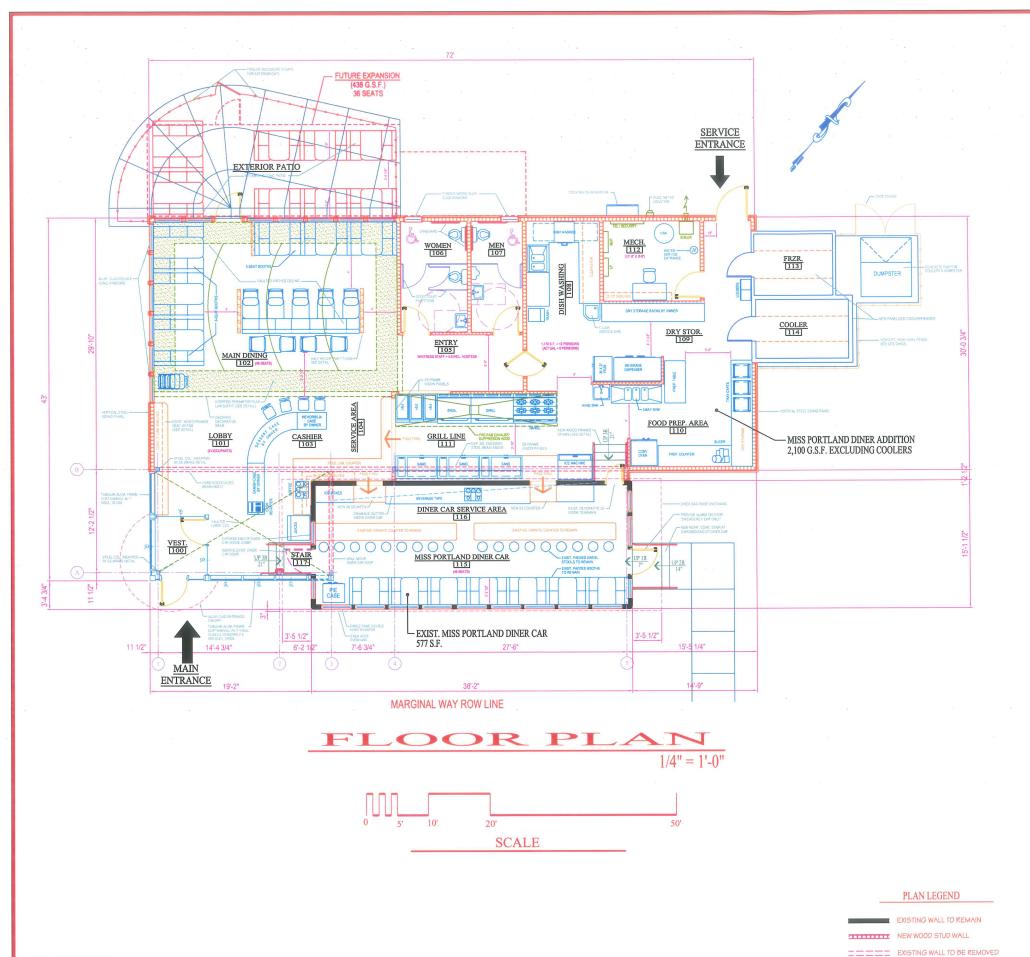





# LEASURE - ARCHITECTURAL ASSOCIATES INC.

OCCUPANCY LOAD

DINER CAR MAIN DINING WAITING 46 PERSONS 48 PERSONS 9 PERSONS WAITRESS STAFF **5 PERSONS** 6 PERSONS KITCHEN STAFF TOTAL OCCUPANCY LOAD 114 PERSONS

### **BUILDING DATA**

MISS PORTLAND DINER CAR 577 G.S.F. MISS PORTLAND DINER ADDITION 2,379 G.S.F. 2,956 G.S.F. TOTAL BUILDING AREA




40% PROGRESS SET - APRIL 26, 2007 NOT FOR CONSTRUCTION

MISS PORTLAND DINER PROJECT FOR MARGINAL WAY


TOMAKS, LLC

PORTLAND, MAINE



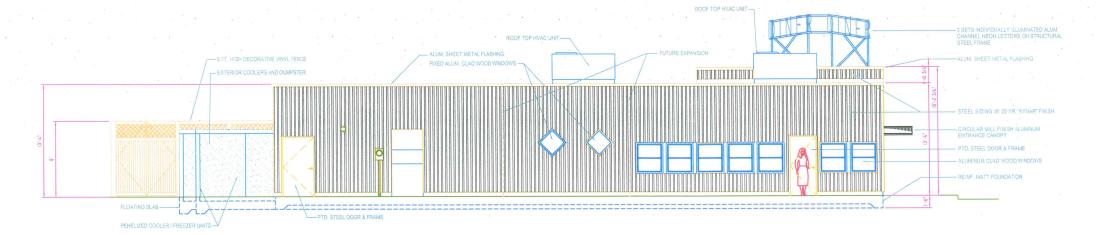

NORTHWEST (RT. 295) ELEVATION

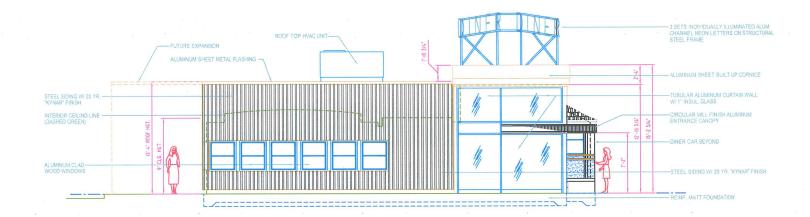

### SOUTHWEST ELEVATION

### **GENERAL NOTES**

FOR	CICNI	TURE	AND	A PPR	DVAI.

OWNER	DATE	
OWNER	DATE	
COMMENTS:		
		÷
		- V


DAVID D. LEASURE - ARCHITECTURAL ASSOCIATES INC.
1344 WASHINGTON AVENUE PORTLAND, MAINE PH. (201) 1991-8661 FAX (201) 1991-8533
PROJECTNO: 040306 PROJECTIFIE MISS PORTLAND DINER PROJECT
SCALE: 1/4" = 1'-0" SHEETTIFE: EXTERIOR BUILDING ELEVATIONS

RESUBMITTED FOR MINOR SITE PLAN REVIEW - APRIL 24, 2007 NOT FOR CONSTRUCTION

MISS PORTLAND DINER PROJECT FOR

TOMAKS, LLC MARGINAL WAY PORTLAND, MAINE



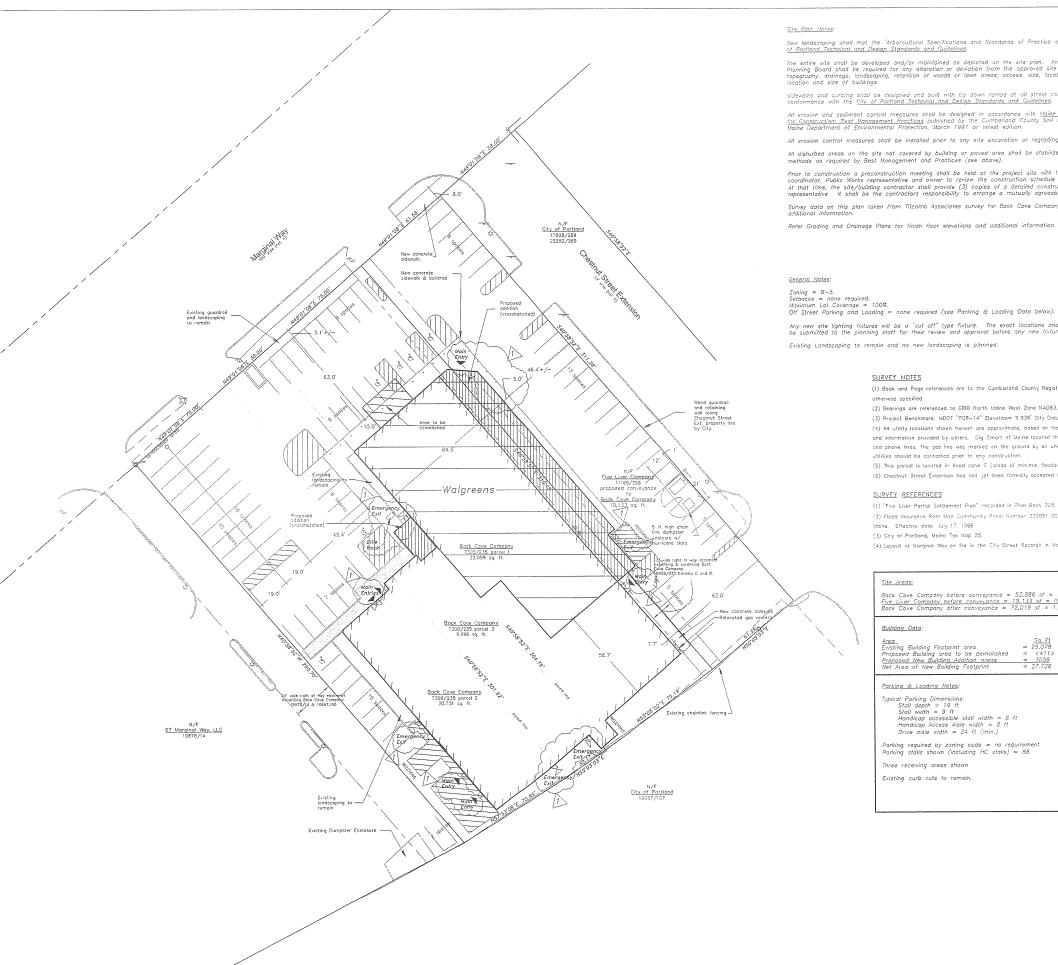

New landscaping shall met the "Arborcultural Specifications and Standards of Practice and Landscaping Guidelines" of the <u>City of Portland Technical and Design Standards and Quidelines.</u>

The entire site shall be developed and/or maintained as depicted on the site plan. Approval of the Planning Authority or Planning Board shall be required for any alteration or deviation from the approved site plan, including, without limitation, topography, drainage, leadscaping, retention of woods or lawn areas, access, size, location surfacing of paving areas and location and size of buildings.

sidewalks and curbing shall be designed and built with tip down ramps at all street corner, crosswalks and driveways in conformance with the <u>City of Portland Technical and Design Standards and Guidelines.</u>

All erosion and sediment control measures shall be designed in accordance with <u>Maine Erosion and Sediment Control Handbook for Construction: Best Management Practices</u> published by the Cumberland County Soil and Water Conservation District and the Maine Department of Environmental Protection, March 1991 or lasts edition.

All erosion control measures shall be installed prior to any site excavation or regrading.

All disturbed areas on the site not covered by building or paved area shall be stabilized with loom and seed or other methods as required by Best Management and Practices (see above).

Prior to construction a preconstruction meeting shall be held at the project sile with the contractor, development review coordinator, Public Works representative and owner to review the construction schedule and critical aspects of the site work. At that time, the site/building contractor shall provide (3) copies of a detailed construction schedule to the City representative. It shall be the contractors responsibility to arrange a mutually agreeable time for the preconstruction meeting.

Survey data on this plan taken from Titcomb Associates survey for Back Cove Company dated July 2008. Refer to survey for

Refer Grading and Drainage Plans for finish floor elevations and additional information.

Any new site lighting fixtures will be a "cut off" type fixture. The exact locations and specifications of any new fixtures will be submitted to the planning staff for their review and approval before any new fixtures are installed.

Existing Landscaping to remain and no new landscaping is planned.

- (1) Book and Page references are to the Cumberland County Registry of Deeds, unless
- (2) Bearings are referenced to GRID North Maine West Zone NAD83.
- (3) Project Benchmark: MOOT "POR-14" Elevation= 9.936' City Datum (mean tide).
- (4) All utility locations shown hereon are approximate, based on location of visible features
- and information provided by others. Dig Smart of Maine located the underground water, electric, catv, and phone lines. The gas line was marked on the ground by an unknown source. The appropriate
- (5) This parcet is topoted in flood zone C (areas of minimal flooding). See plan reference 2.
- (6) Chestnut Street Extension has not yet been formally accepted (per City Engineer).

- (1) "Five Liver Partial Settlement Plan" recorded in Plan Book 205, Page 40.
- (2) Flood Insurance Rate Map Community Panel Number 230051 0013 B City of Portland. Maine. Effective date: July 17, 1986.
- (3) City of Portland, Maine Tax Map 25.
- (4) Layout of Marginal Way on file in the City Street Records in Volume 1, Page 125.

Back Cave Company before conveyance = 52,886 sf = 1.21 Five Liver Company before conveyance = 19,133 st = 0.44 ac Back Cove Company after conveyance = 72,019 st = 1.65 ac


Area Sect Switch Building Footprint area Sect Science Proposed Building area to be demolished Science Science

Typical Parking Dimensions:
Stall depth = 19 ft
Stall width = 9 ft
Handicap accessible stall width = 8 ft
Handicap Access Aisle width = 8 ft
Orive aisle width = 24 ft (min.)

Parking required by zoning code = no requirement Parking stalls shown (including HC stalls) = 88

Three receiving areas shown

Existing curb cuts to remain.

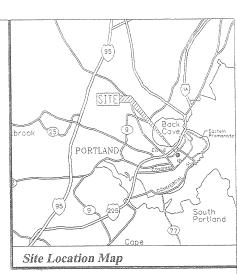



### LEGEND

Monument - found
Iron marker - found
Iron marker - set (#5 rebor)
Proparty line (lacus)
Proparty line (abutter)
Right of way line
Easement line ---- Chain link fence Edge of pavement Curb
Sign
Lamp or light pole
Utility pole
Guy wire
Gas valve Water valve Fire hydrant Fire hydrant
Sewer manhole
Curb Inlet
Catch basin (round)
Catch basin (square)
Drain manhole Bollard Overhead utility line

Cverhood utility line

Sewer line
Storm drain
Underground water line
Underground gas line
Underground electric line ----- Underground telephone line

N/F 7300/235

Now of Formerly Deed reference (Book/Page) Shrubbery Existing building Adjacent Ground Elevation Finish Floor Elevation

### Owners of Record:

Back Cove Company: Bk 7300 Pg 235 Five Liver Company: Bk 11185 Pg 258



DATE


SITE & LANDSCAPING PLAN 127 MARGINAL WAY Back Cove Company


A-0 3/18/08

4/11/08

127 MARGINAL WAY - 9/18/08

P2.1

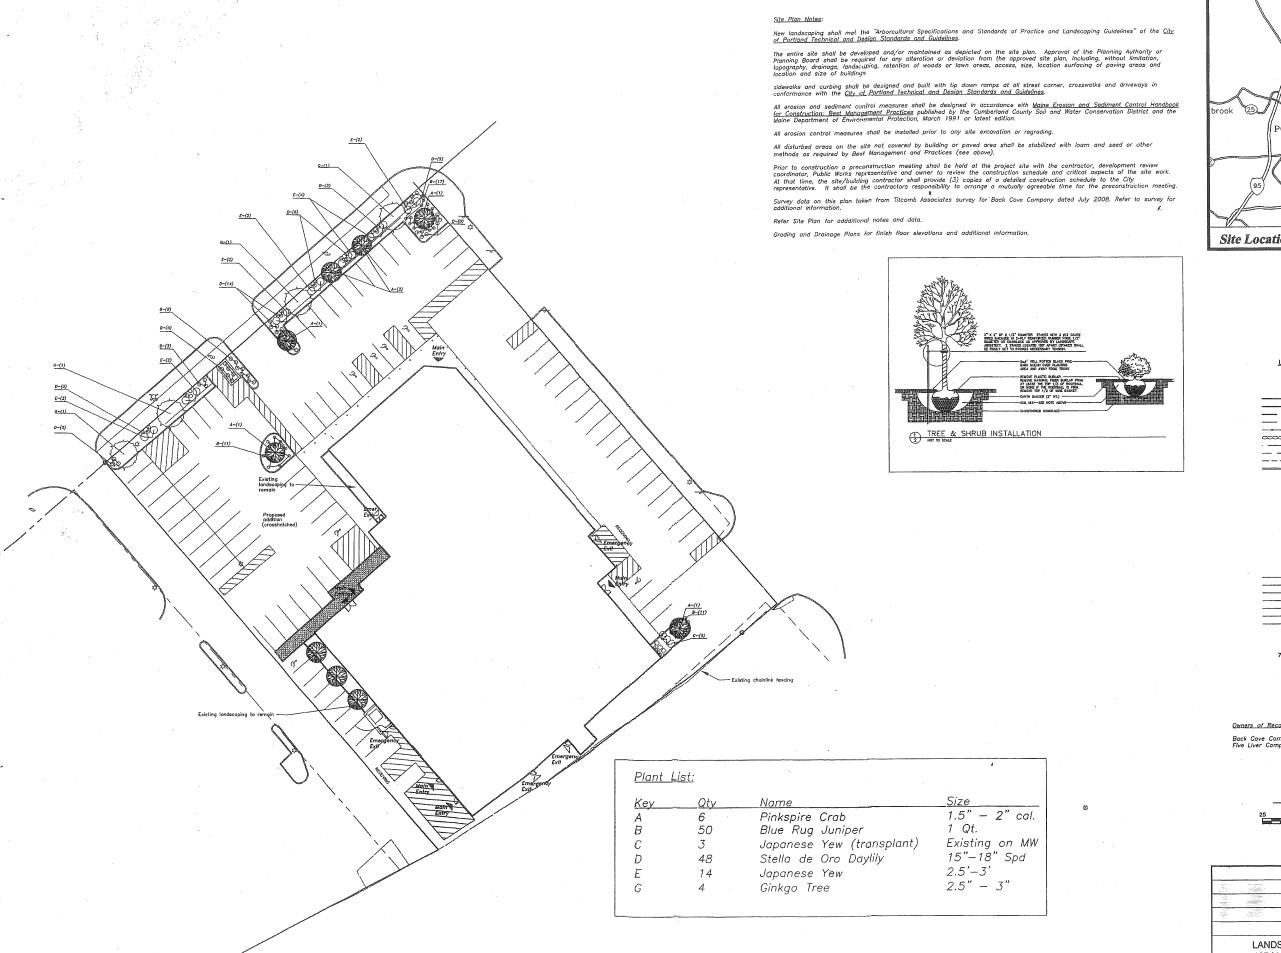


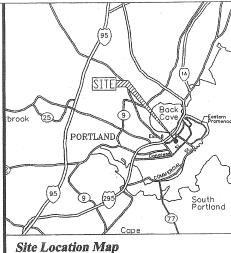




LEGEND	
Ø	Monument - found
0	Iron marker - found
•	Iron marker - set (#5 rebar)
	Property line (locus)
	Properly line (abutter)
	Right of way line
	Egsement line
	Chain link fence
~~~~~~~~	Stone sign base
	Guard roll
	Edge of payament
	Edge of gravel
	Curb
- <del></del> -	Sign
	Lamp or light pole
ep.	Utility pole
~	Guy wire
ă.	Gas valve
*	Water valve
苹	Fire hydrant
<b>©</b>	Sewer manhole
<b>SER</b>	Curb inlet
<b>\equiv </b>	Catch basin (round)
8	Catch basin (square)
•	Drain manhole
•	Bollard
	Overhead utility ilno
	Sewer line
	Storm drain
T	Underground water line
<del></del> 0	Underground gas line
t	Underground electric line
	Underground telephone line


Owners of Record:

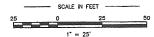


Existing building Adjacent Ground Elevation Finish Floor Elevation

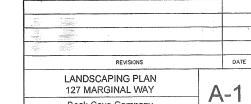

Back Cove Company

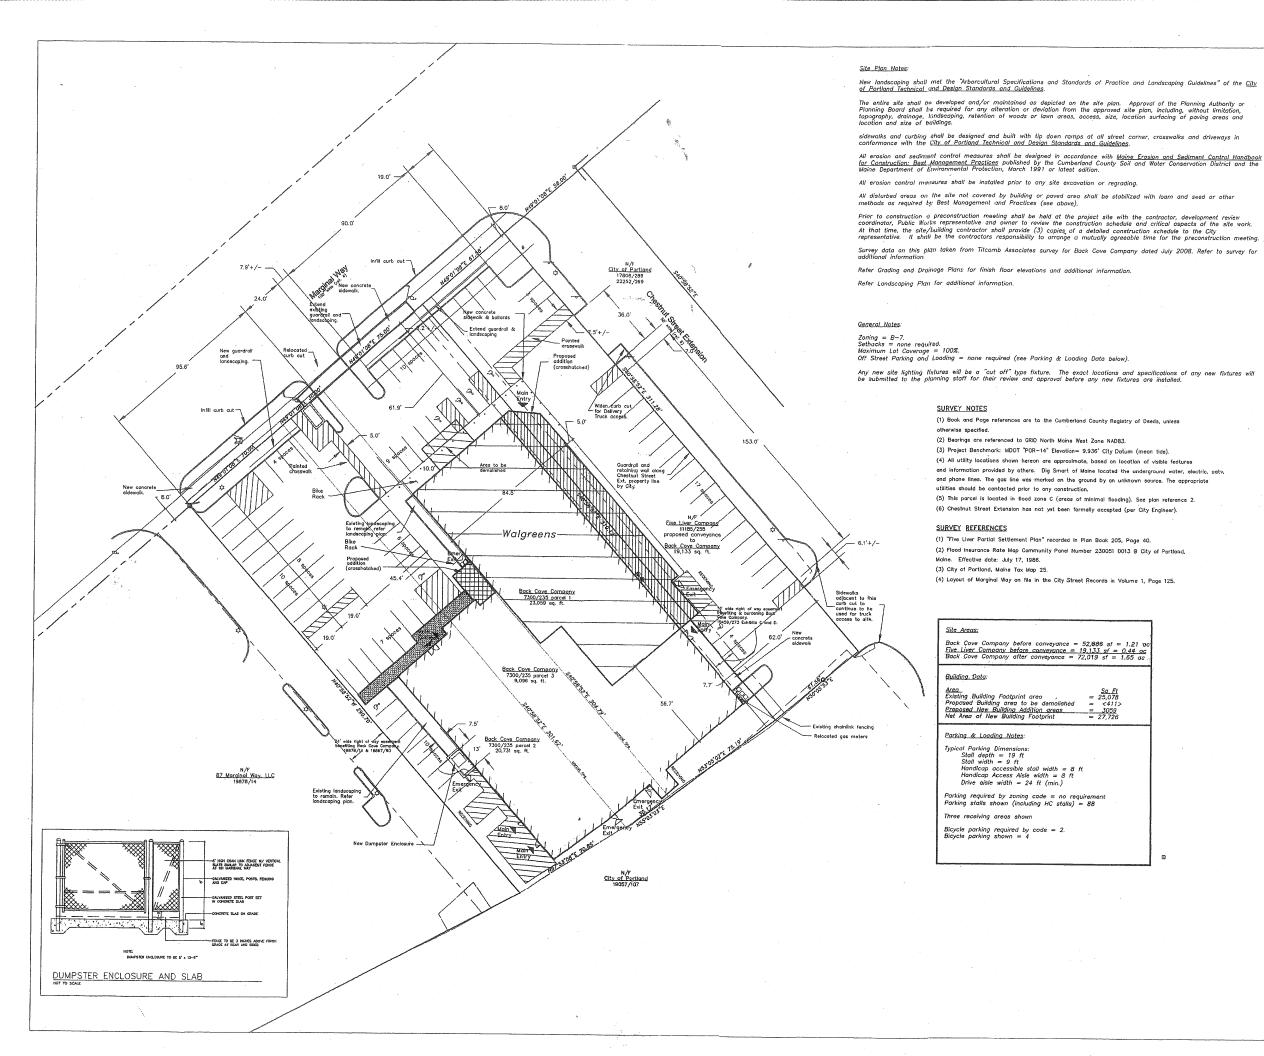

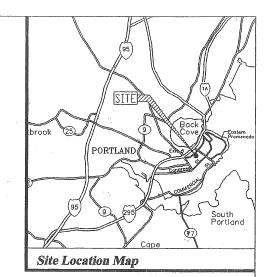




### LEGEND Monument found o Irôn thorker found o Irôn marker set fills o Irôn marker set fills Property line (bleed) Froperty line (bleed) Estable of part line Guard roll Edge of grovel Curb Sign Curb Sign Curb Sign Curb Guy wife Guy wife Guy wife Fro hydroid Seede manhole Curb Long Getch boain (round) Edge catch boain (square) Orcin manhole



Sewer line Storm drain

### Owners of Record:

Back Cove Company: Bk 7300 Pg 235 Five Liver Company: Bk 11185 Pg 258

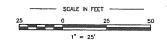

Marginal Way curb cut relocated, Chestnut St curb cut widened, Landscaping plan moved to new sheet.	12/5/08
Landscaping & plant list, dumpsters removed, curb cut infills, new sidewalks, bike racks and data table	10/6/08
Blike Rack and Entry locations	9/18/08
REVISIONS	DATE
SITE PLAN	
127 MARGINAL WAY	$\cap$

8/18/08

Back Cove Company