


VALVE RISER LEGEND

- 6" DICL U.G. SPIGOT, PLUMB AND LEVEL (BY OTHER'S)
- (2) 6" UNI-FLANGE (BY OTHER'S)
- (3) 6" GROOVED FLANGE
- 6" X 2 1/2" GROOVED CONCENTRIC REDUCER
- (5) 2 1/2" BUTTERFLY VLV W/ TAMPER SWITCH (N.O.)
- (6) WATER PRESSURE GAUGE (3.5" DIA.)
- (7) 2 1/2" AMES COLT "C200" DC BFP
- (8) POTTER VSR-2.5" VANE TYPE FLOWSWITCH
- (9) 1 1/4" TEST-N-DRAIN VALVE (1/2" TEST ORIFICE) (N.C.)
- (10) 2 1/2" GROOVED ELBOW
- (11) SPARE HEAD BOX, 6 HD CAPACITY W/ WRENCH
- (12) 1/2" AUTOMATIC BALL DRIP
- (13) 1 1/4" GALV. 45 ELBOW W/ GALV. GRINNELL PLATE (MAIN DRAIN)
- (14) 2 1/2" x 2 1/2" x 4" SIAMESE FDC W/ WALL PLATE, CAP & CHAIN SEE MAIN FLR PLAN FOR LOCATION
- (15) ELECTRIC BELL, 6" DIA., WITH BACKBOX, DEDICATED CIRCUIT POWER (MOUNTED TO OUTSIDE BY OTHERS)

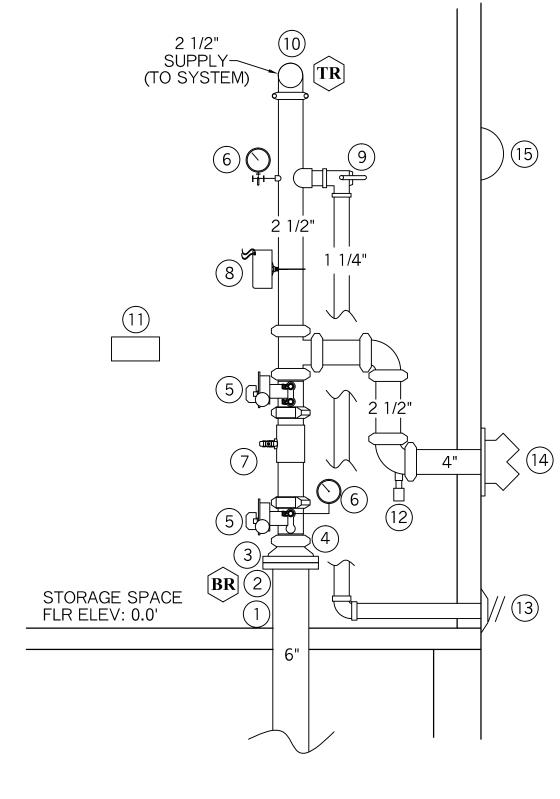


VALVE RISER DETAIL

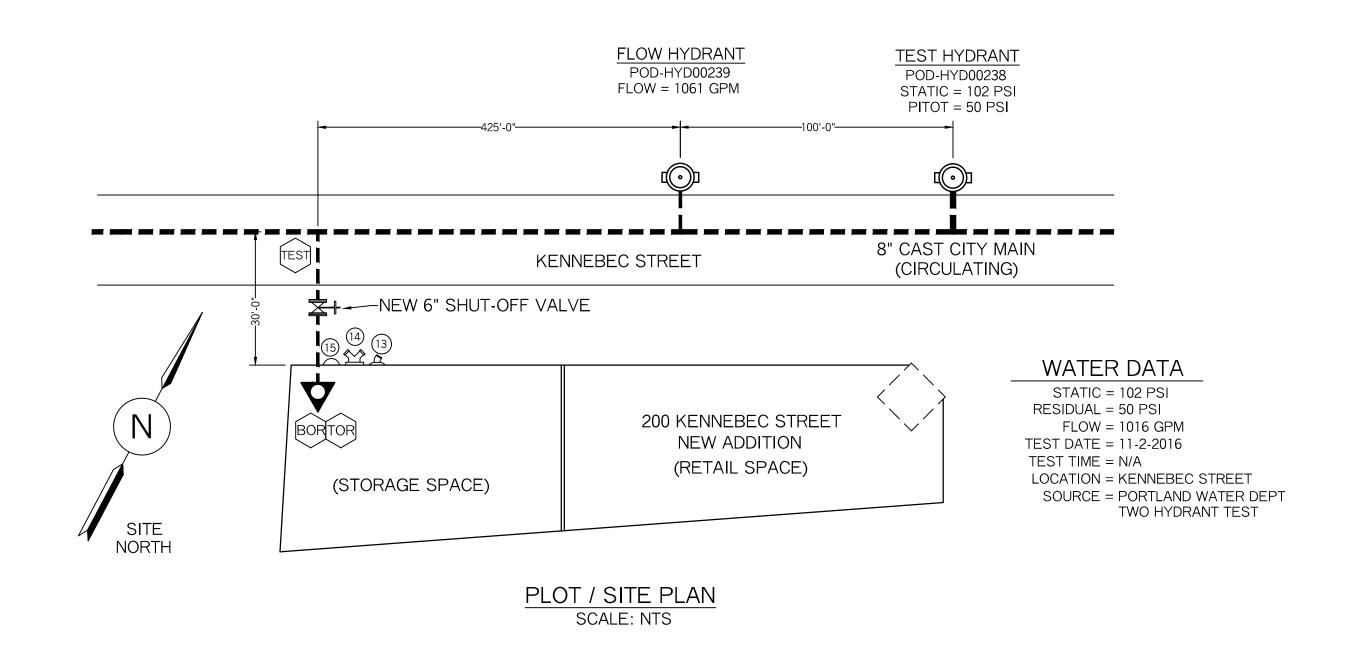

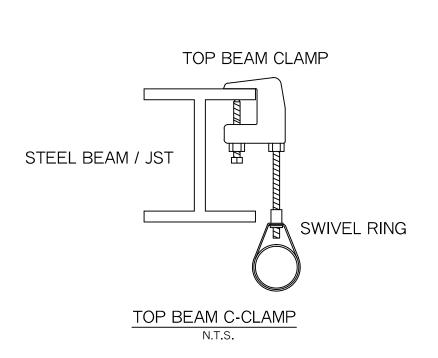


HANGER DETAILS

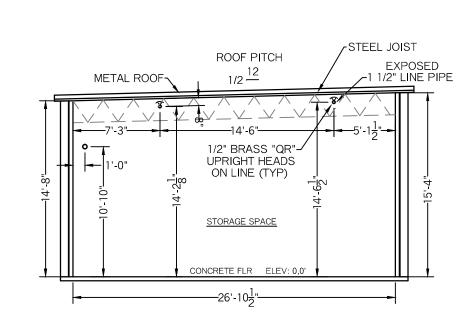

BUILDING SECTION "A'

SYSTEM GENERAL NOTES:

- A WET PIPE SYSTEM OF AUTOMATIC SPRINKLERS DESIGNED, INSTALLED AND TESTED PER NFPA 13 (2016 EDITION)
- SYSTEM DESIGNED TO MEET ORDINARY GROUP II HAZARD OCCUPANCY (.2 DENSITY) (RETAIL, GENERAL STORAGE UP TO 12'-0" AFF)
- DESIGN AREA REDUCED IN ACCORDANCE WITH NFPA 13 (2016) CHAPTER 11 SECTION 11.2.3.2.3 "QUICK RESPONSE SPRINKLERS"
- 1/2" BRASS UPRIGHT HEADS WILL BE INSTALLED EXPOSED ON LINE
- NEW 6" DICL FIRE SPRINKLER WATER LINE TO BE INSTALLED, TESTED AND FLUSHED BY OTHER'S IN ACCORDANCE WITH NFPA 24 AND LOCAL CODES.
 6" DICL SPIGOT IN THE BUILDING SHALL BE PLUMB AND LEVEL.
- RESIDENTIAL FIRE PROTECTION TO START AT 6" UNI-FLANGE AT THE END OF THE 6" SPIGOT IN THE SPRINKLER ROOM ON THE FIRST LEVEL.
- 2 1/2" SHOT-GUN VALVE RISER WITH A DOUBLE CHECK BACKFLOW PREVENTER.
- LINE PIPING (1" & 1 1/4") TO BE SCHEDULE 40 BLACK STEEL WITH THREADED ENDS AND THREADED C.I. FITTINGS.
- LINE PIPING (1 1/2") TO BE SCHEDULE 10 BLACK STEEL WITH GROOVED ENDS AND DUCTILE IRON GROOVED FITIINGS.
- MAIN PIPING (2 1/2") TO BE SCHEDULE 10 BLACK STEEL WITH GROOVED ENDS AND DUCTILE IRON GROOVED FITIINGS.

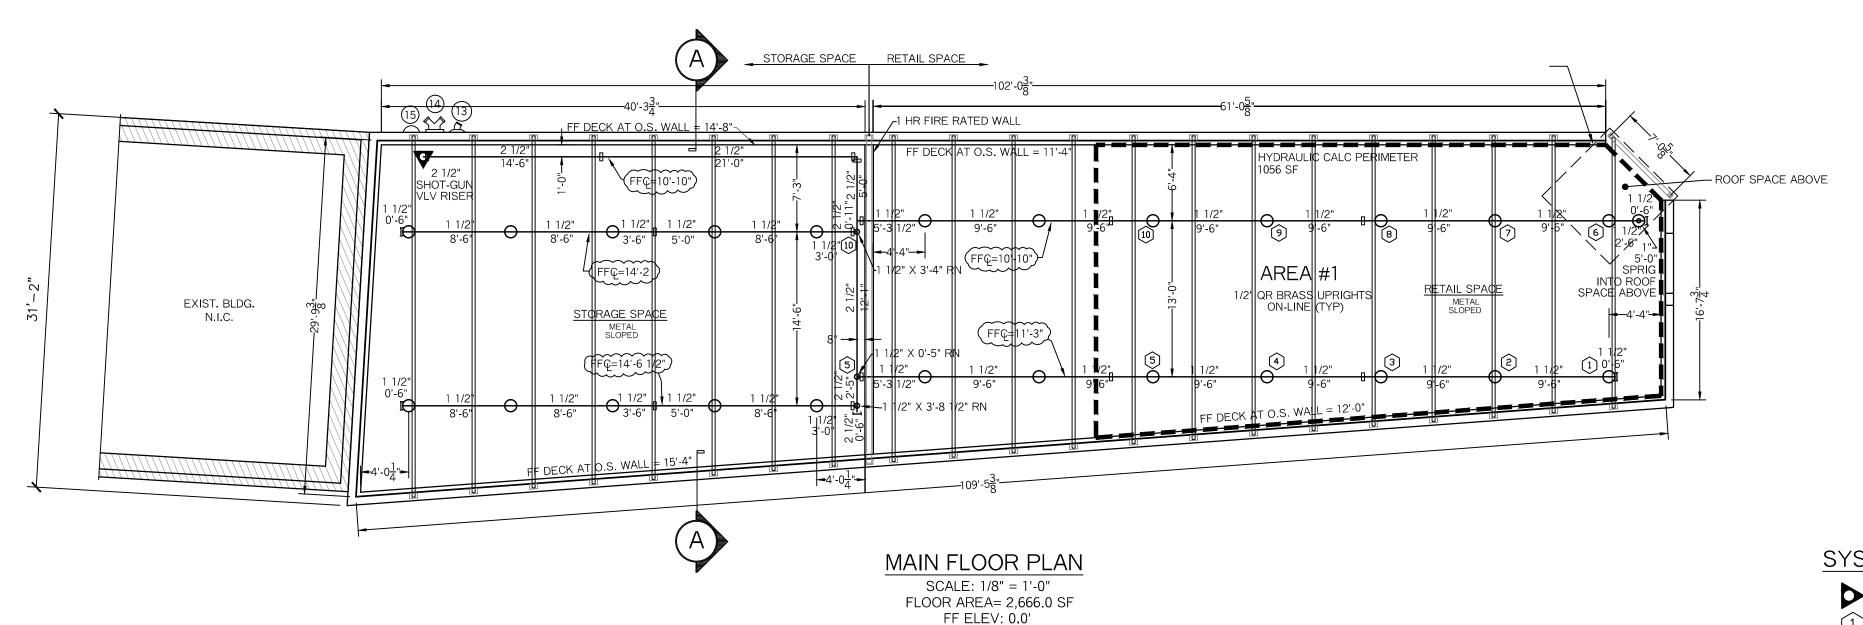

SPRINKLER HEAD INFORMATION, THIS FLOOR ONLY

				,				
QTY	SIZE	ORIFICE	K-FACTOR	DESCRIPTION	MODEL	TEMP	ESCUTCHEON	SYMBOL
24	1/2"	1/2"	5.6	VIKING VK300 BRASS QR UPRIGHT (ON LINE)	VK300	155	NONE	0
1	1/2"	1/2"	5.6	VIKING VK300 BRASS QR UPRIGHT (ON SPRIG)	VK300	200	NONE	0
TOTAL HEADS= 25								

SYSTEM SYMBOL LEGEND:

HYDRAULIC CALCULATION INFORMATION

LOCATION: BASEMENT RENOVATED AREA

BASIS OF DESIGN: NFPA 13, 2007 EDITION

1056 SQFT

TOTAL THREAD TEMP 10 1/2" 155

DENSITY AREA OF COVERAGE

SYSTEM DEMAND AT BASE OF RISER:

PRESSURE FLOW HOSE

67.33 271.31 250

SAFETY MARGIN: 19.29 PSI

OCCUPANCY: RETAIL SPACE

SPRINKLERS:

= WET SHOT-GUN RISER

(1) = HYDRAULIC CALC REF PT

- → = DRAIN VALVE
- → = DRAIN VALVE

 □ = GROOVED COUPLING
- [= GROOVED CAP N.I.C. = NOT IN CONTRACT

N.I.C. = NOT IN CONTRACT LPD = LOW POINT DRAIN

N.O. = NORMALLY OPEN
N.C. = NORMALLY CLOSED

RESIDENTIAL FIRE 200 KENNEBEC STREET FIRE SPRINKLER PLANS AND DETAILS **NEW 2017 ADDITION** REQUIRED APPROVALS: 200 KENNEBEC STREET STATE FIRE MARSHALS OFFICE PORTLAND, ME. 04101 LOCAL FIRE DEPARTMENT PROTECTION, LLC NORTHEAST DEVELOPMENT 3-29-2017 DRAWN BY: TPP 17 SOUTH ST., 3RD FLOOR NICET III PORTLAND, ME. 04101 CERTIFICATION # 100854 1/8" = 1'-0" PH: (207) 780-0223 CHECKED BY: SJC NICET III RESIDENTIAL FIRE PROTECTION C17005 CERTIFICATION # 78065 CONTRACTOR LICENSE #511 WING NO. 64 DAGGETT HILL ROAD, GREENE, MAINE 04236 1 OF 1 PH: (207) 946-3473 FAX: (207) 946-3474 CONTRACTOR RMS #80