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HERRIGEL OYSTER BAR

Portland, Maine MAY 18, 2018

PROJECT CONTACTS


ARCHITECT: PORT CITY ARCHITECTURE, PA 65 NEWBURY STREET PORTLAND, ME Ø41Ø1 TEL: (207) 761-9000 CONTACT: LITA SEMRAU

E-MAIL: LITA@PORTCITYARCH.COM



Reviewed for Code Compliance **Permitting and Inspections Department Approved with Conditions**

06/04/2018

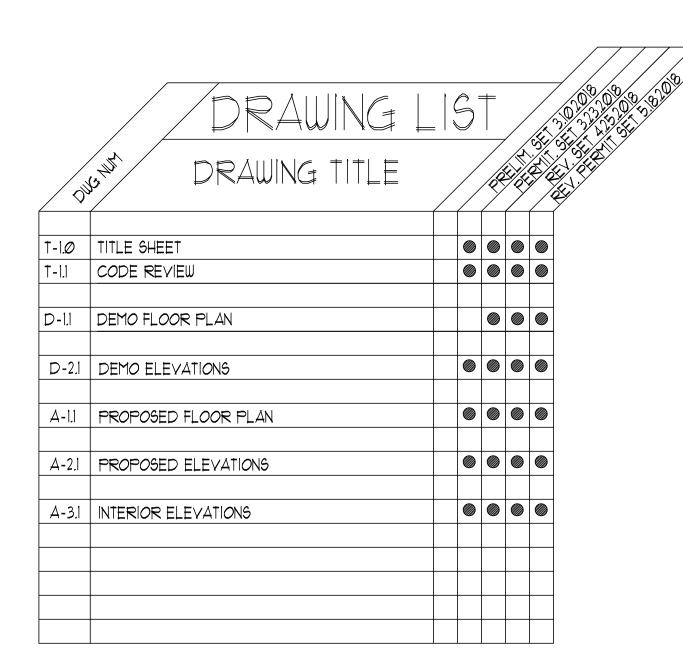

PROJECT SUMMARY

EXISTING CONDITIONS:

THE CURRENT BUILDING IS A 2-STORY BRICK \$WOOD STRUCTURE (WITH A BASEMENT CRAWL SPACE), FORMALLY USED AS A MIXED USE BUSINESS/APARTMENT. PROJECT DESCRIPTION:

THIS PROJECT WILL CHANGE THE OCCUPANCY FROM A FORMER ANTIQUE SHOP(USE GROUP M) TO A OYSTER BAR (USE GROUP B). THE UPPER LEVEL OF THE CURRENT STRUCTURE WILL REMAIN AN APARTMENT. THE BASEMENT WILL USED FOR STORAGE AND NOT OPEN TO THE PUBLIC. NEW RESTROOMS WILL

MECHANICAL, ELECTRICAL AND PLUMBING:

THIS PROJECT DOES NOT INCLUDE MECHANICAL, ELECTRICAL OR PLUMBING WORK. ANY MODIFICATIONS TO THESE SYSTEMS WILL REQUIRE ADDITIONAL PERMITS AND WILL BE THE RESPONSIBILITY OF THE CONTRACTORS PERFORMING THE WORK.

SPRINKLER SYSTEM:

NOT APPLICABLE (THERE IS CURRENTLY NO SPRINKLER SYSTEM AND ONE IS NOT REQUIRED).

FIRE ALARM SYSTEM:

NOT APPLICABLE (THERE IS CURRENTLY NO ALARM SYSTEM AND ONE IS NOT REQUIRED).

NO EXTERIOR MODIFICATIONS TO THE EXISTING GRADES AND NO CHANGES TO PERVIOUS/IMPERVIOUS SURFACES ARE PROPOSED.

THERE IS NO CHANGE OF USE.

ANY AND ALL NEW CONSTRUCTION COVERED ON THESE PLANS SHALL BE ADA COMPLIANT TO THE FURTHEST EXTENT POSSIBLE, ADA RESTROOMS

SUSPENDED ACOUSTICAL TILE


SCHED SCHEDULE


STORM DRAIN SECTION

SQUARE FEET


EXISTING

LEGEND

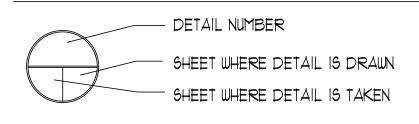


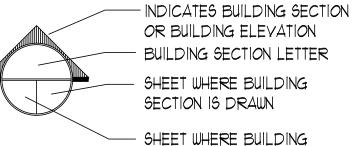

SECTION IS TAKEN INTERIOR ELEVATION

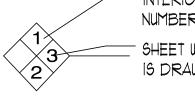

SHEET WHERE ELEVATION IS DRAWN

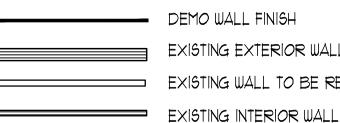

DEMO WALL FINISH EXISTING EXTERIOR WALL EXISTING WALL TO BE REMOVED



ROOM NAME AND NUMBER



KEY NOTE



DOOR NUMBER



COLUMN GRID LINE



ELEVATION TARGET






GENERAL NOTES

- I. ALL MATERIALS, COMPONENTS, AND WORK ARE NEW AND SHALL BE PROVIDED IN THIS CONTRACT BY THE CONTRACTOR UNLESS NOTED OTHERWISE.
- 2. ALL WORK INCLUDED IN THIS CONTRACT SHALL CONFORM TO ALL STATE, NATIONAL AND OTHER CODES AND ORDINANCES WHICH APPLY TO THIS PROJECT.
- 3. IT IS THE INTENT AND MEANING OF THESE DRAWINGS THAT THE CONTRACTOR AND EACH SUBCONTRACTOR PROVIDE ALL LABOR, MATERIALS, TRANSPORTATION, SUPPLIES, EQUIPMENT, ETC. TO OBTAIN A COMPLETE JOB TO INDUSTRY STANDARD IN A PROFESSIONAL WORKMANLIKE MANNER.
- 4. THE CONTRACTOR SHALL FIELD VERIFY ALL EXISTING CONDITIONS AND REPORT ANY DISCREPANCY(IES) IMMEDIATELY TO THE ARCHITECT.
- 5. AT THE END OF EACH WORKING DAY, THE CONSTRUCTION SITE SHALL BE LEFT IN A NEAT AND
- 6. THE CONTRACTOR SHALL BE RESPONSIBLE FOR OBTAINING ALL PERMITS WHICH ARE REQUIRED FOR THE SATISFACTORY COMPLETION OF THE WORK AND FOR PAYING ALL FEES, HOOK UP CHARGES, ETC. (STATE FIRE MARSHAL PERMIT BY OWNER.)
- 7. THE CONTRACTOR SHALL OBTAIN APPROVAL FROM THE OWNER FOR THE SEQUENCE AND TIMING OF OPERATIONS PRIOR TO COMMENCING WORK. AREAS FOR STAGING ETC. MUST BE APPROVED BY THE OWNER.
- 8. THE CONTRACTOR SHALL DISPOSE OF AND / OR RECYCLE ANY CONSTRUCTION DEBRIS FROM THE PROJECT SITE AS REQUIRED BY THE STATE, THE CONTRACTOR SHALL BE RESPONSIBLE FOR OBTAINING DISPOSAL PERMITS WHICH ARE REQUIRED. CONSTRUCTION DEBRIS FROM THE PROJECT SITE SHALL BE DISPOSED OF IN A STATE APPROVED LANDFILL
- 9. ROOM NUMBERS ON THE DRAWING ARE FOR COORDINATION PURPOSES AND DO NOT NECESSARILY CORRESPOND TO ACTUAL ROOM NUMBERS
- 10. DUTY OF COOPERATION: RELEASE OF THESE PLANS CONTEMPLATES FURTHER COOPERATION AMONG THE OWNER. THE CONTRACTOR, THE ARCHITECT AND HIS CONSULTANTS. DESIGN AND CONSTRUCTION ARE COMPLEX. ALTHOUGH THE ARCHITECT AND HIS CONSULTANTS HAVE PERFORMED THEIR SERVICES WITH DUE CARE AND DILIGENCE, THEY CANNOT GUARANTEE PERFECTION. COMMUNICATION IS IMPERFECT, AND EVERY CONTINGENCY CANNOT BE ANTICIPATED. ANY AMBIGUITY OR DISCREPANCY DISCOVERED BY THE USE OF THESE PLANS SHALL BE REPORTED IMMEDIATELY TO THE OWNER. FAILURE TO NOTIFY THE OWNER COMPOUNDS MISUNDERSTANDING AND MAY INCREASE CONSTRUCTION COSTS. A FAILURE TO COOPERATE BY A SIMPLE NOTICE TO THE OWNER SHALL RELIEVE THE OWNER AND THE ARCHITECT FROM RESPONSIBILITY FROM ALL COSTS
- THESE DRAWINGS DO NOT INCLUDE THE NECESSARY COMPONENTS FOR CONSTRUCTION SAFETY. THE GENERAL CONTRACTOR SHALL PROVIDE FOR THE SAFETY, CARE OF UTILITIES AND ADJACENT PROPERTIES DURING CONSTRUCTION, AND SHALL COMPLY WITH STATE AND FEDERAL SAFETY REGULATIONS.
- 12. ALL MATERIALS AND WORK SHALL BE GUARANTEED FOR A MINIMUM OF ONE YEAR FROM THE DATE OF FINAL PAYMENT.
- 13. ALL DOORS SHOULD HAVE ADA COMPLIANT LEVER HANDLES.



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PERMIT SET

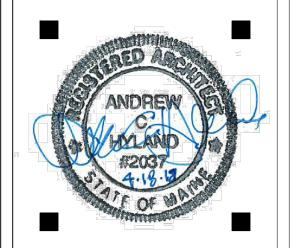HERRIGEL **OYSTER BAR** PORTLAND, MAINE

OYSTER BAR

TITLE SHEET

Project Number Drawn by Checked by

Scale AS NOTED

May 18, 2018

TYPICAL ABBREVIATIONS

\$ ANG a ADA ADJ AFF	AND ANGLE AT AMERICAN DISABILITIES ACT ADJUST OR ADJANCENT ABOVE FINISH FLOOR	ELEY	DRAWING EAST EACH EXPANSION JOINT ELECTRIC ELEVATION
ALUM ARCH AVG	ALUMINUM ARCHITECT OR ARCHITECTURAL AVERAGE	ENCL	EMPLOYEE ENCLOSE
BD	BOARD	ENT	ENTRY OF ENTRANCE EQUAL
BLDG	BUILDING	EQ	
BLKG	BLOCKING	EWC	
BM	BEAM	EXH	
B0	BOTTOM OF	EXIST	EXISTING
£	CENTER LINE	EXP	
CAB	CABINET	EXT	
CLG CLR	CEILING CLEAR	FDN	FOUNDATION
CMU	CONCRETE MASONRY UNIT	FF	FINISH FLOOR
CNTR	COUNTER	FFE	FINISH FLOOR ELEVATIO
COL	COLUMN	FIN	FINISH
CONC	CONCRETE	FI×T	FIXTURE
CONT	CONTINUOUS	FLG	FLOORING
COORD	COORDINATE	FLR	FLOOR
COR	CORNER	FLUOR	FLUORESCENT
CPT	CARPET	FT	FOOT or FEET
CW DBL	COLD WATER DOUBLE	GA GALV	GAUGE
DEG	DEGREE DOMESTIC HOT WATER	GC	GENERAL CONTRACTOR
DHW		GL	GLASS
DIA	DIAMETER	GWB	
DIM	DIMENSION	HGT	

HORIZ HORIZONTAL

HOLLOW METAL

HVAC HEATING, VENTILATION & AIR CONDITION

INSTALLED BY CONTRACTOR INCHES INSULATION INTERIOR LAMINATED POUNDS LINEAR FEET LIVE LOAD LIGHT WEIGHT CONCRETE MAXIMUM MECHANICA. MANUFACTURE MAN HOLE MILLIMETER MINIMUM MAIN SWITCH BOARD MOUNTED MICROWAVE NORTH NOT APPLICABLE NATURAL NOT IN CONTRACT NOT TO SCALE ON CENTER OVER HEAD PARALLEL PRECAST CONCRETE PRFERORATED PERPENDICULAR P-LAM PLASTIC LAMINATE

SIMILAR SHELL PACKAGE SPECIFICATIONS STAINLESS STEEL SQUARE STANDARD STEEL STRUC STRUCTURAL SUSPENDED SYMMETRICAL THERMOSTAT TOP AND BOTTOM TELEPHONE TEMPERED GLASS THICKNESS TENANT IMPROVEMENTS TOP OF TOP OF JOIST TOP OF STEEL TYPICAL UNDERWRITERS LABORATORIES, INC UNLESS NOTED OTHERWISE VINYL BASE VERTICAL VINYL COMPOSITE TILE VERIFY IN FIELD WIDE or WEST PLAS PLASTER WATER COOLER PLBG PLUMBING WITH WITHOUT

Chapter 9 - Change of Occupancy

Section 912.1.1.1 - The building shall also comply with Chapter 8 of this code (Alterations - Level 3).

Section 912.2.1- A sprinkler system is not required as the assembly fire area is under 5,000 sf and under 100 occupants and is not above or below the Level of Exit Discharge (see IBC Table 903.2).

Table 912.4 - There is no change to the Means of Egress Classification Section 912.4.2- Existing egress elements shall comply with IEBC Section 805. New egress elements shall comply with IBC Chapter 10.

Section 805.1 - Means of egress shall comply with IEBC Section 705 (existing egress elements).

Section 705.3.1.1(1) - Two means of egress from the main level are not required as the occupant load does not exceed 50.

Section 705.6 - Dead-end corridors shall not exceed 35'. **Section 705.9.1** - The stair off the existing exterior deck is required to have a handrail on (at least) one side.

Section 805.2 - Means of egress lighting is required on the work floor (this will be included in the electrical portion of the work and under a separate permit).

Section 805.3 - Exit signage is required (see Floor Plan for

Table 912.5 - The building is not increasing the Height/Area Hazard Category (A-3 to A-2 is a Relative Hazard 2).

Section 912.5.2 - The height and area of the existing building is acceptable.

Hazard Category (all Assembly is a Relative Hazard 3). Section 912.6.2 - The existing exterior walls (including openings) shall be accepted.

Table 912.6- There is no change to the Exposure of Exterior Walls

Section 912.7.2- Due to the unchanged Means of Egress Hazard Category (Table 912.4), the existing interior stair is not required to be enclosed. Note: A door at the top of the stair will be installed to prevent the passage of smoke from the lower level to the upper level. Section 912.8.2- See notes under Section 310.4.2.

Code Review - NFPA 101 (Life Safety) 2009

Chapter 6 - Classification of Occupancy

Section 6.1.14.2.3 - A multiple occupancy where the occupancies are separated by fire resistance-rated assemblies.

Table 6.1.14.4.1 - A 2-hr rated ceiling is required to separate the apartment occupancy from the restaurant below.

Chapter 43 - Building Rehabilitation

Section 43.1.2.2 - This project shall comply with Section 43.7 due to the Change of Use (Business to Restaurant).

Section 43.7.1.1 - The Change of Use does not involve a change of occupancy classification per Table 43.7.3 and shall comply with Chapter 13 (Existing Mercantile Occupancies).

Section 43.7.2.1 - The Change of Use does not involve a change of occupancy classification per Table 43.7.3 and shall comply with Chapter 36 (Existing Mercantile Occupancies) and Chapter 37 (New Mercantile Occupancies) for the sprinkler and fire alarm systems.

Table 43.7.3 - The Change of Use does involve a change of occupancy classification as the previous use (Retail) is business and the new restaurant use is Mercantile (per À.3.3.187.2).

Chapter 36- New Mercantile Occupancies

Note - Per Chapter 43, only the sprinkler and fire alarm/communications requirements of this chapter shall apply.

Section 36.3.4.1. - A fire alarm is not required. **Section 36.3.5.1.** - A sprinkler system is not required as the use is not any of the uses listed.

Chapter 37- Existing Mercantile Occupancies (Class - C)

Section 37.2.4.1 - Not less than 2 exits shall be provided from every


Section 37.2.5.2 - Dead end corridors shall not exceed 50 feet. **Section 37.2.5.3.2** - Common Path of travel shall not exceed 75 feet. **Section 37.2.6.2** - Travel distance to an exit shall not exceed 150 feet.

Section 37.3.4 - A fire alarm system is not required. **Section 37.3.5-** A sprinkler system is not required.

Section 37.3.5.3- Portable fire extinguishers shall be provided in all mercantile occupancies in accordance with 9.7.4.1.

Reviewed for Code Compliance Permitting and Inspections Department **Approved with Conditions**

06/04/2018

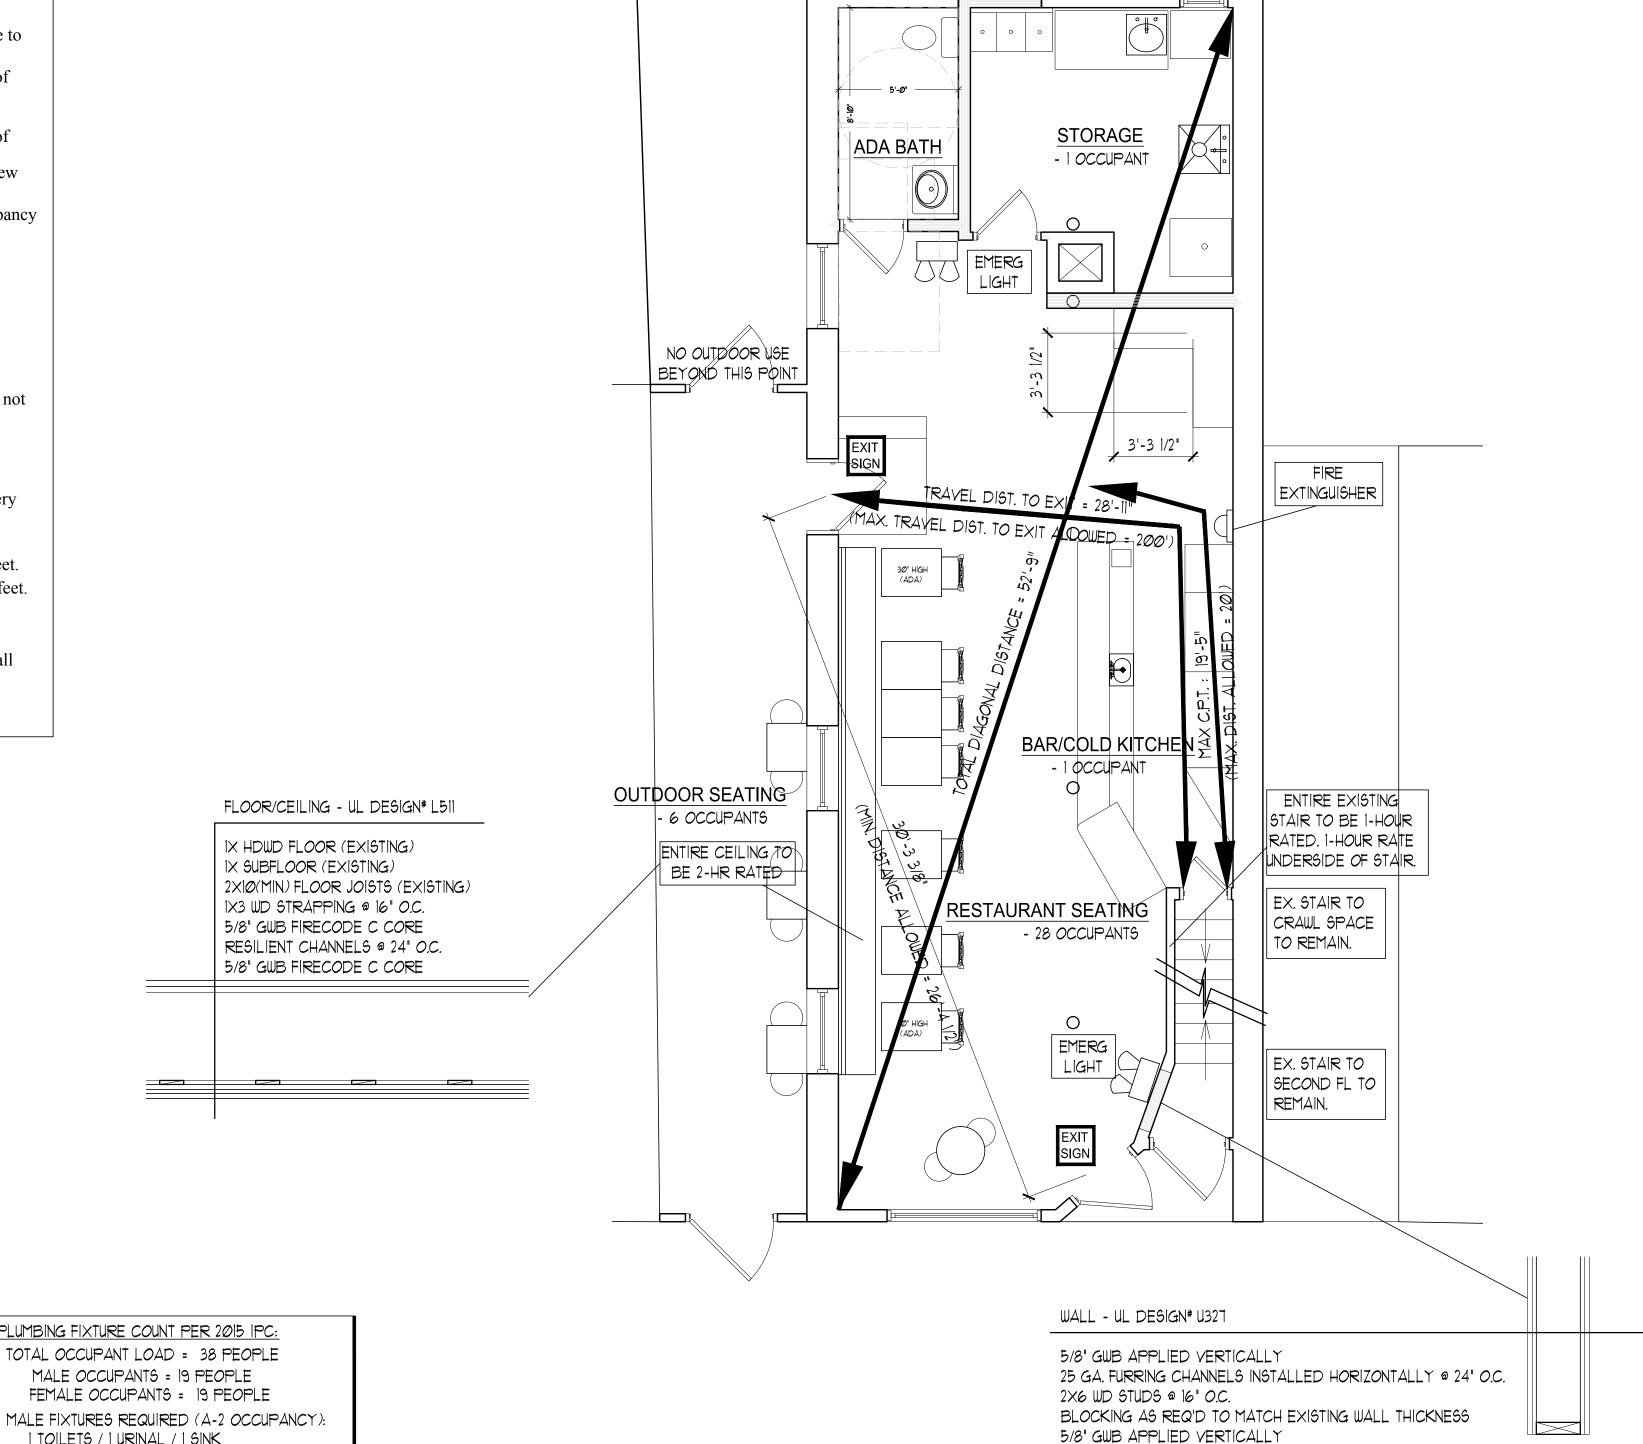

EXIT SIGNAGE NOTE:

SEE EGRESS PLAN FOR EXIT SIGNAGE LOCATIONS. CONFIRM EXACT LOCATIONS WITH LOCAL AHJ. VERIFY SIGNAGE CAN BE SEEN IN ALL AREAS OF FIRST FLOOR. SOME DIRECTIONAL SIGNAGE MAY BE REQUIRED. CONTRACTOR OPTION TO INCLUDE EMERGENCY LIGHTING / EXIT SIGNAGE COMBO FIXTURES.

EMERGENCY LIGHTING IS REQUIRED (INCLUDE WITH ELECTRICAL PERMIT). SEE EGRESS PLANS FOR LIGHTING LOCATIONS. CONTRACTOR TO FIELD VERIFY EXACT LOCATIONS WITH LOCAL AHJ. CONTRACTOR TO CONFIRM EXACT LIGHTING FIXTURE AND LUMEN LEVELS WITH LOCAL AHJ TO VERIFY COMPLIANCE WITH ALL APPLICABLE CODES..

FIRE EXTINGUISHER NOTE:

FIRE EXTINGUISHERS SHALL BE BRACKET MOUNTED OR IN A RECESSED (OR SEMI-RECESSED) CABINET WITH THE HANDLE AT 42" A.F.F. FIRE EXTINGUISHER IN THE SPACE TO BE CLASS ABC (SEE PLAN FOR LOCATIONS). CONFIRM EXACT SIZE W/LOCAL JURISDICTION.

PLUMBING FIXTURE COUNT PER 2015 IPC:

TOTAL OCCUPANT LOAD = 38 PEOPLE MALE OCCUPANTS = 19 PEOPLE FEMALE OCCUPANTS = 19 PEOPLE

1 TOILETS / 1 URINAL / 1 SINK FEMALE FIXTURES REQUIRED (A-2 OCCUPANCY) 1 TOILETS / 1 SINK

NOTE: THIS FIXTURE COUNT WILL ACCOMMODATE A TOTAL OCCUPANT LOAD UP TO 50


NOTE: PER STATE STATUTE FOR RESTAURANTS UP TO 40 SEATS, ONE SINGLE USE BATHROOM IS ALLOWED.

TOTAL SQUARE FEET: 175

TOTAL OCCUPANT LOAD: 36 OCCUPANTS TOTAL SEATING OCCUPANTS LOAD: 36 PEOPLE 9 FIXED SEATS = 9 PEOPLE 342 LINEAR INCHES OF BENCH / 18 INCHES = 19 PEOPLE 6 OUTDOOR SEATING = 6 PEOPLE TOTAL STORAGE OCCUPANT LOAD: I PERSON 116 SQFT / 300 SQFT = 1 PERSON TOTAL BAR/KITCHEN OCCUPANT LOAD: I PERSON 10 SQUARE FEET / 100 = 1 PERSON



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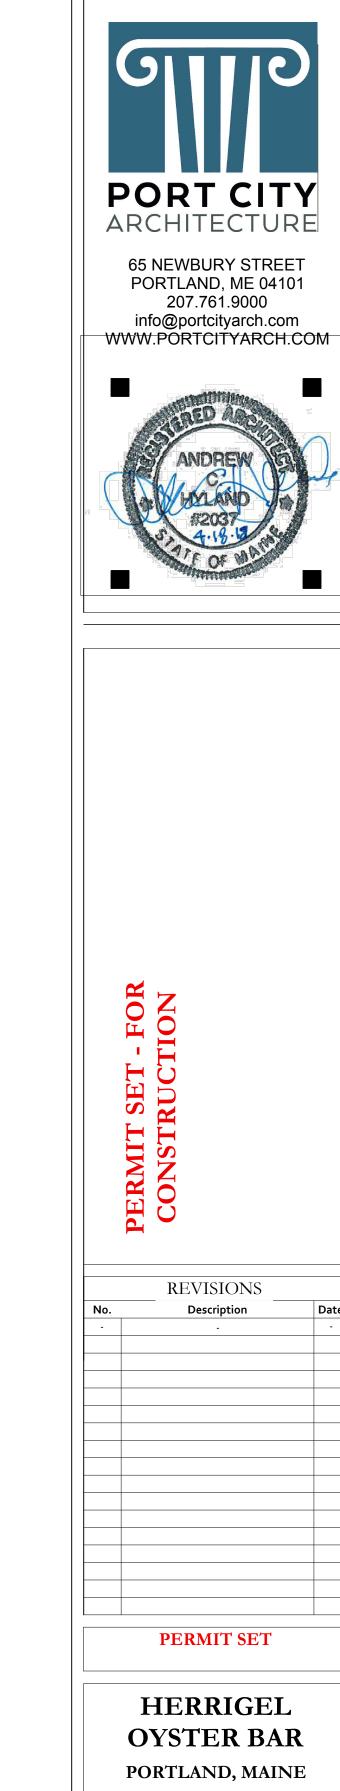
OYSTER BAR

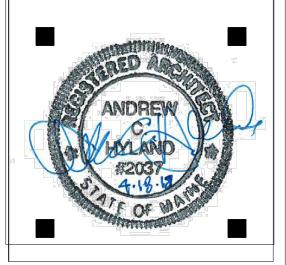CODE REVIEW

Project Number May 18, 2018 Drawn by

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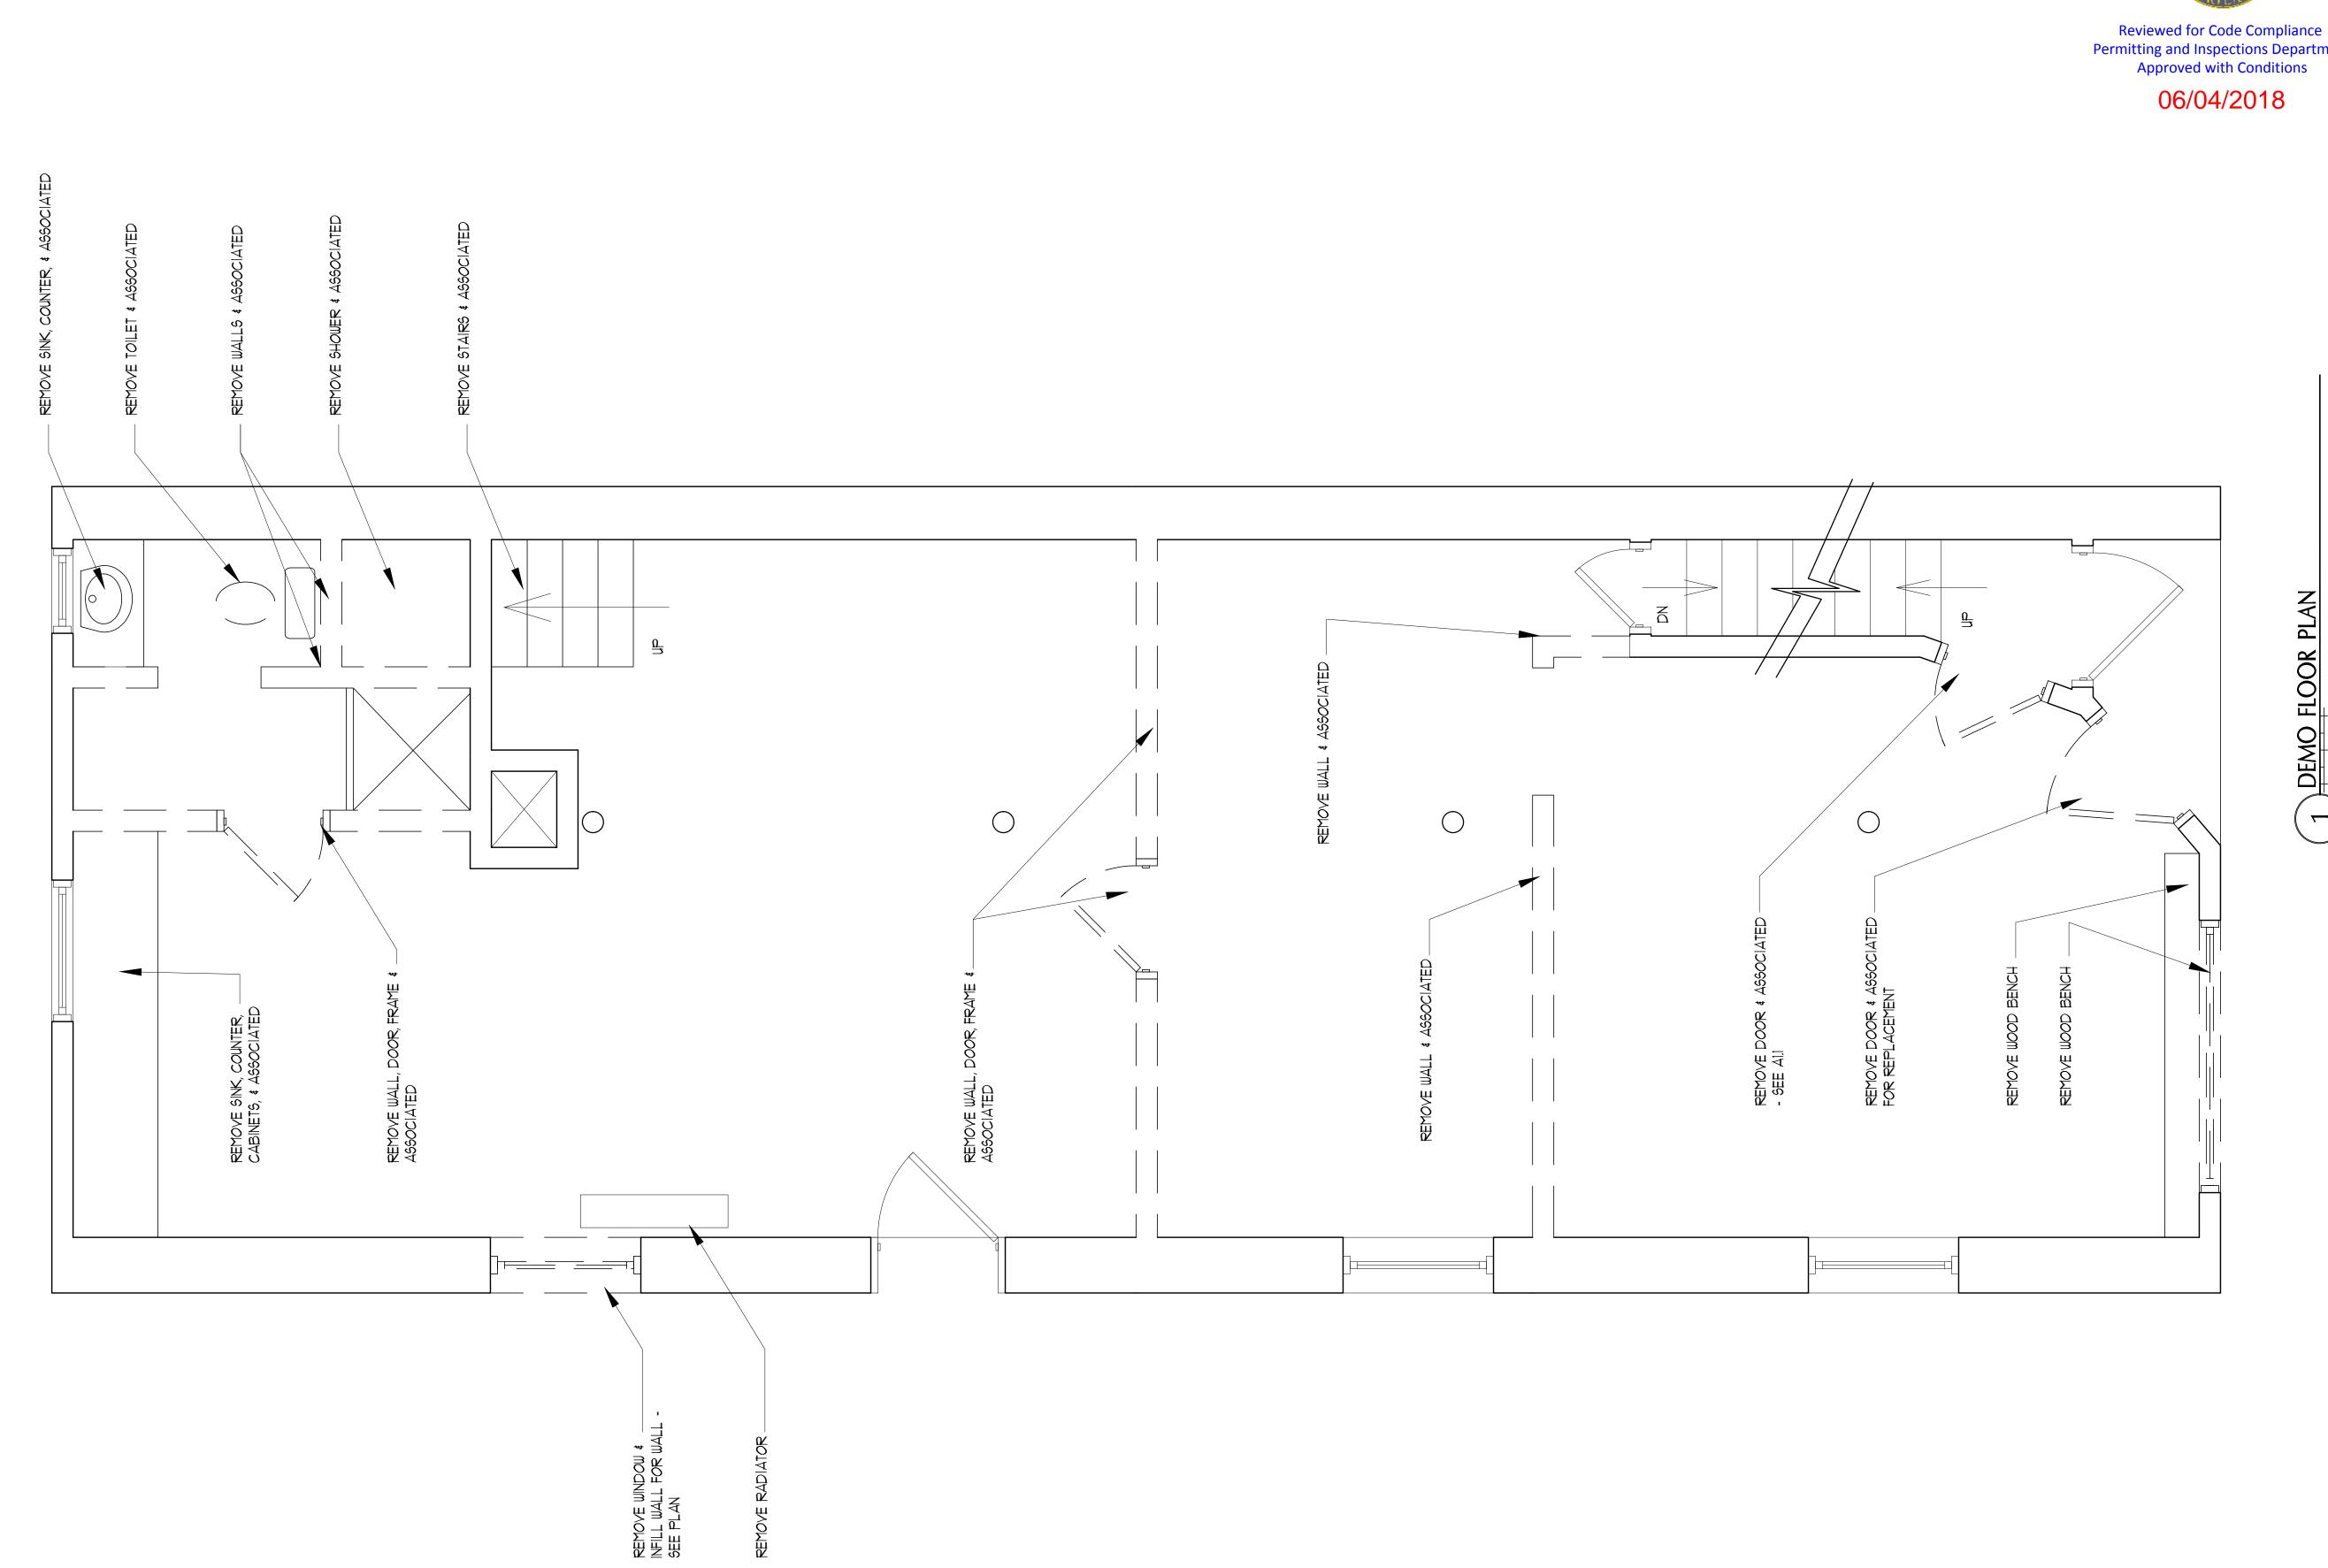
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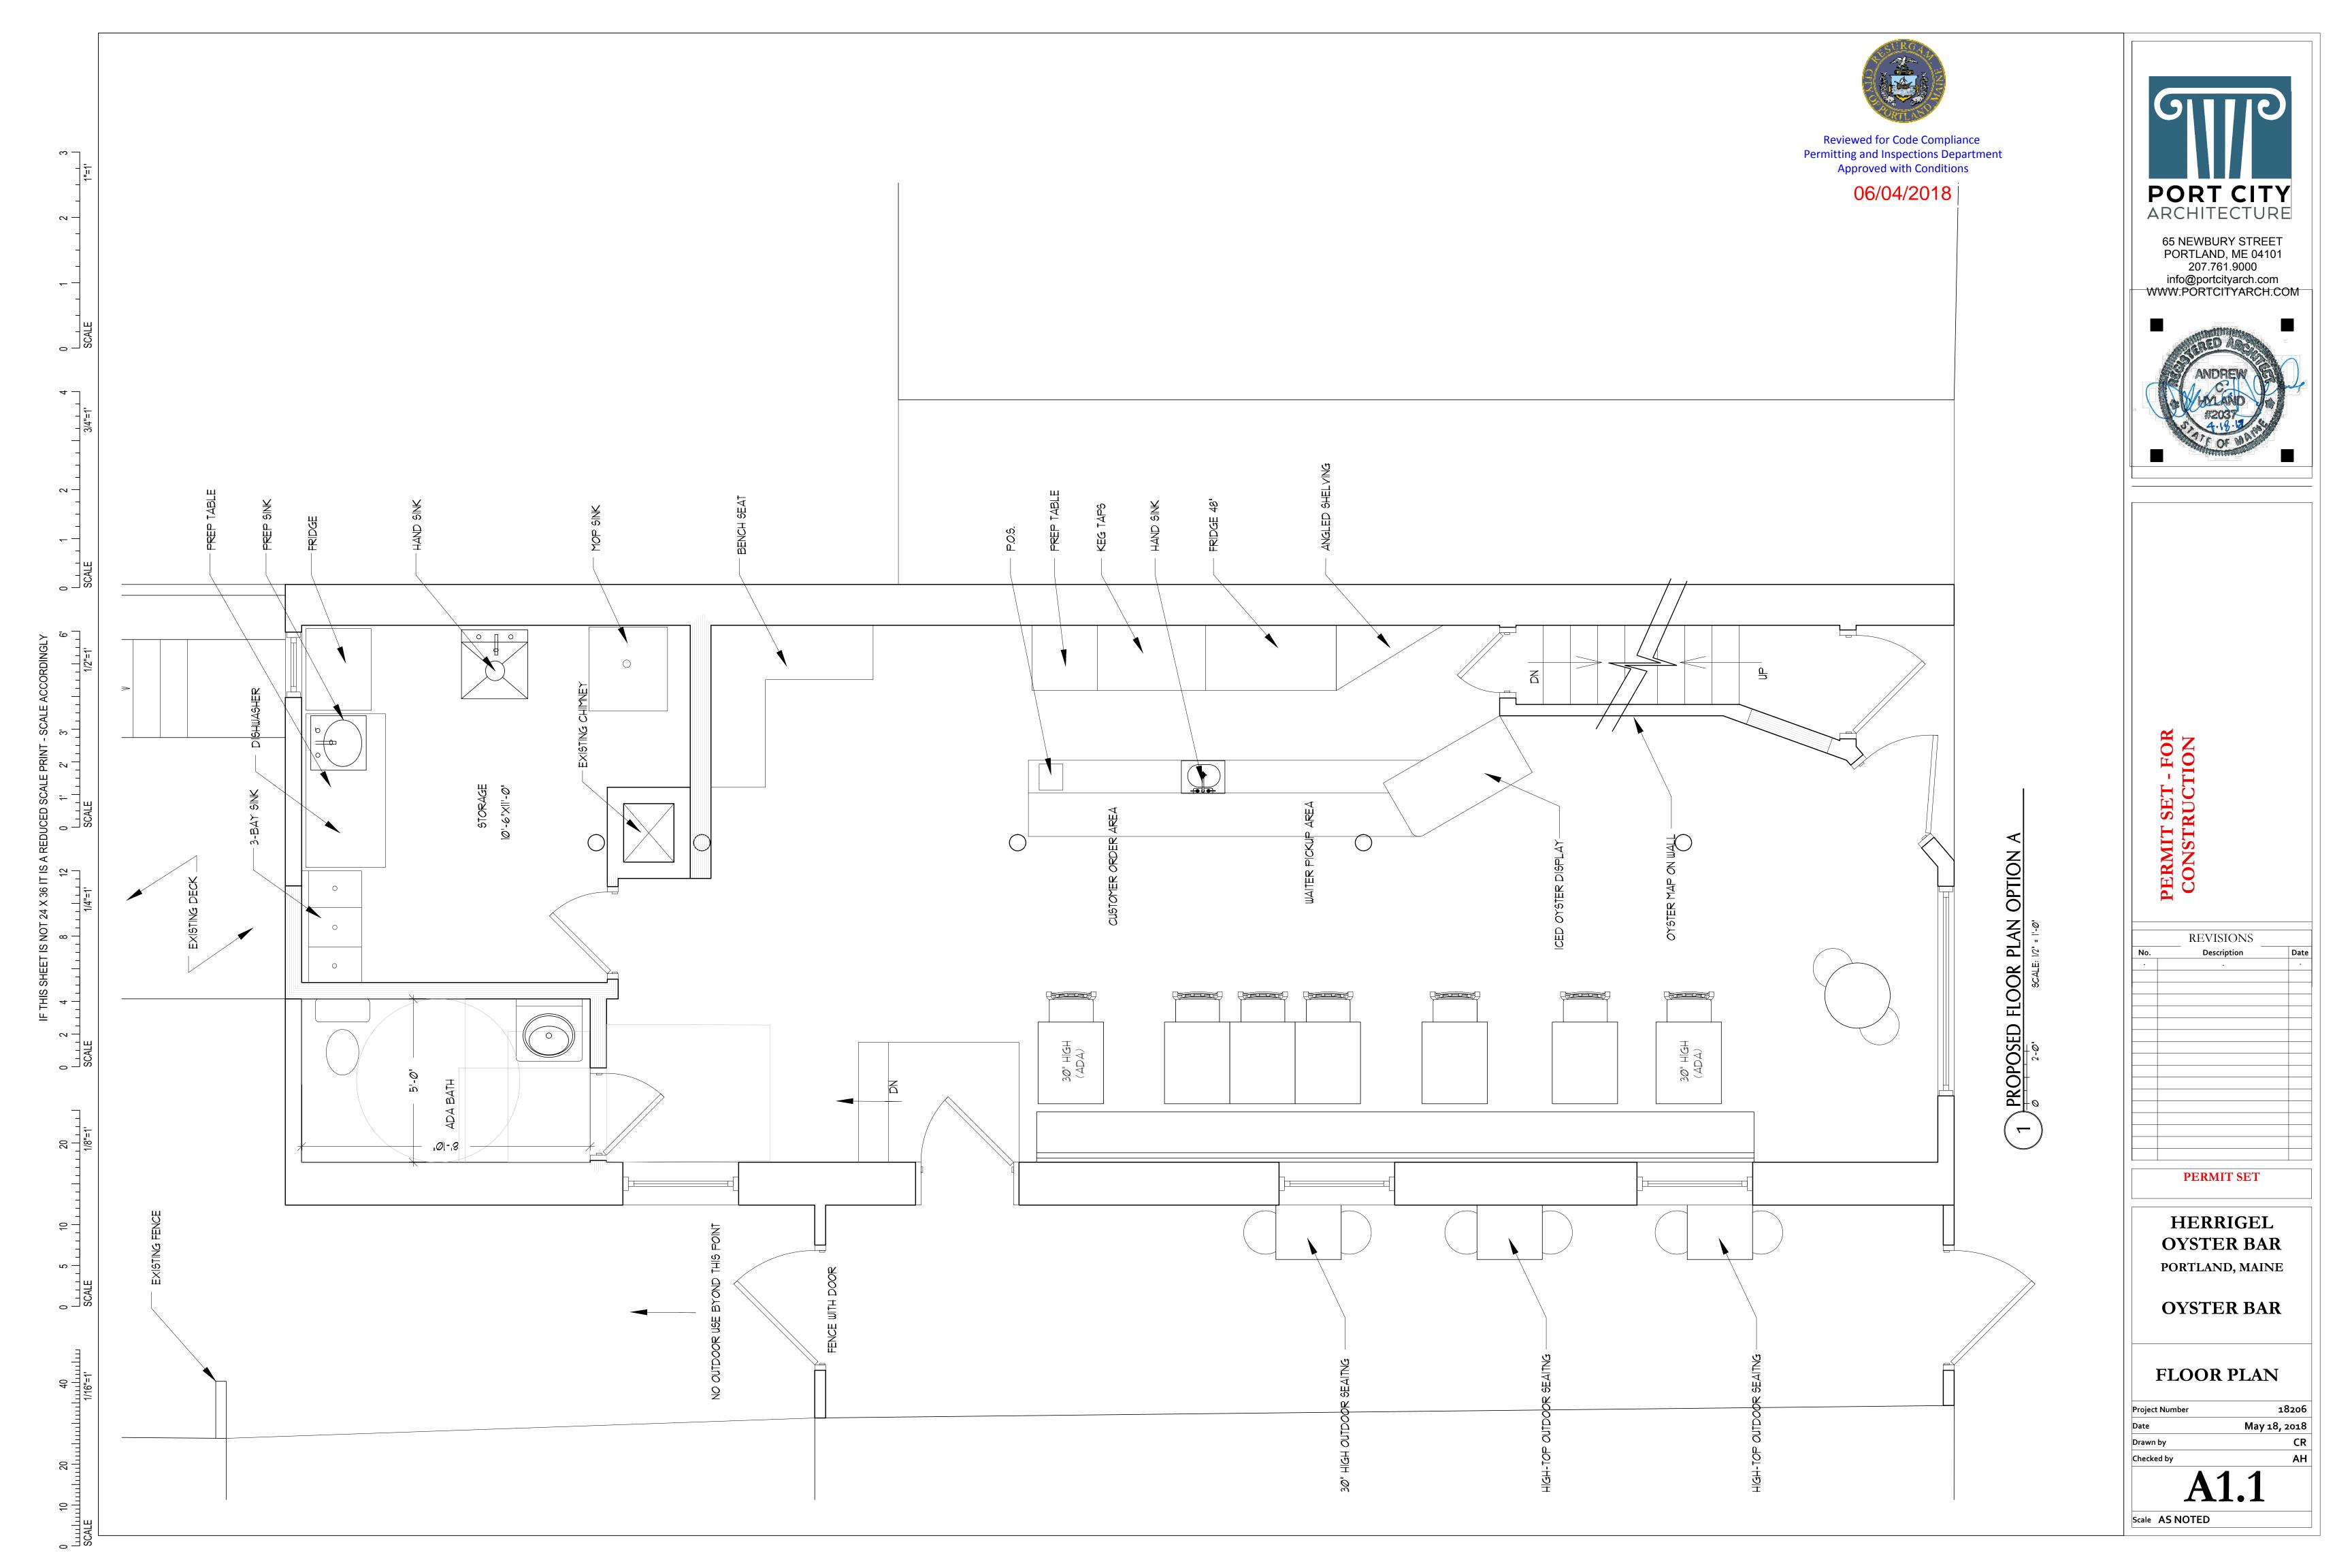
DEMO PLANS

May 18, 2018


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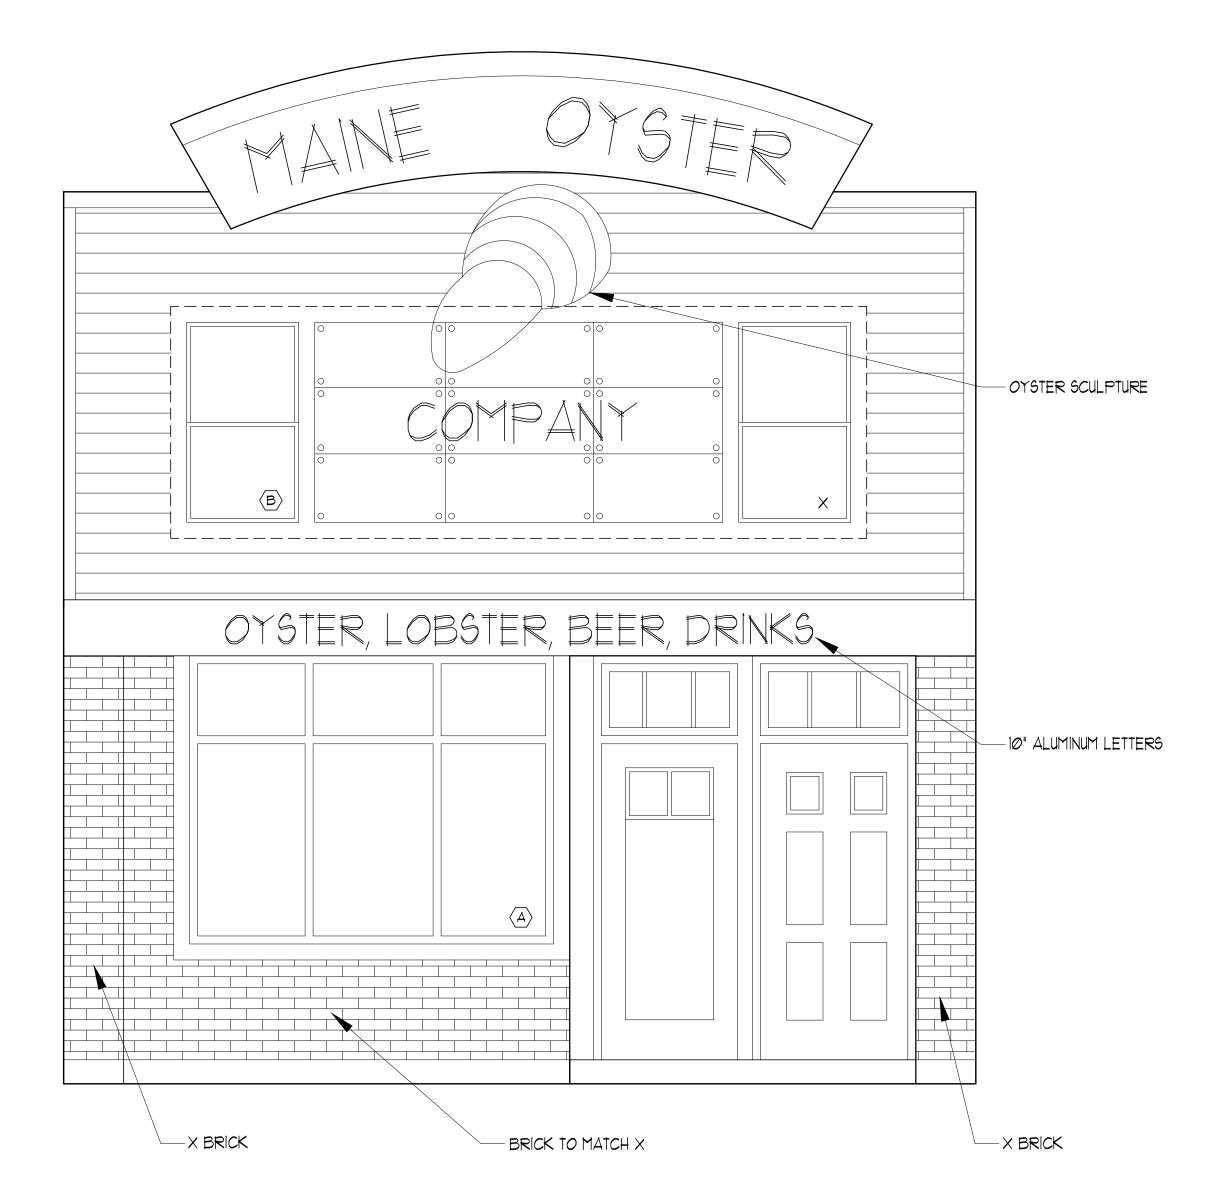
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OYSTER BAR


ELEVATIONS

Project Number	18206
Date	May 18, 2018
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Checked by	AH
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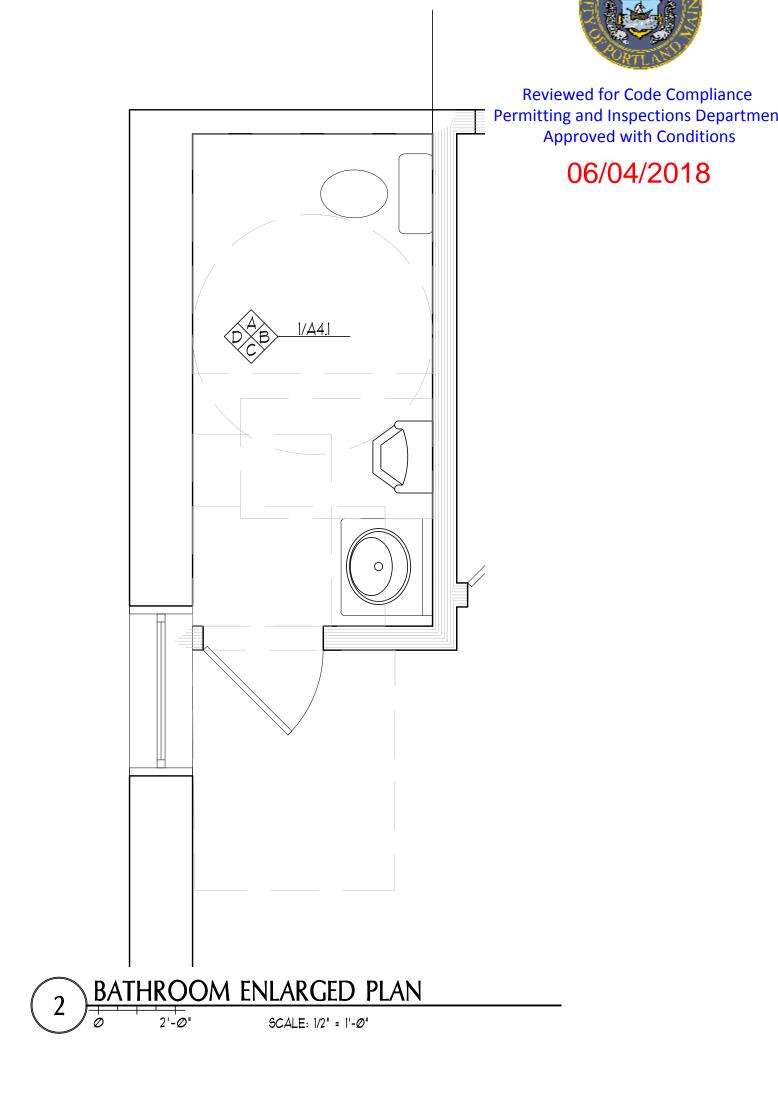
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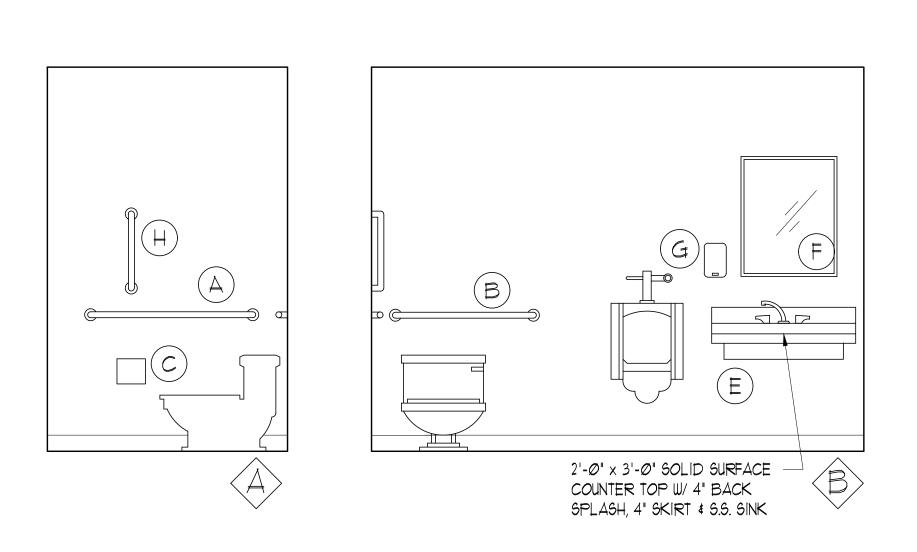



EL	EVATION		
	2'-Ø"	SCALE: 1/2" = 1'-0"	

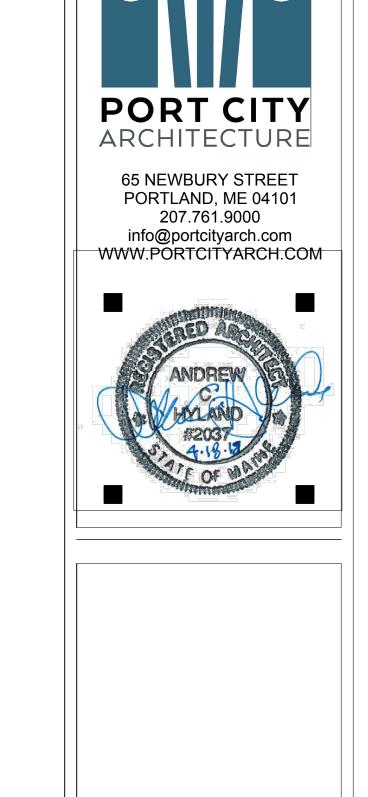


	BATHROOM ACCESSORIES SCHEDULE		
NUMBER	ITEM	MOUNTING HEIGHT	NOTES
A	3'-6" 1/2" DIA GRAB BAR	£ @ 2'-1Ø" AFF	
B	3'-0" 1/2" DIA GRAB BAR	€ @ 2'-1Ø" AFF	
©	TOILET PAPER DISPENSER	€ @ 2Ø" AFF	
D	PAPER TOWEL DISPENSER	TOWELS @ 42" AFF	
Œ	LAY. GAURD		
F	24" x 36" MIRROR	BOTTOM @ 40" AFF	
G	SOAP DISPENSER		
H	2'-4" 1/2" DIA GRAB BAR	BOT @ 3'-6" AFF	3ذ

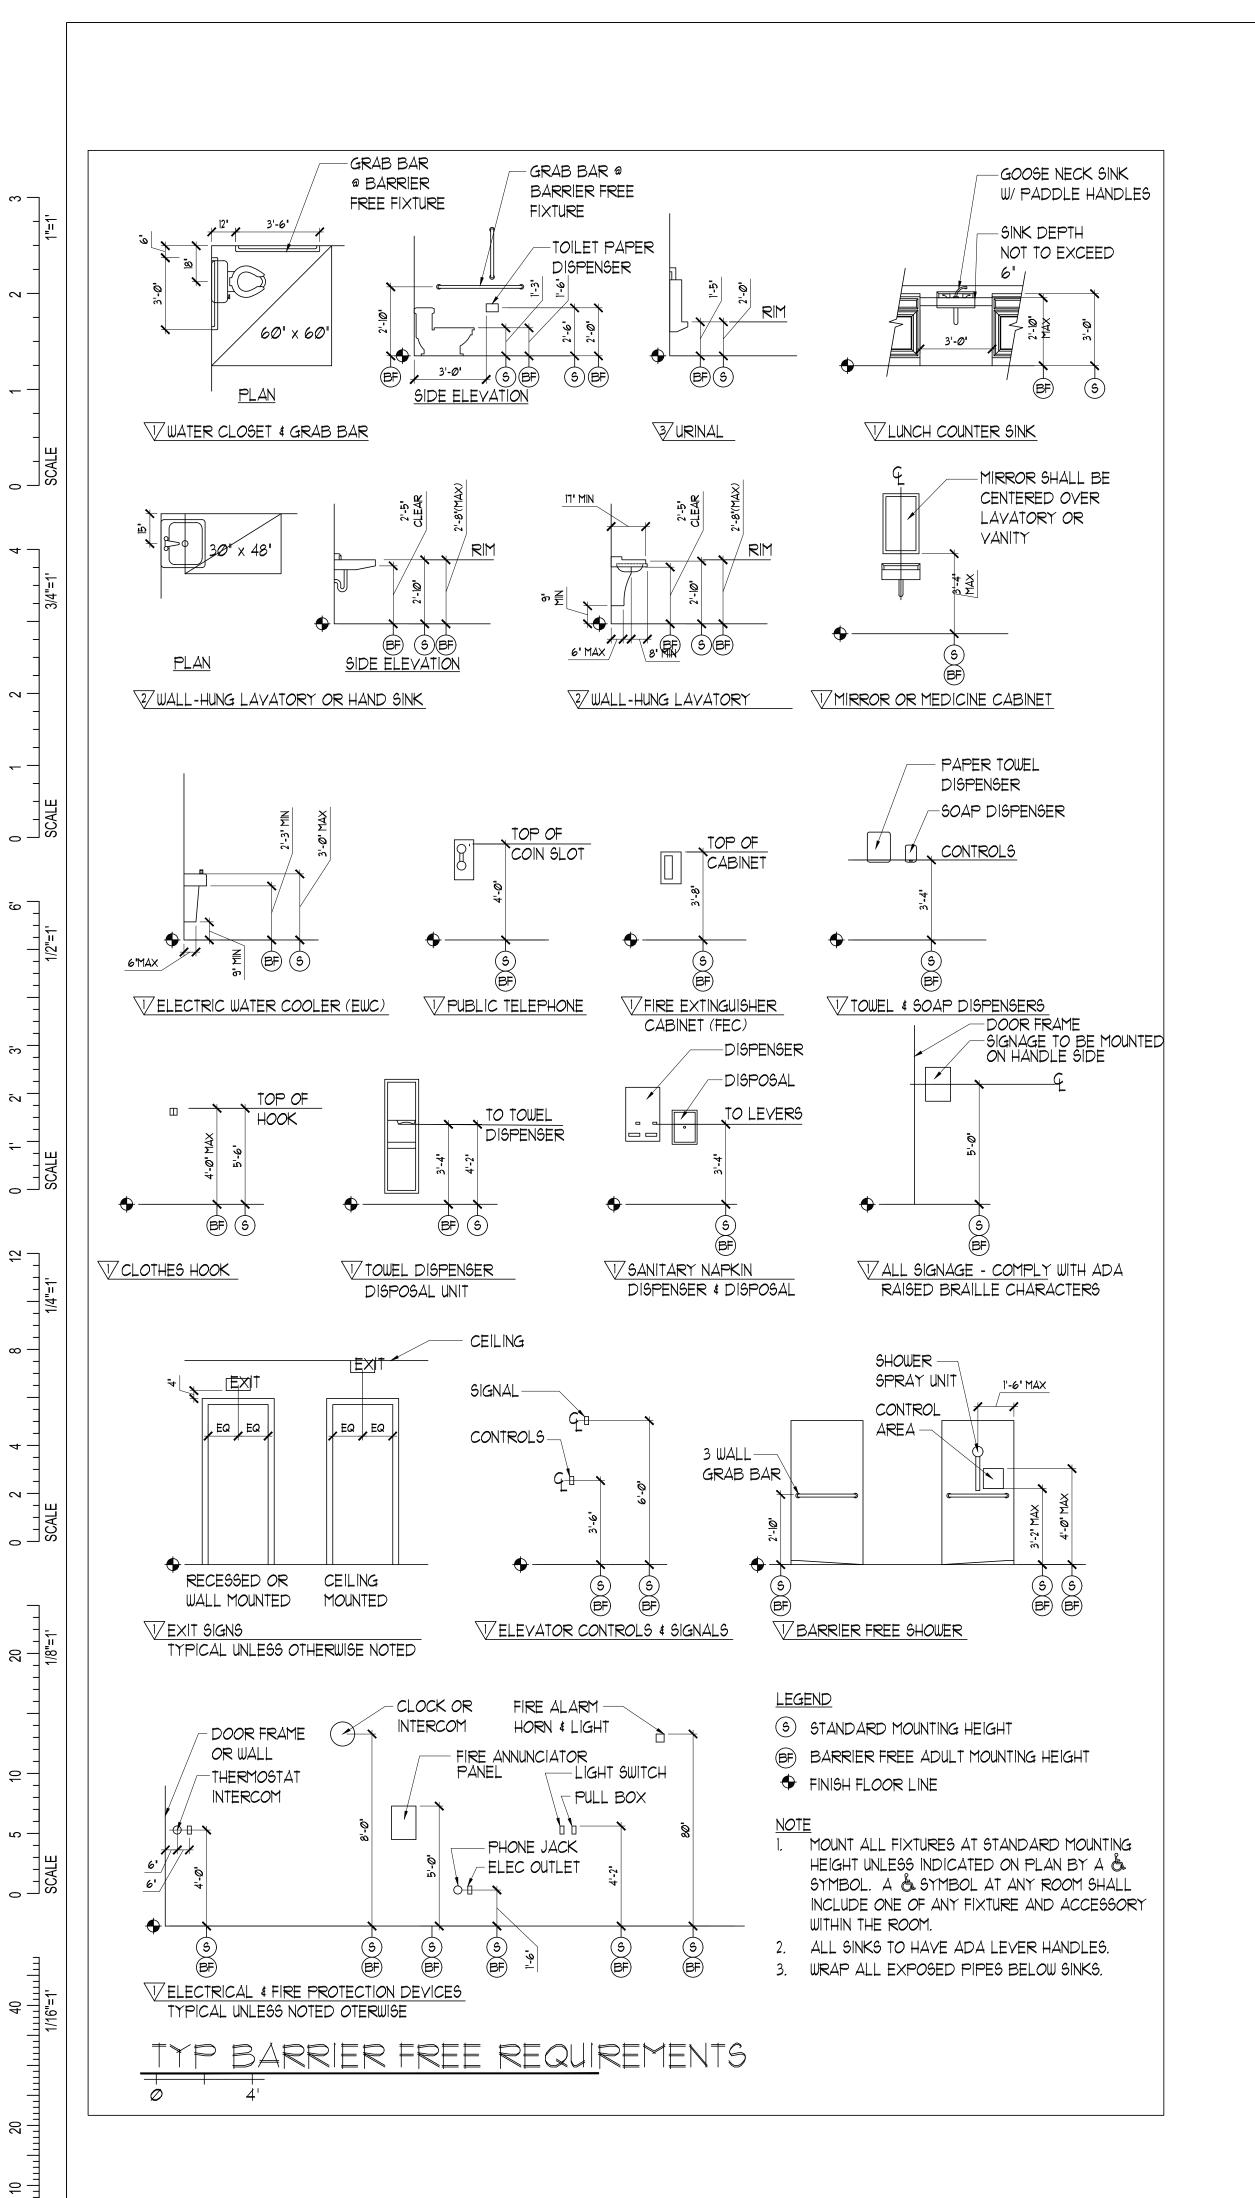




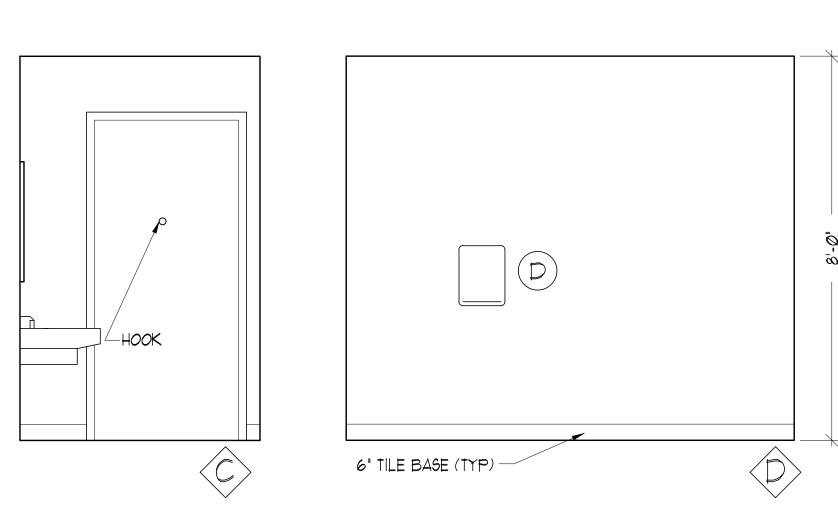



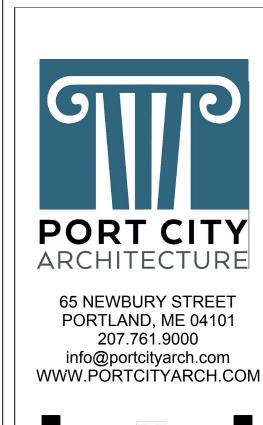

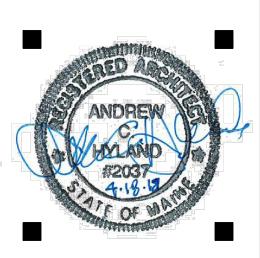

PERMIT SET - FOR CONSTRUCTION

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HERRIGEL OYSTER BAR PORTLAND, MAINE

OYSTER BAR

INTERIOR ELEVATIONS

Project Number 18206

Date May 18, 2018

Drawn by CR

Checked by AH

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