
# The Schlotterbeck Block

117 Preble Street, Portland, Maine

Level III Site Plan and Subdivision Plan

Revised per Conditions of Approval: February 25, 2015

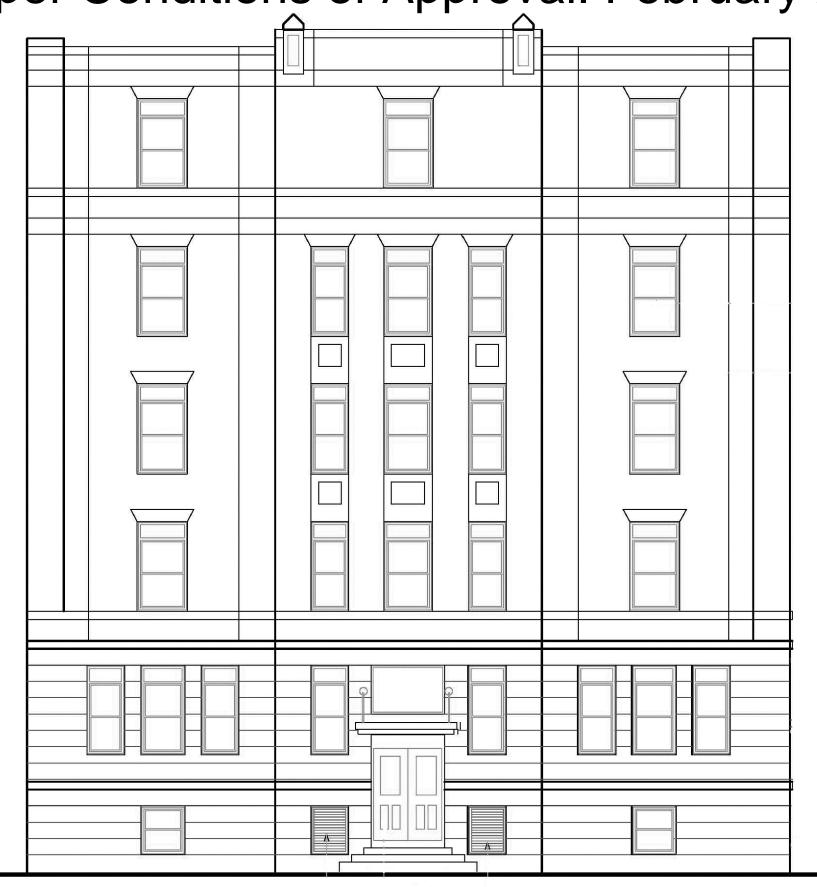

### PREPARED BY:

#### LANDSCAPE ARCHITECT AND SITE PLANNER:

MITCHELL & ASSOCIATES 70 CENTER STREET PORTLAND, MAINE 04101 PHONE: 207.774.4427 FAX: 207.874.2460 CONTACT: MICHAEL W. KING, RLA

E-MAIL: MKING@MITCHELLASSOCIATES.BIZ

#### ARCHITECT:

GODUTI-THOMAS ARCHITECTS 44 OAK STREET, #2 PORTLAND, MAINE 04101 PHONE: 207.775.3184 CONTACT: RICHARD GODUTI, NCARB EMAIL: GTARICK@GMAIL.COM

#### **CIVIL ENGINEER:**

RANSOM CONSULTING ENGINEERS 400 COMMERCIAL STREET, NO.4 PORTLAND, MAINE 04101 PHONE: 207.772.2891 CONTACT: STEPHEN BRADSTREET, P.E. E-MAIL: STEPEHN.BRADSTREET@RANSOMENV.COM

#### LAND SURVEYOR

OWEN HASKELL, INC. 390 U.S. ROUTE ONE, SUITE 10 FALMOUTH, MAINE 04105 PHONE: 207.774.0424 CONTACT: JOHN SWAN, P.L.S.

#### TRAFFIC ENGINEER

GORRILL-PALMER 15 SHAKER ROAD GORHAM, MAINE 04038 PHONE: 207.675.6910 CONTACT: RANDALL DUNTON, P.E.

## UTILITIES:

#### **ELECTRIC**:

CENTRAL MAINE POWER ELECTRICAL DISTRIBUTION ENGINEERING 162 CANCO ROAD PORTLAND, MAINE 04103 PHONE: 207.842.2367 CONTACT: JAMIE COUGH E-MAIL: JAMES.COUGH@CMPCO.COM

#### WATER:

PORTLAND WATER DISTRICT 225 DOUGLASS STREET P.O. BOX 3553 PORTLAND, MAINE 04104-3553 PHONE: 207.774.5961 x.3199 207.761.8307 CONTACT: GLISSEN HAVU E-MAIL: MEANS@PWD.ORG

# SANITARY SEWER:

CITY OF PORTLAND PUBLIC SERVICES DEPARTMENT 55 PORTLAND STREET PORTLAND, MAINE 04101 PHONE: 207.874.8832 207.874.8816 CONTACT: DAVID MARGOLIS-PINEO E-MAIL: DMP@PORTLANDMAINE.GOV

TIME WARNER CABLE OF MAINE 118 JOHNSON ROAD PORTLAND, MAINE 04102 PHONE: 207.253.2324

CONTACT: MARK PELLETIER, CONSTRUCTION PROJECT COORDINATOR E-MAIL: MARK.PELLETIER@TWCABLE.COM

NATURAL GAS:

UNITIL SERVICE CORPORATION 1075 FOREST AVENUE PORTLAND, MAINE 04103 PHONE: 207.541.2505 CONTACT: BRIDGET MATHERS

## OWNER AND APPLICANT

SCHLOTTERBECK BLOCK LLC 77 SPRUCE STREET PORTLAND, MAINE 04101 PHONE: 207.650.8979

#### PERMITS:

TYPE OF PERMIT: **GOVERNING BODY:** STATUS: SITE PLAN REVIEW: CITY OF PORTLAND SUBMITTED: OCTOBER 5, 2015 389 CONGRESS STREET 4TH FLOOR PORTLAND, MAINE 04101 TEL: 207.874.8728

CONTACT: RICHARD KNOWLAND

E-MAIL: RWK@PORTLANDMAINE.GOV

#### SITE LOCATION MAP:



SHEET	INDEX:
SHEET	TITLE
1	COVER PAGE BOUNDARY AND TOPOGRAPHIC SURVEY
1 OF 1	SUBDIVISION PLAT
L1.0	EXISTING CONDITIONS PLAN
L1.1	CONSTRUCTION MANAGEMENT PLAN
L2.0	LAYOUT PLAN
L2.1	DETAIL SITE PLANS: SIDEWALK RAMPS
L3.0	GRADING, DRAINAGE AND UTILITIES PLAN
L4.0 L5.0	EROSION AND SEDIMENT CONTROL PLAN PLANTING PLAN
L6.0	SITE DETAILS
L6.1	SITE DETAILS
L6.2	SITE DETAILS
L6.3	SITE DETAILS
L7.0	LIGHTING PHOTOMETRICS PLAN
L7.1	LIGHTING PHOTOMETRICS PLAN: WITHOUT STREET LIGHTS
SW-1	PRE-DEVLOPMENT STORMWATER DRAINAGE PLAN
014.0	(TO BE SUBMITTED WITH STORMWATER REPORT)
SW-2	POST-DEVELOPMENT STORMWATER DRAINAGE PLAN (TO BE SUBMITTED WITH STORMWATER REPORT)
	(TO BE SUBMITTED WITH STORMWATER REPORT)
A1.1	FIRST FLOOR PLAN AND LOWER FLOOR PLAN
A1.2	2nd - 3th FLOOR PLANS
A1.3	4th - 5th FLOOR PLANS
A1.4	ROOF PLAN
A2.1	BUILDING ELEVATIONS
A2.2	BUILDING ELEVATIONS
A2.3	MASONRY REPAIRS ELEVATIONS
A2.4	MASONRY REPAIRS ELEVATIONS



DATE of APPROVAL 12.15.2015


CITY OF PORTLAND APPROVED SITE PLAN


Subject to Conditions of Approval

and Standard Conditions

PLANNER Shukria Wiar

PROJECT NO. 2015-174

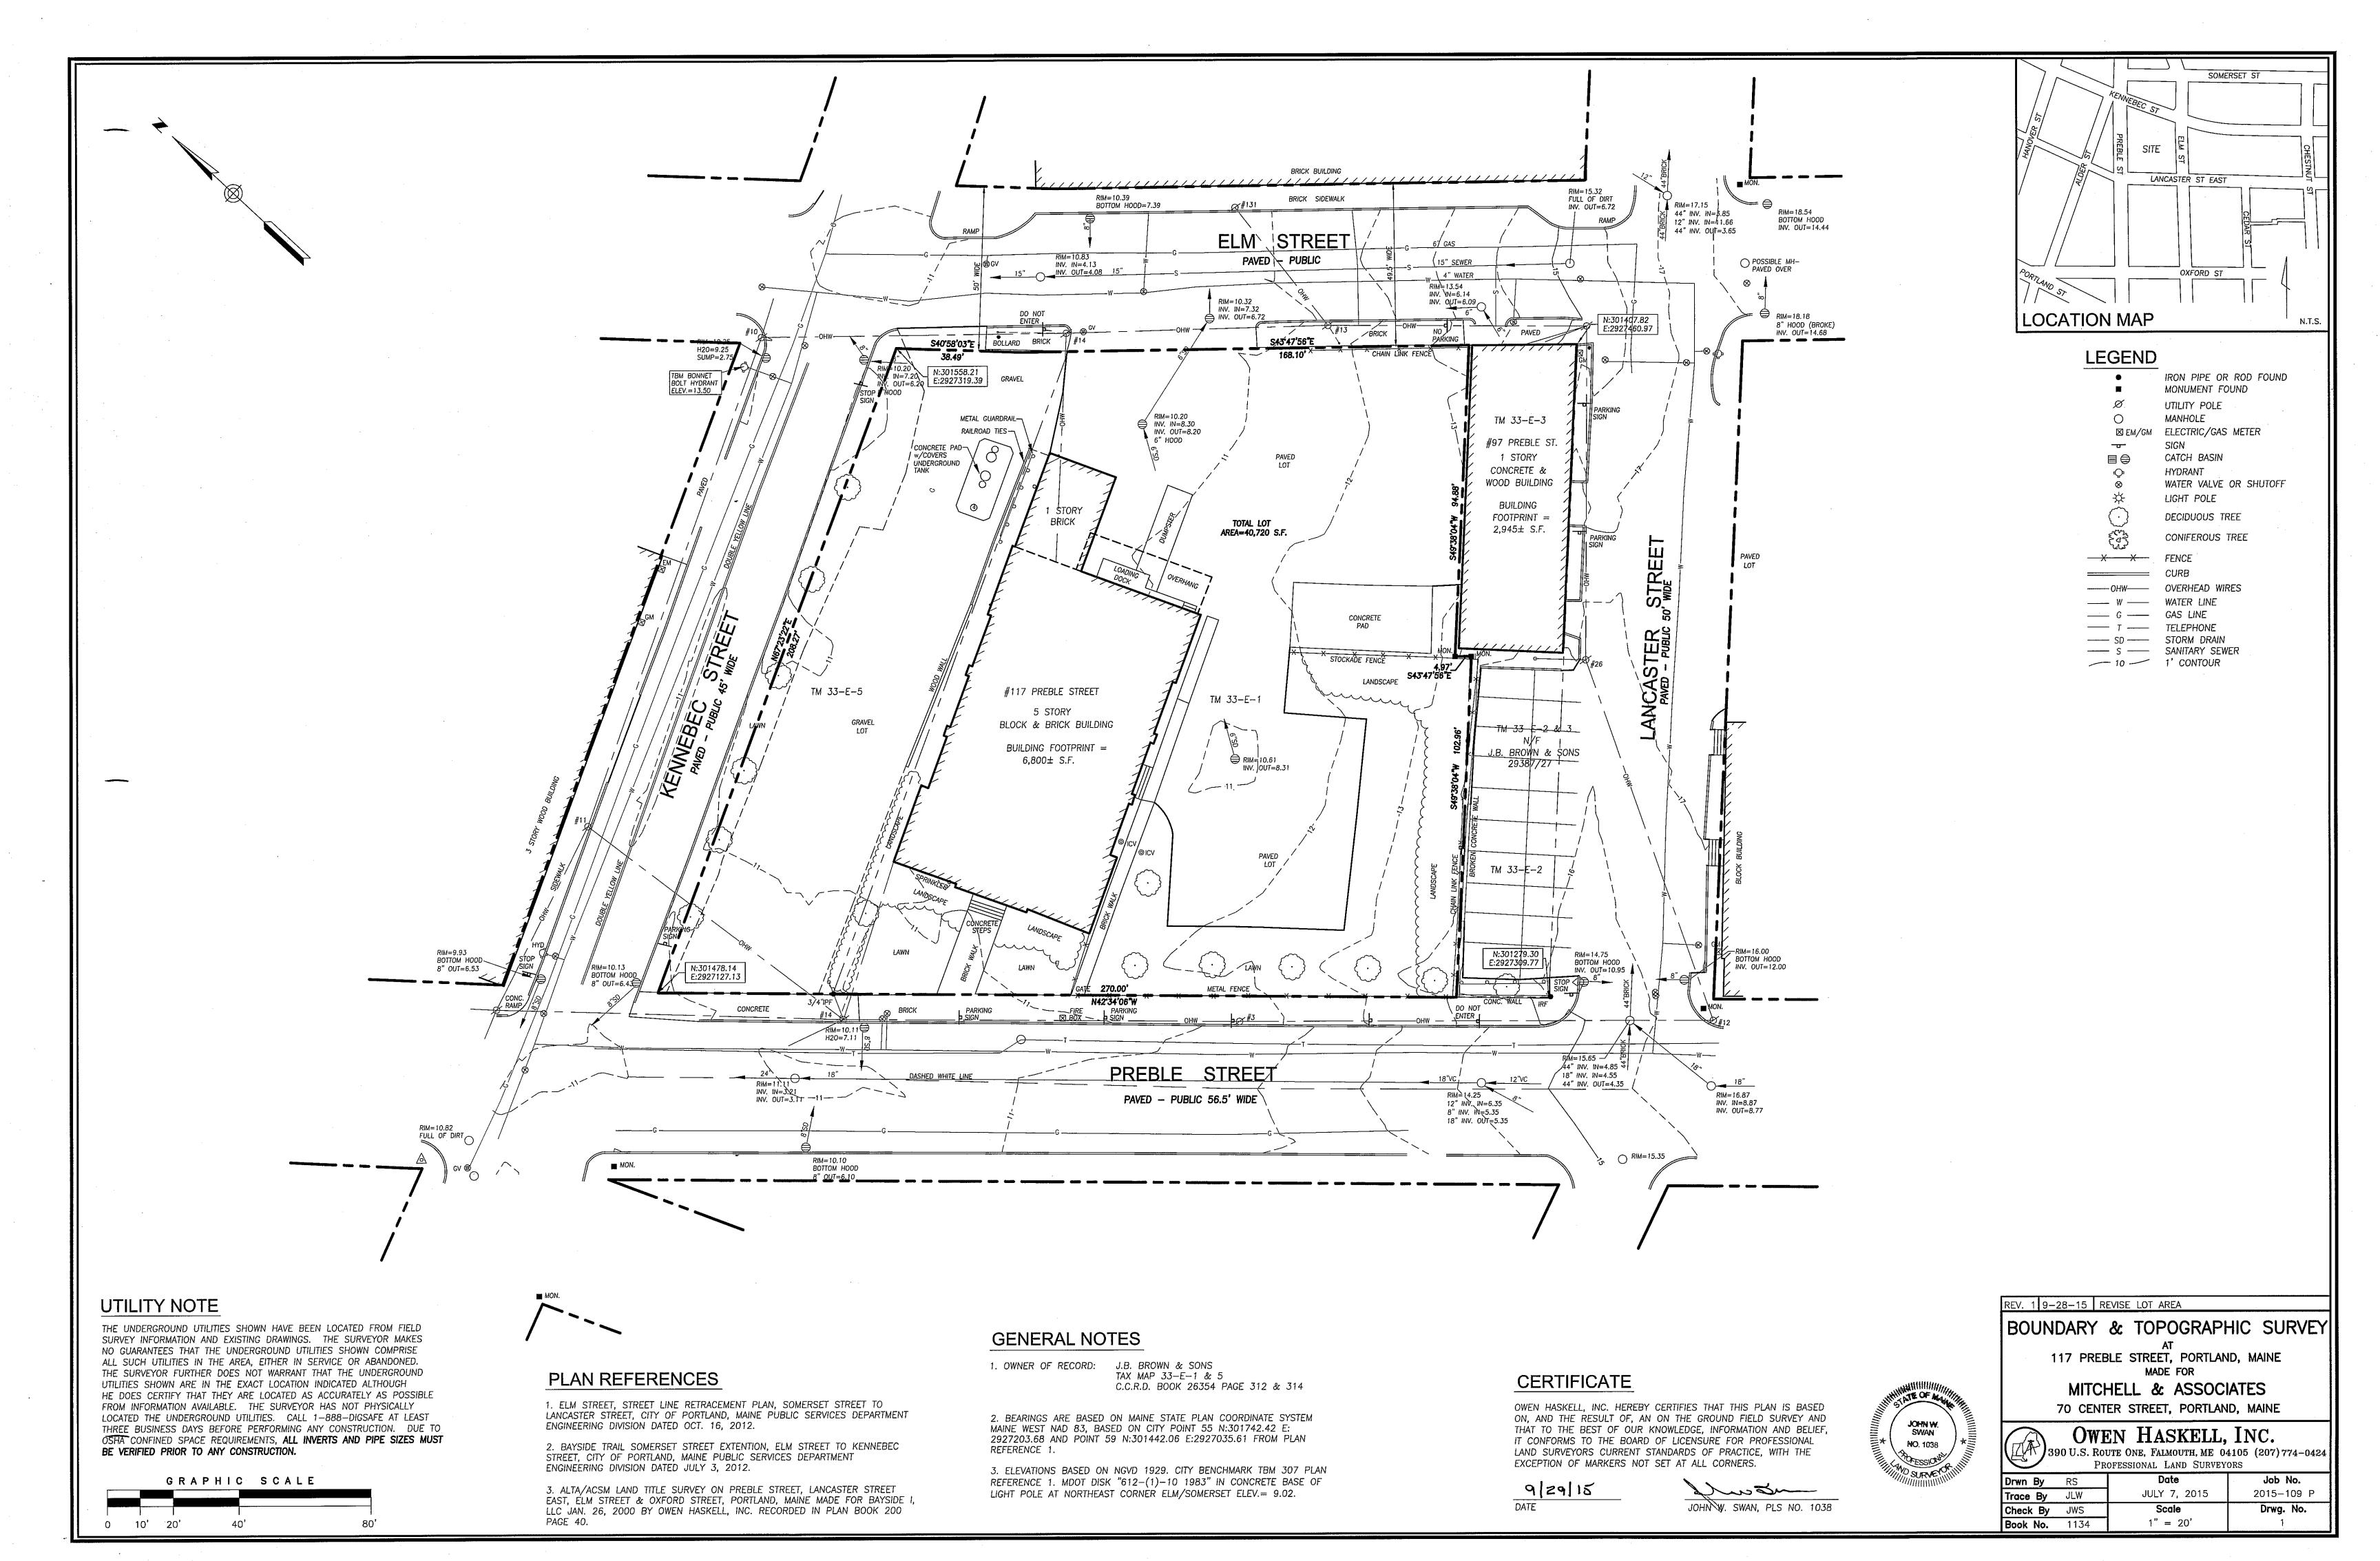

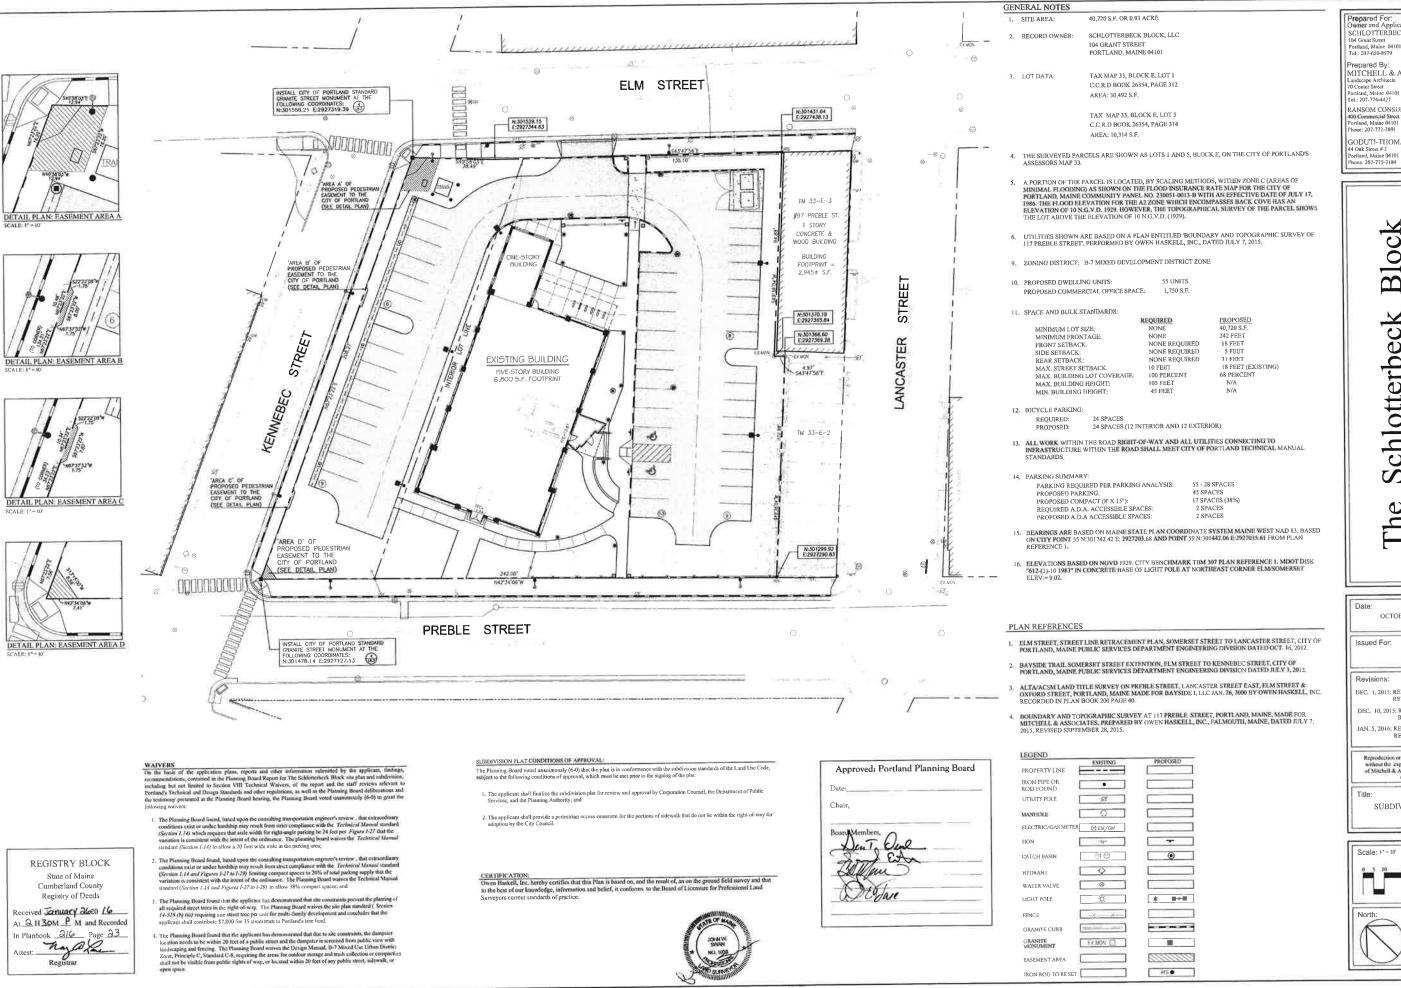

Prepared For: CHLOTTERBECK BLOCK L.L.C.

Portland, Maine 04101 Tel.: 207-650-8979

Prepared By: MITCHELL & ASSOCIATES

RANSOM CONSULTING ENGINEERS ial Street #4

GODUTI-THOMAS ARCHITECTS 44 Oak Street # 2 Portland, Maine 04101 Phone: 207-775-3184

Mai Portland,

0 M S

chlotterbe S

Street

Preble

117

OCTOBER 5, 2015


Issued For


DEC 1, 2015: REVISED PER STAFF REVIEW COMMENTS

DEC: 10, 2015: REVISED PER STAFF REVIEW COMMENTS JAN- 5, 2016; REVISED PER STAFF REVIEW COMMENTS

Reproduction or reuse of this document without the expressed written consent of Mitchell & Associates is prohibited. © 2015

SUBDIVISION PLAN

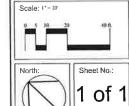

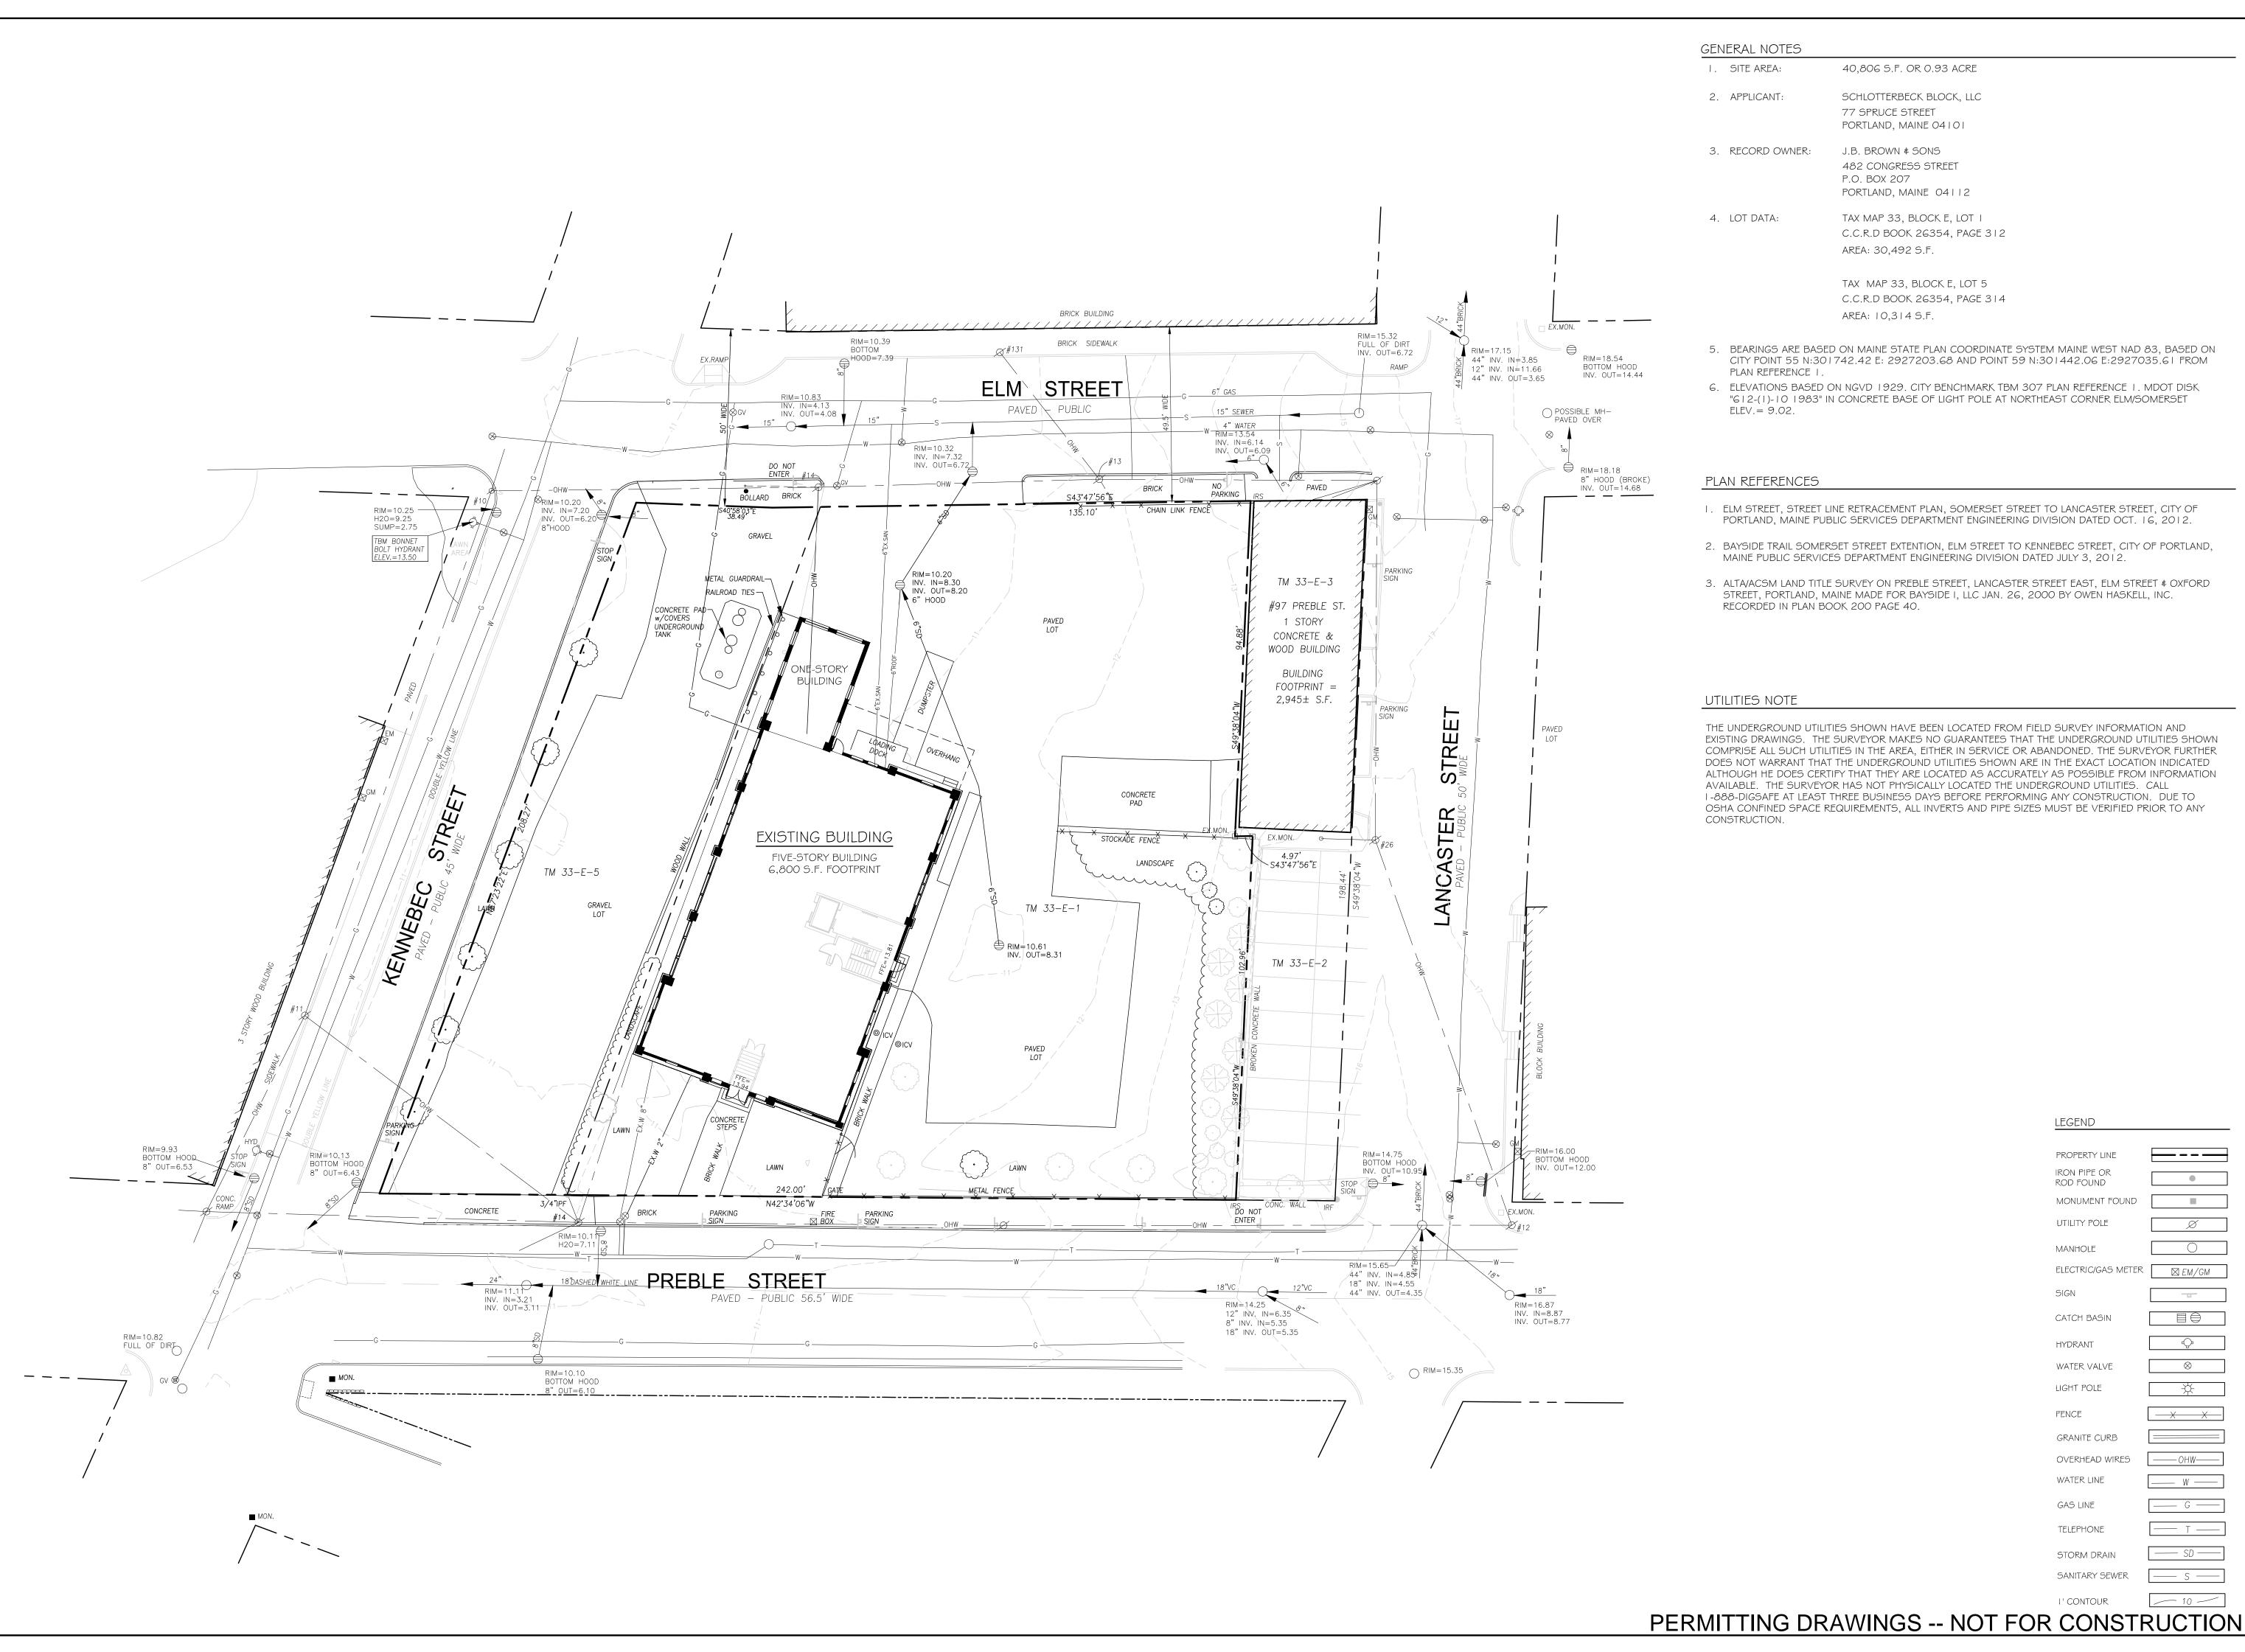

CITY POINT 55 N:30 | 742.42 E: 2927203.68 AND POINT 59 N:30 | 442.06 E:2927035.6 | FROM

"612-(1)-10 1983" IN CONCRETE BASE OF LIGHT POLE AT NORTHEAST CORNER ELM/SOMERSET

- I. ELM STREET, STREET LINE RETRACEMENT PLAN, SOMERSET STREET TO LANCASTER STREET, CITY OF PORTLAND, MAINE PUBLIC SERVICES DEPARTMENT ENGINEERING DIVISION DATED OCT. 16, 2012.
- STREET, PORTLAND, MAINE MADE FOR BAYSIDE I, LLC JAN. 26, 2000 BY OWEN HASKELL, INC.

EXISTING DRAWINGS. THE SURVEYOR MAKES NO GUARANTEES THAT THE UNDERGROUND UTILITIES SHOWN COMPRISE ALL SUCH UTILITIES IN THE AREA, EITHER IN SERVICE OR ABANDONED. THE SURVEYOR FURTHER DOES NOT WARRANT THAT THE UNDERGROUND UTILITIES SHOWN ARE IN THE EXACT LOCATION INDICATED ALTHOUGH HE DOES CERTIFY THAT THEY ARE LOCATED AS ACCURATELY AS POSSIBLE FROM INFORMATION AVAILABLE. THE SURVEYOR HAS NOT PHYSICALLY LOCATED THE UNDERGROUND UTILITIES. CALL I -888-DIGSAFE AT LEAST THREE BUSINESS DAYS BEFORE PERFORMING ANY CONSTRUCTION. DUE TO OSHA CONFINED SPACE REQUIREMENTS, ALL INVERTS AND PIPE SIZES MUST BE VERIFIED PRIOR TO ANY

Prepared For: Owner and Applicant: SCHLOTTERBECK BLOCK L.L.C. 104 Grant Street Portland, Maine 04101 Tel.: 207-650-8979 Prepared By: MITCHELL & ASSOCIATES Landscape Architects 70 Center Street Portland, Maine 04101 Tel.: 207-774-4427 RANSOM CONSULTING ENGINEERS 400 Commercial Street #4 Portland, Maine 04101 Phone: 207-772-2891

> 44 Oak Street # 2 Portland, Maine 04101

Phone: 207-775-3184

GODUTI-THOMAS ARCHITECTS

0

Prebl  $\overline{\phantom{a}}$ 

OCTOBER 5, 2015 Issued For:

The

# Revisions:

\_\_\_\_ DEC. 1, 2015: REVISED PER STAFF REVIEW COMMENTS DEC. 10, 2015: REVISED PER STAFF

> Reproduction or reuse of this document without the expressed written consent of Mitchell & Associates is prohibited.

FEB. 25, 2016: REVISED PER CONDITIONS

OF APPROVAL

REVIEW COMMENTS

**EXISTING** CONDITION PLAN


Scale: 1" = 20' Sheet No.: North:


**©** 

 $\overline{\phantom{a}}$ 

— ОНW——

\_\_\_ G \_\_\_

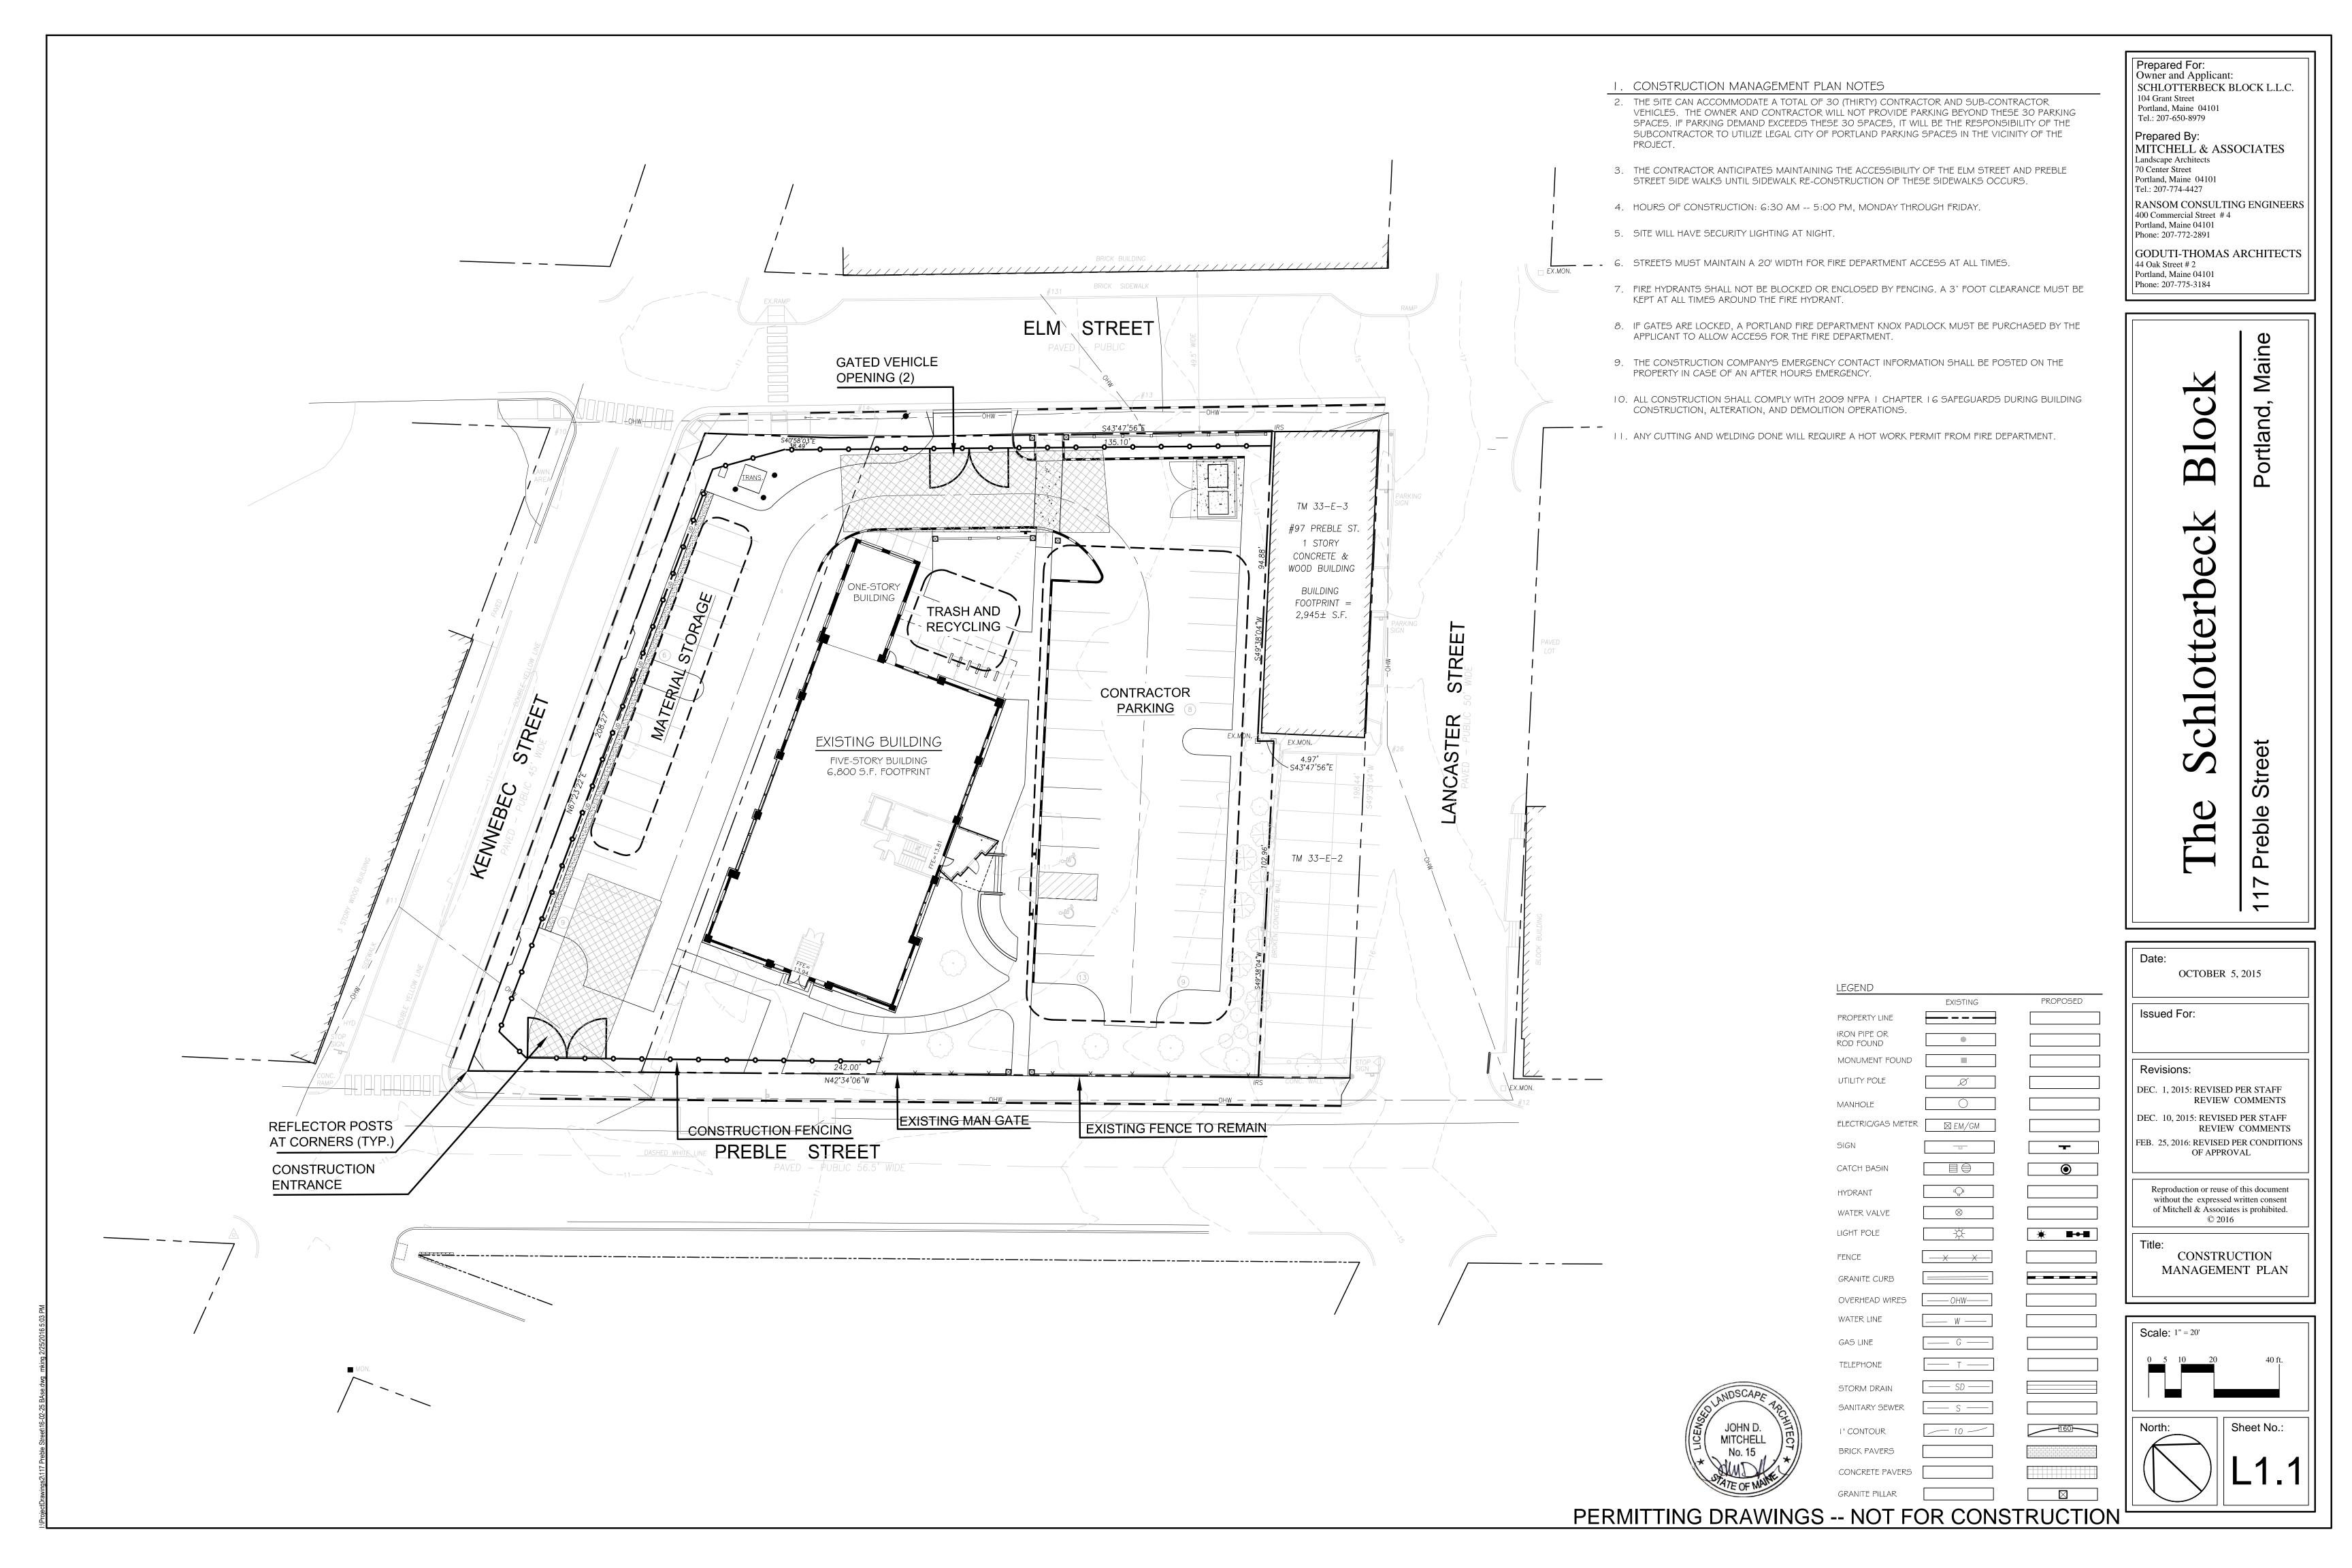

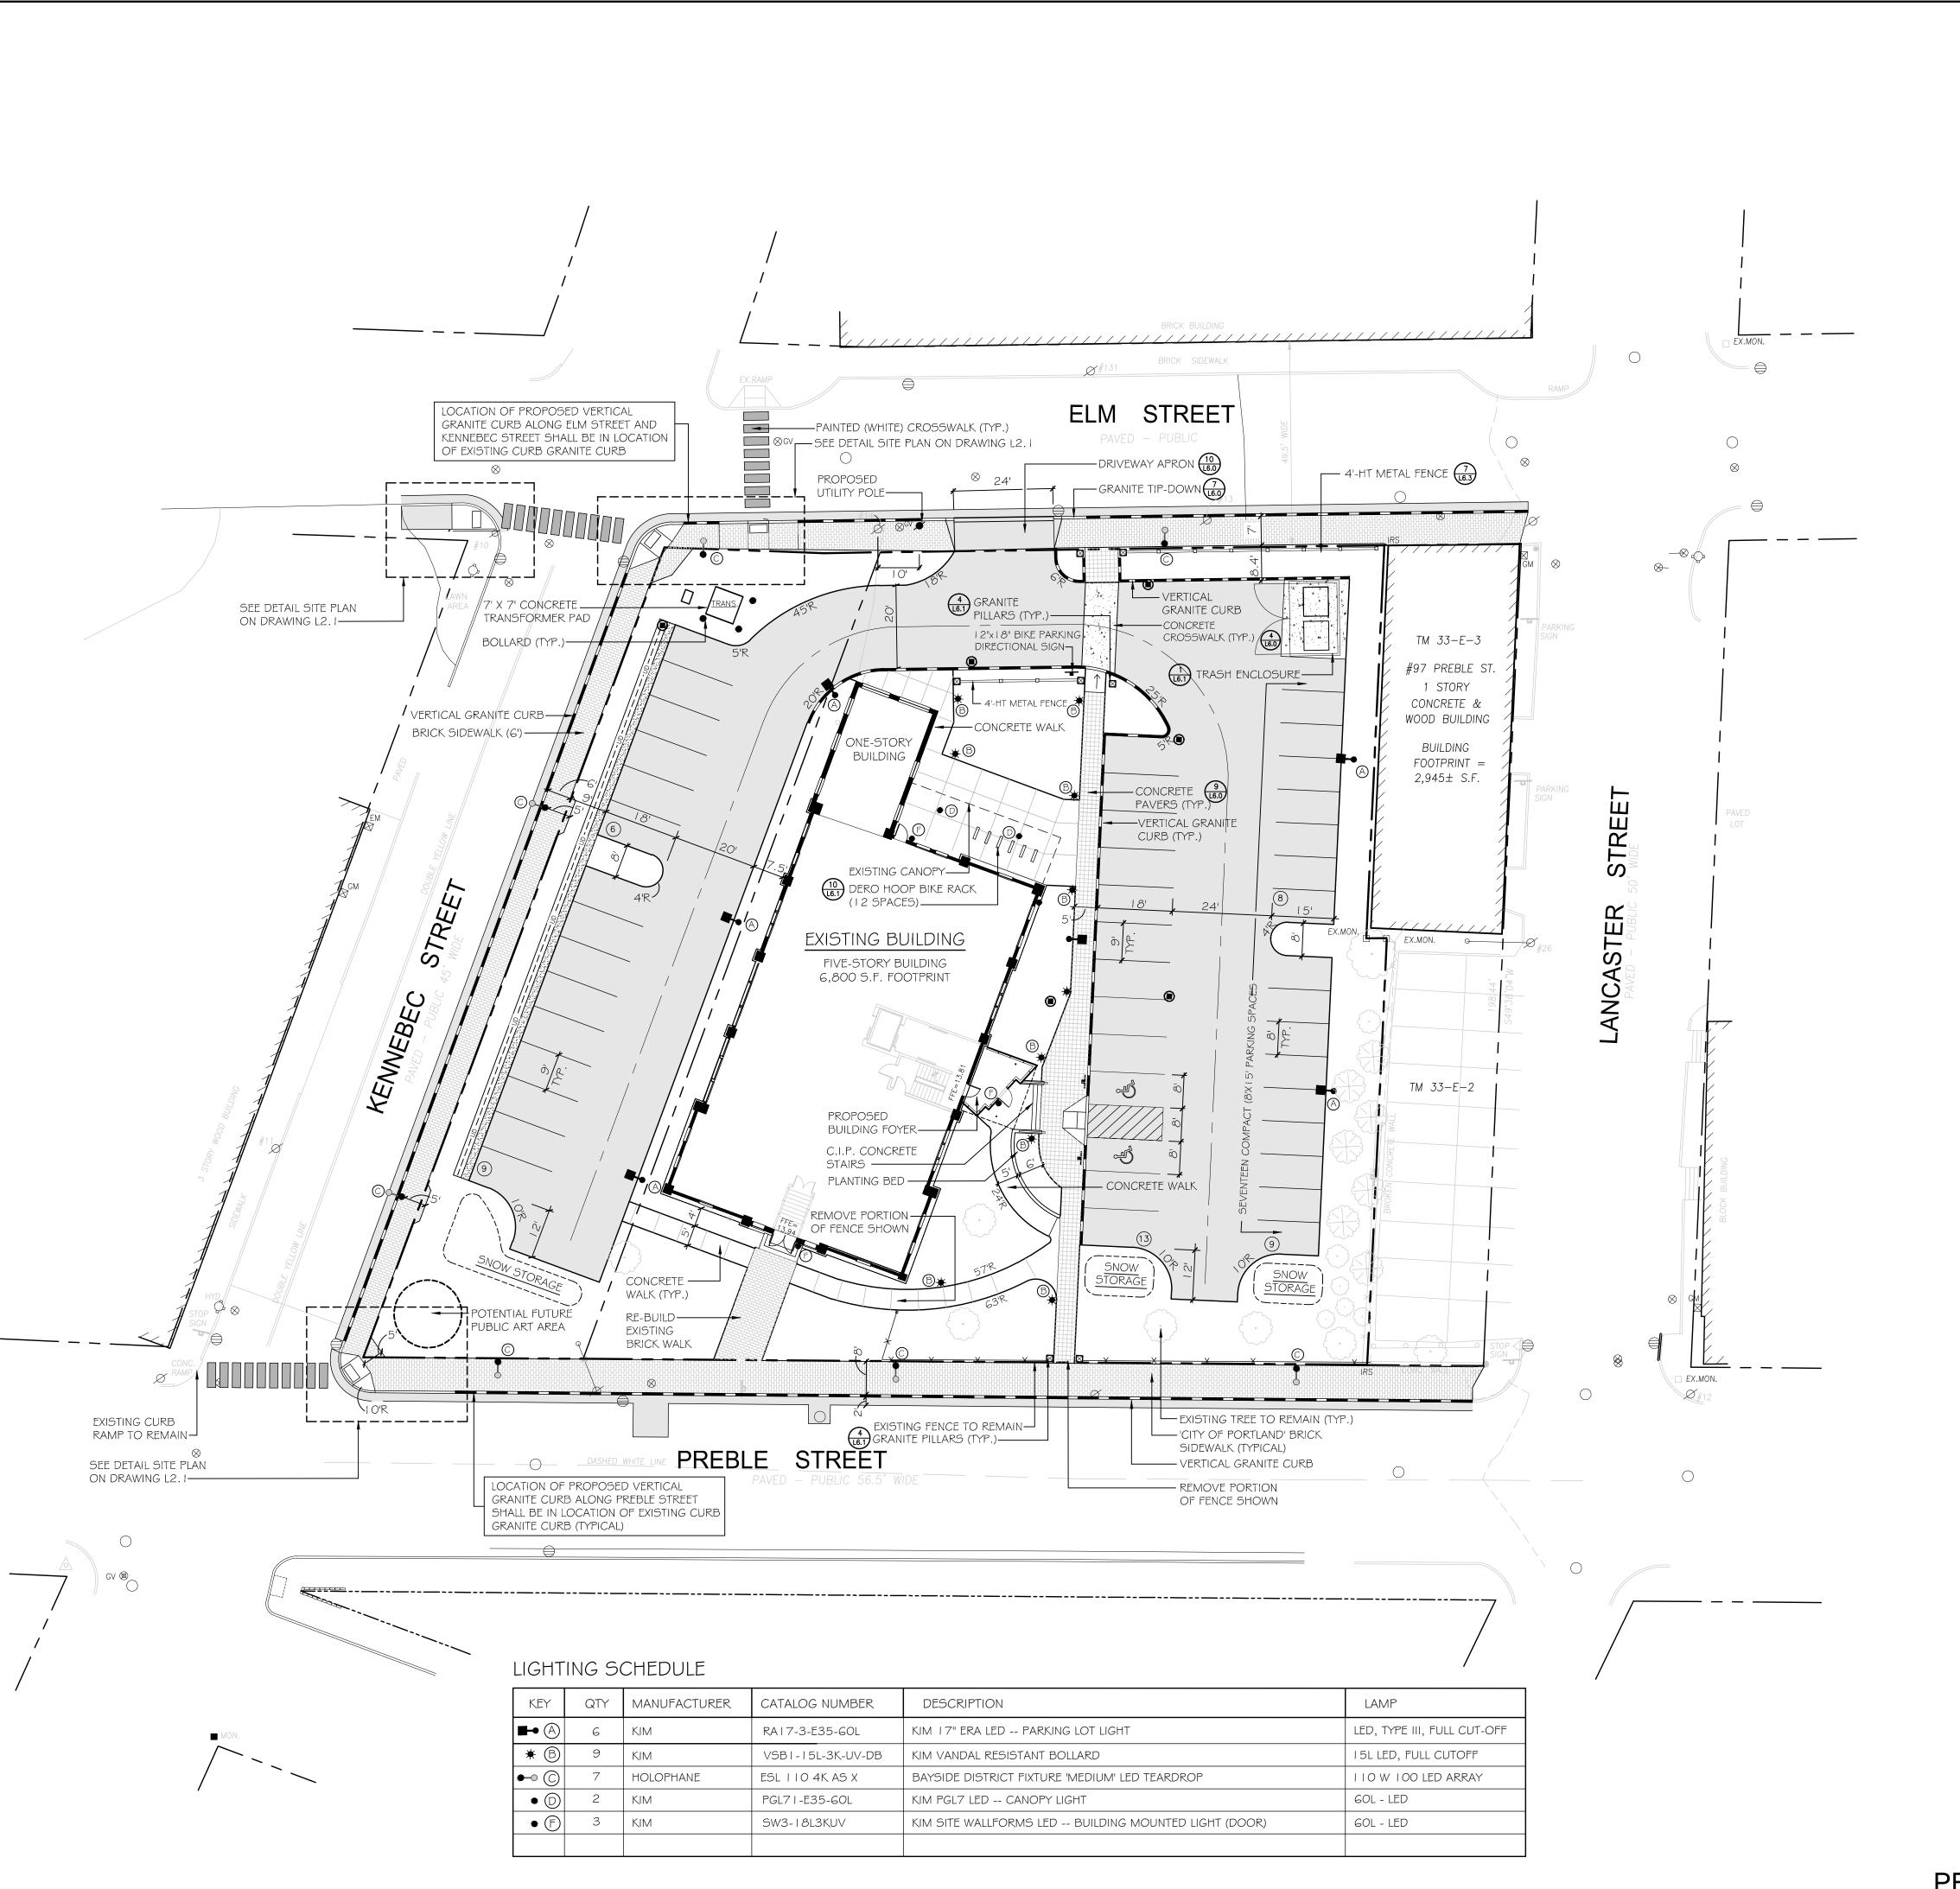

GENERAL NOTES

I. SITE AREA:

2. APPLICANT: SCHLOTTERBECK BLOCK, LLC 77 SPRUCE STREET

PORTLAND, MAINE 04101 3. RECORD OWNER: J.B. BROWN \$ SONS 482 CONGRESS STREET

P.O. BOX 207 PORTLAND, MAINE 04112

4. LOT DATA: TAX MAP 33, BLOCK E, LOT I C.C.R.D BOOK 26354, PAGE 312 AREA: 30,492 S.F.

40,720 S.F. OR 0.93 ACRE

TAX MAP 33, BLOCK E, LOT 5 C.C.R.D BOOK 26354, PAGE 314 AREA: 10,314 S.F.

5. THE SURVEYED PARCELS ARE SHOWN AS LOTS | AND 5, BLOCK E, ON THE CITY OF PORTLAND'S ASSESSORS MAP 33.

6. A PORTION OF THE PARCEL IS LOCATED, BY SCALING METHODS, WITHIN ZONE C (AREAS OF MINIMAL FLOODING) AS SHOWN ON THE FLOOD INSURANCE RATE MAP FOR THE CITY OF PORTLAND. MAINE COMMUNITY PANEL NO. 23005 I-00 I 3-B WITH AN EFFECTIVE DATE OF JULY 17, 1986. THE FLOOD ELEVATION FOR THE A2 ZONE WHICH ENCOMPASSES BACK COVE HAS AN ELEVATION OF 10 N.G.V.D. 1929. HOWEVER, THE TOPOGRAPHICAL SURVEY OF THE PARCEL SHOWS THE LOT ABOVE THE ELEVATION OF 10 N.G.V.D. (1929).

7. UTILITIES SHOWN ARE BASED ON A PLAN ENTITLED 'BOUNDARY AND TOPOGRAPHIC SURVEY OF 117 PREBLE STREET', PERFORMED BY OWEN HASKELL, INC., DATED JULY 7, 2015.

9. ZONING DISTRICT: B-7 MIXED DEVELOPMENT DISTRICT ZONE

10. SPACE AND BULK STANDARDS:

PROPOSED 40,720 S.F. MINIMUM LOT SIZE: NONE MINIMUM FRONTAGE: 242 FEET NONE REQUIRED 18 FEET FRONT SETBACK: SIDE SETBACK: NONE REQUIRED 5 FEET REAR SETBACK: NONE REQUIRED 31 FEET MAX. STREET SETBACK IO FEET 18 FEET (EXISTING) MAX. BUILDING LOT COVERAGE: 100 PERCENT 68 PERCENT MAX. BUILDING HEIGHT: 105 FEET N/A MIN. BUILDING HEIGHT: 45 FEET N/A

II. BICYCLE PARKING:

**REQUIRED:** 24 SPACES (22 RESIDENTIAL, 2 COMMERCIAL) 24 SPACES (12 EXTERIOR, 12 INTERIOR) PROPOSED:

12. ALL WORK WITHIN THE ROAD RIGHT-OF-WAY AND ALL UTILITIES CONNECTING TO INFRASTRUCTURE WITHIN THE ROAD SHALL MEET CITY OF PORTLAND TECHNICAL MANUAL STANDARDS.

LEGEND

13. PARKING SUMMARY:

45 SPACES PROPOSED PARKING: 17 SPACES (38%) PROPOSED COMPACT (8' X 15"): 2 SPACES REQUIRED A.D.A. ACCESSIBLE SPACES 2 SPACES PROPOSED A.D.A ACCESSIBLE SPACES

> PROPOSED EXISTING PROPERTY LINE \_\_\_\_ IRON PIPE OR ROD FOUND MONUMENT FOUND UTILITY POLE MANHOLE ELECTRIC/GAS METER 🔲 EM/GM ---SIGN \_ CATCH BASIN **O** HYDRANT  $\otimes$ WATER VALVE LIGHT POLE \* **\*** ■•■ **FENCE** X \_\_\_\_ GRANITE CURB OVERHEAD WIRES —— ОНW—— WATER LINE \_\_\_ W -\_\_\_ \_\_\_ G \_\_\_ GAS LINE

> > — т —

— SD —

— 10 —



160 North:

PERMITTING DRAWINGS -- NOT FOR CONSTRUCTION

CONCRETE PAVERS

TELEPHONE

STORM DRAIN

I' CONTOUR

BRICK PAVERS

SANITARY SEWER

Prepared For: Owner and Applicant: SCHLOTTERBECK BLOCK L.L.C. 104 Grant Street Portland, Maine 04101

Tel.: 207-650-8979 Prepared By: MITCHELL & ASSOCIATES Landscape Architects 70 Center Street Portland, Maine 04101

Tel.: 207-774-4427 RANSOM CONSULTING ENGINEERS 400 Commercial Street #4 Portland, Maine 04101 Phone: 207-772-2891

GODUTI-THOMAS ARCHITECTS 44 Oak Street # 2 Portland, Maine 04101 Phone: 207-775-3184

P

**—** 


OCTOBER 5, 2015 Issued For: Revisions: DEC. 1, 2015: REVISED PER STAFF REVIEW COMMENTS DEC. 10, 2015: REVISED PER STAFF REVIEW COMMENTS FEB. 25, 2016: REVISED PER CONDITIONS OF APPROVAL

Reproduction or reuse of this document without the expressed written consent of Mitchell & Associates is prohibited.


LAYOUT AND LIGHTING PLAN

Scale: 1" = 20' Sheet No.:


SIDEWALK RAMP: KENNEBEC STREET AND ELM

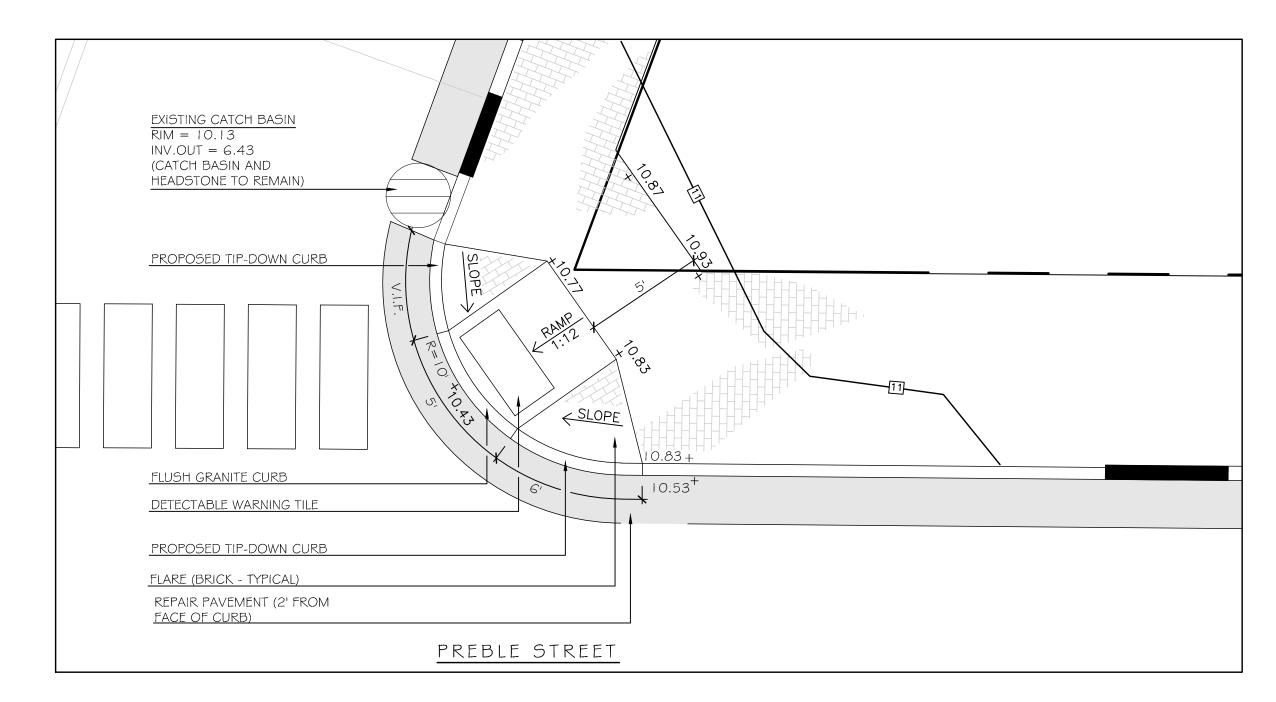

SIDEWALK RAMP: KENNEBEC STREET AND PREBLE STREET (NORTH)

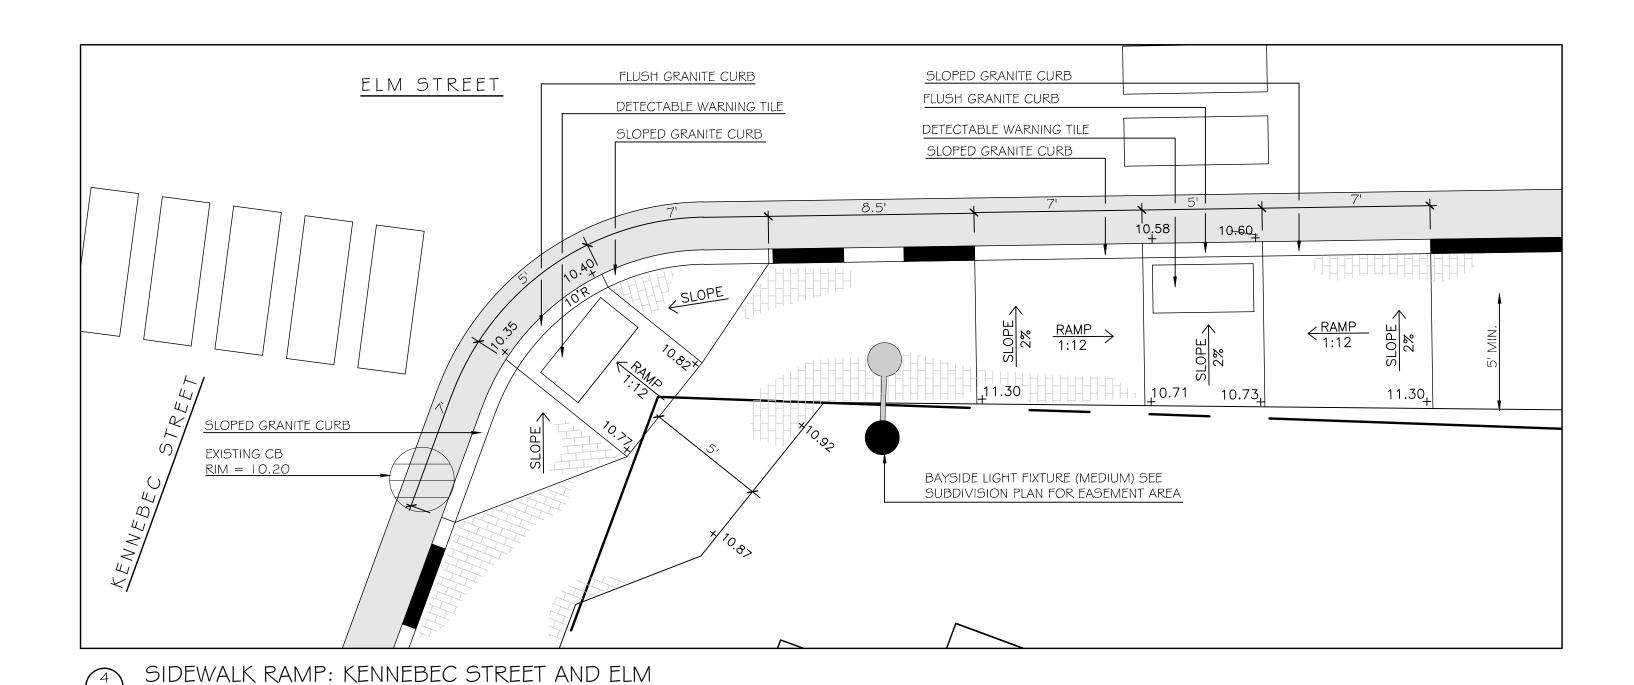


NOTE: CONTRACTOR SHALL COORDINATE WITH CITY OF PORTLAND AND OWNER'S REPRESENTATIVE BEFORE CONSTRUCTING CURB CUTS.

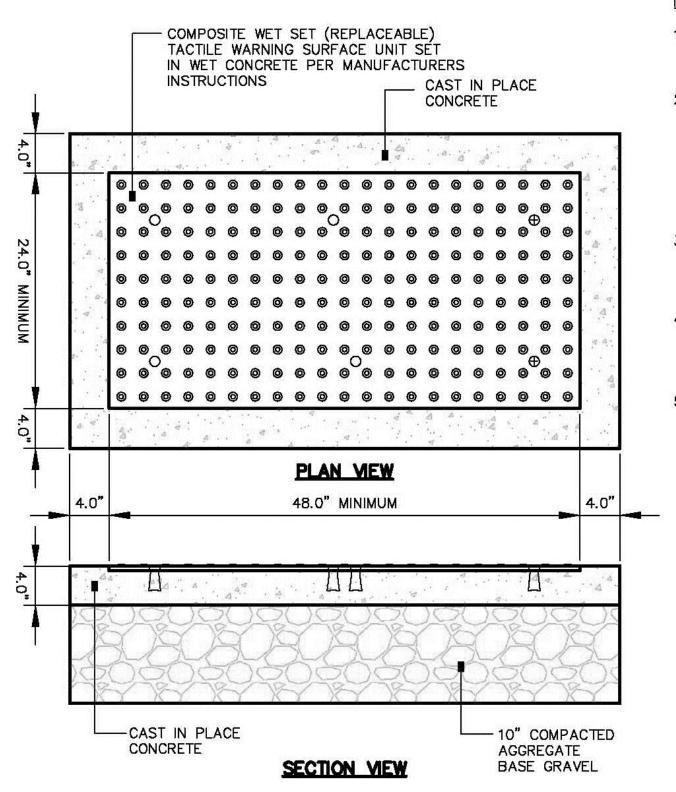

NOTES:

- COMPOSITE WET SET (REPLACEABLE) TACTILE WARNING SURFACE UNITS SHALL BE AS MANUFACTURED BY ADA SOLUTIONS, INC. (WWW.ADATILE.COM), OR APPROVED EQUAL.
- CAST IN PLACE CONCRETE SHALL MEET SPECIFICATIONS FOR MDOT CLASS A STRUCTURAL CONCRETE, MINIMUM COMPRESSIVE STRENGTH 4,000 PSI. THE CONCRETE SHALL BE SEALED PRIOR TO SETTING PANELS. THE EXPOSED CONCRETE BORDER SHALL RECEIVE A GROOVED EDGE BETWEEN THE TILE AND CONCRETE, ALONG WITH A UNIFORM BROOM FINISH PERPENDICULAR TO THE FLOW OF PEDESTRIAN TRAFFIC.
- TRUNCATED DOMES SHALL BE ALIGNED IN ROWS, PARALLEL AND PERPENDICULAR TO THE PREDOMINANT DIRECTION OF TRAVEL. TRUNCATED DOME BRICKS AND GRANITE PAVERS ARE NOT ALLOWED.
- 4. FOR ALL SIDEWALK RAMPS MADE OF CONCRETE OR ASPHALT, FEDERAL YELLOW COLORED (#33538) TILES SHALL BE USED. FOLLOW MANUFACTURER'S INSTRUCTIONS FOR INSTALLATION.
- FOR ALL SIDEWALK RAMPS MADE OF BRICK, SEATTLE YELLOW (#23594) COATED COLORED TILES SHALL BE

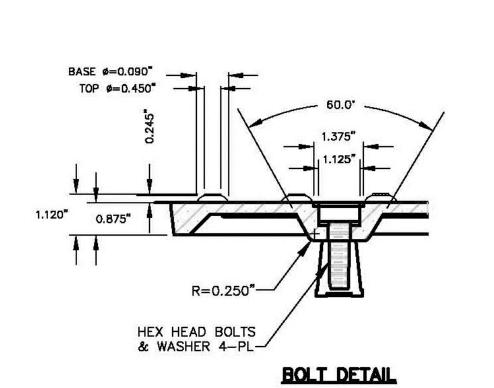

MITCHELL No. 15

Prepared For: Owner and Applicant: SCHLOTTERBECK BLOCK L.L.C 104 Grant Street Portland, Maine 04101 Tel.: 207-650-8979 Prepared By: MITCHELL & ASSOCIATES Landscape Architects 70 Center Street Portland, Maine 04101

Tel.: 207-774-4427 RANSOM CONSULTING ENGINEERS 400 Commercial Street #4 Portland, Maine 04101 Phone: 207-772-2891

GODUTI-THOMAS ARCHITECTS 44 Oak Street # 2 Portland, Maine 04101 Phone: 207-775-3184

chlotterbe

~


OCTOBER 5, 2015 Issued For: Revisions: DEC. 1, 2015: REVISED PER STAFF REVIEW COMMENTS DEC. 10, 2015: REVISED PER STAFF REVIEW COMMENTS FEB. 25, 2016: REVISED PER CONDITIONS OF APPROVAL Reproduction or reuse of this document without the expressed written consent

> DETAIL SITE PLANS: SIDEWALK RAMPS

of Mitchell & Associates is prohibited.

© 2016

Scale: AS SHOWN

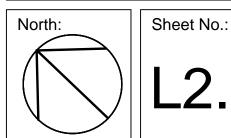


DETAIL NOT USED

SIDEWALK RAMP DETECTABLE WARNING TILE

SIDEWALK RAMP DETECTABLE WARNING TILE

NOT TO SCALE

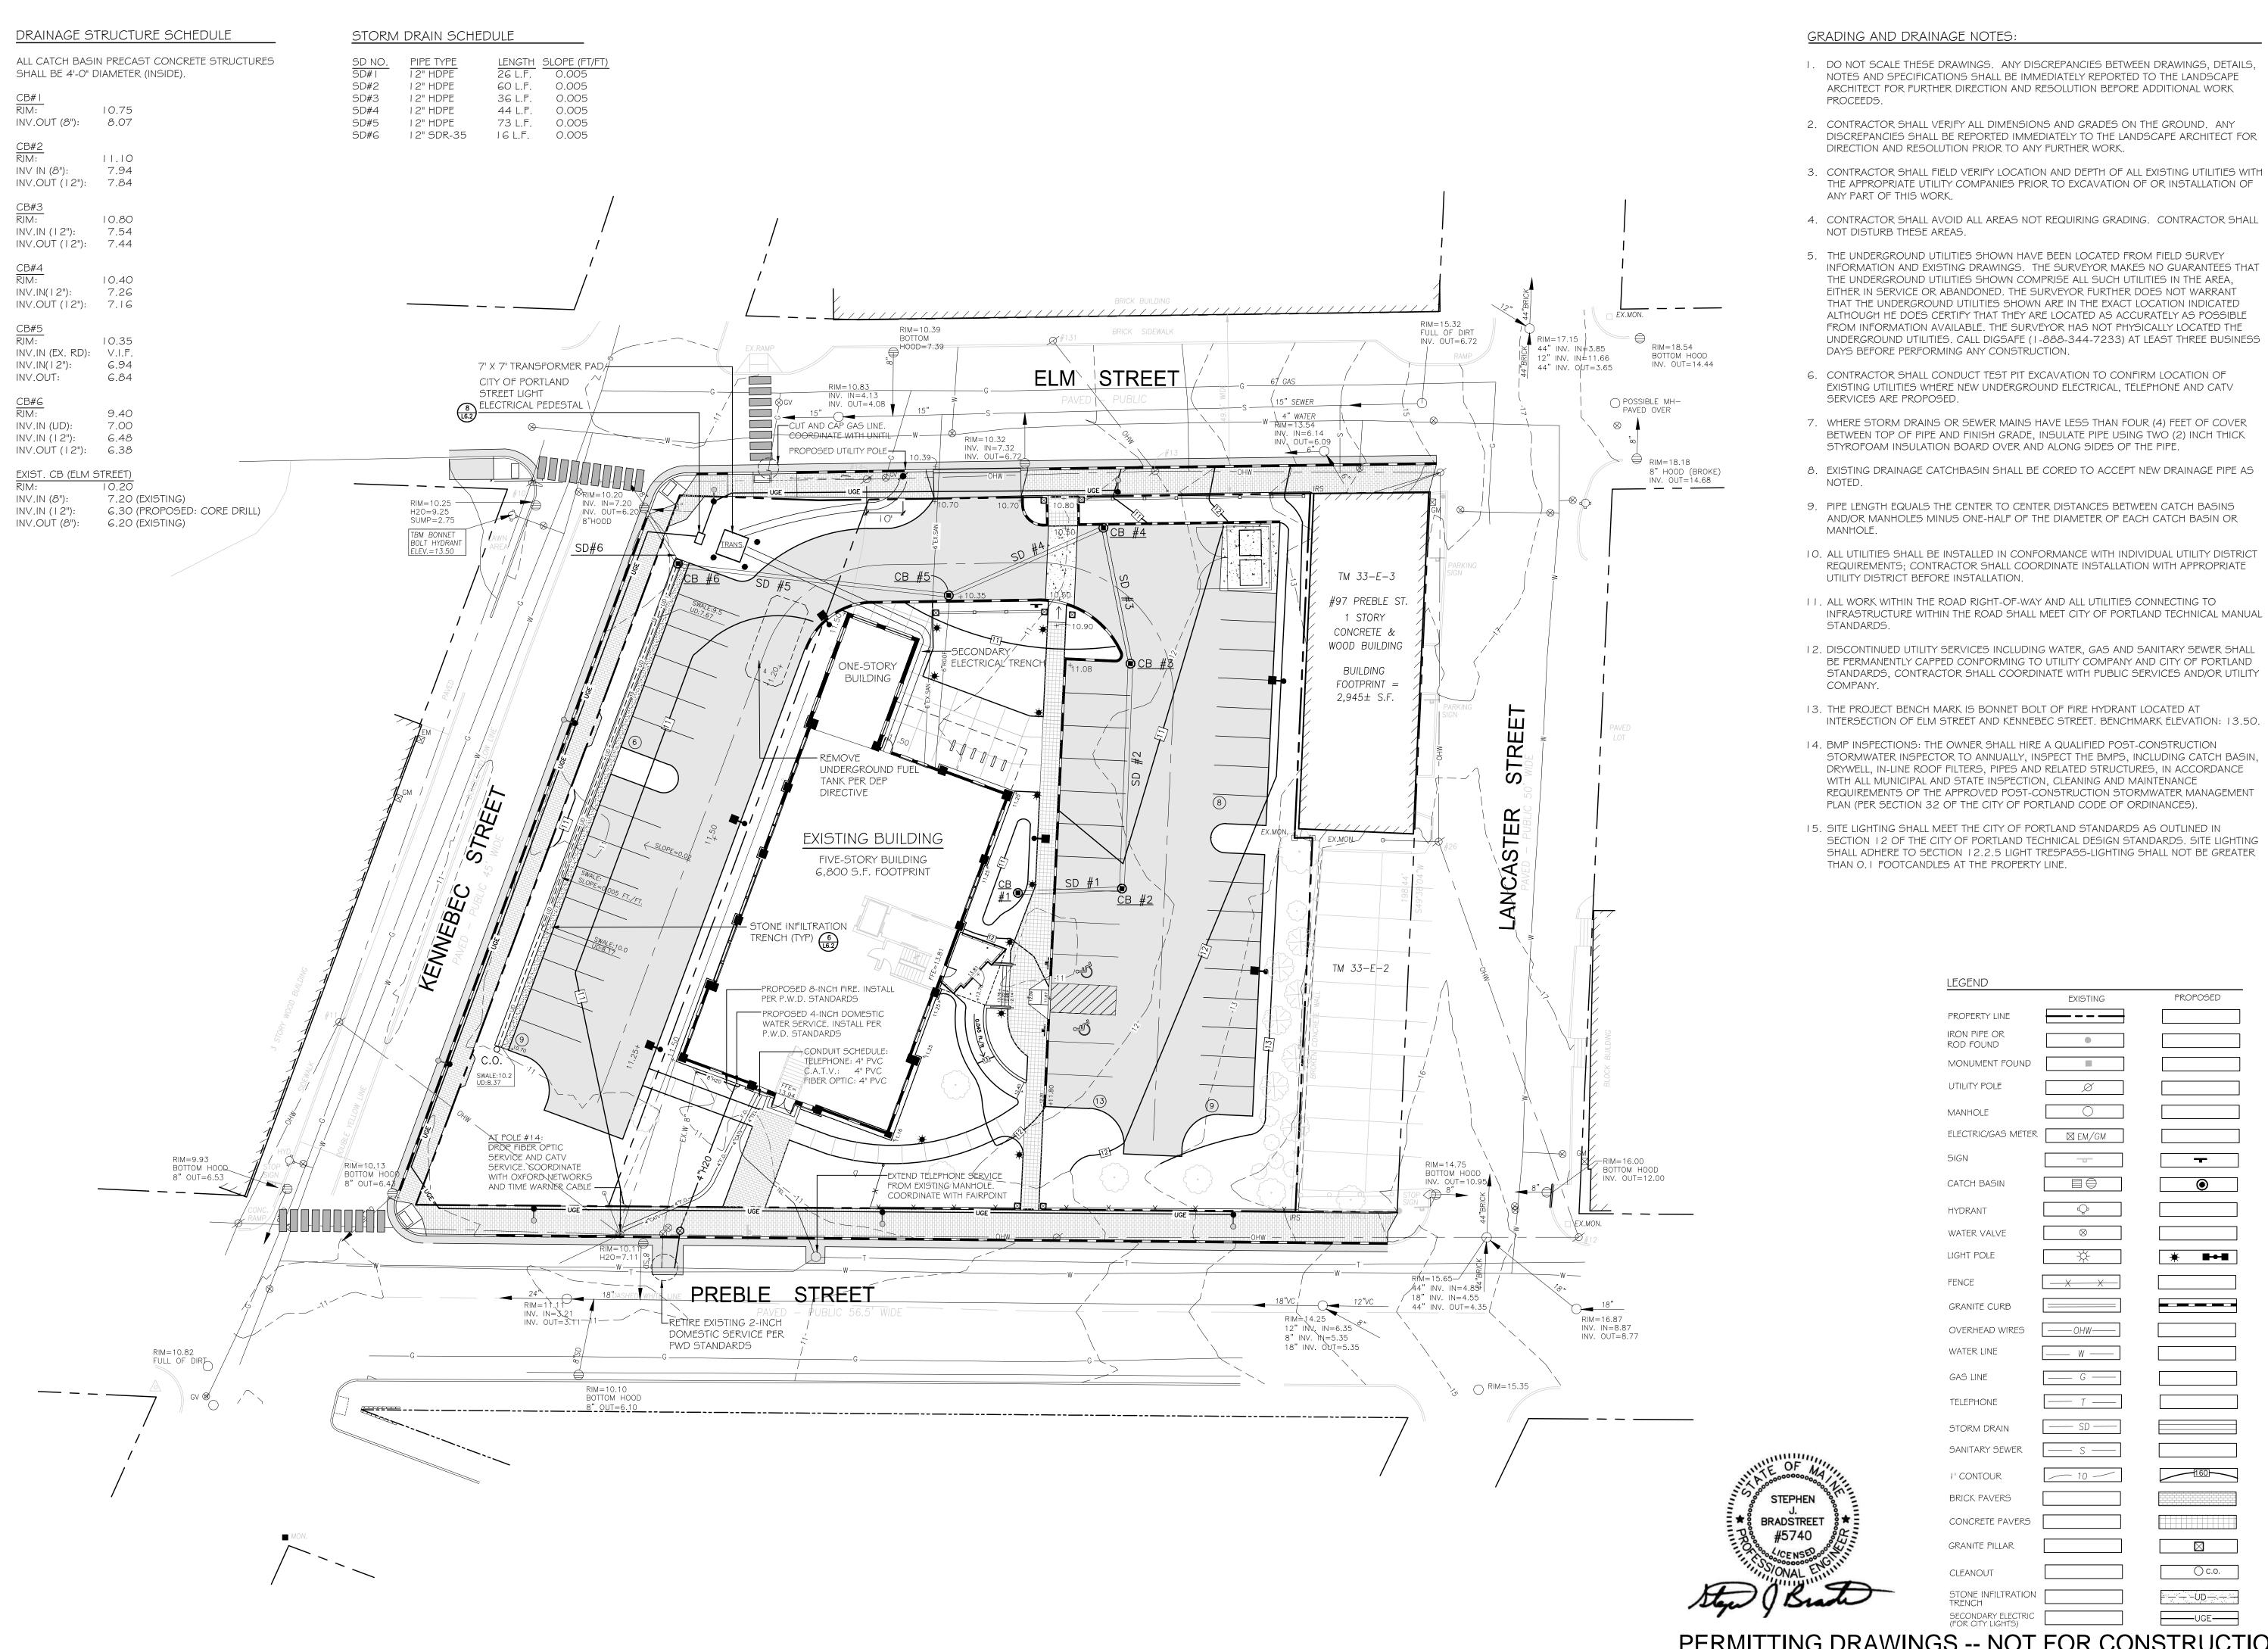

NOTES AND SPECIFICATIONS SHALL BE IMMEDIATELY REPORTED TO THE LANDSCAPE

DISCREPANCIES SHALL BE REPORTED IMMEDIATELY TO THE LANDSCAPE ARCHITECT FOR

- THE APPROPRIATE UTILITY COMPANIES PRIOR TO EXCAVATION OF OR INSTALLATION OF
- 4. CONTRACTOR SHALL AVOID ALL AREAS NOT REQUIRING GRADING. CONTRACTOR SHALL
- INFORMATION AND EXISTING DRAWINGS. THE SURVEYOR MAKES NO GUARANTEES THAT THAT THE UNDERGROUND UTILITIES SHOWN ARE IN THE EXACT LOCATION INDICATED ALTHOUGH HE DOES CERTIFY THAT THEY ARE LOCATED AS ACCURATELY AS POSSIBLE FROM INFORMATION AVAILABLE. THE SURVEYOR HAS NOT PHYSICALLY LOCATED THE UNDERGROUND UTILITIES. CALL DIGSAFE (1-888-344-7233) AT LEAST THREE BUSINESS
- BETWEEN TOP OF PIPE AND FINISH GRADE, INSULATE PIPE USING TWO (2) INCH THICK
- 8. EXISTING DRAINAGE CATCHBASIN SHALL BE CORED TO ACCEPT NEW DRAINAGE PIPE AS
- REQUIREMENTS; CONTRACTOR SHALL COORDINATE INSTALLATION WITH APPROPRIATE
- INFRASTRUCTURE WITHIN THE ROAD SHALL MEET CITY OF PORTLAND TECHNICAL MANUAL
- I 2. DISCONTINUED UTILITY SERVICES INCLUDING WATER, GAS AND SANITARY SEWER SHALL BE PERMANENTLY CAPPED CONFORMING TO UTILITY COMPANY AND CITY OF PORTLAND STANDARDS, CONTRACTOR SHALL COORDINATE WITH PUBLIC SERVICES AND/OR UTILITY
- STORMWATER INSPECTOR TO ANNUALLY, INSPECT THE BMPS, INCLUDING CATCH BASIN, DRYWELL, IN-LINE ROOF FILTERS, PIPES AND RELATED STRUCTURES, IN ACCORDANCE REQUIREMENTS OF THE APPROVED POST-CONSTRUCTION STORMWATER MANAGEMENT
- SECTION 12 OF THE CITY OF PORTLAND TECHNICAL DESIGN STANDARDS. SITE LIGHTING SHALL ADHERE TO SECTION 12.2.5 LIGHT TRESPASS-LIGHTING SHALL NOT BE GREATER

GLND		
	EXISTING	PROPOSED
OPERTY LINE		
ON PIPE OR D FOUND	•	
DNUMENT FOUND		
ILITY POLE	Ø	
ANHOLE		
ECTRIC/GAS METER	⊠ EM/GM	
ΘN	-11	_
TCH BASIN		<b>(</b>
DRANT	- O	
ATER VALVE	$\otimes$	
HT POLE	*	* ==
NCE	X	
CANITE CURB		
/ERHEAD WIRES	OHW	
ATER LINE	W	
AS LINE	G	
LEPHONE	T	
ORM DRAIN	SD	
NITARY SEWER	s	
CONTOUR		160
RICK PAVERS		
DNCRETE PAVERS		
ANITE PILLAR		
EANOUT		O c.o.
ONE INFILTRATION ENCH		
CONDARY ELECTRIC OR CITY LIGHTS)		UGE

Prepared For: Owner and Applicant: SCHLOTTERBECK BLOCK L.L.C. 104 Grant Street

Portland, Maine 04101 Tel.: 207-650-8979

Prepared By: MITCHELL & ASSOCIATES Landscape Architects 70 Center Street Portland, Maine 04101

Tel.: 207-774-4427 RANSOM CONSULTING ENGINEERS 400 Commercial Street #4 Portland, Maine 04101 Phone: 207-772-2891

GODUTI-THOMAS ARCHITECTS 44 Oak Street # 2 Portland, Maine 04101 Phone: 207-775-3184

OCTOBER 5, 2015 Issued For:

 $\overline{\phantom{a}}$ 

Revisions:


DEC. 1, 2015: REVISED PER STAFF REVIEW COMMENTS

DEC. 10, 2015: REVISED PER STAFF REVIEW COMMENTS FEB. 25, 2016: REVISED PER CONDITIONS

Reproduction or reuse of this document without the expressed written consent of Mitchell & Associates is prohibited. © 2016

OF APPROVAL

GRADING, DRAINAGE AND UTILITIES PLAN

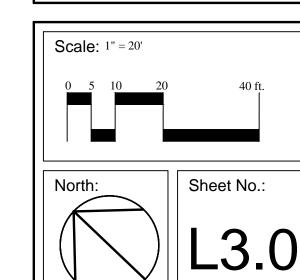

PERMITTING DRAWINGS -- NOT FOR CONSTRUCTION

#### EROSION AND SEDIMENT CONTROL PLAN

THIS PLAN HAS BEEN DEVELOPED AS A STRATEGY TO CONTROL SOIL EROSION AND SEDIMENTATION DURING AND AFTER THE RE-DEVELOPMENT OF THE SCHLOTTERBECK AND FOSS BUILDING AT 117 PREBLE STREET IN PORTLAND, MAINE. THIS PLAN IS BASED ON THE MAINE EROSION AND SEDIMENTATION CONTROL HANDBOOK FOR CONSTRUCTION, BEST MANAGEMENT PRACTICES, MARCH, 2003.

#### A. PROPOSED DEVELOPMENT

THE PROJECT CONSISTS OF THE RE-DEVELOPMENT OF AN EXISTING FIVE-STORY, 6,800 SQUARE FOOT BUILDING. HE BUILDING WILL INCLUDE 55 APARTMENT UNITS AND 2,000 S.F. OF COMMERCIAL OFFICE SPACE. THE 40,702 S.F. PARCEL CURRENTLY CONSISTS OF THE BUILDING AND A PAVED PARKING LOT AND A GRAVEL PARKING LOT;  $^73\%$  OF THE EXISTING SITE IS IMPERVIOUS. THE PROPOSED IMPERVIOUS LOT IMPERVIOUS IS  $27,\!300$  S.F. OR 67% OF THE SITE.

#### B. EROSION CONTROL PRACTICES/TEMPORARY MEASURES

THE FOLLOWING TEMPORARY MEASURES TO CONTROL EROSION AND SEDIMENTATION SHALL BE UTILIZED:

EACH GROUND AREA, OPENED OR EXPOSED, WHETHER DIRECTLY OR INDIRECTLY DUE TO THE DEVELOPMENT, SHALL BE MINIMIZED AND SHALL BE STABILIZED WITHIN 15 DAYS OF INITIAL DISTURBANCE OF SOIL AND SHALL BE PERMANENTLY STABILIZED WITHIN SEVEN DAYS OF FINAL GRADING. THIS STATEMENT APPLIES TO DISTURBED AREAS BEYOND THE LIMITS OF THE PROPOSED BUILDING. EXPOSED AREAS SHALL BE STABILIZED PRIOR TO A RAIN EVENT.

TEMPORARY SOIL STABILIZATION SHALL BE EITHER BY TEMPORARY MULCHING, TEMPORARY SEEDING, PERMANENT BASE GRAVEL, OR ASPHALT BINDER COURSE AS FOLLOWS:

TEMPORARY SEEDING: SEED SHALL BE AROOSTOOK RYE APPLIED AT 2.60#/1000 SF. LIME SHALL BE AGRICULTURAL GROUND LIMESTONE APPLIED AT 138#/1000 SF. FERTILIZER SHALL BE 10-10-10 CLASSIFICATION APPLIED AT 13.8#/1000 SF. MULCH SHALL CONSIST OF HAY AND STRAW MULCH AND SPREAD EVENLY AT A RATE OF 70-90#/I 000 SF. TEMPORARY SEEDINGS SHALL ONLY BE MADE BETWEEN APRIL 15 AND OCTOBER 1, AND SHALL NOT BE PLACED OVER SNOW.

TEMPORARY MULCHING: MULCH SHALL CONSIST OF CHOPPED HAY OR STRAW MULCH AND SPREAD BY MECHANICAL BLOWER EVENLY AT A RATE OF 150-200#/1000 SF. TEMPORARY MULCH SHALL BE REMOVED PRIOR TO PERMANENT SOIL STABILIZATION. MULCH MUST NOT BE PLACED OVER SNOW. SNOW SHALL BE REMOVED PRIOR TO MULCHING.

PERMANENT BASE GRAVEL: BASE GRAVEL UNDER PAVEMENT SHALL BE SUITABLE AS TEMPORARY SOIL STABILIZATION UNDER THE FOLLOWING CONDITIONS: a) SLOPES SHALL BE LESS THAN EIGHT PERCENT;

b) GRAVEL SHALL MEET THE SPECIFICATIONS FOR BASE OR SUBBASE GRAVEL FOR THE PROPOSED COMPLETED PAVEMENT.

#### C. EROSION CONTROL PRACTICES/PERMANENT MEASURES

THE FOLLOWING PERMANENT MEASURES TO CONTROL EROSION AND SEDIMENTATION SHALL BE UTILIZED:

PERMANENT SEEDING SHALL BE PERFORMED DURING CONSTRUCTION OPERATIONS AS EACH DISTURBED AREA HAS BEEN BROUGHT TO FINISH GRADE. PERMANENT SEEDINGS SHALL BE MADE AS DORMANT SEEDING AFTER THE FIRST KILLING FROST. DORMANT SEEDING AND MULCH SHALL BE USED AT TWO TIMES THE PERMANENT SEEDING AND MULCHING RATE SHOWN BELOW FOR BOTH LAWN AS WELL AS EMBANKMENTS. SEED, LOAM, LIME, FERTILIZER AND MULCH ARE TO BE AS FOLLOWS:

SEED: THE SEED MIXTURE SHALL CONSIST OF SEED PROPORTIONED BY WEIGHT. ALL SEED SHALL BE FRESH, CLEAN, "NEW CROP" SEED. HARMLESS INERT MATTER AND WEED SEEDS SHALL BE PERMITTED UP TO ONE PERCENT OF THE GROSS WEIGHT OF EACH VARIETY OF SEED. ALL SEED SUPPLIED SHALL BE PACKED IN APPROVED CONTAINERS BEARING THE MANUFACTURER'S MANE AND ANALYSIS OF CONTENTS. THE FOLLOWING MATERIALS AND APPLICATION RATES SHALL BE REQUIRED FOR PERMANENT SEEDING

TOTAL:

CREEPING RED RESCUE: 0.69#/1000 SF 0.57#/1000 SF KENTUCKY BLUEGRASS: PERENNIAL RYEGRASS: 0.46#/1000 SF 0.12#/1000 SF

LOAM: SHALL BE FREE OF GRASSES, ROOTS, LARGE STONE AND INORGANIC DEBRIS. PLACE LOAM AT FOUR INCHES MINIMUM DEPTH OVER ALL DISTURBED AREAS. FINAL GRADING OF ALL LAWN AREAS TO BE APPROVED BY LANDSCAPE ARCHITECT BEFORE SEEDING.

1.84#/1000 SF

LIME: LIME SHALL BE AGRICULTURAL GROUND LIMESTONE AND APPLIED AS PER RECOMMENDATION OF A STATE COMMERCIAL SOIL TESTING LABORATORY. FERTILIZER: FERTILIZER SHALL BE 10-20-20 CLASSIFICATION AND APPLIED AS PER RECOMMENDATION OF A STATE COMMERCIAL SOIL TESTING LABORATORY.

MULCH: MULCH SHALL CONSIST OF HAY OR STRAW MULCH. MULCH SHALL BE SPREAD EVENLY AT A RATE OF TWO AND ONE HALF TONS PER ACRE OVER ALL SEEDING. AFTER APPLICATION, THE MULCH SHALL BE THOROUGHLY WETTED. IN STEEP AREAS, THE MULCH SHALL BE HELD IN PLACE BY THE USE OF JUTE EROSION CONTROL NETTING OR APPROVED ALTERNATIVE NETTING MATERIAL. NOTE: ALL EXPOSED SOIL MUST BE COVERED REGARDLESS OF MULCHING RATES SPECIFIED.

THE CONTRACTOR SHALL MAINTAIN THE SEEDED AND MULCHED AREAS UNTIL FINAL ACCEPTANCE OR THE WORK MAINTENANCE SHALL CONSIST OF PROVIDING PROPER WATERING. PROTECTION AGAINST TRAFFIC AND REPAIRING ANY AREAS DAMAGED DUE TO WIND, WATER, EROSION, FIRE OR OTHER CAUSES. SUCH DAMAGED AREAS SHALL BE REPAIRED TO REESTABLISH THE CONDITION AND GRADE OF THE SOIL PRIOR TO SEEDING AND SHALL THEN BE REFERTILIZED, RESEEDED AND REMULCHED.

#### D. WINTER CONDITIONS

XCAVATION AND EARTHWORK SHALL BE COMPLETED SUCH THAT NO MORE THAN I ACRE OF THE SITE IS WITHOUT STABILIZATION AT ANY ONE TIME. LIMIT THE EXPOSED AREA TO THOSE AREAS IN WHICH WORK IS EXPECTED TO BE UNDERTAKEN DURING THE PROCEEDING 15 DAYS AND THAT CAN BE MULCHED IN ONE DAY PRIOR TO ANY SNOW EVENT. HAY AND STRAW MULCH RATE SHALL BE A MINIMUM OF 150 LBS./1,000 S.F. (3 TONS/ACRE) AND SHALL BE PROPERLY ANCHORED. THE CONTRACTOR SHALL INSTALL ANY ADDED MEASURES VHICH MAY BE NECESSARY TO CONTROL EROSION/SEDIMENTATION FROM THE SITE, DEPENDENT UPON THE ACTUAL SITE AND WEATHER CONDITIONS. CONTINUATION OF EARTHWORK OPERATIONS ON ADDITIONAL AREAS SHALL NOT BEGIN UNTIL THE EXPOSED SOIL SURFACE ON THE AREA BEING WORKED HAS BEEN STABILIZED, IN ORDER TO MINIMIZE AREAS WITHOUT EROSION CONTROL PROTECTION.

#### . CONSTRUCTION SEQUENCE

- HE GENERAL SEQUENCE OF WORK SHALL BE AS FOLLOWS:
- INSTALL EROSION CONTROL DEVICES. (SILT FENCE, STABILIZED CONSTRUCTION ENTRANCE AND OR SEDIMENT
- TEMPORARILY STABILIZE DISTURBED AREAS BY MULCHING ALL EXPOSED SOIL WITHIN 15 DAYS OF INITIAL
- DISTURBANCE. INSTALL STORMWATER SYSTEM;
- COMPLETE SITE CONSTRUCTION WORK;
- CONSTRUCT PAVED ACCESS AND PARKING AREAS;
- INSTALL PERMANENT VEGETATION ON ALL EXPOSED AREAS WITHIN 15 DAYS OF FINAL GRADING; AND PERFORM CONTINUING MAINTENANCE ON ALL EROSION AND SEDIMENTATION CONTROL DEVICES AND


#### . SITE INSPECTION & MAINTENANCE


RESPONSIBILITY OF THE SITE CONTRACTOR.

RESPONSIBILITY OF THE SCHLOTTERBECK BLOCK LLC.

WEEKLY INSPECTIONS, AS WELL AS ROUTINE INSPECTIONS FOLLOWING RAINFALLS OF 0.5" OVER A CONSECUTIVE 24-HOUR PERIOD, SHALL BE CONDUCTED BY THE SITE CONTRACTOR OF ALL TEMPORARY AND PERMANENT EROSION CONTROL DEVICES UNTIL FINAL ACCEPTANCE OF THE PROJECT. NECESSARY REPAIRS SHALL BE MADE TO CORRECT UNDERMINING OR DETERIORATION. FINAL ACCEPTANCE SHALL INCLUDE A SITE INSPECTION TO VERIFY THE STABILITY OF ALL DISTURBED AREAS AND SLOPES. UNTIL FINAL INSPECTION, ALL EROSION AND SEDIMENTATION CONTROL MEASURES SHALL IMMEDIATELY BE CLEANED, AND REPAIRED BY THE SITE CONTRACTOR AFTER STORM EVENTS. DISPOSAL OF ALL TEMPORARY EROSION CONTROL DEVICES SHALL BE THE

CONTINUED TEMPORARY MAINTENANCE AND LONG TERM PROVISIONS FOR PERMANENT MAINTENANCE OF ALL EROSION AND SEDIMENTATION CONTROL FACILITIES AFTER ACCEPTANCE OF THE PROJECT SHALL BE THE

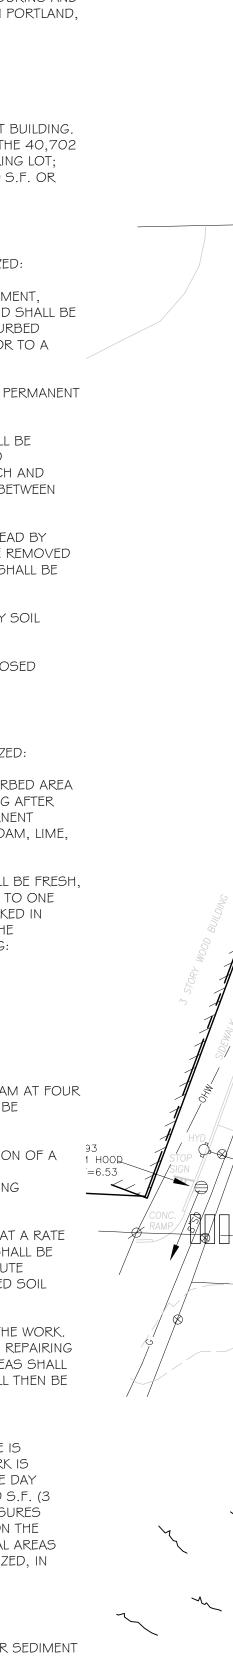

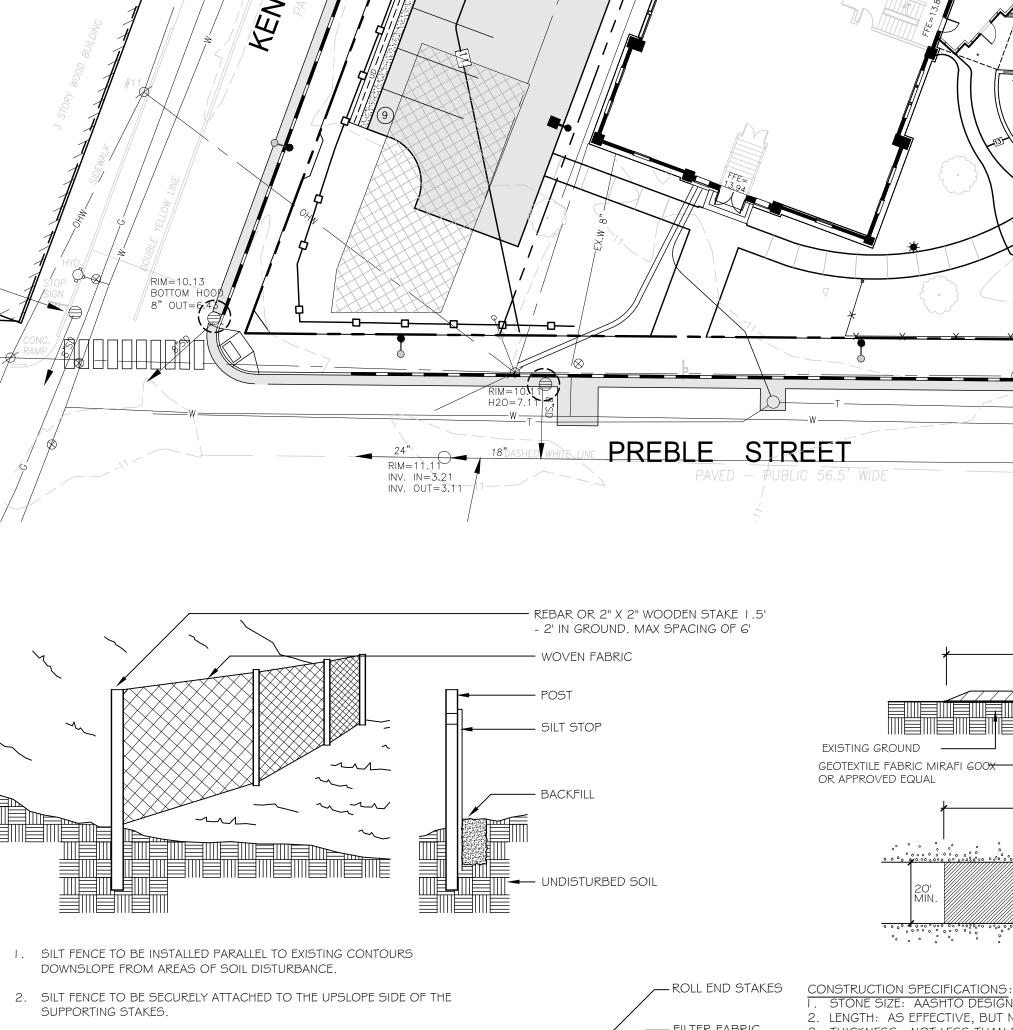

SUMP=2.75

TBM BONNET


BOLT HYDRANT ELEV.=13.50

 $\langle \mathcal{O} \rangle$ 


3. BOTTOM 4 TO 6 INCHES OF SILT FENCE TO BE BURIED IN SLOPE AND BACKFILLED WITH COMPACTED SOIL.

4. INSPECTION SHALL BE MADE AFTER EVERY RAINFALL WITH REMOVAL OF EXCESSIVE SEDIMENT AND REPAIR OF THE FENCE ACCOMPLISHED

5. SILT FENCE AND ACCUMULATED SEDIMENT SHALL BE REMOVED AS SOON AS PERMANENT EROSION CONTROL MEASURES HAVE BEEN ESTABLISHED.

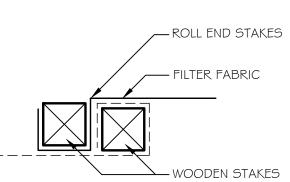



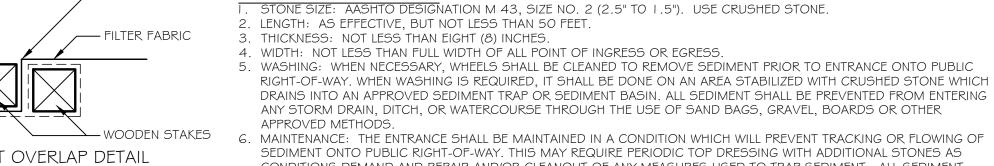

SEDIMENT ONTO PUBLIC RIGHT-OF-WAY. THIS MAY REQUIRE PERIODIC TOP DRESSING WITH ADDITIONAL STONES AS NOT TO SCALE



50' MINIMUM

Prepared For: Owner and Applicant: SCHLOTTERBECK BLOCK L.L.C. 104 Grant Street Portland, Maine 04101

Tel.: 207-650-8979 Prepared By: MITCHELL & ASSOCIATES Landscape Architects 70 Center Street Portland, Maine 04101

Tel.: 207-774-4427

PROPOSED

\_

**③** 

**\*** ■◆■

160

-0--0--

**MITCHELL** 

EXISTING

⊠ EM/GM

 $\otimes$ 

\*

 $\times$ 

— ОНW——

\_\_ W -----

— SD —

— 10 —

I/4" NYLON ROPE, 2" FLAT

RANSOM CONSULTING ENGINEERS 400 Commercial Street #4 Portland, Maine 04101 Phone: 207-772-2891

GODUTI-THOMAS ARCHITECTS 44 Oak Street # 2 Portland, Maine 04101 Phone: 207-775-3184

> 0  $\overline{\phantom{a}}$

OCTOBER 5, 2015

 $\overline{\phantom{a}}$ 

Issued For:


DEC. 1, 2015: REVISED PER STAFF REVIEW COMMENTS DEC. 10, 2015: REVISED PER STAFF

FEB. 25, 2016: REVISED PER CONDITIONS OF APPROVAL

REVIEW COMMENTS

Reproduction or reuse of this document without the expressed written consent of Mitchell & Associates is prohibited.

**EROSION AND SEDIMENT** CONTROL PLAN

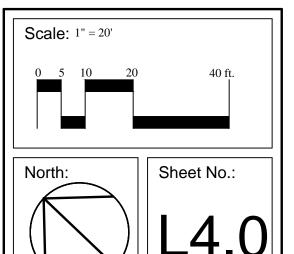

PERMITTING DRAWINGS -- NOT FOR CONSTRUCTION

INLET SEDIMENT CONTROL DEVICE

INV. OUT=6.72

INV. IN=6.14

TM 33-E-3

#97 PREBLE ST. 1 STORY

CONCRETE &

WOOD BUILDING

BUILDING

FOOTPRINT =

2,945± S.F.

EX.MON.

TM 33-E-2

RIM=14.25

PUBLIC R.O.W

PROVIDE APPROPRIATE TRANSITION BETWEEN STABILIZATION

CONSTRUCTION ENTRANCE AND PUBLIC RIGHT-OF-WAY

12" INV. IN=6.35

18" INIV ONT-5 35

8" INV. IN=5.35

BOTTOM HOOD

RIM=15.65-

44" INV. IN=4.85

18" INV. IN=4.55 44" INV. OUT=4.35

STREE

INV. OUT=4.08

EXISTING BUILDING

FIVE-STORY BUILDING

6,800 S.F. FOOTPRINT

RIM=18.5

RIM=18.1

PROPERTY LINE

MONUMENT FOUND

ELECTRIC/GAS METER

IRON PIPE OR

UTILITY POLE

MANHOLE

CATCH BASIN

**HYDRANT** 

WATER VALVE

GRANITE CURB

CONCRETE CURB

OVERHEAD WIRES

WATER LIN

GAS LINE

**TELEPHONE** 

STORM DRAIN

1' CONTOUR

ESC SILT FENCE

EX.MON.

RIM = 16.87

INSTALLATION DETAIL

REMOVAL FROM INLET

INV. IN=8.87

INV. OUT=8.77

SANITARY SEWER

CONSTRUCTION ENTRANCE

INLET SEDIMENT CONTROL DEVICE


LIGHT POLE

FENCE

O POSSIBLE MH-

44" INV. IN±3.85 12" INV. IN±11.66

44" INV. OUT=3.65

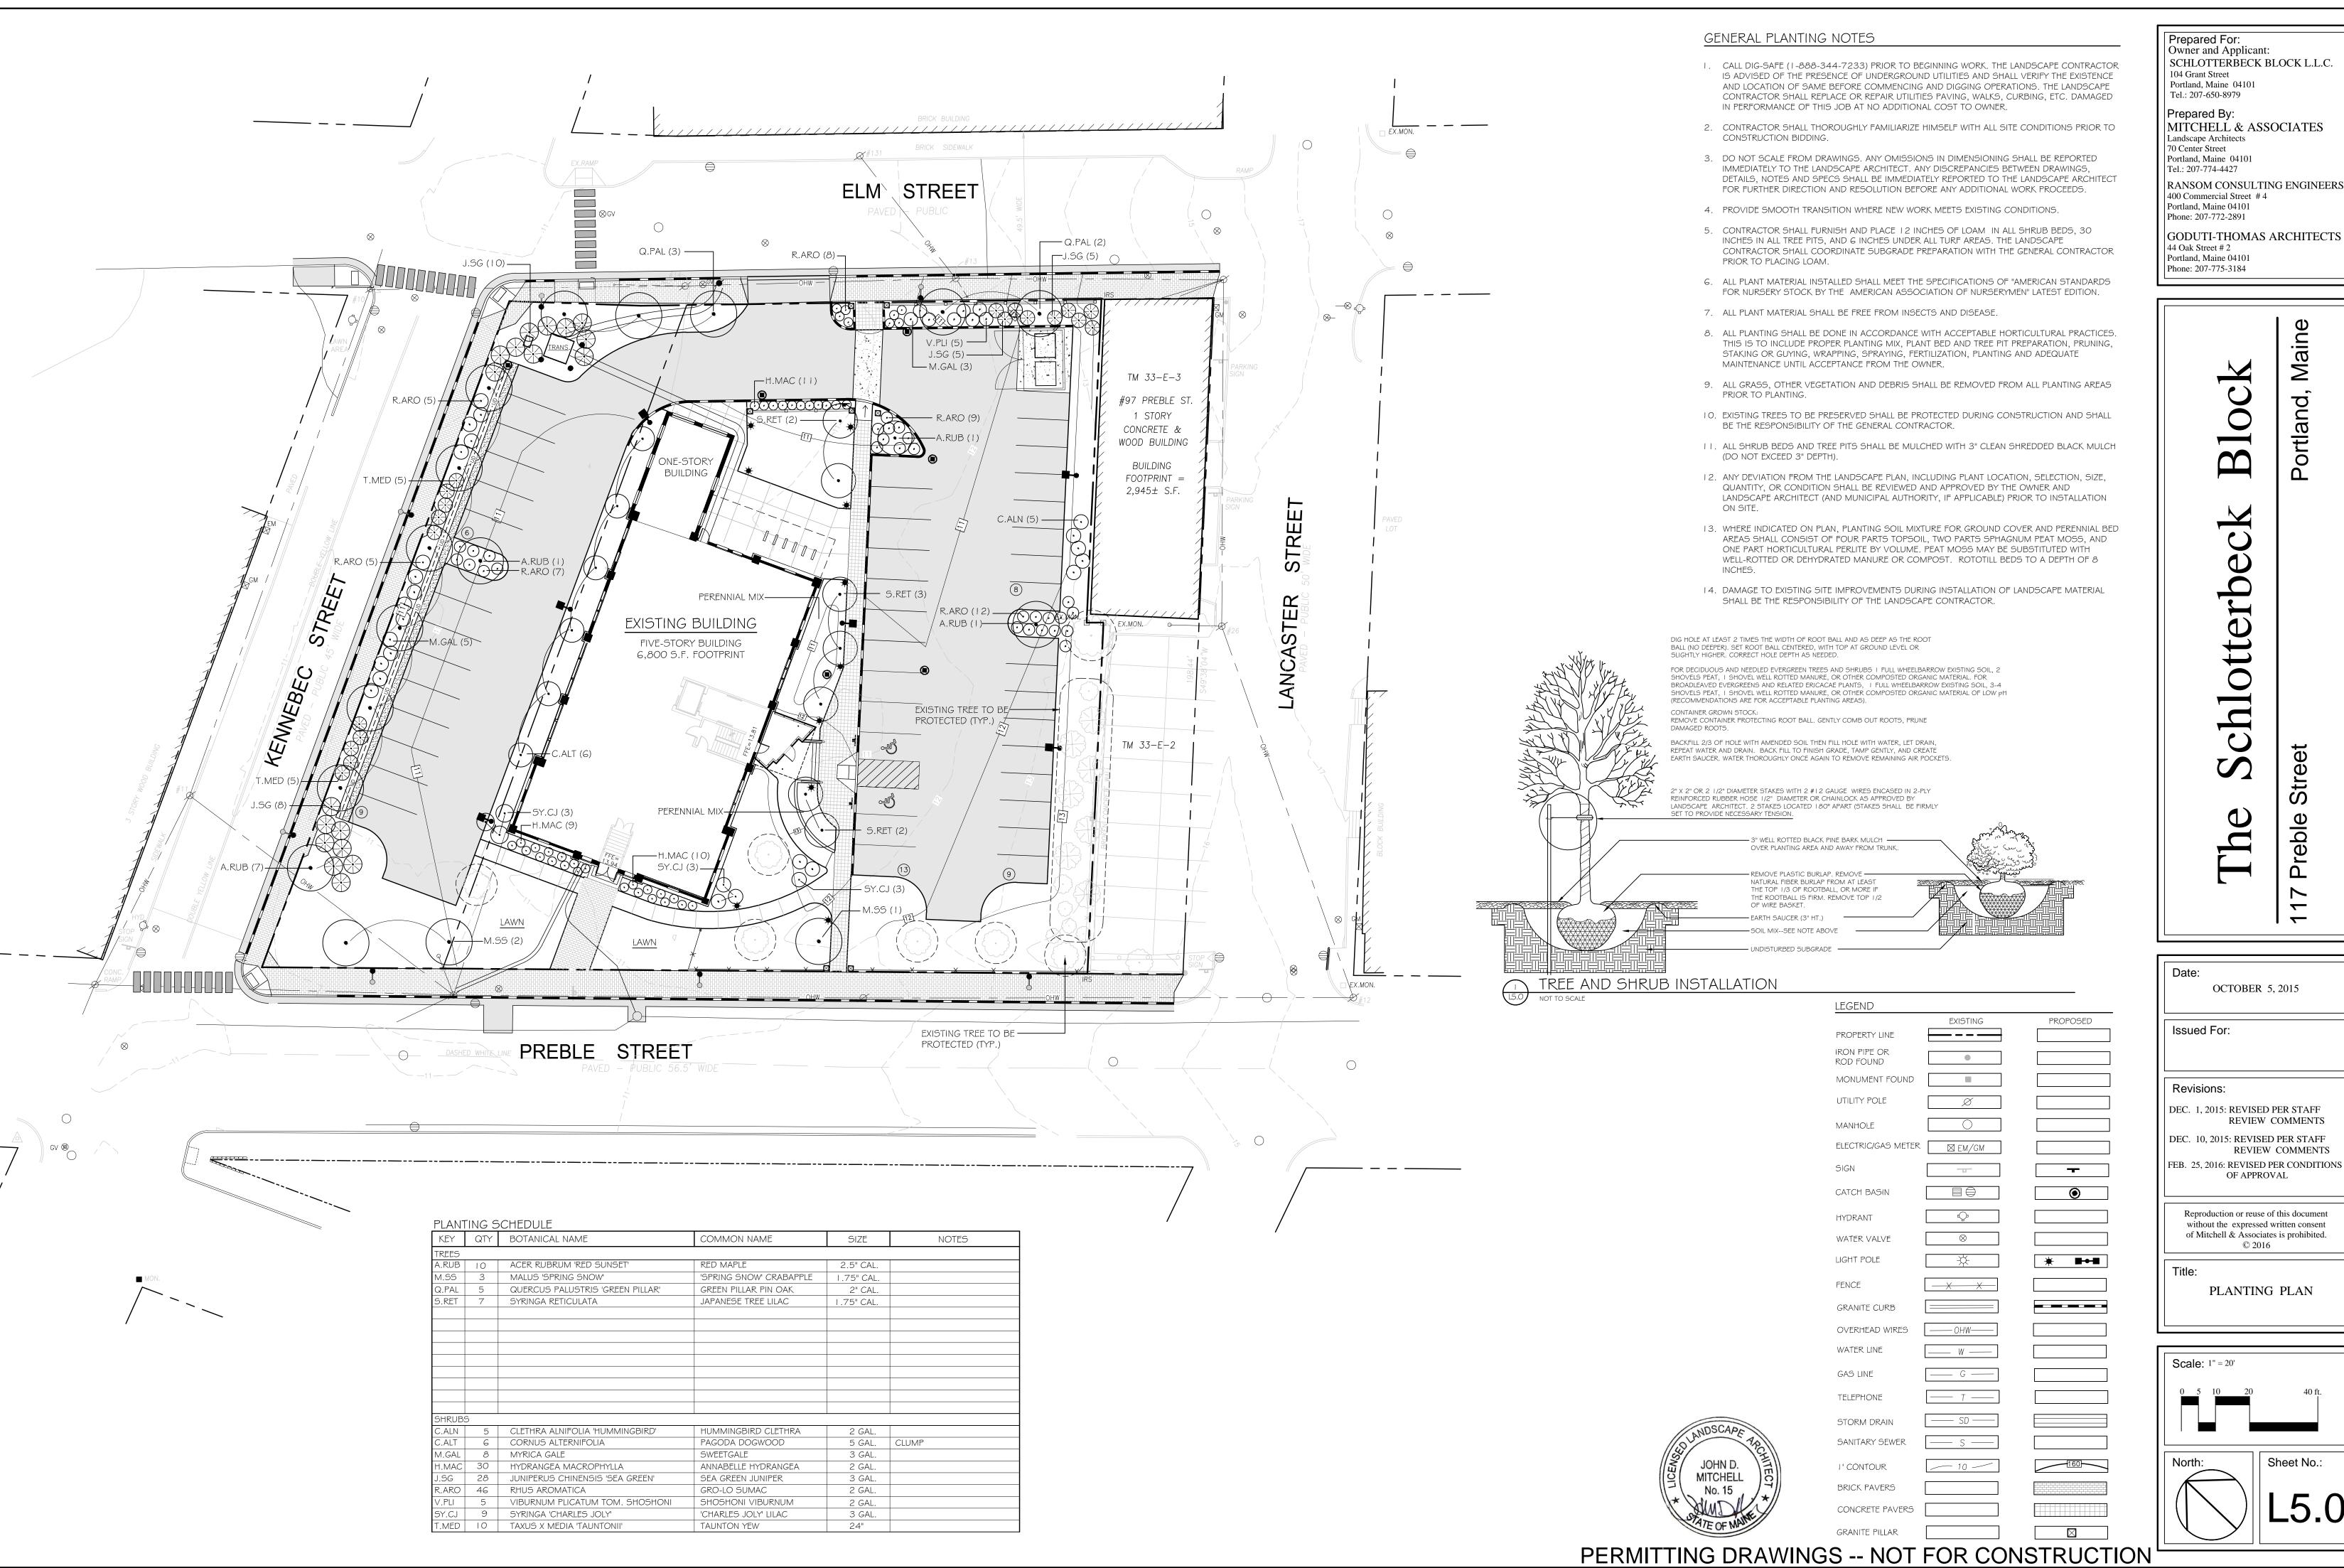

SCHLOTTERBECK BLOCK L.L.C.

MITCHELL & ASSOCIATES

RANSOM CONSULTING ENGINEERS

GODUTI-THOMAS ARCHITECTS

~


OCTOBER 5, 2015


REVIEW COMMENTS

Reproduction or reuse of this document without the expressed written consent


PLANTING PLAN

Sheet No.:

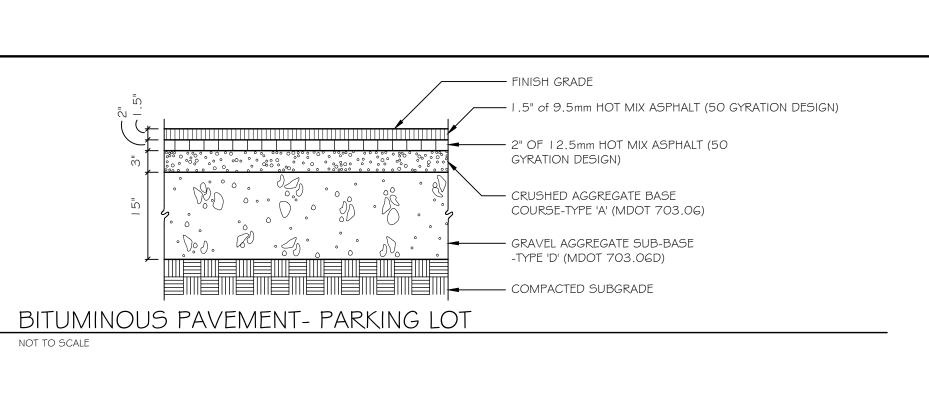

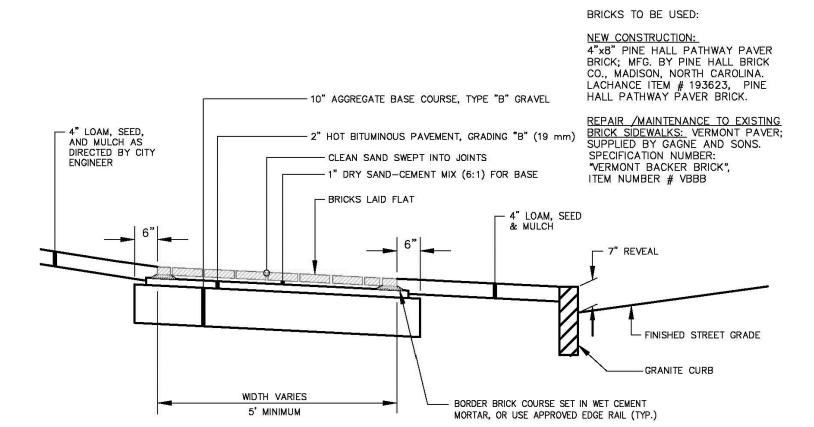




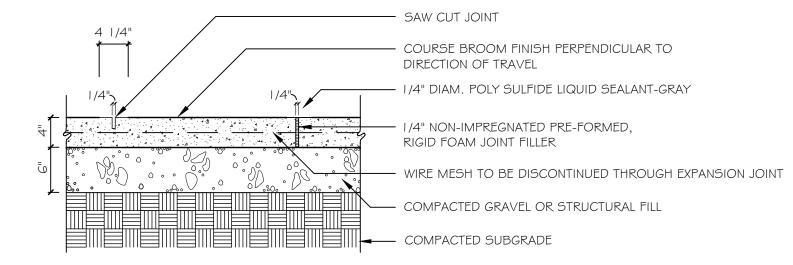


 $\underline{\mathsf{FINISH:}} \ \mathsf{SCREED} \ \mathsf{AND} \ \mathsf{BULL} \ \mathsf{FLOAT}, \ \mathsf{BROOM} \ \mathsf{FINISH}, \ \mathsf{PERPENDICULAR} \ \mathsf{TO} \ \mathsf{TRAVEL} \ \mathsf{DIRECTION}$  $\underline{\text{JOINTS:}}$  HAND TROWEL TO  $\frac{1}{3}$  DEPTH AT 5' O.C. WITHIN 24 HOURS AT 25-FOOT INTERVALS OR APPROPRIATE CONNECTIONS. SEALING: APPLY POLY SULFIDE LIQUID SEALANT, GRAY COLOR, INSTALL PER MANUFACTURER'S SPECIFICATIONS



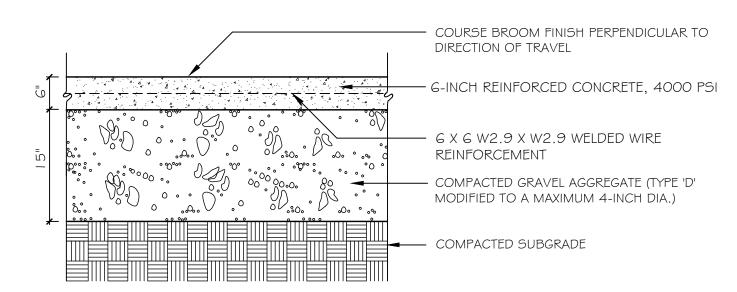


FINISH: SCREED AND BULL FLOAT, BROOM FINISH, PERPENDICULAR TO TRAVEL DIRECTION  $\underline{\text{JOINTS:}}$  HAND TROWEL TO  $\frac{1}{3}$  DEPTH AT 5' O.C. WITHIN 24 HOURS AT 25-FOOT INTERVALS OR APPROPRIATE CONNECTIONS. SEALING: APPLY POLY SULFIDE LIQUID SEALANT, GRAY COLOR, INSTALL PER MANUFACTURER'S SPECIFICATIONS

# CONCRETE PAD: CROSSWALK AND DUMPSTER PAD

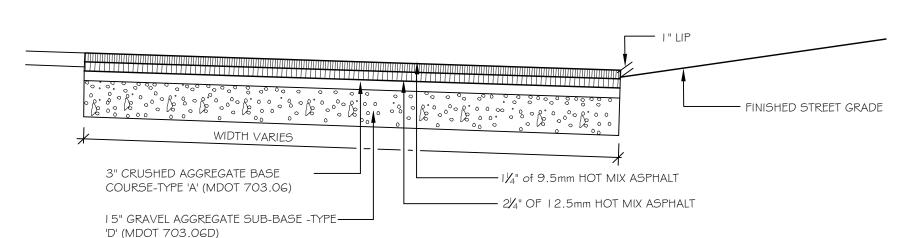

BITUMINOUS DRIVEWAY APRON

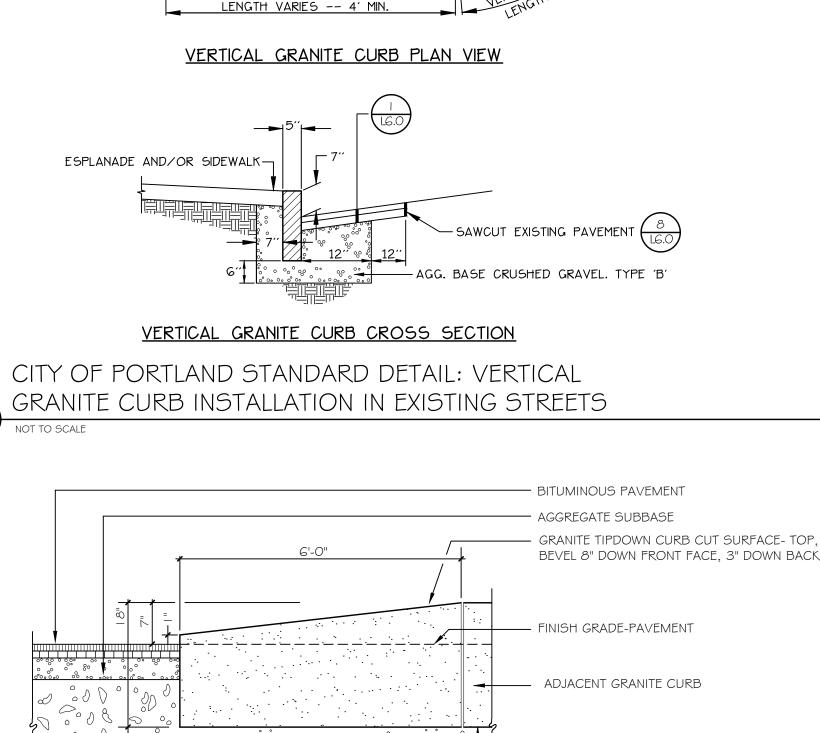

G' MIN. TERMINAL CURB

(7' AT SIDEWALK RAMPS)

☐ GUTTER LINE

BACK OF CURB

GRANITE TIP-DOWN CURB

— 4" X 8½" FILTER FABRIC (TYP.) FOR

TERMINAL CURB PROFILE

4" X 81/2" FILTER FABRIC (TYP.) FOR


ALL GRANITE CURB INSTALLATION -


VERTICAL CURB TYPE 1 STRAIGHT (TYP.)

ALL GRANITE CURB INSTALLATION


T 1" CURB REVEAL AT DRIVEWAY

GUTTER LINE AT DRIVEWAY

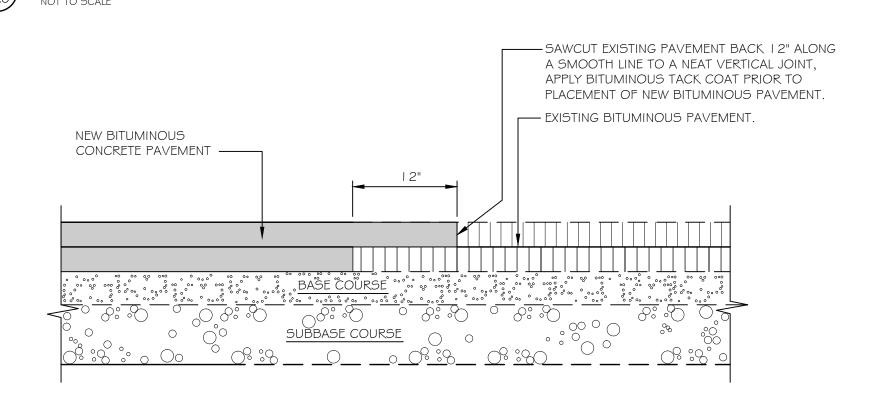

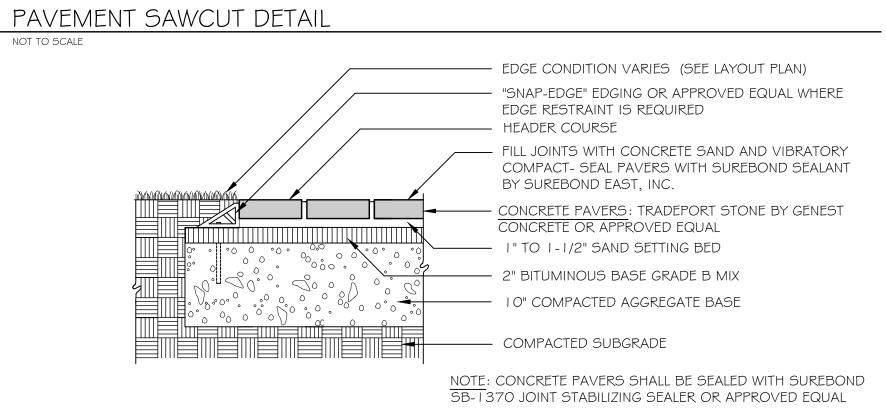



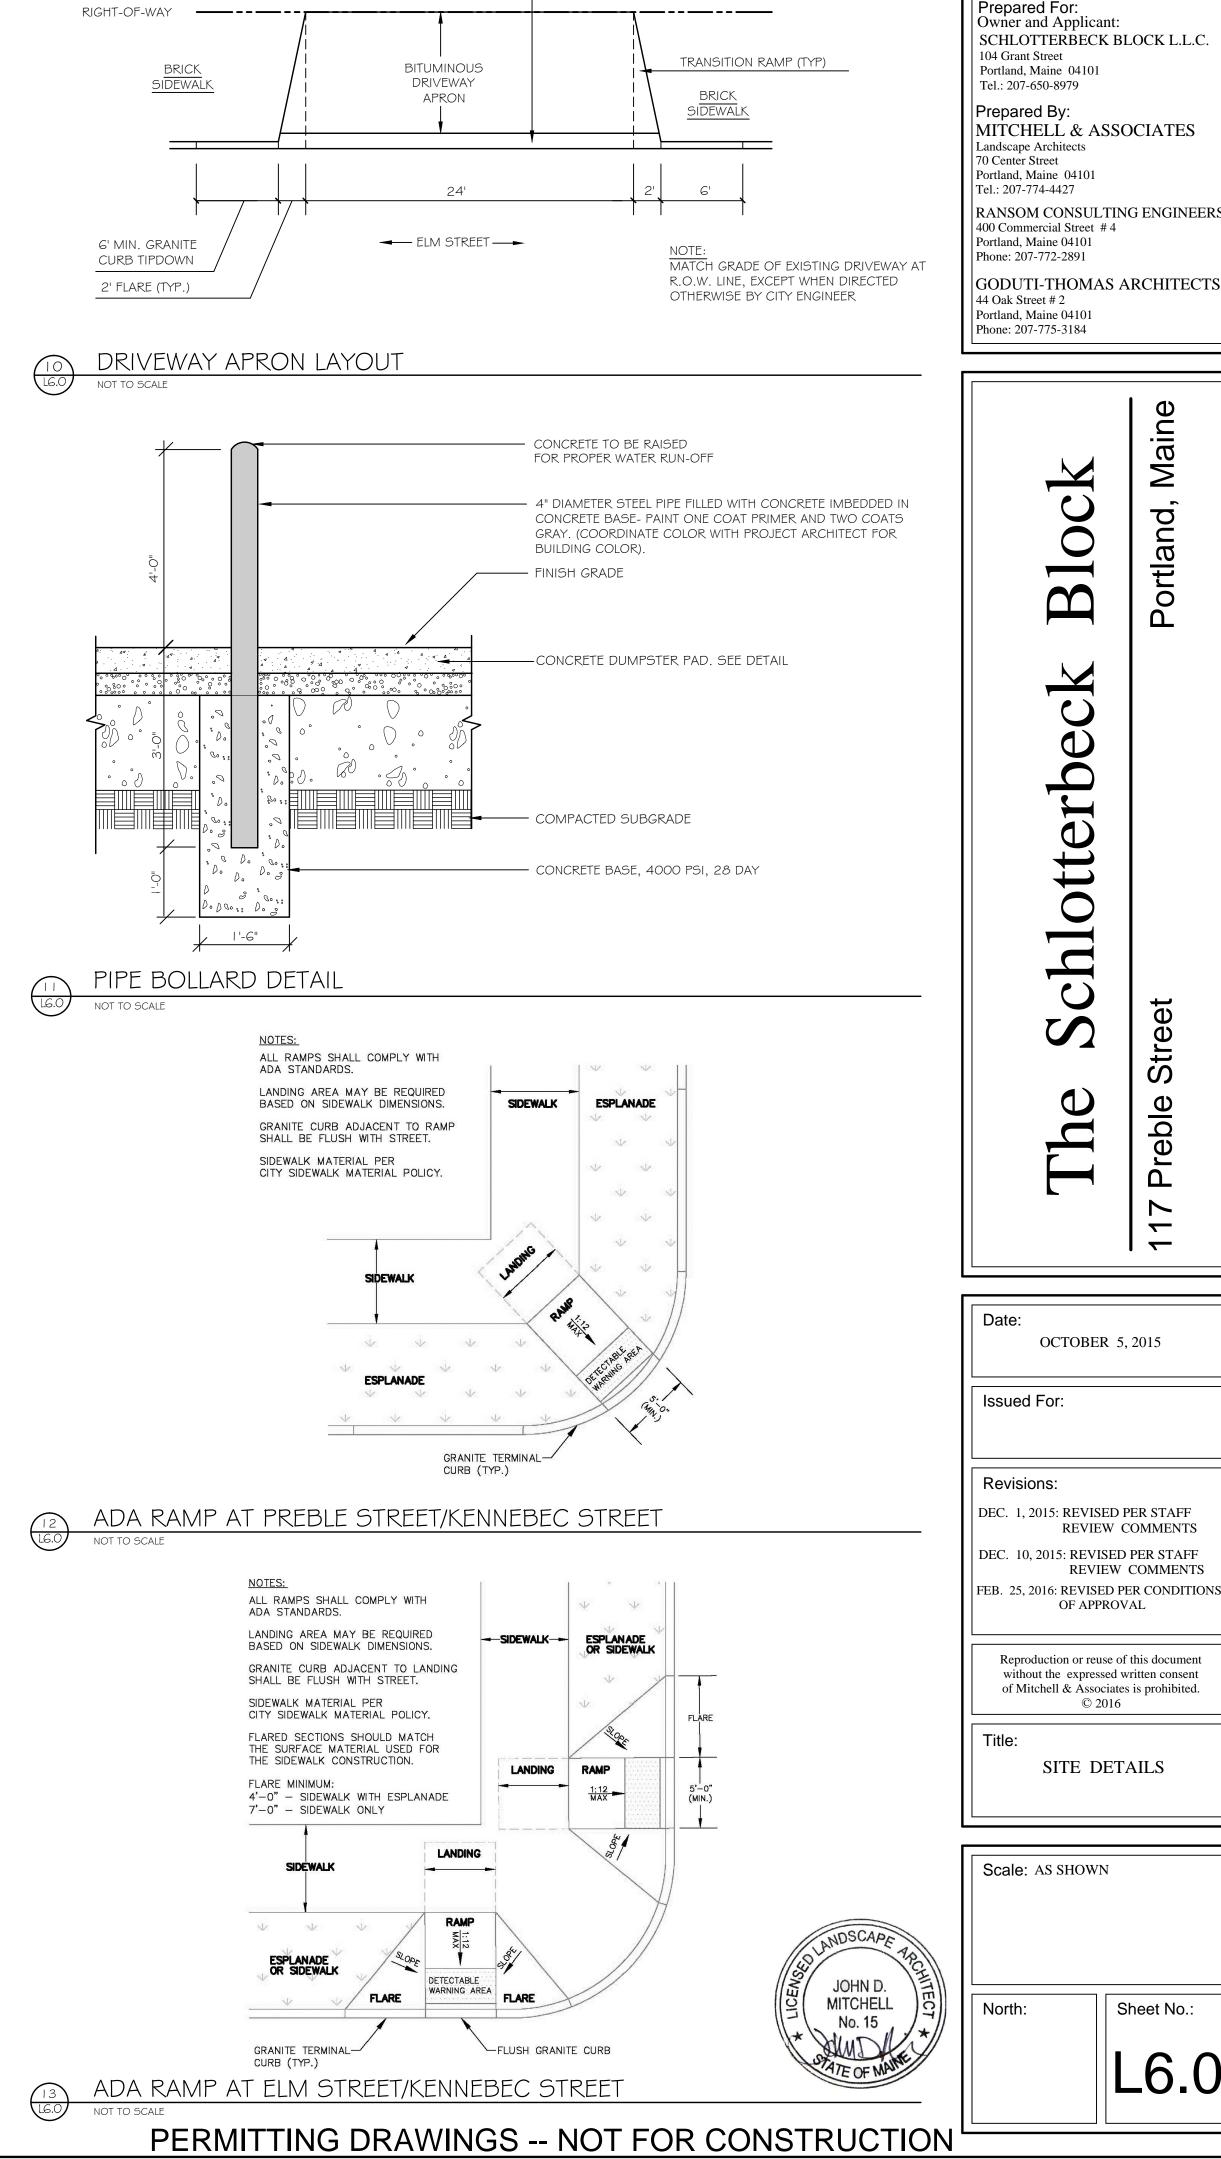

I' BITUMINOUS STRIP

ain

0

ortland


**D** 


eble


\_


Sheet No.:

**L6.**C

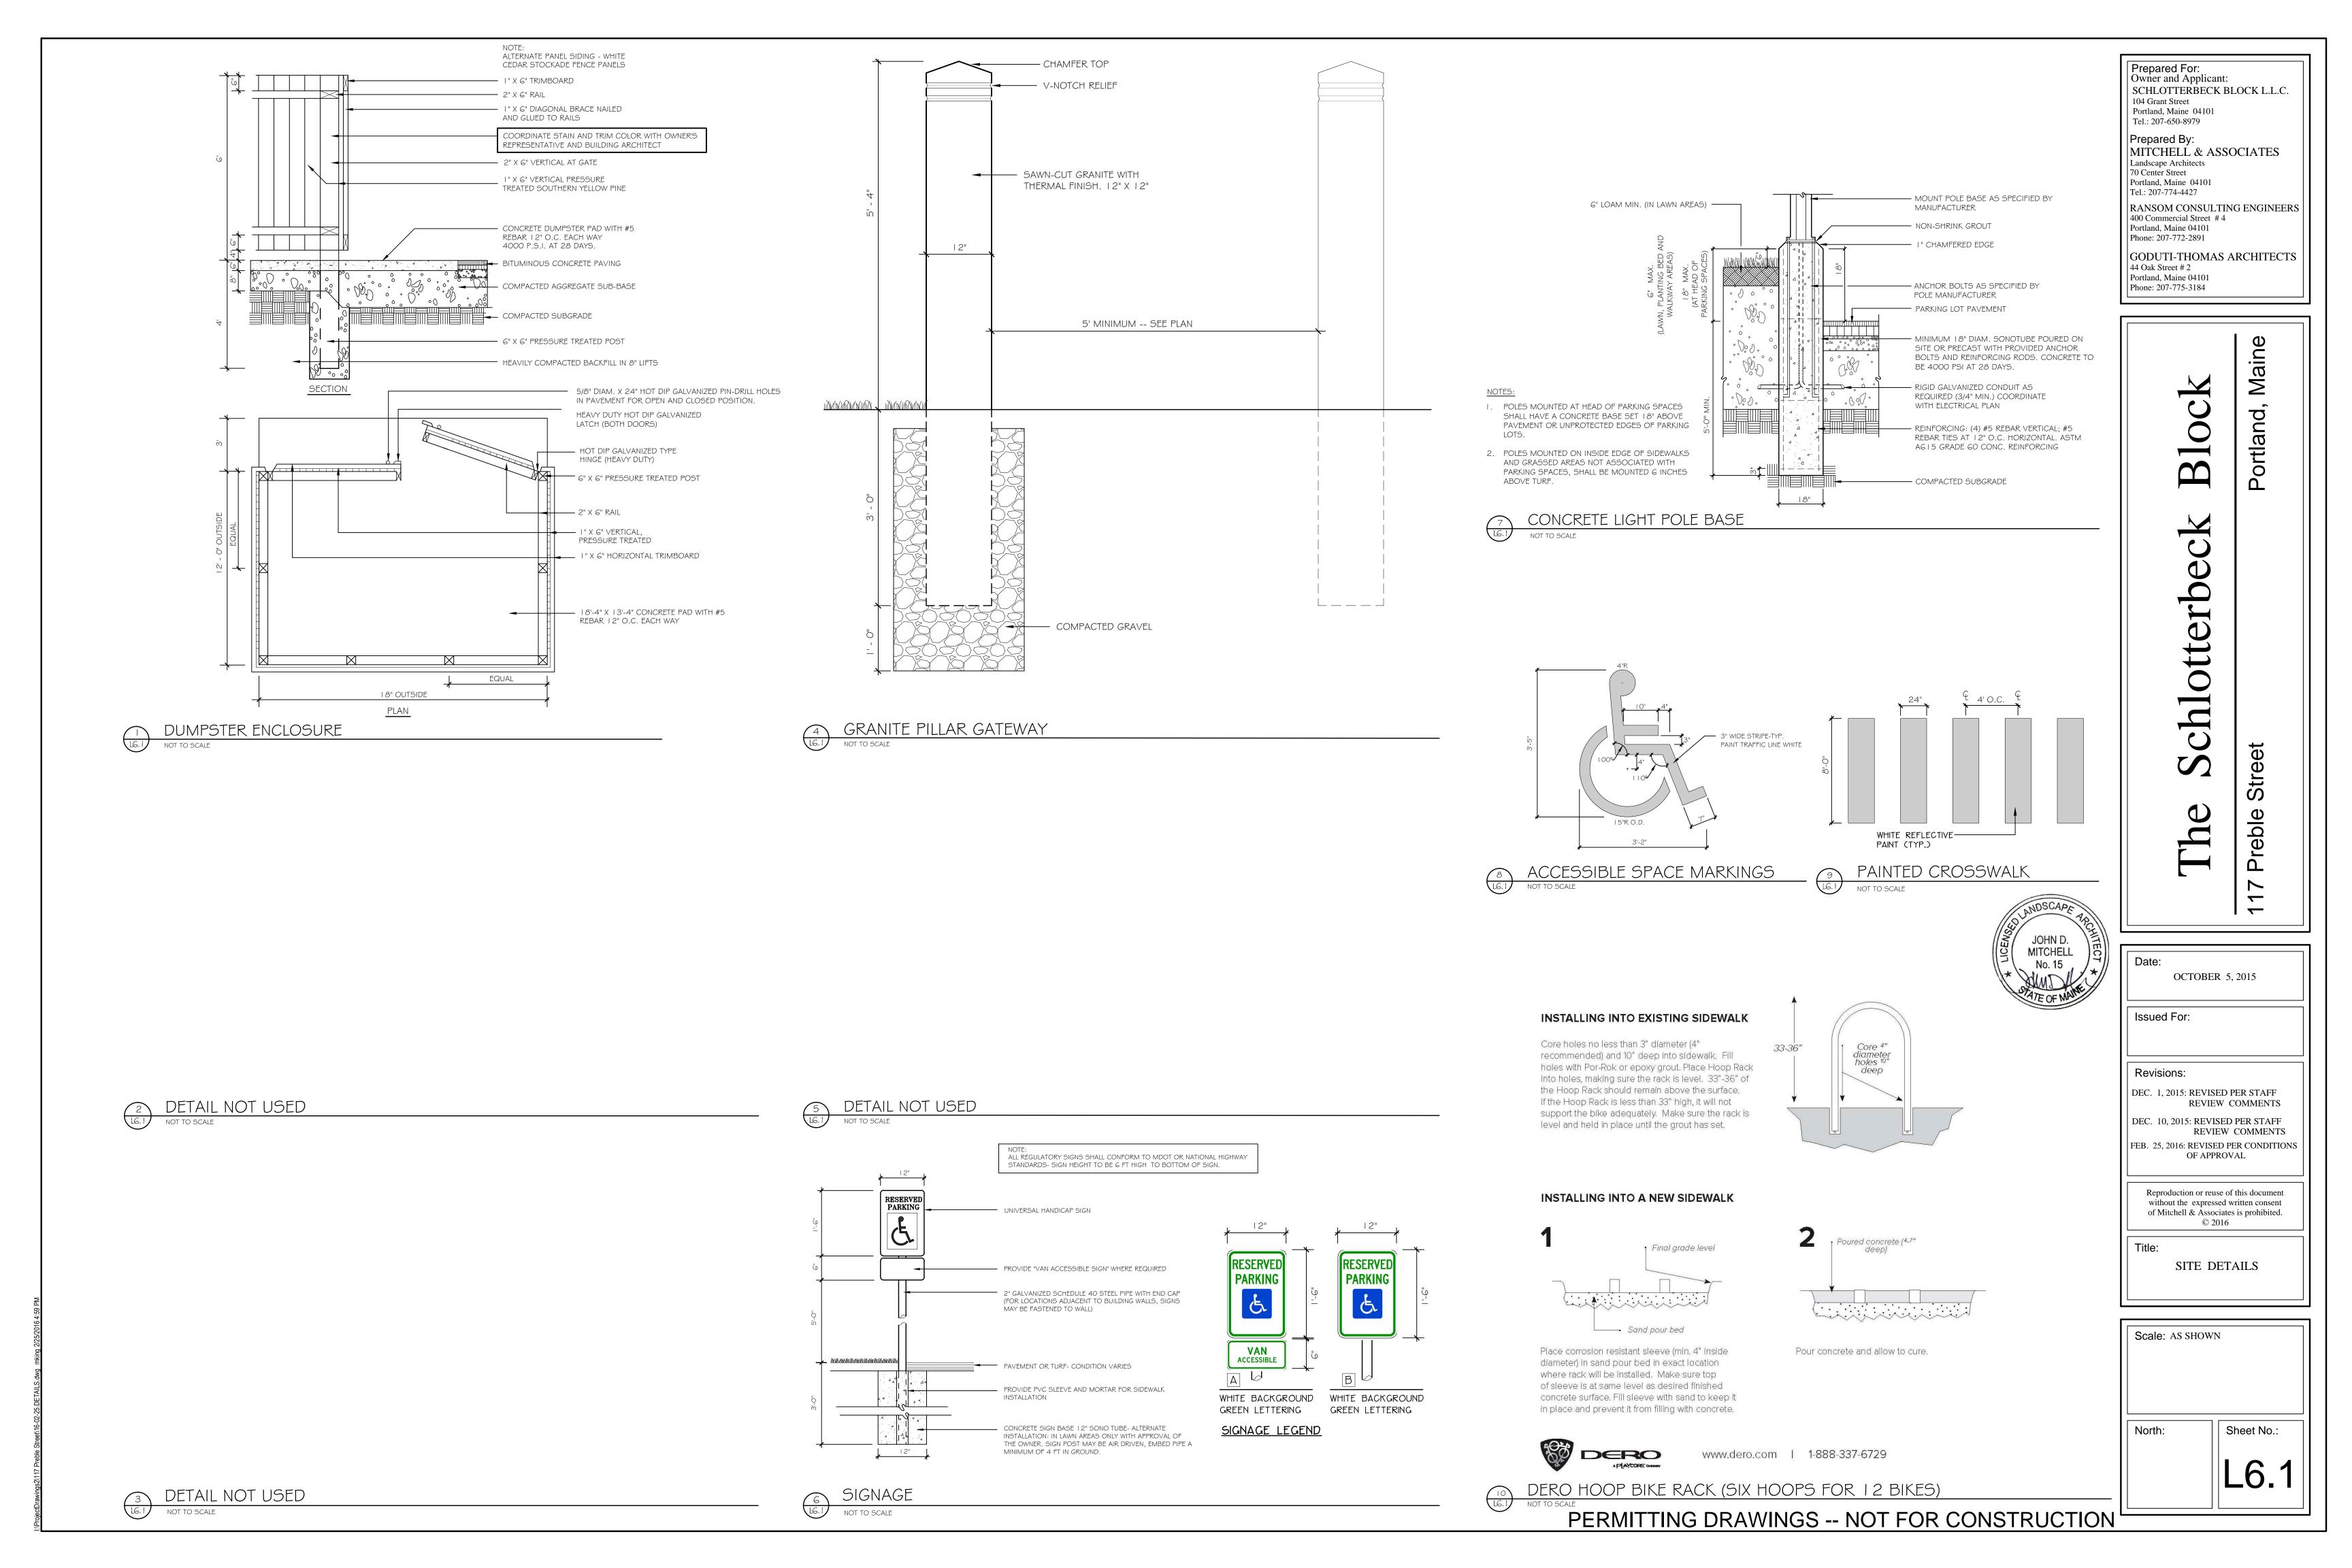


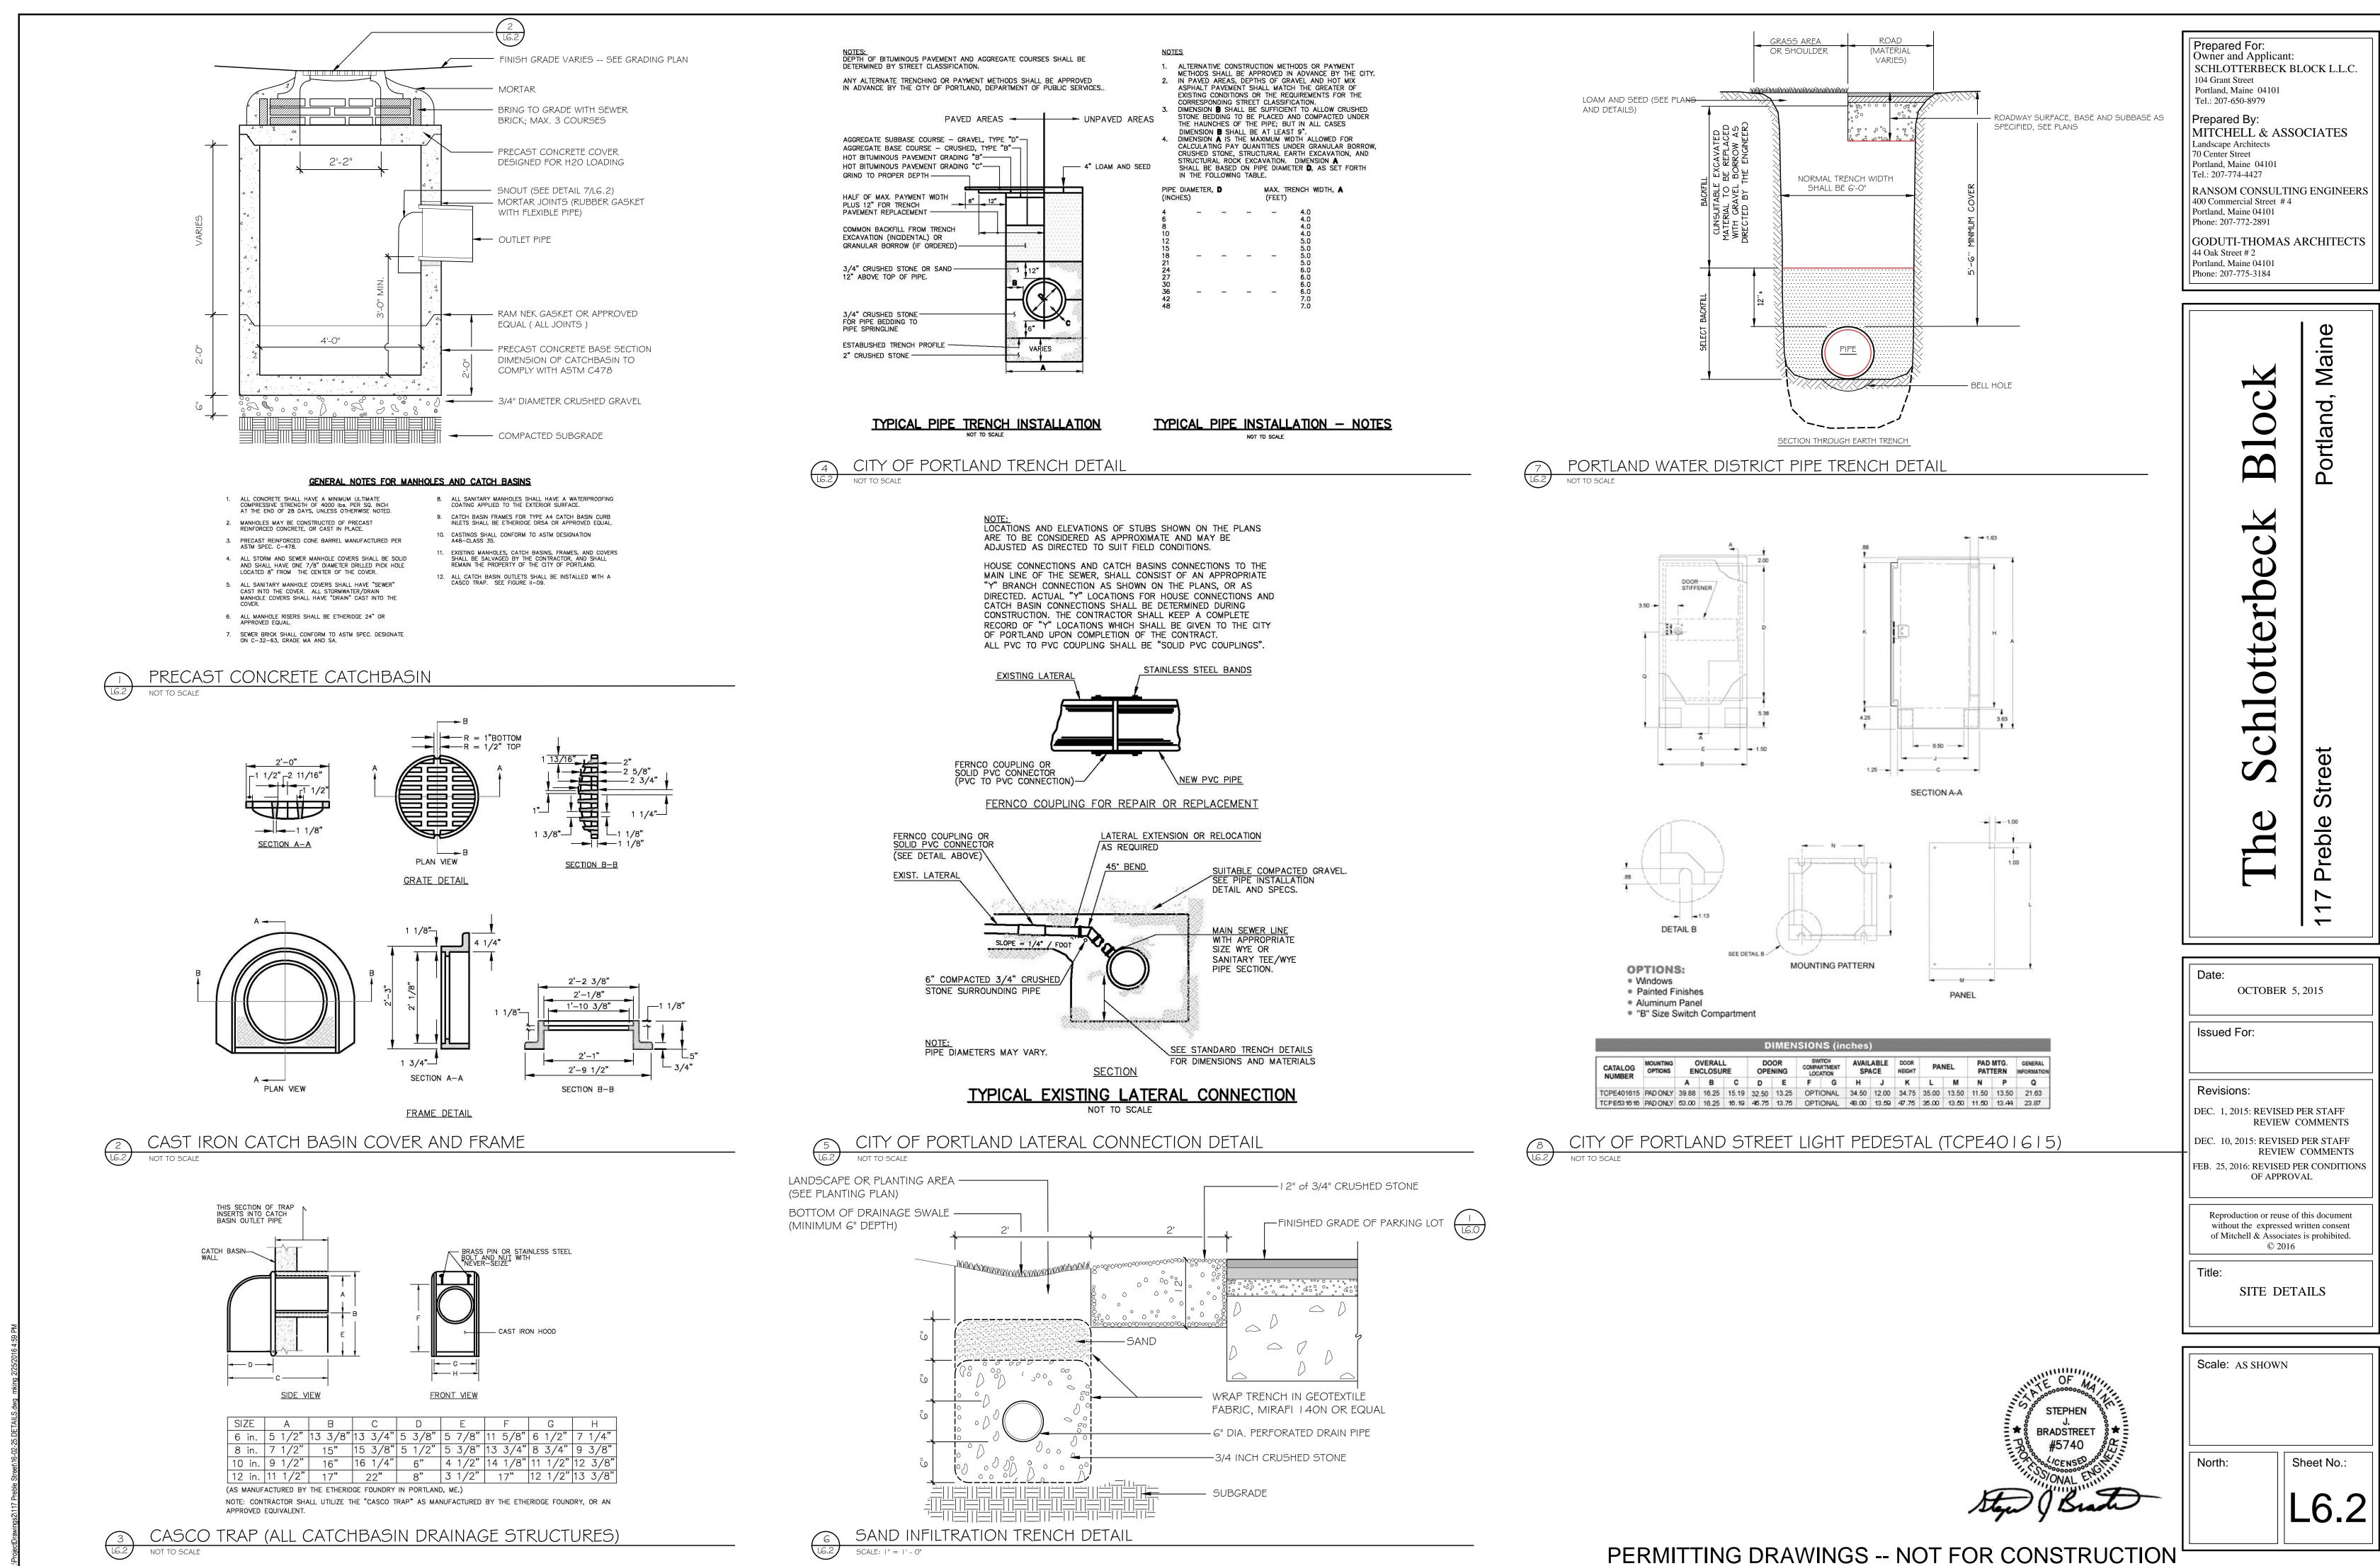


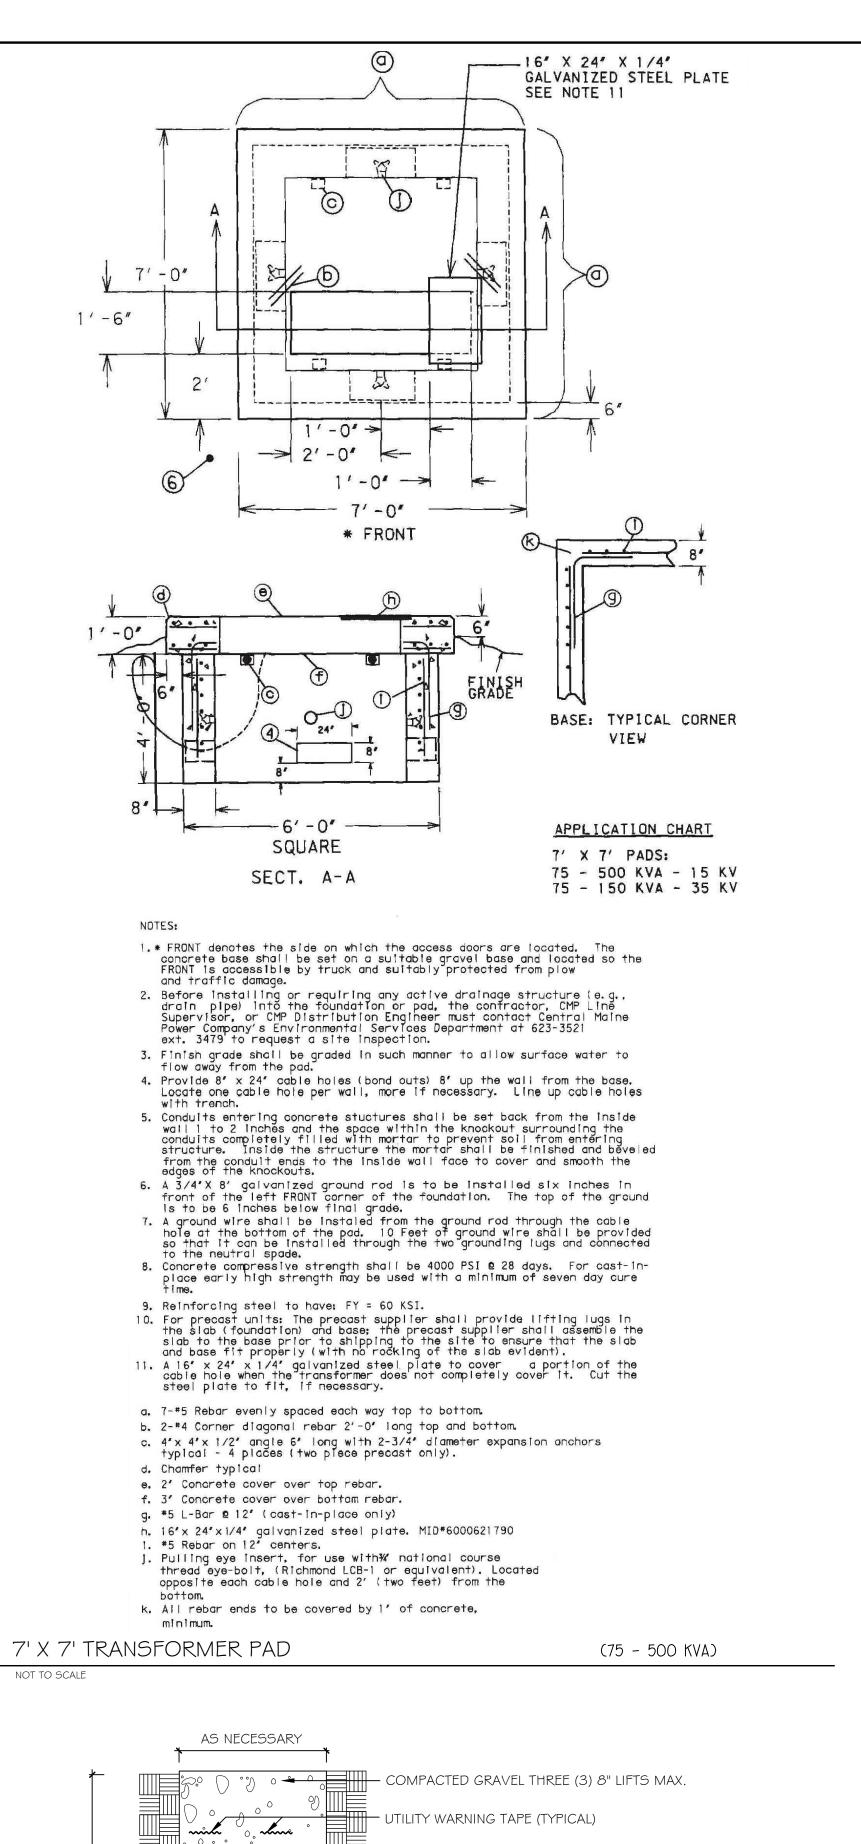

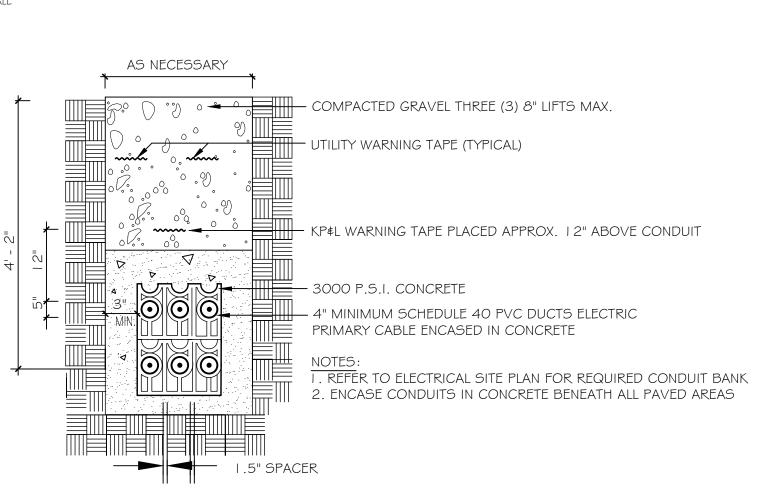

ELECTRIC TRENCH

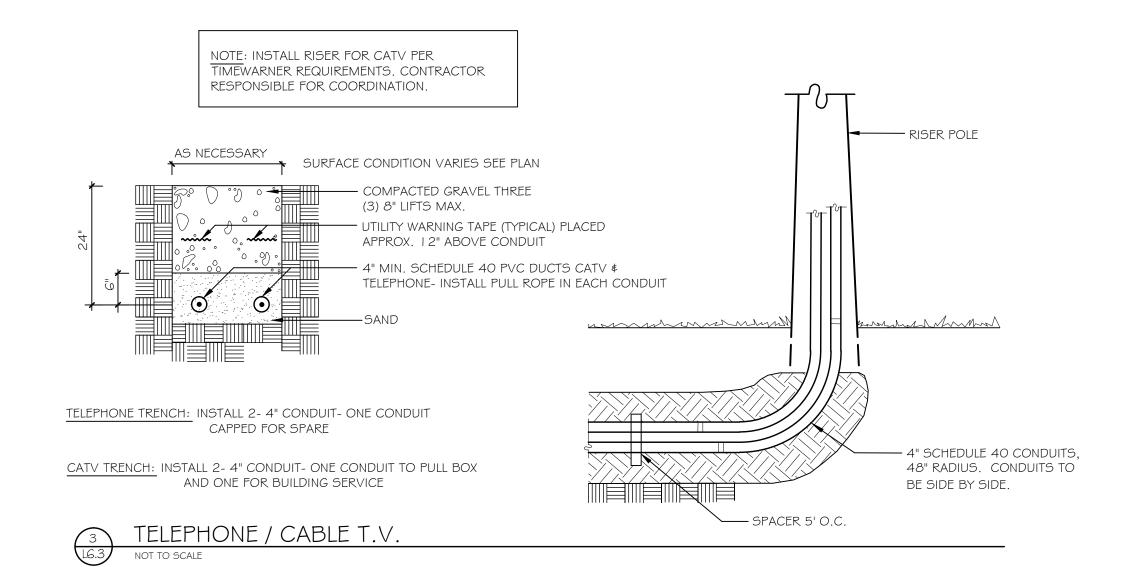


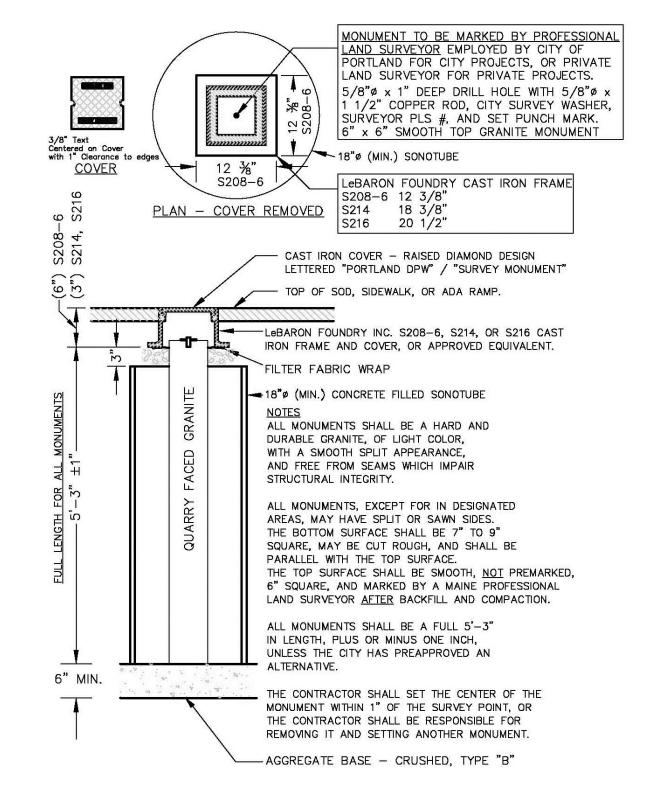

CITY OF PORTLAND GRANITE MONUMENT DETAIL



4'-HT. ORNAMENTAL FENCE DETAIL

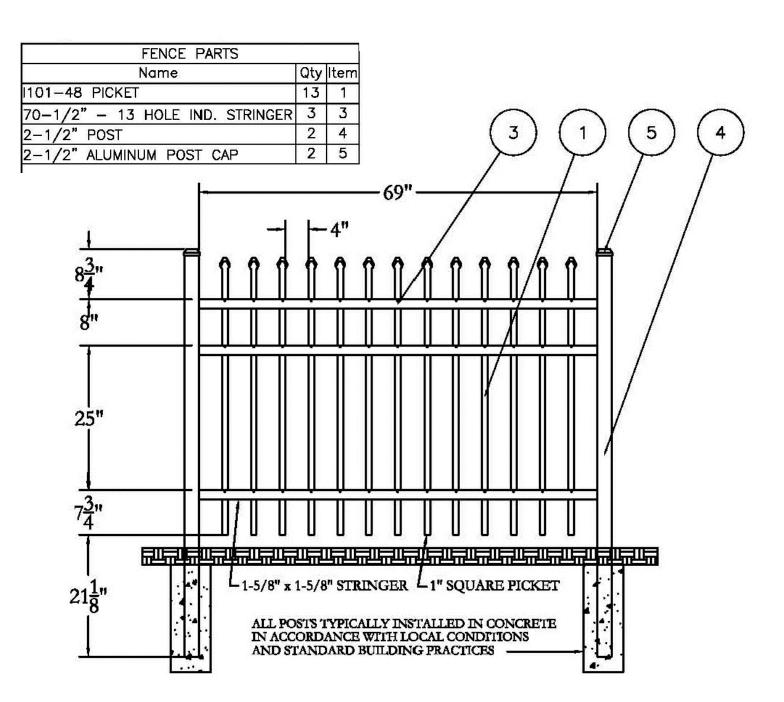

MITCHELL No. 15

Prepared For: Owner and Applicant: SCHLOTTERBECK BLOCK L.L.C. 104 Grant Street Portland, Maine 04101 Tel.: 207-650-8979

Prepared By: MITCHELL & ASSOCIATES Landscape Architects 70 Center Street

> Portland, Maine 04101 Tel.: 207-774-4427

RANSOM CONSULTING ENGINEERS 400 Commercial Street #4 Portland, Maine 04101 Phone: 207-772-2891

**GODUTI-THOMAS ARCHITECTS** 44 Oak Street # 2 Portland, Maine 04101

Phone: 207-775-3184

0

eble \_

Date: OCTOBER 5, 2015 Issued For: Revisions: DEC. 1, 2015: REVISED PER STAFF REVIEW COMMENTS DEC. 10, 2015: REVISED PER STAFF REVIEW COMMENTS FEB. 25, 2016: REVISED PER CONDITIONS OF APPROVAL

> Reproduction or reuse of this document without the expressed written consent of Mitchell & Associates is prohibited. © 2016

SITE DETAILS

Scale: AS SHOWN

North:

Sheet No.:

PERMITTING DRAWINGS -- NOT FOR CONSTRUCTION

DETAIL NOT USED