
33-E-1 117 Preble Street Schlotterbeck Block (55 Unit Apt.)

Schlotterbeck Block, LLC. (John Anton)

#2015-174

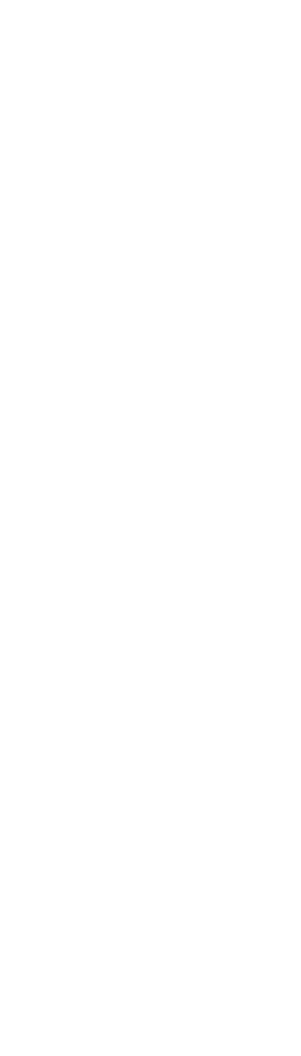

# The Schlotterbeck Block

117 Preble Street, Portland, Maine

October 5, 2015: Level III Site Plan and Subdivision Plan



# PREPARED BY:

LANDSCAPE ARCHITECT AND SITE PLANNER:

MITCHELL & ASSOCIATES 70 CENTER STREET
PORTLAND, MAINE 04101
PHONE: 207.774.4427
FAX: 207.874.2460
CONTACT: MICHAEL W. KING, RLA
E-MAIL: MKING@MITCHELLASSOCIATES.BIZ

ARCHITECT:

GODUTI-THOMAS ARCHITECTS PORTLAND, MAINE 04101 PHONE: 207.775.3184

CONTACT: RICHARD GODUTI, NCARB
EMAIL: GTARICK@GMAIL.COM

### CIVIL ENGINEER:

RANSOM CONSULTING ENGINEERS PORTLAND, MAINE 04101 CONTACT: STEPHEN BRADSTREET, P.E. E-MAIL: STEPEHN.BRADSTREET@RANSOMENV.COM

## LAND SURVEYOR

OWEN HASKELL, INC. 390 U.S. ROUTE ONE, SUITE 10 PHONE: 207.774.0424 CONTACT: JOHN SWAN, P.L.S.

# TRAFFIC ENGINEER

GORRILL-PALMER PHONE: 207.675.6910 CONTACT: RANDALL DUNTON, P.E.

# UTILITIES:

ELECTRIC: CENTRAL MAINE POWER

CENTRAL MAINE POWER
ELECTRICAL DISTRIBUTION ENGINEERING
162 CANCO ROAD
PORTLAND, MAINE 04103
PHONE: 207.942.2387
CONTACT: JAMIE COUGH
E-MAIL: JAMES.COUGH@CMPCO.COM

PORTLAND WATER DISTRICT 225 DOUGLASS STREET P.O. BOX 3553 PORTLAND, MAINE 04104-3553 PHONE: 207,774,5961 x,3199 FAX: 207,761,8307 FAX: 207.761.8507 CONTACT: GLISSEN HAVU E-MAIL: MEANS@PWD.ORG

# SANITARY SEWER:

CITY OF PORTLAND CITY OF PORTLAND
PUBLIC SERVICES DEPARTMENT
55 PORTLAND STREET
PORTLAND, MAINE 04101
PHONE: 207.874.8816
FAX: 207.874.8816
CONTACT: DAVID MARGOLIS-PINEO
E-MAIL: DMP@PORTLANDMAINE.GOV

# CABLE:

TIME WARNER CABLE OF MAINE
118 JOHNSON ROAD
PORTLAND, MAINE 04102
PHONE: 207.253.2324
CONTACT: MARK PELLETIER, CONSTRUCTION PROJECT COORDINATOR
E-MAIL: MARK/PELLETIER@TWCABLE.COM

# NATURAL GAS:

UNITIL SERVICE CORPORATION PORTLAND, MAINE 04103

# OWNER AND APPLICANT

SCHLOTTERBECK BLOCK LLC 77 SPRUCE STREET PORTLAND, MAINE 04101

# PERMITS:

TYPE OF PERMIT: SITE PLAN REVIEW:

GOVERNING BODY:


CITY OF PORTLAND 389 CONGRESS STREET 4TH FLOOR PORTLAND, MAINE 04101 TEL: 207,874,8728 CONTACT: RICHARD KNOWLAND RWK@PORTLANDMAINE.GOV STATUS:


SUBMITTED: OCTOBER 5, 2015


- OUTET	
SHEET	TITLE COVER PAGE
1	BOUNDARY AND TOPOGRAPHIC SURVEY
1 OF 1	SUBDIVISION PLAT
L1.0	EXISTING CONDITIONS PLAN
L1.1	CONSTRUCTION MANAGEMENT PLAN
L2.0	LAYOUT PLAN
L3.0	GRADING, DRAINAGE AND UTILITIES PLAN
L4.0	EROSION AND SEDIMENT CONTROL PLAN
L5.0	PLANTING PLAN
L6.0	SITE DETAILS
L6.1	SITE DETAILS
L6.2	SITE DETAILS
L6.3	SITE DETAILS
L7.0	LIGHTING PHOTOMETRICS PLAN (TO BE SUBMITTED)
SW-1	PRE-DEVLOPMENT STORMWATER DRAINAGE PLAN
SW-2	POST-DEVELOPMENT STORMWATER DRAINAGE PLAN
A1,1	FIRST FLOOR PLAN AND LOWER FLOOR PLAN
A1.2	ROOF PLAN AND 2nd - 5th FLOOR PLAN
A2,1	BUILDING ELEVATIONS
A2.2	BUILDING ELEVATIONS


# SITE LOCATION MAP:



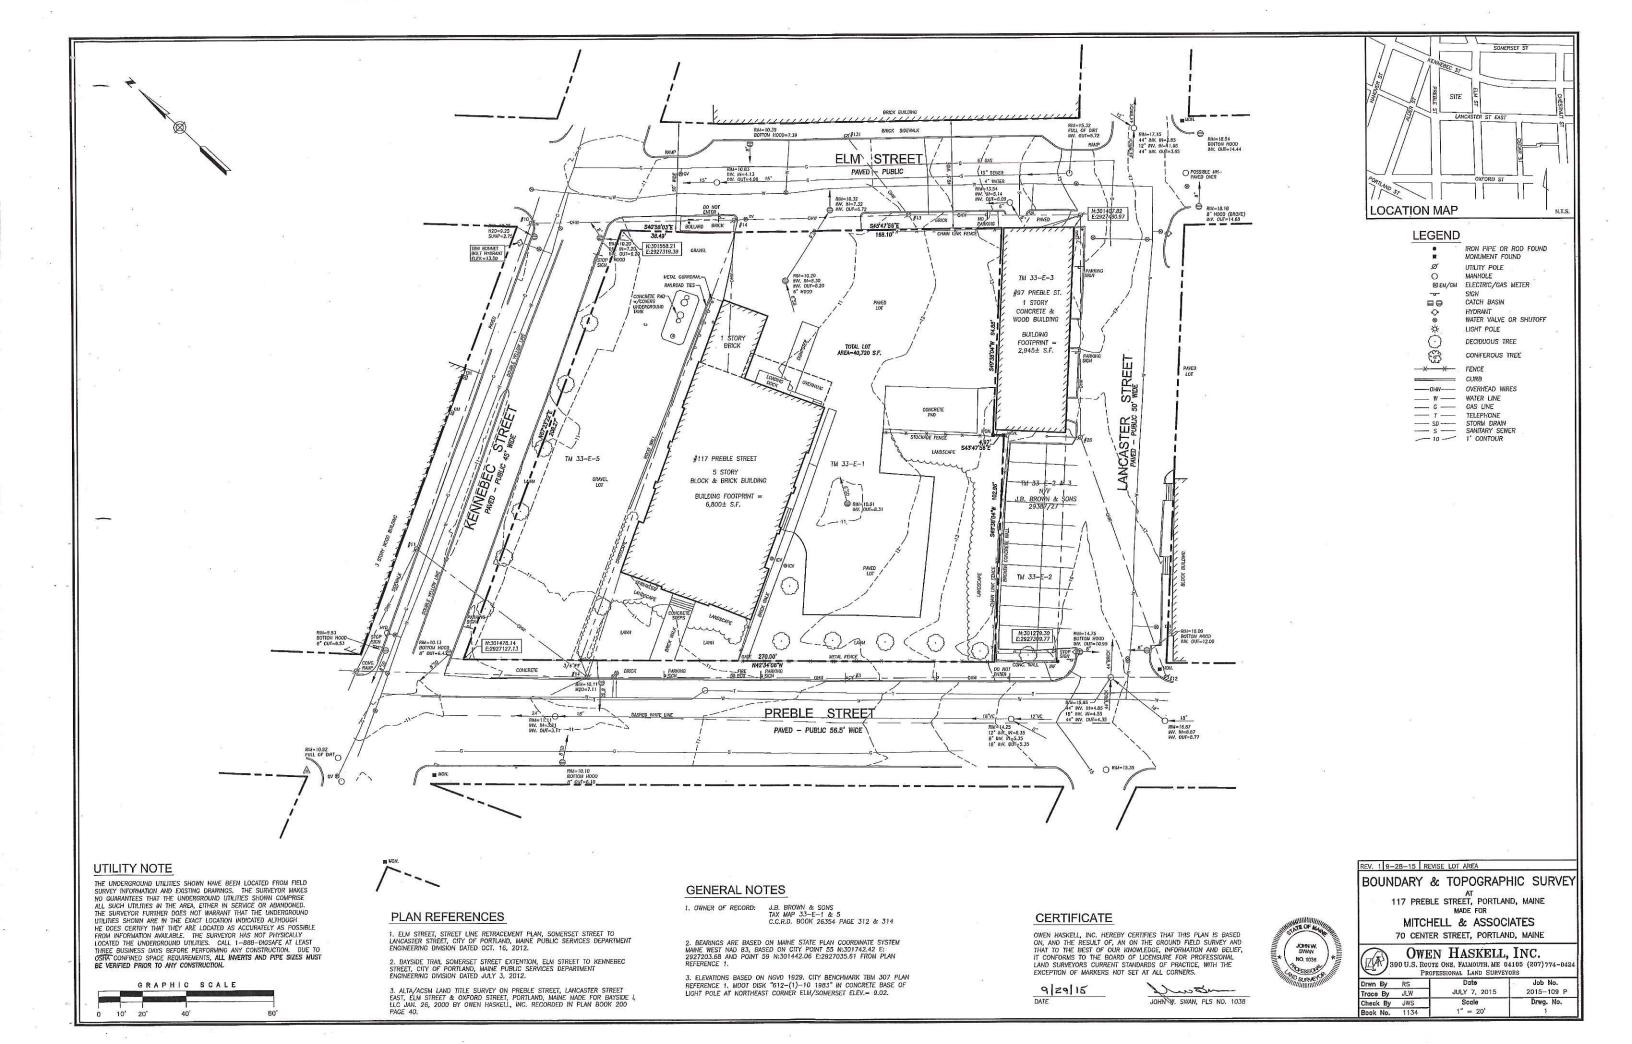

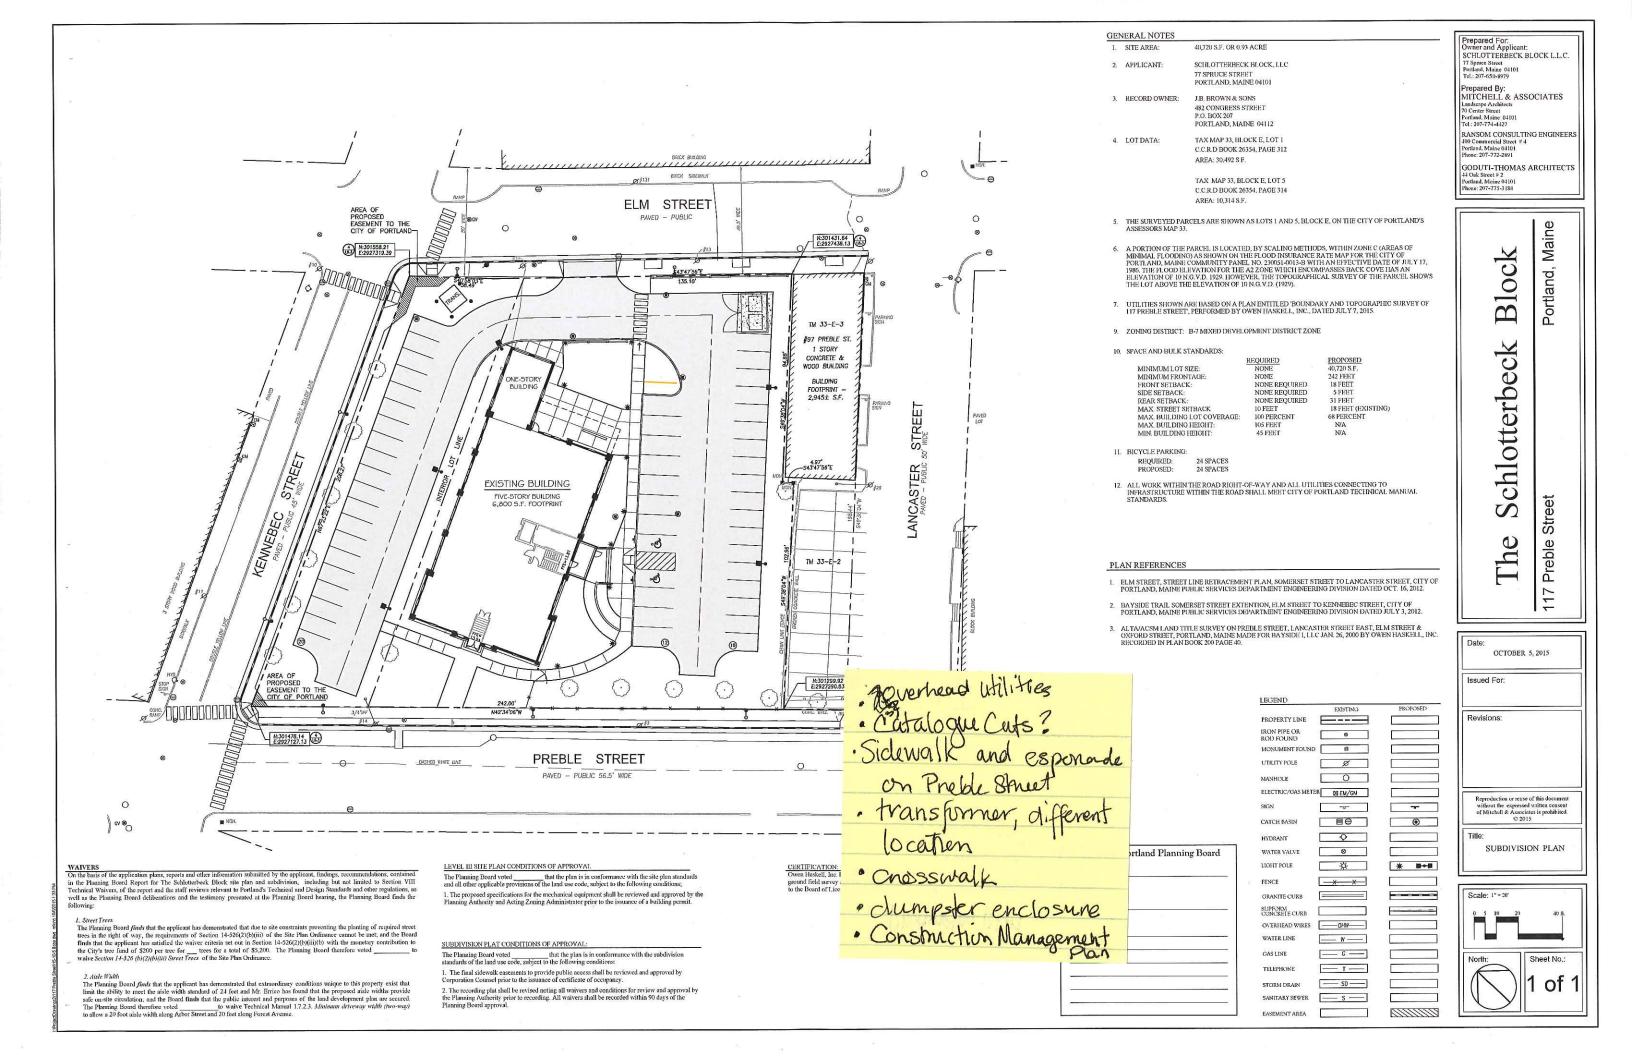

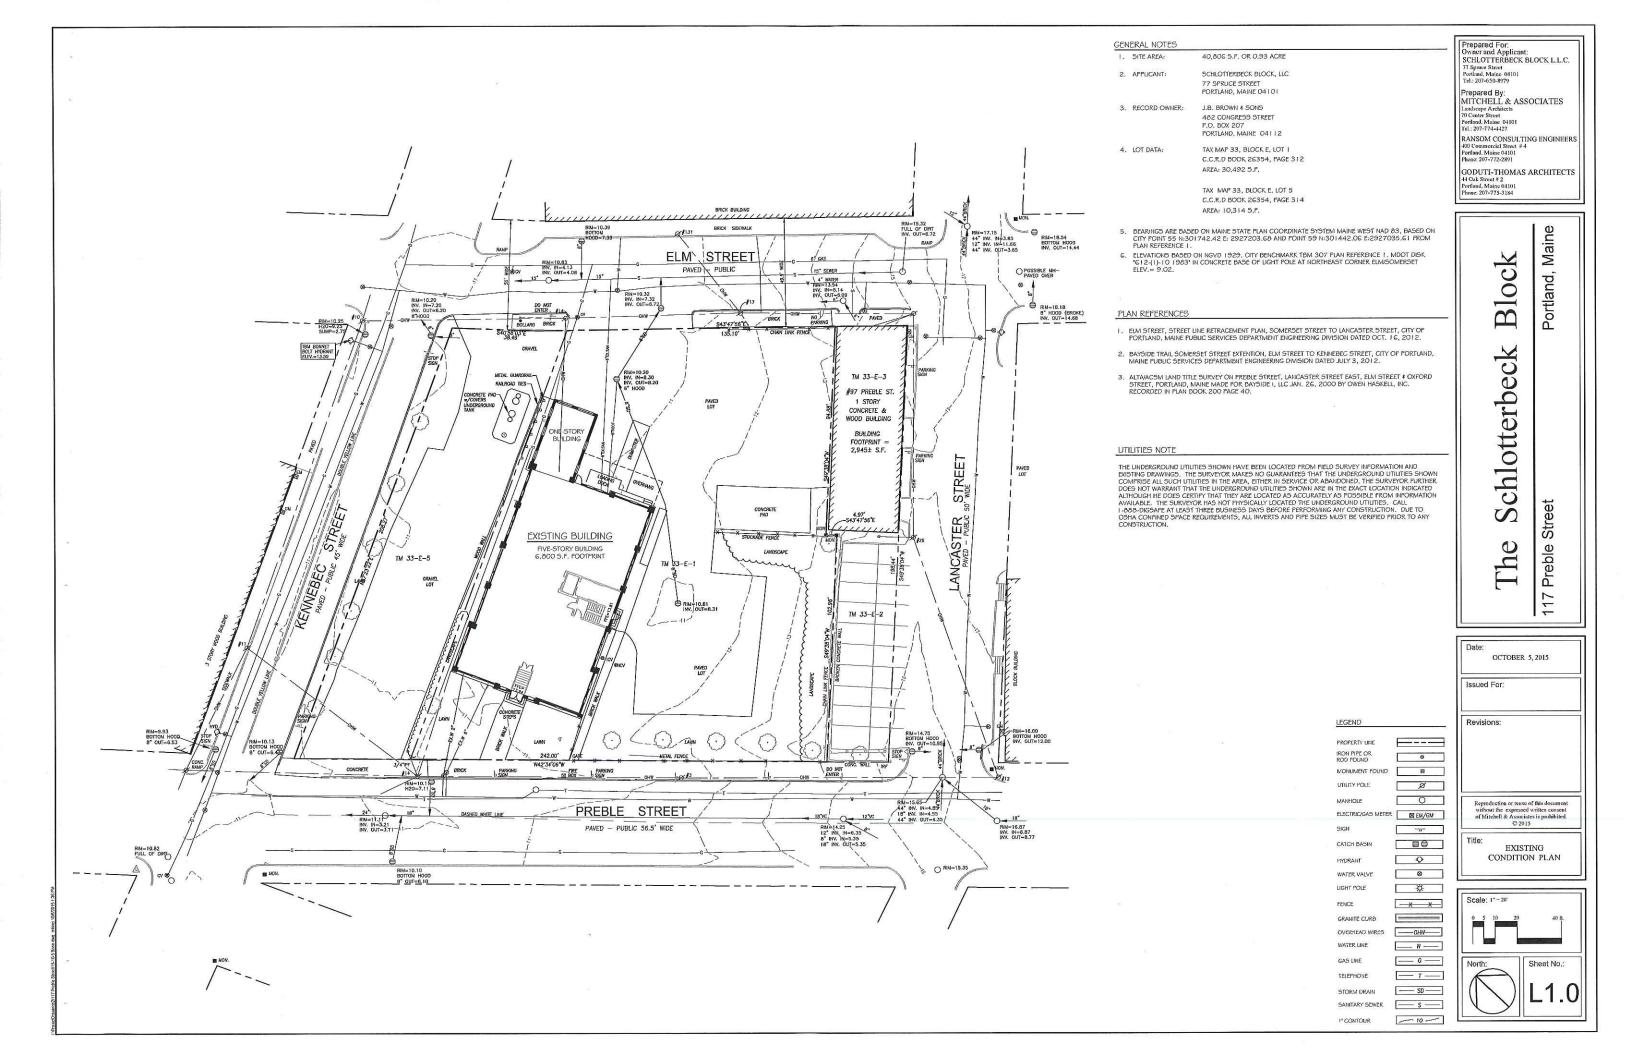

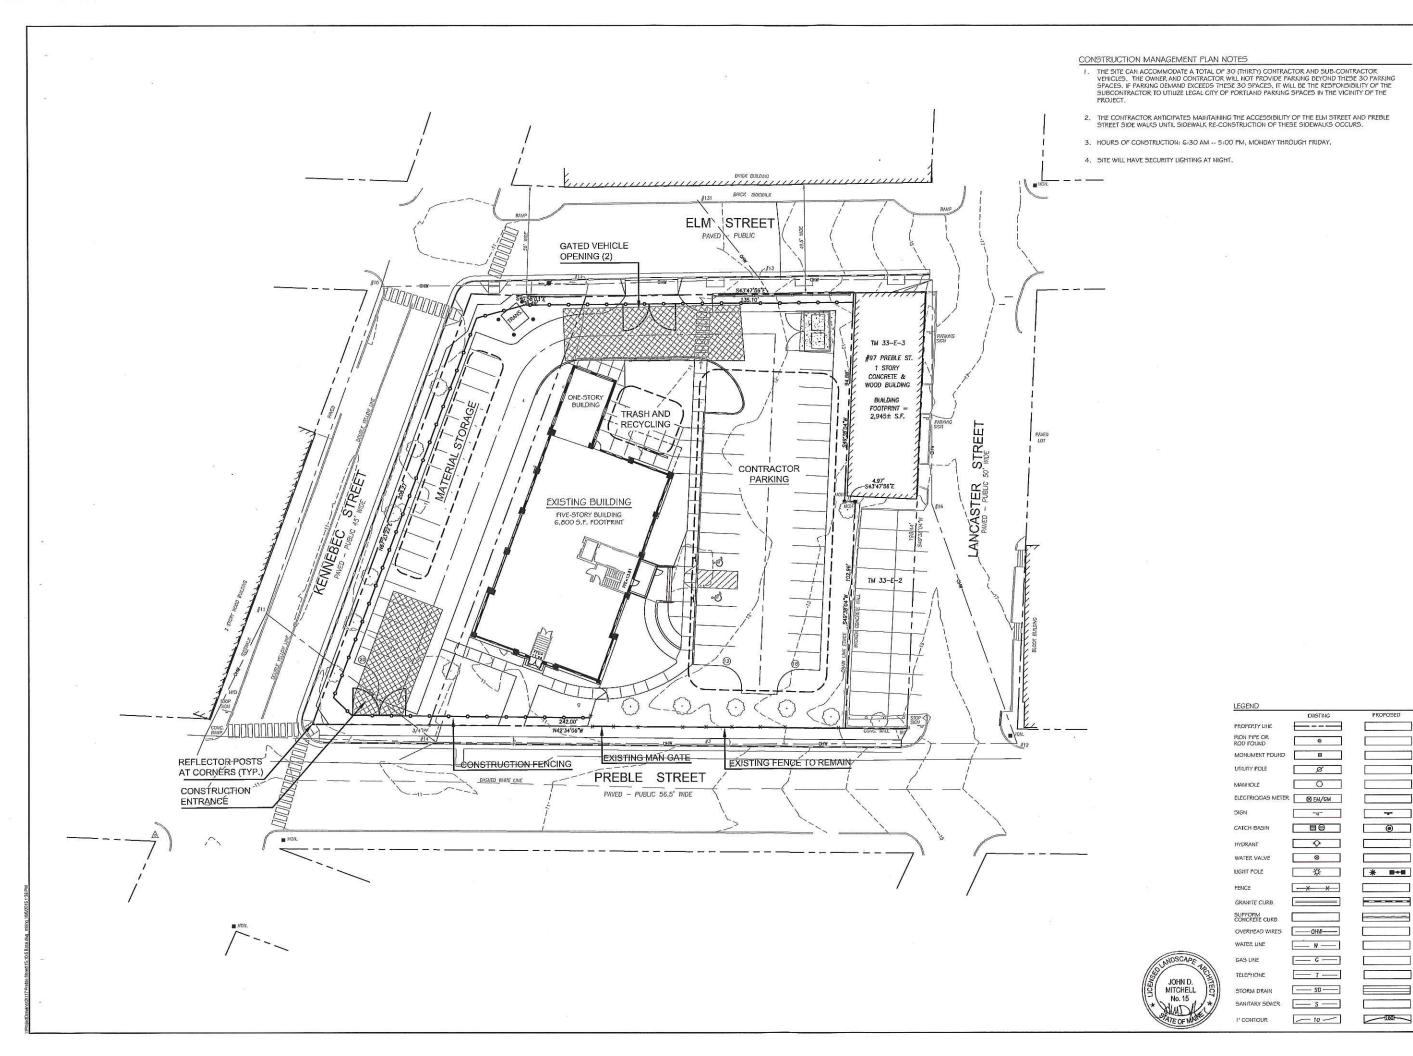

Prepared For: Owner and Applicant: SCHLOTTERBECK BLOCK L.L.C.

Prepared By: MITCHELL & ASSOCIATES Londscape Architects 70 Center Street Portland, Maine 04101 Tel.: 207-774-4427

RANSOM CONSULTING ENGINEERS 400 Commercial Street #4 Portland, Maine 04101 Phone: 207-772-2891

GODUTI-THOMAS ARCHITECTS 44 Oak Street # 2 Portland, Maine 04101 Phone: 207-775-3184

Maine

Block chlotterbeck

Street Preble

Date: OCTOBER 5, 2015

S


The

Issued For:


Revisions:

Reproduction or reuse of this document without the expressed written consent of Mitchell & Associates is prohibited. © 2015

CONSTRUCTION MANAGEMENT PLAN

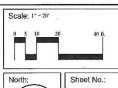



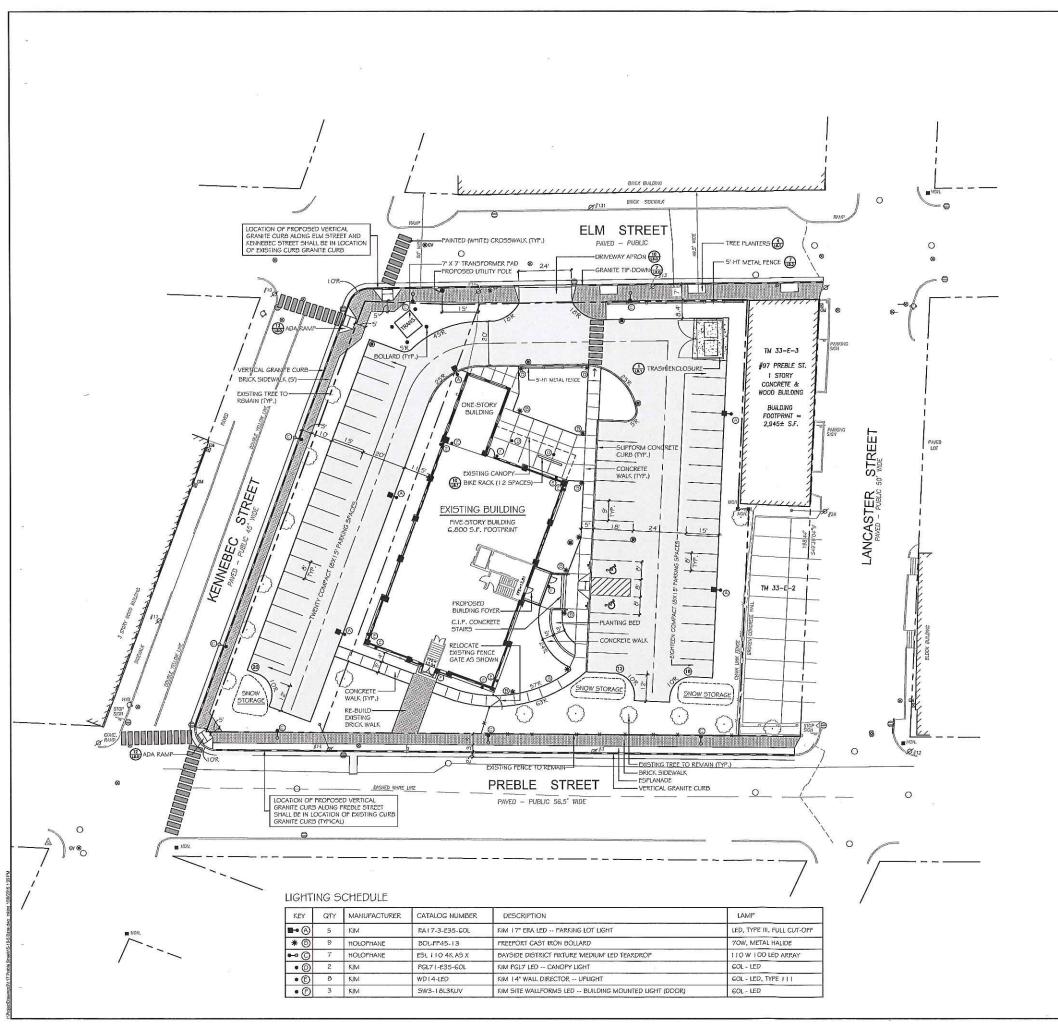

GENERAL NOTES

4. LOT DATA:

40,720 S.F. OR 0.93 ACRE 1. SITE AREA:

5CHLOTTERBECK BLOCK, LLC 2. APPLICANT:

77 SPRUCE STREET PORTLAND, MAINE 04101

3. RECORD OWNER: J.B. BROWN # SONS 482 CONGRESS STREET

P.O. BOX 207 PORTLAND, MAINE 04112

TAX MAP 33, BLOCK E, LOT J

C.C.R.D BOOK 26354, PAGE 312

AREA: 30,492 5.F.

TAX MAP 33, BLOCK E. LOT 5 C.C.R.D BOOK 26354, PAGE 314

AREA: 10,314 5.F.

THE SURVEYED PARCELS ARE SHOWN AS LOTS 1 AND 5, BLOCK E, ON THE CITY OF PORTLANDS ASSESSORS MAP 33.

6. A FORTION OF THE PARCEL IS LOCATED, BY SCALING METHODS, WITHIN ZONE C (AREAS OF MINIMAL FLOODING) AS SHOWN ON THE FLOOD INSURANCE RATE MAP FOR THE CITY OF FORTLAND, MAINE COMMUNITY PANEL NO. 23005 I-001 3-B WITH AN EFFECTIVE DATE OF JULY 17, 1986. THE FLOOD ELEVATION FOR THE AZ ZONE WHICH ENCOMPASSES BACK COVE HAS AN ELEVATION OF 10 N.G.Y.D. 1929. HOWEVER, THE TOPOGRAPHICAL SURVEY OF THE PARCEL SHOWS THE LOT ABOVE THE PENATURO FOR CV.D. (1921). ELEVATION OF 10 N.G.V.D. (1929).

UTILITIES SHOWN ARE BASED ON A PLAN ENTITLED 'BOUNDARY AND TOPOGRAPHIC SURVEY OF 117 PREBLE STREET, PERFORMED BY OWEN HASKELL, INC., DATED JULY 7, 2015.

9. ZONING DISTRICT: B-7 MIXED DEVELOPMENT DISTRICT ZONE

10. SPACE AND BULK STANDARDS:

	REQUIRED	PROPOSED
MINIMUM LOT SIZE:	NONE	40,720 S.F.
MINIMUM FRONTAGE:	NONE	242 PEET
FRONT SETBACK:	NONE REQUIRED	18 FEET
SIDE SETBACK:	NONE REQUIRED	5 FEET
REAR SETBACK:	NONE REQUIRED	31 FEET
MAX. STREET SETBACK	I O FEET	18 FEET (EXISTIN
MAX. BUILDING LOT COVERAGE:	I OO PERCENT	GB PERCENT
MAX. BUILDING HEIGHT:	105 FEET	N/A
MIN. BUILDING HEIGHT:	45 FEET	NA

II. BICYCLE PARKING:

24 SPACES (22 RESIDENTIAL, 2 COMMERCIAL) PROPOSED: 24 SPACES (12 EXTERIOR, 12 INTERIOR)

12. ALL WORK WITHIN THE ROAD RIGHT-OF-WAY AND ALL UTILITIES CONNECTING TO INFRASTRUCTURE WITHIN THE ROAD SHALL MEET CITY OF PORTLAND TECHNICAL MANUAL STANDARDS.

13. PARKING SUMMARY:

PARKING REQUIRED PER PARKING ANALYSIS: 50 SPACES PROPOSED PARKING: 50 SPACES PROPOSED COMPACT (8' X 15'): REQUIRED A.D.A. ACCESSIBLE SPACES : PROPOSED A.D.A ACCESSIBLE SPACES: 38 5PACES (76%) 2 5PACES 2 SPACES

LEGE

END		6
	EXIST(IIG	PROPOSED
DEERTY LINE		
N PIPE OR [	0	
NUMENT FOUND	a	
JITY POLE [	Ø	
NHOLE [	0	
CTRIC/GAS METER	⊠ EM/GM	
м [	-0-	
Cri BASIN		•
RANT	<b>\$</b>	
TER VALVE	8	
T POLE	茶	<b>※ ■・■</b>
CE [	_xx_	
ANITÉ CURB		
FORM CURB		
ERHEAD WIRES	OHW	
TER LINE	w	
5 LINE [	G]	
EPHONE	— T —	
DRM DRAIN	so	

Prepared For: Owner and Applicant: SCHLOTTERBECK BLOCK L.L.C. 77 Spruce Street Portland, Maine 04101 Tel.: 207-650-8979

Prepared By: MITCHELL & ASSOCIATES

RANSOM CONSULTING ENGINEERS 400 Commercial Street # 4 Portland, Maine 04101 Phone: 207-772-2891

GODUTI-THOMAS ARCHITECTS

44 Oak Street # 2 Portland, Maine 04101 Phone: 207-775-3184

Maine Block Portland,

chlotterbeck 0 Th

Street


Preble


117


Date: OCTOBER 5, 2015 Issued For: Revisions:

Reproduction or reuse of this document without the expressed written consent of Mitchell & Associates is prohibited. © 2015

LAYOUT AND LIGHTING PLAN

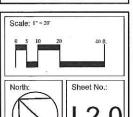

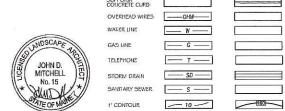

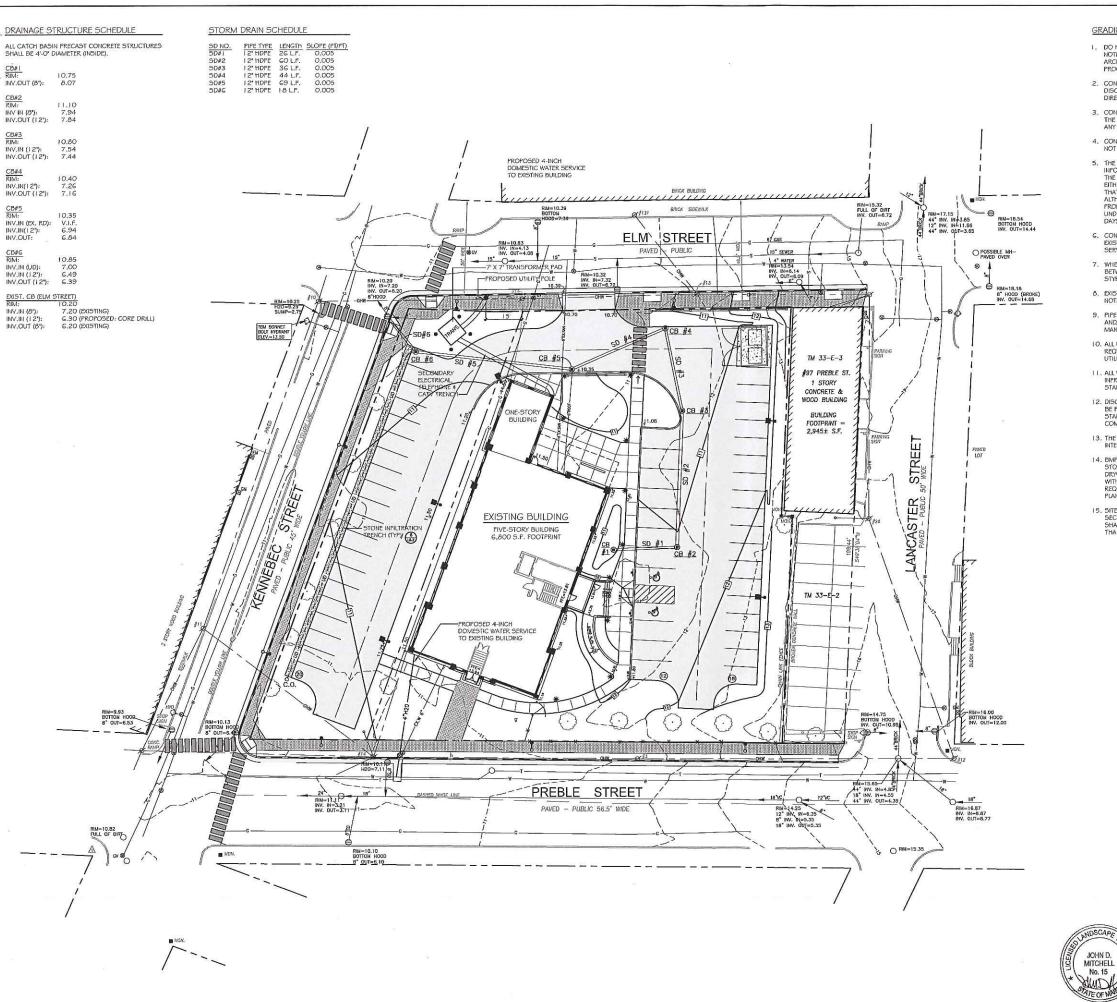

## GRADING AND DRAINAGE NOTES:

- DO NOT SCALE THESE DRAWNIGS, ANY DISCREPANCIES DETWEEN DRAWNIGS, DETAILS, NOTES AND SPECIFICATIONS SHALL BE IMMEDIATELY REPORTED TO THE LANDSCAPE ARCHITECT FOR FURTHER DIRECTION AND RESOLUTION BEFORE ADDITIONAL WORK. PROCEEDS
- CONTRACTOR SHALL VERIFY ALL DIMENSIONS AND GRADES ON THE GROUND. ANY DISCREPANCIES SHALL BE REPORTED IMMEDIATELY TO THE LANDSCAPE ARCHITECT FOR DIRECTION AND RESOLUTION PRIOR. TO ANY FURTHER WORK.
- CONTRACTOR SHALL FIELD VERIFY LOCATION AND DEPTH OF ALL EXISTING UTILITIES WITH THE APPROPRIATE UTILITY COMPANIES PRIOR TO EXCAVATION OF OR INSTALLATION OF ANY PART OF THIS WORK.
- CONTRACTOR SHALL AVOID ALL AREAS NOT REQUIRING GRADING. CONTRACTOR SHALL NOT DISTURB THESE AREAS.
- 5. THE UNDERGROUND UTILITIES SHOWN HAVE BEEN LOCATED FROM FIELD SURVEY INFORMATION AND EXISTING DRAWINGS. THE SURVEYOR MAKES NO GUARANTEES THAT THE UNDERGROUND UTILITIES SHOWN COMPRISE ALL SUCH UTILITIES IN THE AREA, ETHER IN SERVICE OR ABANDONED. THE SURVEYOR FURTHER DOES NOT WARRANT THAT THE UNDERGROUND UTILITIES SHOWN ARE IN THE EXACT LOCATION INDICATED ALTHOUGH HE DOES CERTIFY THAT THEY ARE LOCATED AS ACCURATELY AS POSSIBLE FROM INFORMATION AVAILABLE. THE SURVEYOR HAS NOT PHYSICALLY LOCATED THE UNDERGROUND UTILITIES. CALL DIGSAFE (1-886-344-7233) AT LEAST THREE BUSINESS DAYS BEFORE FERFORMING ANY CONSTRUCTION.
- 6. CONTRACTOR SHALL COMDUCT TEST PIT EXCAVATION TO CONFIRM LOCATION OF EXISTING UTILITIES WHERE NEW UNIDERGROUND ELECTRICAL, TELEPHONE AND CATV SERVICES ARE PROPOSED.
- WHERE STORM DRAINS OR SEWER MAINS HAVE LESS THAN FOUR (4) FEET OF COVER BETWEEN TOP OF PIPE AND FINISH GRADE, INSULATE PIPE USING TWO (2) INCH THICK STYROFOAM INSULATION BOARD OVER AND ALONG SIDES OF THE PIPE.
- EXISTING DRAINAGE CATCHBASIN SHALL BE CORED TO ACCEPT NEW DRAINAGE PIPE AS NOTED.
- PIPE LENGTH EQUALS THE CENTER TO CENTER DISTANCES BETWEEN CATCH BASINS AND/OR MANHOLES MINUS ONE-HALF OF THE DIAMETER OF EACH CATCH BASIN OR MANHOLE.
- 10. ALL UTILITIES SHALL BE INSTALLED IN COMPORMANCE WITH INDIVIDUAL UTILITY DISTRICT REQUIREMENTS; CONTRACTOR SHALL COORDINATE INSTALLATION WITH APPROPRIATE UTILITY DISTRICT BEFORE INSTALLATION.
- II. ALL WORK WITHIN THE ROAD RIGHT-OF-WAY AND ALL UTILITIES CONNECTING TO IMPRASTRUCTURE WITHIN THE ROAD SHALL MEET CITY OF PORTLAND TECHNICAL MANUAL STANDARDS.
- 12. DISCONTINUED UTILITY SERVICES INCLUDING WATER, GAS AND SANITARY SEWER SHALL BE PERMANENTLY CAPPED CONFORMING TO UTILITY COMPANY AND CITY OF PORTLAND STANDARDS, CONTRACTOR SHALL COORDINATE WITH PUBLIC SERVICES AND/OR UTILITY COMPANY.
- 13. THE PROJECT BENCH MARK IS BONNET BOLT OF FIRE HYDRANT LOCATED AT INTERSECTION OF ELM STREET AND KENNEBEC STREET, BENCHMARK ELEVATION: 13.50.
- 1.4. BMP INSPECTIONS: THE OWNER SHALL HIRE A QUALIFIED POST-CONSTRUCTION STORMWATER INSPECTOR TO ANNUALLY, INSPECT THE BMPS, INCUDING CATCH BASIN, DRIWBLI, IN-LINE ROOP FILTERS, PIEPS AND RELATED STRUCTURES, IN ACCORDANCE WITH ALL MUNICIPAL AND STATE INSPECTION, CLEANING AND MAINTENANCE REQUIREMENTS OF THE AFPROVED POST-CONSTRUCTION STORWWATER MANAGEMENT PLAN (PER SECTION 32 OF THE CITY OF PORTLAND CODE OF ORDINANCES).
- 15. SITE LIGHTING SHALL MEET THE CITY OF PORTLAND STANDARDS AS OUTLINED IN SECTION 12 OF THE CITY OF PORTLAND TECHNICAL DESIGN STANDARDS, SITE LIGHTING SHALL ADHERE TO SECTION 12.2.5 LIGHT TRESPASS-LIGHTING SHALL NOT BE GREATER THAN 0.1 POOTCANDLES AT THE PROPERTY LINE.

LEGEND PROPOSED PROPERTY LINE Ø 0 MANHOLE ELECTRIC/GAS METER ⊠ EM/GM SIGN ---CATCH BASIN O HYDRANT 8 WATER VALVE 举 \* === \_<del>-x-x</del>-FENCE = SUPFORM CONCRETE CURB OVERHEAD WIRES ——онw—— WATER LINE \_\_\_ w \_\_\_ GAS LINE --- G ---TELEFHONE — r — ---- SD ----SANITARY SEWER \_\_\_ s \_\_\_ 1150 \_\_\_ 10 \_\_\_ I' CONTOUR O c.o. CLEANOUT STONE INFILTRATION [ 

Prepared For:
Owner and Applicant:
SCHLOTTERBECK BLOCK L.L.C.
77 Spruce Street

Portland, Maine 04101 Tel.: 207-650-8979

Phone: 207-772-2891

Prepared By: MITCHELL & ASSOCIATES

Tel.: 207-774-4427

RANSOM CONSULTING ENGINEERS
400 Commercial Street # 4
Portland, Maine 04101

GODUTI-THOMAS ARCHITECTS 44 Oak Street # 2 Portland, Maine 04101 Phone: 207-775-3184

ck Block
Portland, Maine


The Schlotterb

Š

Prebl

0

Date:	OCTOBER :	5, 2015
Issued	For:	
Revisio	ns:	
		of this documer

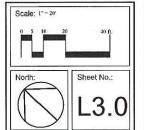

GRADING, DRAINAGE AND UTILITIES PLAN

### EROSION AND SEDIMENT CONTROL PLAN

THIS PLAN HAS BEEN DEVELOPED AS A STRATEGY TO CONTROL SOIL EROSION AND SEDIMENTATION DURING AND AFTER THE RE-DEVELOPMENT OF THE SCHLOTTERBECK AND FOSS BUILDING AT 117 PREBLE STREET IN PORTLAND, MAINE THIS PLAN IS BASED ON THE MAINE EROSION AND SEDIMENTATION CONTROL HANDBOOK FOR CONSTRUCTION, BEST MANAGEMENT PRACTICES, MARCH, 2003.

### A. PROPOSED DEVELOPMENT

THE PROJECT CONSISTS OF THE RE-DEVELOPMENT OF AN EXISTING FIVE-STORY, G.SOO SQUARE FOOT BUILDING THE BUILDING WILL INCLUDE 55 APARTMENT UNITS AND 2,000 S.F. OF COMMERCIA: OFFICE SPACE. THE 40,702 S.F. PARCEL CURRENTLY CONSISTS OF THE BUILDING AND A PAVED PARKING LOT AND A GRAVEL PARKING LOT: 5... FANCEL CURRENIUT CURRIDID OF THE BUILDING AND A PAYED PARKING LOT AND A GRAVEL PARKING LOT; 73% OF THE BUISTING SITE 19 IMPERVIOUS. THE PROPOSED IMPERVIOUS LOT IMPERVIOUS IS 27,300 S.F. OR 67% OF THE SITE.

### 3. EROSION CONTROL PRACTICES/TEMPORARY MEASURES

THE FOLLOWING TEMPORARY MEASURES TO CONTROL EROSION AND SEDIMENTATION SHALL BE UTILIZED

EACH GROUND AREA, OPENED OR EXPOSED, WHETHER DIRECTLY OR INDIRECTLY DUE TO THE DEVELOPMENT SHALL BE MINIMIZED AND SHALL BE STABILIZED WITHIN 15 DAYS OF INITIAL DISTURBANCE OF SOIL AND SHALL BE PERMANENTLY STABILIZED WITHIN SEVEN DAYS OF FINAL GRADING. THIS STATEMENT APPLIES TO DISTURBED AREAS BEYOND THE LIMITS OF THE PROPOSED BUILDING, EXPOSED AREAS SHALL BE STABILIZED PRIOR TO A

TEMPORARY SOIL STABILIZATION SHALL BE EITHER BY TEMPORARY MULCHING, TEMPORARY SEEDING, PERMANENT BASE GRAVEL, OR ASPHALT BINDER COURSE AS FOLLOWS:

TEMPORARY SEEDING: SEED SHALL BE AROOSTOOK RYE APPLIED AT 2.60#/1000 5F, LIME SHALL BE AGRICULTURAL GROUND LIMESTONE APPLIED AT 13.8#/1000 5F, FERTILIZER SHALL BE 10-10-10 CLASSIFICATION APPLIED AT 13.8#/1000 5F, MULCH SHALL CONSIST OF HAY AND STRAW MULCH AND SPREAD EVENLY AT A RATE OF 70-30#/1000 5F. TEMPORARY SEEDINGS SHALL ONLY BE MADE BETWEEN APRIL 15 AND OCTOBER 1. AND SHALL NOT BE PLACED OVER SNOW.

TEMPORARY MULCHING: MULCH SHALL CONSIST OF CHOPPED HAY OR STRAW MULCH AND SPREAD BY MECHANICAL BLOWER EVENLY AT A RATE OF 150-200#/1000 5F. TEMFORARY MULCH SHALL BE REMOVED FRIOR TO PERMANENT SOIL STABILIZATION. MULCH MUST NOT BE PLACED OVER SNOW, SNOW SHALL BE

PERMANENT BASE GRAVEL: BASE GRAVEL UNDER PAVEMENT SHALL BE SUITABLE AS TEMPORARY SOIL STABILIZATION UNDER THE POLLOWING CONDITIONS: a) SLOPES SHALL BE LESS THAN EIGHT PERCENT

b) GRAVEL SHALL MEET THE SPECIFICATIONS FOR BASE OR SUBBASE GRAVEL FOR THE PROPOSED

C. EROSION CONTROL PRACTICES/PERMANENT MEASURES
THE FOLLOWING PERMANENT MEASURES TO CONTROL EROSION AND SEDIMENTATION SHALL BE UTILIZED:

. Permanent Seeding Shall be performed during construction operations as each disturbed area has been brought to finish grade. Permanent Seedings Shall be made as dormant seeding after the first killing frost, dormant seeding and mulch shall be used at two times the permanent SEEDING AND MULCHING RATE SHOWN BELOW FOR BOTH LAWN AS WELL AS EMBANKMENTS, SEED, LOAM, LIME, FERTILIZER AND MULCH ARE TO BE AS FOLLOWS:

<u>SEED</u>: THE SEED MIXTURE SHALL CONSIST OF SEED PROPORTIONED BY WEIGHT. ALL SEED SHALL BE FRESH, CLEAN, "NEW CROP" SEED. HARMLESS INERT MATTER AND WEED SEEDS SHALL BE PERMITTED UP TO ONE FERCENT OF THE GROSS WEIGHT OF EACH VARRIET OF SEC. ALL SEED SUPPLIED SHALL BE PACKED IN APPROVED CONTAINERS BEARING THE MANUFACTURERS MANK AND ANALYSIS OF CONTENTS. THE FOLLOWING MATERIALS AND APPLICATION RATES SHALL BE REQUIRED FOR FERMANENT SEEDING:

LAWN: CREEPING RED RESCUE: 0.69#/1000 5F KENTUCKY BLUEGRASS: 0.57#/1000 SP PERENNIAL RYEGRASS: 0.4G#I1000 SF REDTOP: 0.12#/1000 5F

LOAM: SHALL BE FREE OF GRASSES, ROOTS, LARGE STONE AND INORGANIC DEBRIS. PLACE LOAM AT FOUR INCHES MINIMUM DEPTH OVER ALL DISTURBED AREAS. FINAL GRADING OF ALL LAWN AREAS TO BE

LIME: LIME SHALL BE AGRICULTURAL GROUND LIMESTONE AND APPLIED AS PER RECOMMENDATION OF A STATE COMMERCIAL SOIL TESTING LABORATORY. FERTILIZER: FERTILIZER SHALL BE 10-20-20 CLASSIFICATION AND APPLIED AS PER RECOMMENDATION OF A STATE COMMERCIAL SOIL TESTING

MULCH: MULCH SHALL CONSIST OF HAY OR STRAW MULCH. MULCH SHALL DE SPREAD EVENLY AT A RATE OF TWO AND ONE HALP TONS PER ACRE OVER ALL SEEDING. AFTER APPLICATION, THE MULCH SHALL DE THOROUGHLY WETTED, IN STEEP AREAS, THE MULCH SHALL DE HELD IN PLACE BY THE USE OF JUTE EROSION CONTROL NETTING OR APPROVED ALTERNATIVE NETTING MATERIAL, NOTE: ALL EXPOSED SOIL MUST BE COVERED REGARDLESS OF MULCHING RATES SPECIFIED.

THE CONTRACTOR SHALL MAINTAIN THE SEEDED AND MULCHED AREAS UNTIL FINAL ACCEPTANCE OR THE WORK. WAINTENANCE SHALL CONSIST OF PROVIDING PROPER WATERING, PROTECTION AGAINST TRAFFIC AND REPAREING ANY AREAS DAMAGED DUE TO WIND, WATER, EROSION, FIRE OR OTHER CAUSES, SUCH DAMAGED AREAS SHALL SE REPAIRED TO REESTABLISH THE CONDITION AND GRADE OF THE SOIL PRIOR TO SEEDING AND SHALL THEN BE


D. WINTER CONDITIONS EXCAVATION AND EARTHWORK SHALL BE COMPLETED SUCH THAT NO MORE THAN I ACRE OF THE SITE IS EXCAVATION AND EARTHWORK SHALL BE COMPLETED SUCH THAT NO MORE THAN I ACRE OF THE SITE IS WITHOUT STABILIZATION AT ANY ONE TIME. LIMIT THE EXPOSED AREA TO THOSE AREAS IN WHICH WORK IS EXPECTED TO BE UNDERTAKEN DURING THE PROCEEDING IS DAYS AND THAT CAN BE MULCHED IN ONE DAY FRIOR TO ANY SHOW EVENT. HAY AND STRAW MULCH RATE SHALL BE A MINIMUM OF ISO LBS./I, COO. S.F. (3 TONSIACRE) AND SHALL BE PROPERLY ANCHORED. THE CONTRACTOR SHALL INSTALL ANY ADDED MEASURES WHICH MAY BE NECESSARY TO CONTROL EROSIONISEDIMENTATION FROM THE SITE, DEPENDENT UPON THE ACTUAL SITE AND WEATHER CONDITIONS. CONTINUATION OF EARTHWORK OPERATIONS ON ADDITIONAL AREAS SHALL NOT BEGIN UNTIL THE EXPOSED SOIL SURFACE ON THE AREA BEING WORKED HAS BEEN STABILIZED, IN ORDER TO MINIMIZE AREAS WITHOUT EROSION CONTROL PROTECTION.


- E. CONSTRUCTION SEQUENCE
  THE GENERAL SEQUENCE OF WORK SHALL BE AS FOLLOWS:
- INSTALL EROSION CONTROL DEVICES. (SILT FENCE, STABILIZED CONSTRUCTION ENTRANCE AND OR SEDIMENT

- BARRIER.)
  TEMPORARILY STABILIZE DISTURBED AREAS BY MULCHING ALL EXPOSED SOIL WITHIN 15 DAYS OF INITIAL
  DISTURBANCE.
  INSTALL STORMWATER SYSTEM;
  COMPLETE SITE CONSTRUCTION WORK;
  CONSTRUCT PAYED ACCESS AND PARKING AREAS;
  INSTALL REPLANENT VICE ACTION ON ALL EXPOSED AREAS;
  INSTALL REPLANENT VICE ACTION ON ALL EXPOSED AREAS;
  INSTALL REPLANENT VICE ACTION ON ALL EXPOSED AREAS;
- INSTALL PERMANENT VEGETATION ON ALL EXPOSED AREAS WITHIN 15 DAYS OF FINAL GRADING; AND PERFORM CONTINUING MAINTENANCE ON ALL EROSION AND SEDIMENTATION CONTROL DEVICES AND


F. SITE INSPECTION & MAINTENANCE WEEKLY INSPECTIONS, AS WELL AS ROUTINE INSPECTIONS FOLLOWING RAINFALLS OF 0.5° OVER A CONSECUTIVE WEEKLY HISPECTIONS, AS WELL AS ROUTINE HISPECTIONS FOLLOWING RANNALLS OF 0.5° OVER A CONSECUTIVE 24-HOUR FREROO, SHALL BE CONFIDED BY THE SITE CONTRACTOR OF ALL TEMPORARY AND PERMANENT EROSION CONTROL DEVICES UNTIL FINAL ACCEPTANCE OF THE PROJECT. NECESSARY REPAIRS SHALL BE MADE TO CORRECT UNDERMINING OR DETERIORATION, FINAL ACCEPTANCE SHALL INCLIDE A STELL INSPECTION TO VERIFY THE STABILITY OF ALL DISTURBED AREAS AND SLOPES. UNTIL FINAL INSPECTION, ALL EROSION AND SEDIMENTATION CONTROL MEASURES SHALL IMMEDIATELY BE CLEANED, AND REPAIRED BY THE SITE CONTRACTOR AFTER STORM EVENTS. DISPOSAL OF ALL TEMPORARY EROSION CONTROL DEVICES SHALL BE THE DESERVANCE OF THE STORM EVENTS. DISPOSAL OF ALL TEMPORARY EROSION CONTROL DEVICES SHALL BE THE RESPONSIBILITY OF THE SITE CONTRACTOR.

CONTINUED TEMPORARY MAINTENANCE AND LONG TERM PROVISIONS FOR PERMANENT MAINTENANCE OF ALL EROSION AND SEDIMENTATION CONTROL FACILITIES AFTER ACCEPTANCE OF THE PROJECT SHALL BE THE RESPONSIBILITY OF THE SCHLOTTERBECK BLOCK LLC.

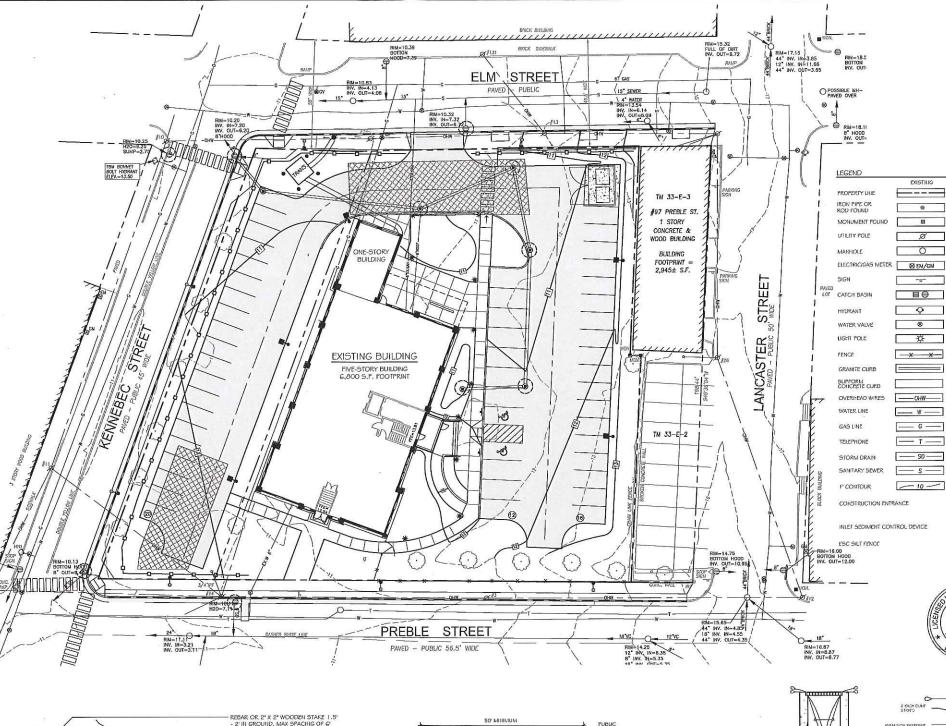

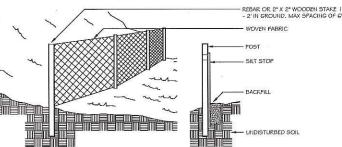

- SILT FENCE TO BE INSTALLED PARALLEL TO EXISTING CONTOURS DOWNSLOPE FROM AREAS OF SOIL DISTURBANCE.
- 2. SILT FENCE TO BE SECURELY ATTACHED TO THE UPSLOPE SIDE OF THE
- BOTTOM 4 TO 6 INCHES OF SILT FENCE TO BE BURIED IN SLOPE AND BACKFILLED WITH COMPACTED SOIL.
- 4. IIISPECTION SHALL BE MADE AFTER EVERY RAINFALL WITH REMOVAL OF EXCESSIVE SEDIMENT AND REPAIR OF THE FENCE ACCOMPLISHED PROWIFTLY.
- 5. SILT FENCE AND ACCUMULATED SEDIMENT SHALL BE REMOVED AS SOON AS FERMAHENT EROSION CONTROL MEASURES HAVE BEEN ESTABLISHED.

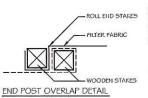

PROVIDE APPROPRIATE TRANSITION BETWEEN STABILIZ CONSTRUCTION ENTRANCE AND PUBLIC RIGHT-OF-WAY **PROFILE** GEOTEXTILE PADRIC MIRAFI 6009 OR APPROVED EQUAL PLAN

ONSTRUCTION SPECIFICATIONS:

STONIE SIZE: AASHTO DESIGNATION M 43, SIZE NO. 2 (2.5"TO 1.5"), USE CRUSHED STONE.

LENGTH: AS PRECIFICE, BUT NOT LESS THAN 50 FEET.


THICKNIESS: NOT LESS THAN RICHT (6) HICHES.


MOTH: HOT LESS THAN FILL WIDTH OF ALL POIL TO FINGRESS OR EGRESS.

WOSHIG: WHEN RECESSARY, WHELE SHALL BE LEALED TO REMOVE SEDIMENT PRIOR TO ENTRANCE ONTO PUBLIC MOSHIG: WHEN RECESSARY, WHELE SHALL BE LEALED TO REMOVE SEDIMENT PRIOR TO ENTRANCE ONTO PUBLIC PROPERTIES OF A SEDIMENT SHALL BE PREVENTED FROM ENTERING ANY STORM DRAW, DITCH, OR WATERCOURSE THROUGH THE USE OF SAND BAGS, GRAVEL BOARDS OR OTHER APPROVED HETCHIS, OR WATERCOURSE THROUGH THE USE OF SAND BAGS, GRAVEL BOARDS OR OTHER ARY STORM DRAW, DITCH, OR WATERCOURSE THROUGH THE USE OF SAND BAGS, GRAVEL BOARDS OR OTHER

ANY STORM DRAIN, DITION, ON WALKRUDURDE THAODSHITTED BY A CONDITION WHICH WILL PREVENT TRACKING OR FLOWING OF APPROVED METHODS.

MAINTENIAGE: THE ENTRAICE SHALL BE MAINTAINED IN A CONDITION WHICH WILL PREVENT TRACKING OR FLOWING OF SEDIMENT OWNTO PUBLIC RIGHT-OF-WAY. THIS MAY REQUIRE PERIODIC TOP DRESSHIG WITH ADDITIONAL STONES AS CONDITIONS DEMAND AND REPAIR AND/OR CLEANOUT OF ANY MEASURES USED TO TRAP SEDIMENT. ALL SEDIMENT SPILLED, DROPPED, WASHED, OR TRACKED ONTO PUBLIC RIGHT-OF-WAY MUST BE REMOVED IMMEDIATELY. STABILIZED CONSTRUCTION ENTRANCE

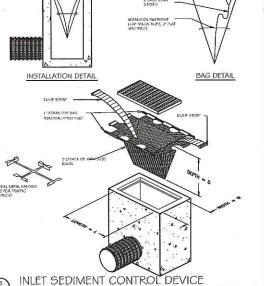

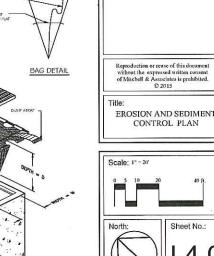

Prepared For: Owner and Applicant: SCHLOTTERBECK BLOCK L.L.C.

MITCHELL & ASSOCIATES

RANSOM CONSULTING ENGINEERS

GODUTI-THOMAS ARCHITECTS

ŭ

0

M

상

chlotterbe

0

OCTOBER 5, 2015

Issued For:

Revisions:

Prebl

117

≥

nd,

Prepared By

Portland, Maine 04101

Phone: 207-772-2891

14 Oak Street # 2 Portland, Maine 0410 Phone: 207-775-3184

PROPOSED

•

\* ===

1.50

(0)

MITCHELL


No. 15

CIME

0

tii .

SILT FENCE

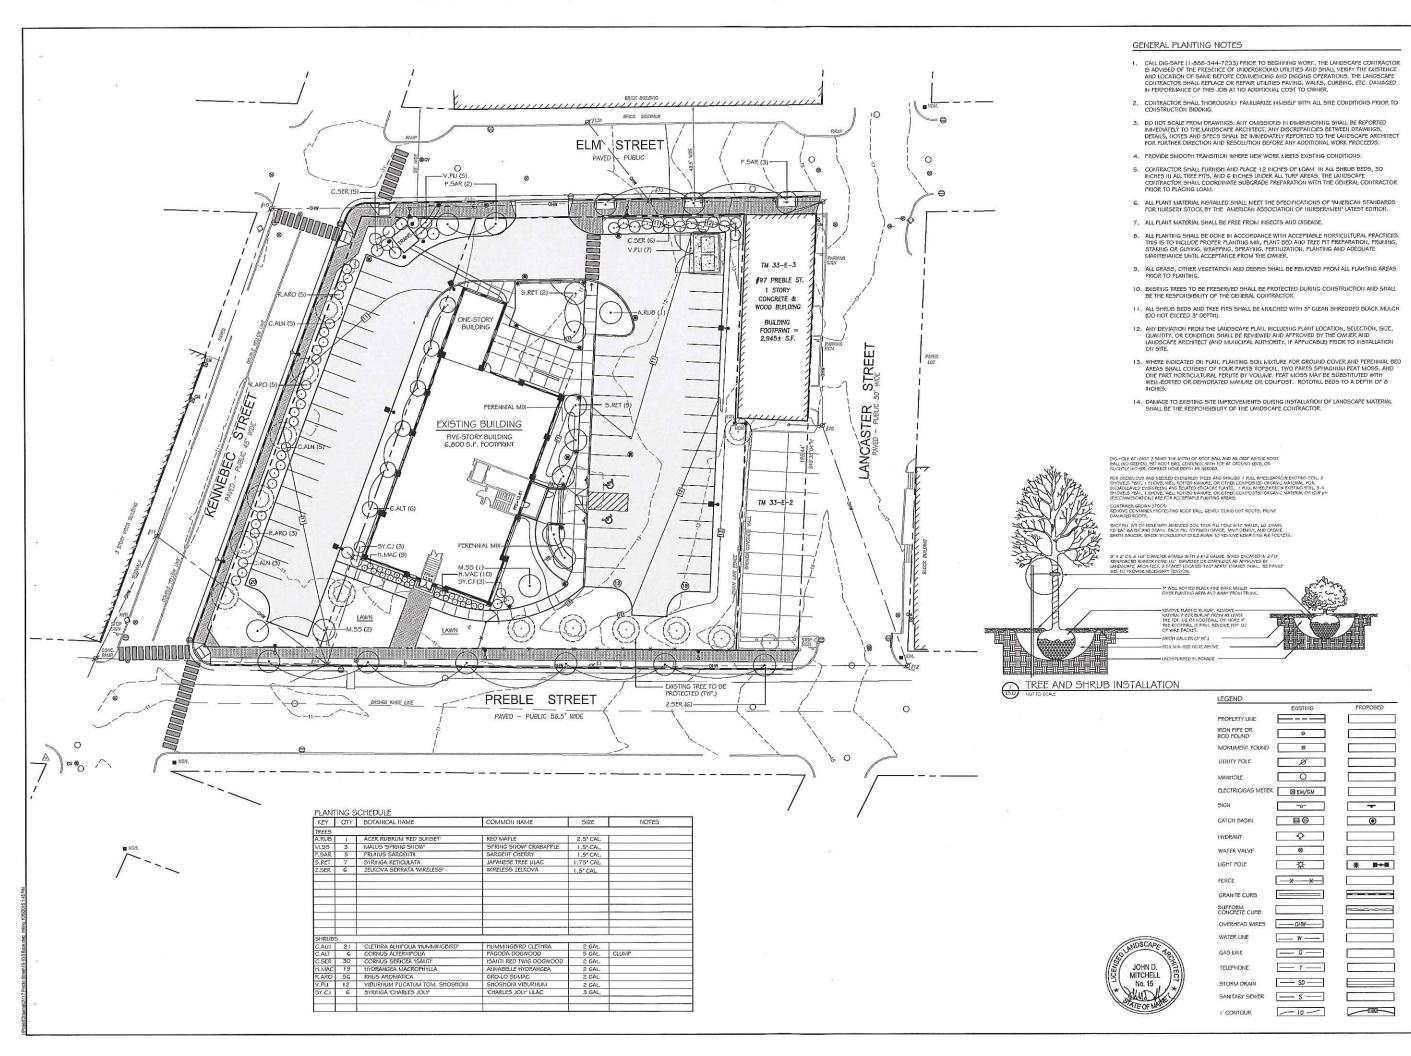

Prepared For: Owner and Applicant: SCHLOTTERBECK BLOCK L.L.C.

77 Sprace Street Portland, Maine 04101 Tel.: 207-650-8979

Phone: 207-772-2891

Prepared By MITCHELL & ASSOCIATES

RANSOM CONSULTING ENGINEERS 400 Commercial Street #4 Portland, Maine 04101

GODUTI-THOMAS ARCHITECTS

44 Oak Street # 2 Portland, Maine 04101 Phone: 207-775-3184

Mai Portland, 0 M

S

chlotterbe S 0 The

 $\bar{S}$ 


Prebl


117 OCTOBER 5, 2015 Issued For: Revisions:

> Reproduction or reuse of this documer without the expressed written consent of Mitchell & Associates is prohibited. © 2015


> > PLANTING PLAN

Scale: 1" - 20 North: Sheet No .:

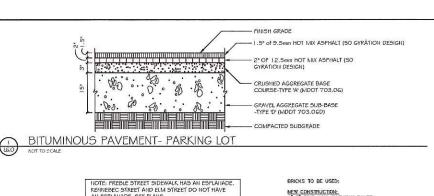


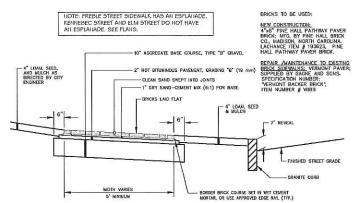

# BRICK SIDEWALK WITH BITUMINOUS BASE AND GRANITE CURB

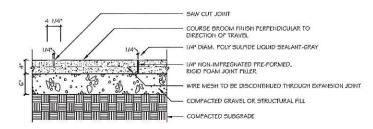


JOINTS: HAND TROWEL TO 1/3 DEPTH AT 5' O.C. WITHIN 24 HOURS AT 25-FOOT INTERVALS OR APPROPRIATE CONNECTIONS. SEALING: AFFLY POLY SULFIDE LIQUID SEALANT, GRAY COLOR, INSTALL PER MANUFACTURER'S SPECIFICATIONS.

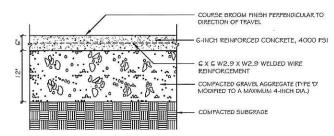


 $\underline{\text{FINISH:}} \text{ 5CREED AND BULL PLOAT, BROOM FINISH, PERPENDICULAR TO TRAVEL DIRECTION}$ JOINTS: HAND TROWEL TO X DEPTH AT 5' O.C. WITHIN 24 HOURS AT 25-FOOT INTERVALS OR APPROPRIATE COLLECTIONS, SEALING: APPLY POLY SULFIDE LIQUID SEALANT, GRAY COLOR, INSTALL PER MANUFACTURER'S SPECIFICATIONS.


# CONCRETE PAD: DUMPSTER AND GENERATOR

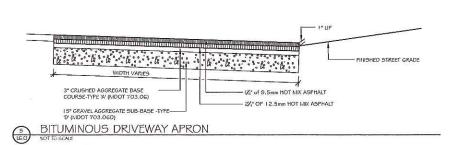

G' MIN. TERMINAL CURB (7' AT SIDEWALK RAMPS) - 1" CURB REVEAL AT DRIVEWAY 4" X 8½" FILTER FABRIC CTYP.) FOR ALL GRANITE CURB INSTALLATION TERMINAL CURB PROFILE

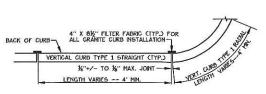


## VERTICAL GRANITE CURB PLAN VIEW

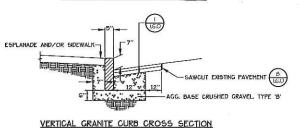



GRANITE CURB INSTALLATION IN EXISTING STREETS


(GO NOTTO SCALE CITY OF PORTLAND STANDARD DETAIL: VERTICAL

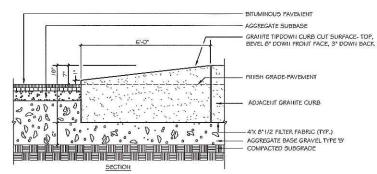


GRANITE TIP-DOWN CURB

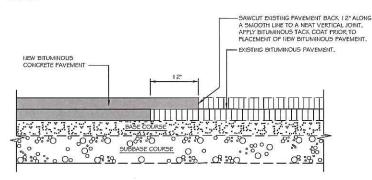

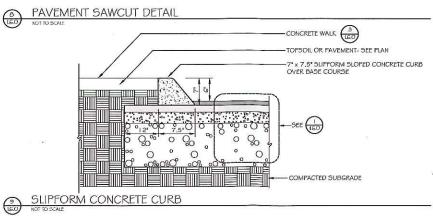


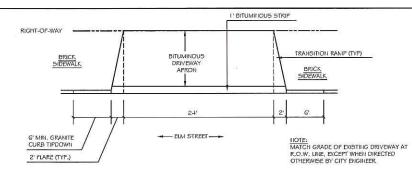


DRIVEWAY APRON LAYOUT

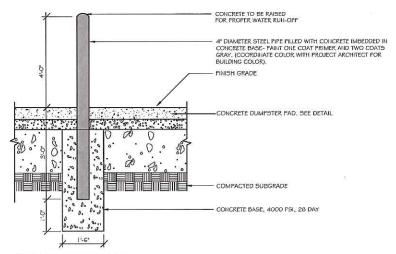

PIPE BOLLARD DETAIL

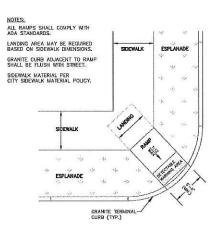

ADA RAMP AT PREBLE STREET/KENNEBEC STREET

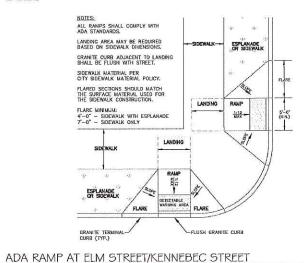

MITCHELL No. 15 PERMITTING SET -- NOT FOR CONSTRUCTION


Prepared For: Owner and Applicant SCHLOTTERBECK BLOCK L.L.C. Portland, Maine 04101 Tel.: 207-650-8979 Prepared By: MITCHELL & ASSOCIATES RANSOM CONSULTING ENGINEER 400 Commercial Street # 4 Portland, Maine 04101 Phone: 207-772-2891 GODUTI-THOMAS ARCHITECTS


44 Oak Street # 2 Portland, Maine 04101 Phone: 207-775-3184 Maine


Block Portland, chlotterbeck Street S The Preble


Date: OCTOBER 5, 2015 Revisions: Reproduction or reuse of this document without the expressed written consent of Mitchell & Associates is prohibited. © 2015 SITE DETAILS Scale: AS SHOWN


Sheet No. North: L6.0

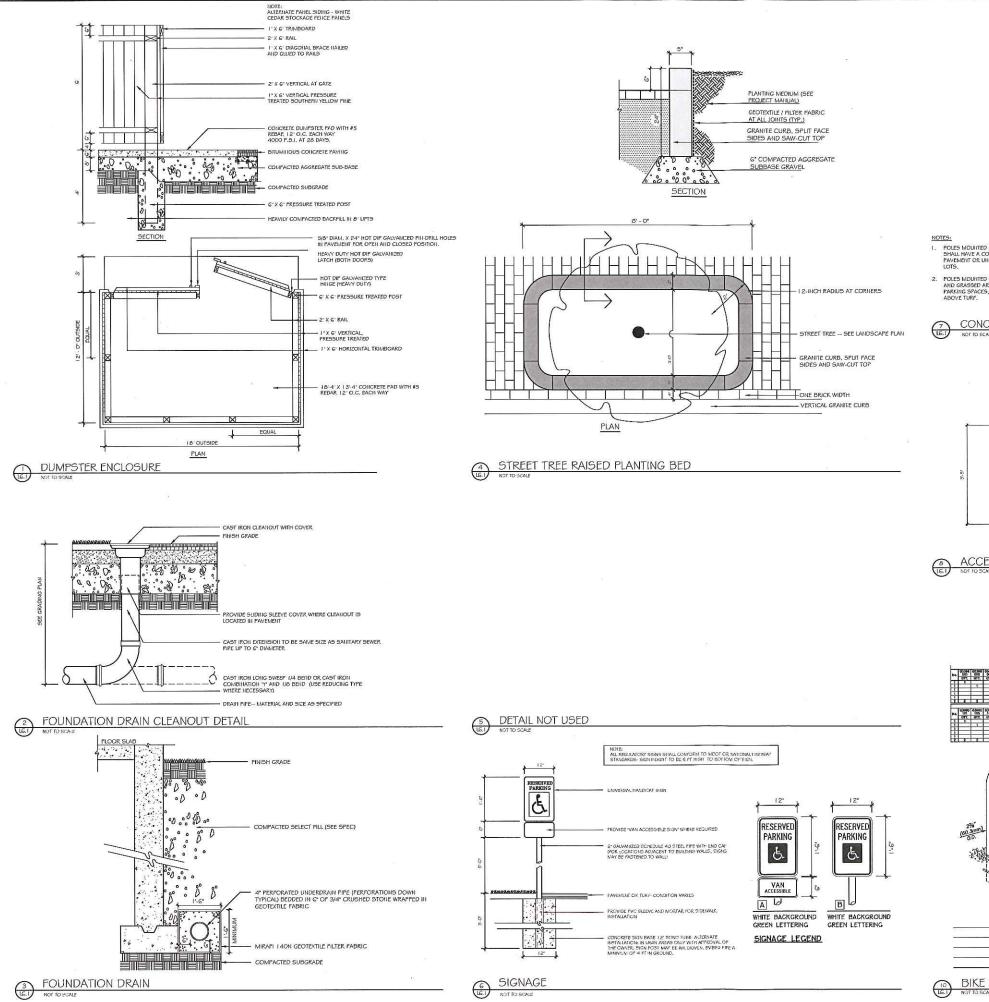

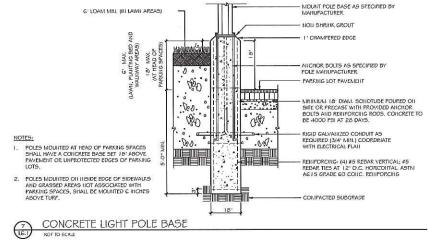

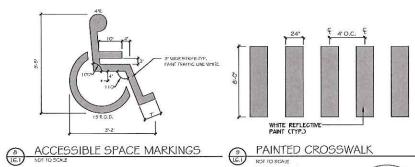

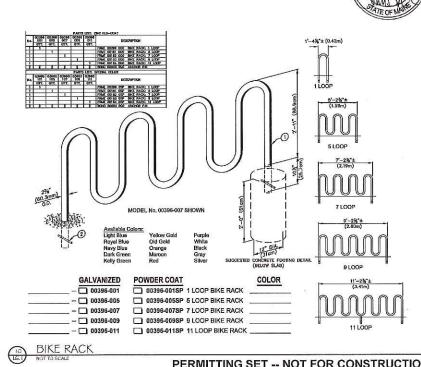

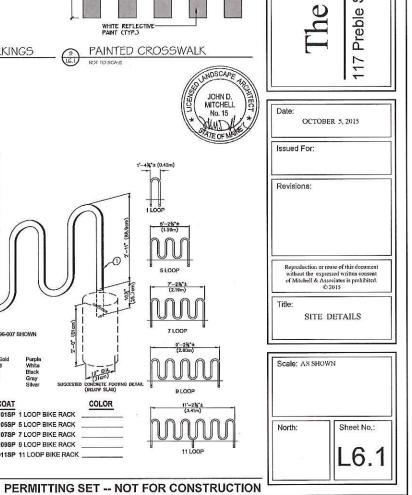

Prepared For: Owner and Applie

77 Spruce Street Portland, Maine 04101 Tel.: 207-650-8979

Portland, Maine 04101 Phone: 207-775-3184

SCHLOTTERBECK BLOCK L.L.C.

Prepared By: MITCHELL & ASSOCIATES

RANSOM CONSULTING ENGINEERS 400 Commercial Street # 4 Portland, Maine 04101 Phone: 207-772-2891

GODUTI-THOMAS ARCHITECTS
44 Oak Street # 2

Block

chlotterbeck


S

JOHN D. MITCHELL No. 15

Maine

Portland,

Street

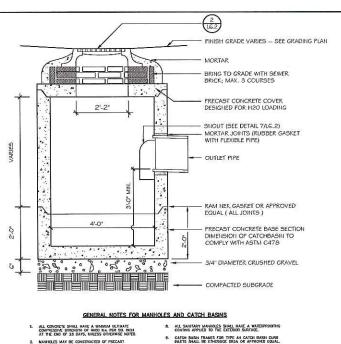

10. CASTINGS SHALL CONFORM TO ASTM DESIGNATION A48-CLASS 35.

DISTING MANHOLES, CATCH BASINS, FRANES, AND COVERS SHALL BE SALVACED BY THE CONTRACTOR, AND SHALL REMAIN THE PROPERTY OF THE CITY OF PORTLAND.

- 2. MANHOLES WAY BE CONSTRUCTED OF PRECAST
- PRECAST RENFORCED CONE BARREL MANUFACTURED PER ASTM SPEC. C-478.
- ALL STORM AND SEWER WANHOLE COVERS SHALL BE SOUD AND SHALL HAVE DNE 7/8" DIAMETER DRILLED PICK HOLE LOCATED 8" FROM THE CONTER OF THE COVER.
- 6. ALL MANHOLE RISERS SHALL BE ETHERDOE 24" OR APPROVED EQUAL.
- SEWER BRCK SHALL CONFORM TO ASTW SPEC. DESIGNATE ON C-32-63, GRADE MA AND SA.

PRECAST CONCRETE CATCHBASIN

NOTES: DEPTH OF BITUMINOUS PAYEMENT AND AGGREGATE COURSES SHALL BE DETERMINED BY STREET CLASSIFICATION. ANY ALTERNATE TRENCHING OR PAYMENT METHODS SHALL BE APPROVED IN ADVANCE BY THE CITY OF PORTLAND, DEPARTMENT OF PUBLIC SERVICES PAVED AREAS -MAX. TRENCH WIDTH, A (FEET) PIPE DIAMETER, D (INCHES) 3/4" CRUSHED STONE FOR PIPE BEDDING TO PIPE SPRINGUNE


TYPICAL PIPE TRENCH INSTALLATION

TYPICAL PIPE INSTALLATION - NOTES


4 CITY OF PORTLAND TRENCH DETAIL

NOTE: LOCATIONS AND ELEVATIONS OF STUBS SHOWN ON THE PLANS ARE TO BE CONSIDERED AS APPROXIMATE AND MAY BE ADJUSTED AS DIRECTED TO SUIT FIELD CONDITIONS.

HOUSE CONNECTIONS AND CATCH BASINS CONNECTIONS TO THE MAIN LINE OF THE SEWER, SHALL CONSIST OF AN APPROPRIATE "Y" BRANCH CONNECTION AS SHOWN ON THE PLANS, OR AS DIRECTED. ACTUAL "Y" LOCATIONS FOR HOUSE CONNECTIONS AND CAICH BASIN CONNECTIONS SHALL BE DETERMINED DURING CONSTRUCTION. HIE CONTRACTION SHALL KEEP A COMPALET RECORD OF "Y" LOCATIONS WHICH SHALL BE GYEN TO THE CITY OF PORTLAND UPON COMPLETION OF THE CONTRACT. ALL PVC TO PVC COUPLING SHALL BE "SOULD PVC COUPLINGS".

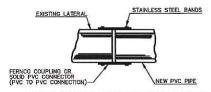


FERNCO COUPLING FOR REPAIR OR REPLACEMENT

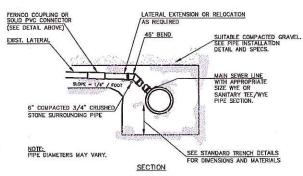


# TYPICAL EXISTING LATERAL CONNECTION NOT TO SCALE

CITY OF PORTLAND LATERAL CONNECTION DETAIL

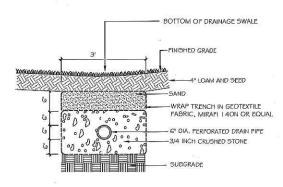

STONE INFILTRATION TRENCH
LEZ NOT TO SCALE

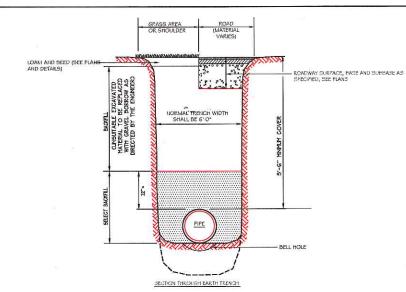

PORTLAND WATER DISTRICT PIPE TRENCH DETAIL

Block chlotterbeck S The

Prepared For: Owner and Applicant:

77 Spruce Street Portland, Maine 04101 Tel.: 207-650-8979

44 Oak Street # 2 Portland, Maine 04101 Phone: 207-775-3184

SCHLOTTERBECK BLOCK L.L.C.

MITCHELL & ASSOCIATES
Landscape Architects

RANSOM CONSULTING ENGINEERS 400 Commercial Street # 4 Portland, Maine 04101 Phone: 207-772-2891

GODUTI-THOMAS ARCHITECTS

Maine


Portland,


Street


Preble

Date: OCTOBER 5, 2015 Issued For: Revisions: Reproduction or reuse of this document without the expressed written consent of Mitchell & Associates is prohibited. © 2015 Title: SITE DETAILS




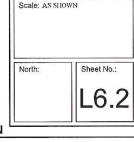

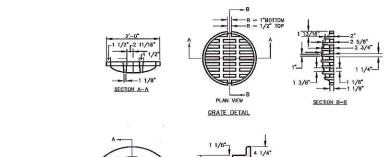

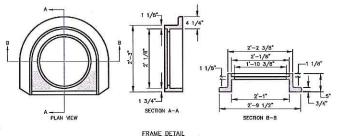



CAST IRON CATCH BASIN COVER AND FRAME

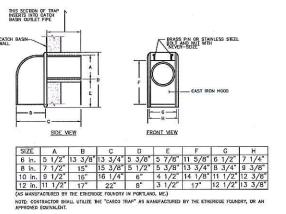

CASCO TRAP (ALL CATCHBASIN DRAINAGE STRUCTURES)

PERMITTING SET -- NOT FOR CONSTRUCTION

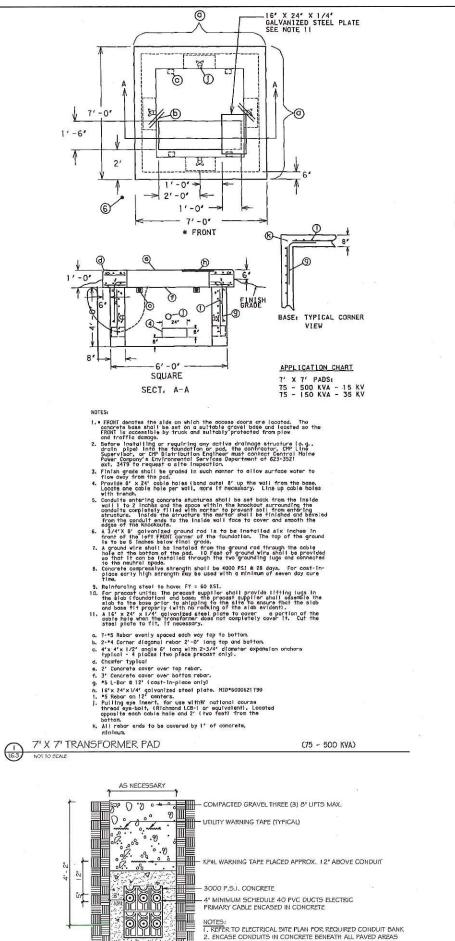

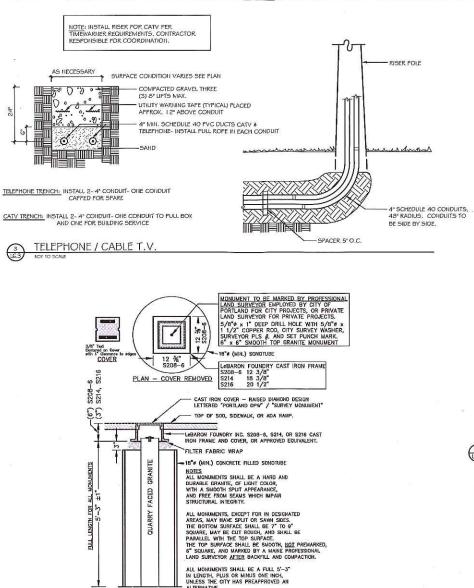


THE CONTRACTOR SHALL SET THE CENTER OF THE MONUMENT WITHIN 1" OF THE SURVEY POINT, OR THE CONTRACTOR SHALL BE RESPONSIBLE FOR REMOVING IT AND SETTING ANOTHER MONUMENT.

-AGGREGATE BASE - CRUSHED, TYPE "B"

CITY OF PORTLAND GRANITE MONUMENT DETAIL

6" MIN.

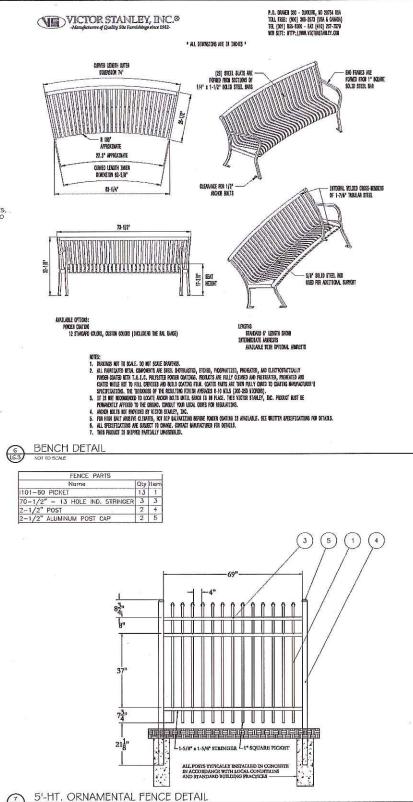

JOHN D. MITCHELL No. 15

Revisions: Reproduction or reuse of this document without the expressed written consent of Mitchell & Associates is prohibited. © 2015 SITE DETAILS Scale: AS SHOWN Sheet No. L6.3

Prepared For: Owner and Applicant:

77 Spruce Street Portland, Maine 04101 Tel.: 207-650-8979

70 Center Street Portland, Maine 04101 Tel.: 207-774-4427

Portland, Maine 04101 Phone: 207-775-3184

ट्

Ŏ

M

S

0

chlotterb

S

0 Th

OCTOBER 5, 2015

Date:

Title:

North:

Issued For:

SCHLOTTERBECK BLOCK L.L.C.

Prepared By: MITCHELL & ASSOCIATES

RANSOM CONSULTING ENGINEERS

GODUTI-THOMAS ARCHITECTS

Maine

Portland,


Street

Preble

DETAIL NOT USED

16.3 NOT TO SCALE

PERMITTING SET -- NOT FOR CONSTRUCTION

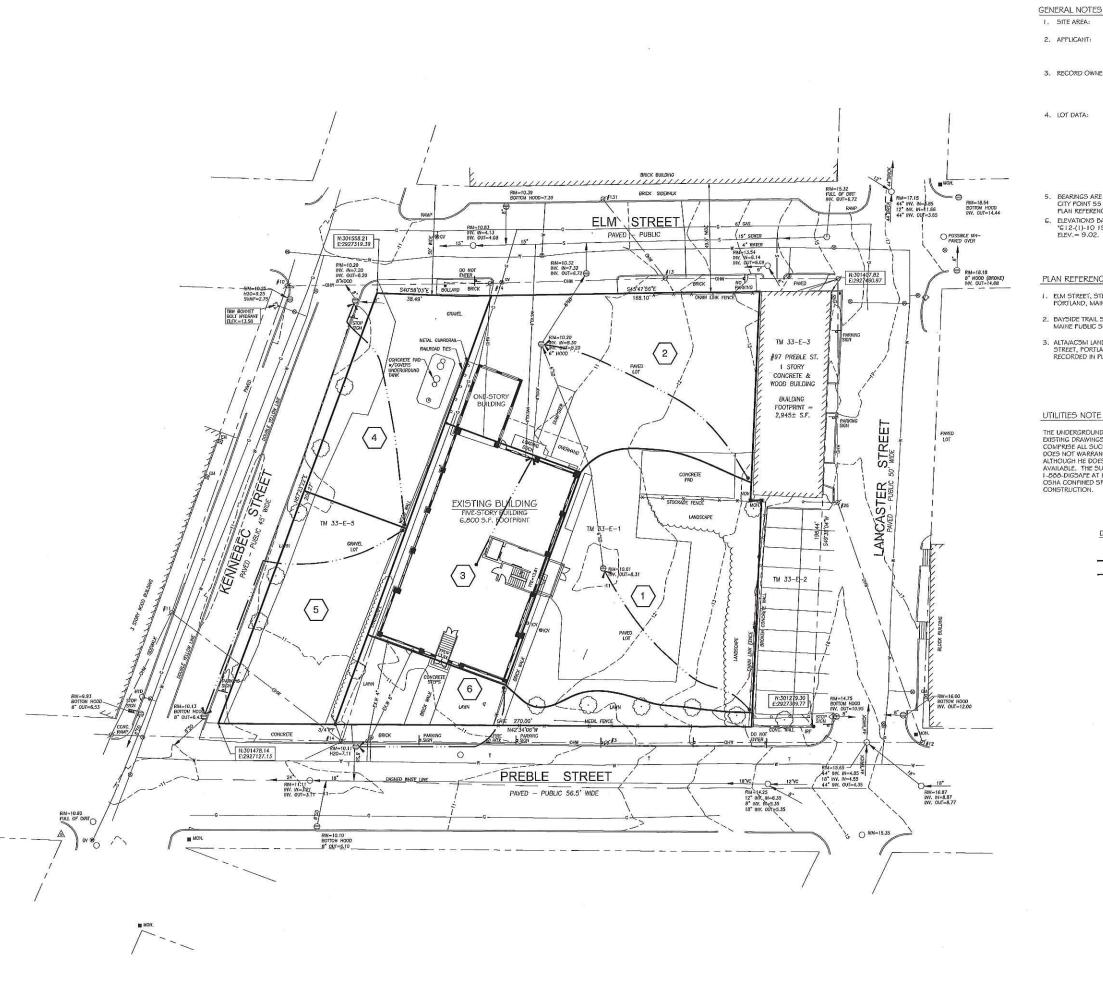

40,806 S.F. OR 0.93 ACRE

SCHLOTTERBECK BLOCK, LLC 77 SPRUCE STREET PORTLAND, MAINE 04101

3. RECORD OWNER: J.B. BROWN # SONS 482 CONGRESS STREET

P.O. BOX 207 PORTLAND, MAINE 04112

TAX MAP 33, BLOCK E, LOT I

C.C.R.D BOOK 26354, PAGE 312

AREA: 30,492 5.F.

TAX MAP 33, BLOCK E, LOT 5 C.C.R.D BOOK 26354, PAGE 314 AREA: 10,314 5.F.

BEARINGS ARE BASED ON MAINE STATE PLAN COORDINATE SYSTEM MAINE WEST NAD 83, BASED ON CITY POINT 55 N:301742.42 E: 2927203.68 AND POINT 59 N:301442.06 E:2927035.61 FROM PLAN REFERENCE 1.

6. ELEVATIONS BASED ON NGVD 1929. CITY BENCHMARK TBM 307 PLAN REFERENCE 1. MDOT DISK "612-(1)-10 1963" IN CONCRETE BASE OF LIGHT POLE AT NORTHEAST CORNER ELM/SOMERSET ELEV. = 9,02.

### PLAN REFERENCES

- ELM STREET, STREET LINE RETRACEMENT PLAN, SOMERSET STREET TO LANCASTER STREET, CITY OF PORTLAND, MAINE PUBLIC SERVICES DEPARTMENT ENGINEERING DIVISION DATED OCT. 16, 2012.
- 2. BAYSIDE TRAIL SOMERSET STREET EXTENTION, ELM STREET TO KENNEBEC STREET, CITY OF PORTLAND, MAINE PUBLIC SERVICES DEPARTMENT ENGINEERING DIVISION DATED JULY 3, 2012.
- 3. ALTA/ACSM LAND TITLE SURVEY ON PREBLE STREET, LANCASTER STREET EAST, ELM STREET & OXFORD STREET, FORTLAND, MAINE MADE FOR BAYSIDE I, LLC JAN. 26, 2000 BY OWEN HASKELL, INC. RECORDED IN PLAIN BOOK 200 PAGE 40.

THE UNDERGROUND UTILITIES SHOWN HAVE BEEN LOCATED FROM FIELD SURVEY INFORMATION AND EXISTING DRAWFINGS. THE SURVEYOR MAKES HIG GUARANITES THAT THE UNDERGROUND UTILITIES SHOWN COMFRISE ALL SUCH UTILITIES IN THE AREA, EITHER IN SERVICE OR ABANDONED. THE SURVEYOR FURTHER DOES NOT WARRANT THAT THE UNDERGROUND UTILITIES SHOWN ARE IN THE EXACT LOCATION INDICATED ALTHOUGH HE DOES CERTIFY THAT THEY ARE LOCATED AS ACCURATELY AS POSSIBLE FROM INFORMATION AVAILABLE. THE SURVEYOR HAS NOT PHYSICALLY LOCATED THE UNDERGROUND UTILITIES. CALL 1-889-DIGSAFE AT LEAST THREE BUSINESS DAYS DEFORE PERFORMING ANY CONSTRUCTION. DUE TO OSHA COMPINED SPACE REQUIREMENTS, ALL INVERTS AND PIPE SIZES MUST BE VERIFIED PRIOR TO ANY CONSTRUCTION.

DRAINAGE LEGEND

(4S)

WATERSHED AREA WATERSHED DIVIDE

TIME OF CONCENTRATION (TC) PATH

LEGEND

MANHOLE

HYDRANT

FENCE

WATER VALVE LIGHT POLE

GRANITE CURB OVERHEAD WIRES

WATER LINE

GAS LINE

TELEPHONE

STORM DRAIN

SANITARY SEWER I' CONTOUR

SIGN CATCH BASIN Prepared For: Owner and Applicant: SCHLOTTERBECK BLOCK L.L.C. 77 Sprace Street Portland, Maine 04101 Tel.: 207-650-8979

Prepared By: MITCHELL & ASSOCIATES Landscape Architects 70 Center Street Portland, Moine 04101 Tel.: 207-774-4427

GODUTI-THOMAS ARCHITECTS 44 Oak Street # 2 Portland, Maine 04101 Phone: 207-775-3184


Maine

Portland,

Block chlotterbeck

Street Preble 117

PRE-DEVELOPMENT STORMWATER PLAN

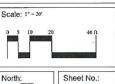

SEPTEMBER 29, 2015

S

The

Issued For:

Revisions:

Reproduction or reuse of this document without the expressed written consent of Mitchell & Associates is prohibited. © 2015

•

Ø

0

**B B** 

Q

8

举

\_x \_x

----ОНW-----

\_\_\_\_ w \_\_\_

\_\_\_ G -\_\_ — T —


\_\_\_\_ SD \_\_\_\_


\_\_\_ s -\_\_

10-

MONUMENT FOUND

ELECTRIC/GAS METER ■ EM/GM

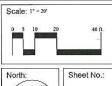

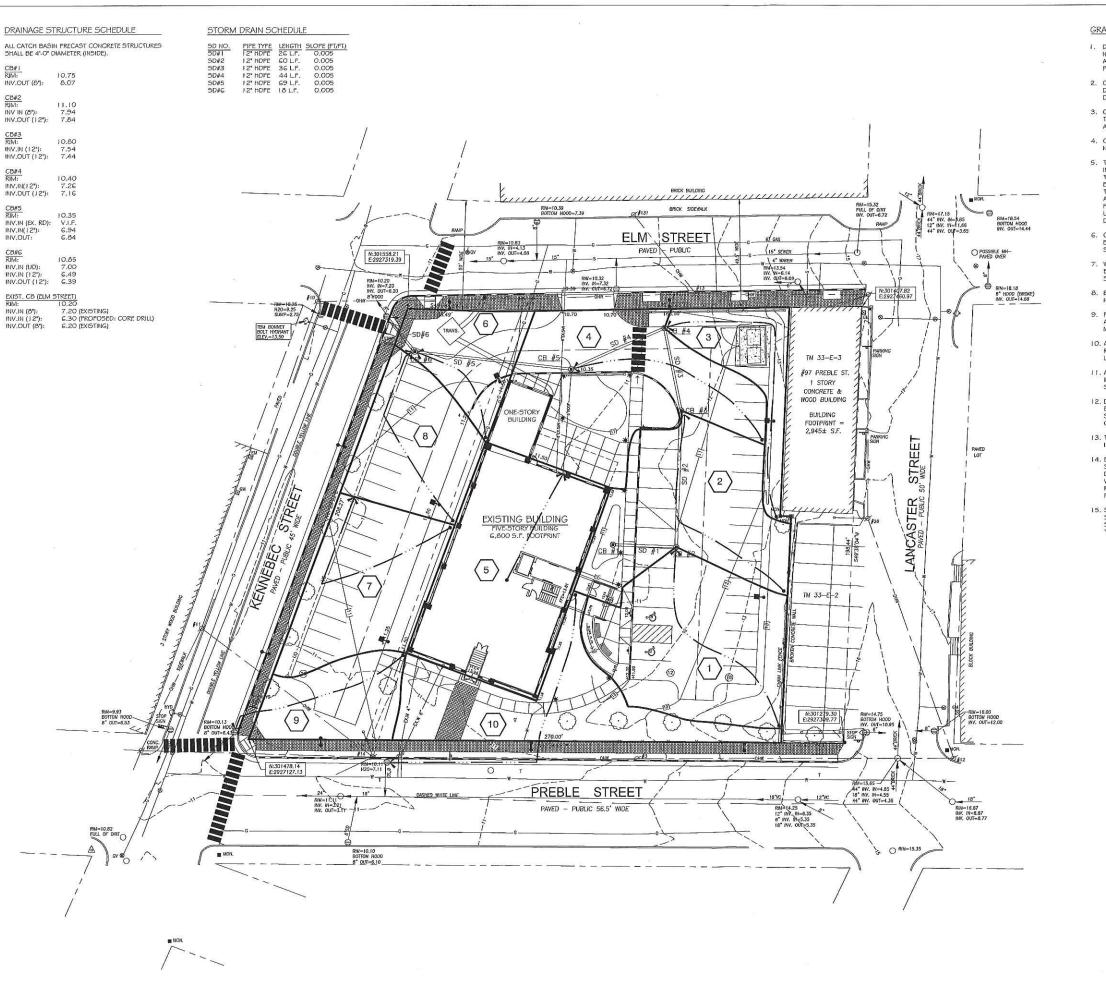

# GRADING AND DRAINAGE NOTES:

- DO NOT SCALE THESE DRAWINGS. ANY DISCREPANCIES BETWEEN DRAWINGS, DETAILS, NOTES AND SPECIFICATIONS SHALL BE IMMEDIATELY REPORTED TO THE LANDSCAPE ARCHITECT FOR PURTHER DIRECTION AND RESOLUTION BEFORE ADDITIONAL WORK PROCEPTS
- CONTRACTOR SHALL VERIFY ALL DIMENSIONS AND GRADES ON THE GROUND. ANY DISCREPANCIES SHALL BE REPORTED IMMEDIATELY TO THE LANDSCAPE ARCHITECT FOR DIRECTION AND RESOLUTION PRORE TO ANY PURITIES WORK.
- CONTRACTOR SHALL FIELD VERIFY LOCATION AND DEPTH OF ALL EXISTING UTILITIES WITH THE APPROPRIATE UTILITY COMPANIES PRIOR TO EXCAVATION OF OR INSTALLATION OF ANY PART OF THIS WICEN.
- CONTRACTOR SHALL AVOID ALL AREAS NOT REQUIRING GRADING. CONTRACTOR SHALL NOT DISTURB THESE AREAS.
- 5. THE UNIDERGROUND UTILITIES SHOWN HAVE BEEN LOCATED FROM FIELD SURVEY INFORMATION AND EXISTING DRAWINGS. THE SURVEYOR MAKES NO GUARANTEES THAT THE UNIDERGROUND UTILITIES SHOWN COMPRISE ALL SUCH UTILITIES IN THE AREA, ETHER IN SERVICE OR ABANDONED. THE SURVEYOR FURTHER DOES NOT WARRANT THAT THE UNIDERGROUND UTILITIES SHOWN ARE IN THE EXACT LOCATION INDICATED ALTHOUGH HE DOES CERTIFY THAT THEY ARE LOCATED AS ACCURATELY AS POSSIBLE FROM INFORMATION AVAILABLE. THE SURVEYOR HAS NOT PHYSICALLY LOCATED THE UNIDERGROUND UTILITIES, CALL DICSAFE (1-886-344-7233) AT LEAST THREE BUSINESS DAYS BEFORE PERFORMING ANY CONSTRUCTION.
- CONTRACTOR SHALL CONDUCT TEST PIT EXCAVATION TO CONFIRM LOCATION OF EXISTING LITLINES WHERE NEW UNDERGROUND ELECTRICAL, TELEPHONE AND CATV SERVICES ARE PROPOSED.
- WHERE STORM DRAINS OR SEWER MAINS HAVE LESS THAN FOUR (4) FEET OF COVER BETWEEN TOP OF PIPE AND FINISH GRADE, INSULATE PIPE USING TWO (2) INCH THICK STYROFOAM INSULATION BOARD OVER AND ALONG SIDES OF THE PIPE.
- EXISTING DRAINAGE CATCHBASIN SHALL BE CORED TO ACCEPT NEW DRAINAGE PIPE AS NOTED.
- PIPE LENGTH EQUALS THE CENTER TO CENTER DISTANCES BETWEEN CATCH BASINS AND/OR MANHOLES MINUS ONE-HALF OF THE DIAMETER OF EACH CATCH BASIN OR MANHOLE.
- ALL UTILITIES SHALL BE INSTALLED IN CONFORMANCE WITH INDIVIDUAL UTILITY DISTRICT REQUIREMENTS; CONTRACTOR SHALL COORDINATE INSTALLATION WITH APPROPRIATE UTILITY DISTRICT BEFORE INSTALLATION.
- 11. ALL WORK WITHIN THE ROAD RIGHT-OF-WAY AND ALL UTILITIES CONNECTING TO INFRASTRUCTURE WITHIN THE ROAD SHALL MEET CITY OF PORTLAND TECHNICAL MANUAL STANDARDS.
- 12. DISCONTINUED UTILITY SERVICES INCLUDING WATER, GAS AND SANITARY SEWER SHALL BE PERMANENTLY CAPPED CONFORMING TO UTILITY COMPANY AND CITY OF PORTLAND STANDARDS, CONTRACTOR SHALL COORDINATE WITH PUBLIC SERVICES AND/OR UTILITY COMPANY.
- 13. THE PROJECT BENCH MARK IS BONNET BOLT OF FIRE HYDRANT LOCATED AT INTERSECTION OF ELM STREET AND KENNEBEC STREET, BENCHMARK ELEVATION: 13.50.
- 14. BMP INSPECTIONS: THE OWNER SHALL HIRE A QUALIFIED POST-CONSTRUCTION STORMWATER INSPECTOR TO ANNUALLY, INSPECT THE BMPS, INCLUDING CATCH BASIN, DRIVMELL, IN-LINE ROOF FILTERS, PIPES AND RELATED STRUCTURES, IN ACCORDANCE WITH ALL MUNICIPAL AND STATE INSPECTION, CLEANING AND MAINTENANCE REQUIREMENTS OF THE APPROVED POST-CONSTRUCTION STORMWATER MANAGEMENT FLAN (PER SECTION 32 OF THE CITY OF PORTLAND CODE OF ORDINANCES).
- 15. SITE LIGHTING SHALL MEET THE CITY OF PORTLAND STANDARDS AS OUTLINED IN SECTION 12 OF THE CITY OF PORTLAND TECHNICAL DESIGN STANDARDS. SITE LIGHTING SHALL ADHERE TO SECTION 12.2.5 LIGHT TRESPASS-LIGHTING SHALL NOT BE GREATER THAN O. I FOOTCANDLES AT THE PROPERTY LINE.

(10)	WATERSHED AREA
	WATERSHED DIVIDE
	TIME OF CONCENTRATION (TC) PATH

	DUSTING	PROPOSED
PROPERTY LINE		
ron Pipe or Rod Found	•	
MONUMENT FOUND		
JTILITY POLE	Ø	
MANHOLE	0	
ELECTRIC/GAS METER	EM/GM	
BIGN		-
CATCH BASIN	目像	•
HYDRANT	Q	
WATER VALVE	8	
JGHT FOLE		* 11-1
ENCE	_ <del>-x-x</del>	
GRANITE CURB		-
OUFFORM CONCRETE CURB		
OVERHEAD WIRES	OHW	
WATER LINE	w]	
gas line	G	
TELEPHONE	— r —	
STORM DRAIN	so	
SANITARY SEWER	s	
1' CONTOUR	10 -	[60]

Prepared For: Owner and Applicant: SCHLOTTERBECK BLOCK L.L.C. 77 Sprace Street Portland, Maine 04101 Tel.: 207-650-8979

Prepared By:
MITCHELL & ASSOCIATES
Landscape Architects
70 Center Street

GODUTI-THOMAS ARCHITECTS 44 Onk Street # 2 Portland, Maine 04101 Phone: 207-775-3184

Block
Portland, Maine

chlotterbeck Bloc

117 Preble Street


0


The

Date: SEPTEME	BER 29, 2015
ssued For:	
Revisions:	28

itle: POST-DEVELOPMENT STORMWATER PLAN

Reproduction or reuse of this documen without the expressed written consent of Mitchell & Associates is prohibited. © 2015

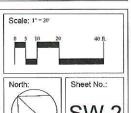

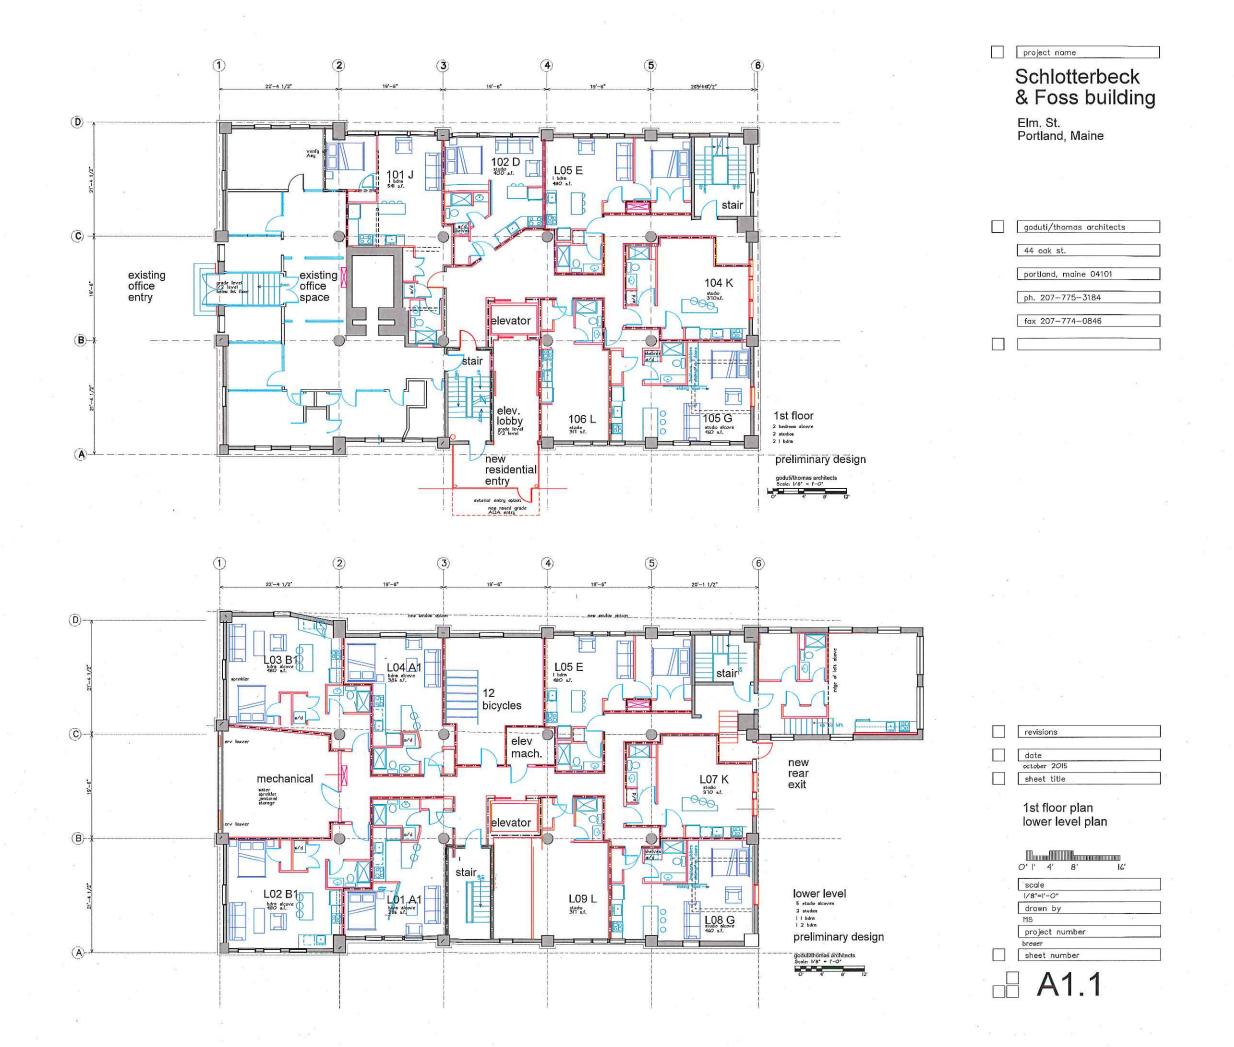



# Schlotterbeck & Foss building

Elm. St. Portland, Maine

goduti/thomas architects

44 oak st.

portland, maine 04101

ph. 207-775-3184

fax 207-774-0846

revisions

date october 2015

sheet title

roof plan 2nd - 5th floor plans


O' l' 4' 8' 16'

scale 1/8"=1'-0" drawn by

project number

brewer sheet number



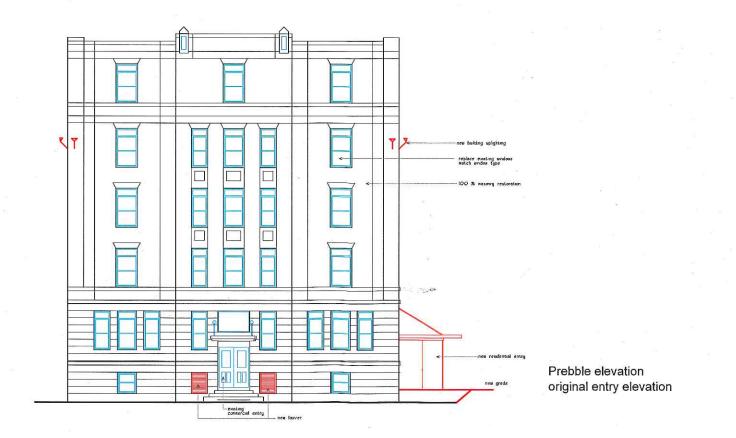

project name
Schlotterbeck
& Foss building
Duckble/ Clas Ct

Prebble/ Elm St. Portland, Maine

44	oak	st.	

portland, maine 04101

ph. 207-775-3184

fax 207-774-0846

revisions

date
october 2015
sheet title

# elevations

O' l' 4' 8' 16'

scale
1/8"=1'-O"

drawn by
MS

project number

brewer

sheet number







Schlotterbeck

# Schlotterbeck & Foss building

Elm. St. Portland, Maine

goduti/thomas architects
44 oak st.
portland, maine 04101
ph. 207-775-3184
fax 207-774-0846

date
actober 2015
sheet title

# elevations

D' I' 4'	8'		16
scale			
1/8"=1'-0"			
drawn by			
M5			
project nu	mber	ď	
brewer	s <sup>W</sup>		
sheet num	her		- 57

# The Schlotterbeck Block

117 Preble Street, Portland, Maine

REVISED: December 1, 2015: Level III Site Plan and Subdivision Plan



# PREPARED BY:

LANDSCAPE ARCHITECT AND SITE PLANNER:

PORTLAND, MAINE 04101 PHONE: 207.774.4427 FAX: 207.874.2460 CONTACT: MICHAEL W. KING, RLA E-MAIL: MKING@MITCHELLASSOCIATES.BIZ

# ARCHITECT:

GODUTI-THOMAS ARCHITECTS
44 OAK STREET, #2
PORTLAND, MAINE 04101
PHONE: 207.775.3184
CONTACT: RICHARD GODUTI, NCARB
EMAIL: GTARICK@GMAIL.COM

# CIVIL ENGINEER:

RANSOM CONSULTING ENGINEERS RANSOM CONSULTING ENGINEERS
400 COMMERCIAL STREET, NO.4
PORTLAND, MAINE 04101
PHONE: 207.772.2891
CONTACT: STEPPHEN BRADSTREET, P.E.
E-MAIL: STEPEHN.BRADSTREET@RANSOMENV.COM

# LAND SURVEYOR

OWEN HASKELL, INC. 390 U.S. ROUTE ONE, SUITE 10 FALMOUTH, MAINE 04105 PHONE: 207.774.0424 CONTACT: JOHN SWAN, P.L.S.

# TRAFFIC ENGINEER

GORRILL-PALMER 15 SHAKER ROAD GORHAM, MAINE 04038 PHONE: 207,675,6910 CONTACT: RANDALL DUNTON, P.E.

# UTILITIES:

ELECTRIC: CENTRAL MAINE POWER CENTRAL MAINE POWER
ELECTRICAL DISTRIBUTION ENGINEERING
162 CANCO ROAD
PORTLAND, MAINE 04103
PHONE: 207.482.2367
CONTACT: JAMIE COUGH
E-MAIL: JAMES.COUGH@CMPCO.COM

# WATER:

PORTLAND WATER DISTRICT 225 DOUGLASS STREET P.O. BOX 3553 PORTLAND, MAINE 04104-3553 PHONE: 207.774.5961 x.3199
FAX: 207.761.8307
CONTACT: GLISSEN HAVU
E-MAIL: MEANS@PWD.ORG

# SANITARY SEWER:

CITY OF PORTLAND CITY OF PORTLAND
PUBLIC SERVICES DEPARTMENT
55 PORTLAND STREET
PORTLAND, MAINE 04101
PHONE: 207.874.8816
CONTACT: 207.874.8816
CONTACT: DAVID MARGOLIS-PINEO
E-MAIL: DMP@PORTLANDMAINE.GOV

# CABLE:

TIME WARNER CABLE OF MAINE TIME WARNER CABLE OF MAINE
118 JOHNSON ROAD
PORTLAND, MAINE 04102
PHONE: 207.253.2924
CONTACT: MARK PELLETIER, CONSTRUCTION PROJECT COORDINATOR
E-MAIL: MARK-PELLETIER@TWCABLE.COM

# NATURAL GAS:

UNITIL SERVICE CORPORATION PORTLAND, MAINE 04103 PHONE: 207.541.2505 CONTACT: BRIDGET MATHERS

# OWNER AND APPLICANT

SCHLOTTERBECK BLOCK LLC 77 SPRUCE STREET PORTLAND, MAINE 04101 PHONE: 207.650.8979

# PERMITS:

TYPE OF PERMIT:

GOVERNING BODY:

SITE PLAN REVIEW:

CITY OF PORTLAND 389 CONGRESS STREET 4TH FLOOR PORTLAND, MAINE 04101 TEL: 207.874.8728 CONTACT: RICHARD KNOWLAND

STATUS:


SUBMITTED: OCTOBER 5, 2015


# SITE LOCATION MAP:



## OUTET INDEX

SHEET	TITLE
SHEET	COVER PAGE
1	BOUNDARY AND TOPOGRAPHIC SURVEY
1 OF 1	SUBDIVISION PLAT
I OF I	SUBDIVISION FLAT
L1.0	EXISTING CONDITIONS PLAN
L1.1	CONSTRUCTION MANAGEMENT PLAN
L2.0	LAYOUT PLAN
L2.1	DETAIL SITE PLANS: SIDEWALK RAMPS
L3.0	GRADING, DRAINAGE AND UTILITIES PLAN
L4.0	EROSION AND SEDIMENT CONTROL PLAN
L5.0	PLANTING PLAN
L6.0	SITE DETAILS
L6.1	SITE DETAILS
L6.2	SITE DETAILS
L6.3	SITE DETAILS
L7.0	LIGHTING PHOTOMETRICS PLAN
L7.1	LIGHTING PHOTOMETRICS PLAN: WITHOUT STREET LIGHTS
SW-1	PRE-DEVLOPMENT STORMWATER DRAINAGE PLAN
	(TO BE SUBMITTED WITH STORMWATER REPORT)
SW-2	POST-DEVELOPMENT STORMWATER DRAINAGE PLAN
	(TO BE SUBMITTED WITH STORMWATER REPORT)
A1.1	FIRST FLOOR PLAN AND LOWER FLOOR PLAN
A1.2	2nd - 3th FLOOR PLANS
A1.3	4th - 5th FLOOR PLANS
A1.4	ROOF PLAN
A2.1	BUILDING ELEVATIONS
A2.2	BUILDING ELEVATIONS
A2,3	MASONRY REPAIRS ELEVATIONS
A2.4	MASONRY REPAIRS ELEVATIONS

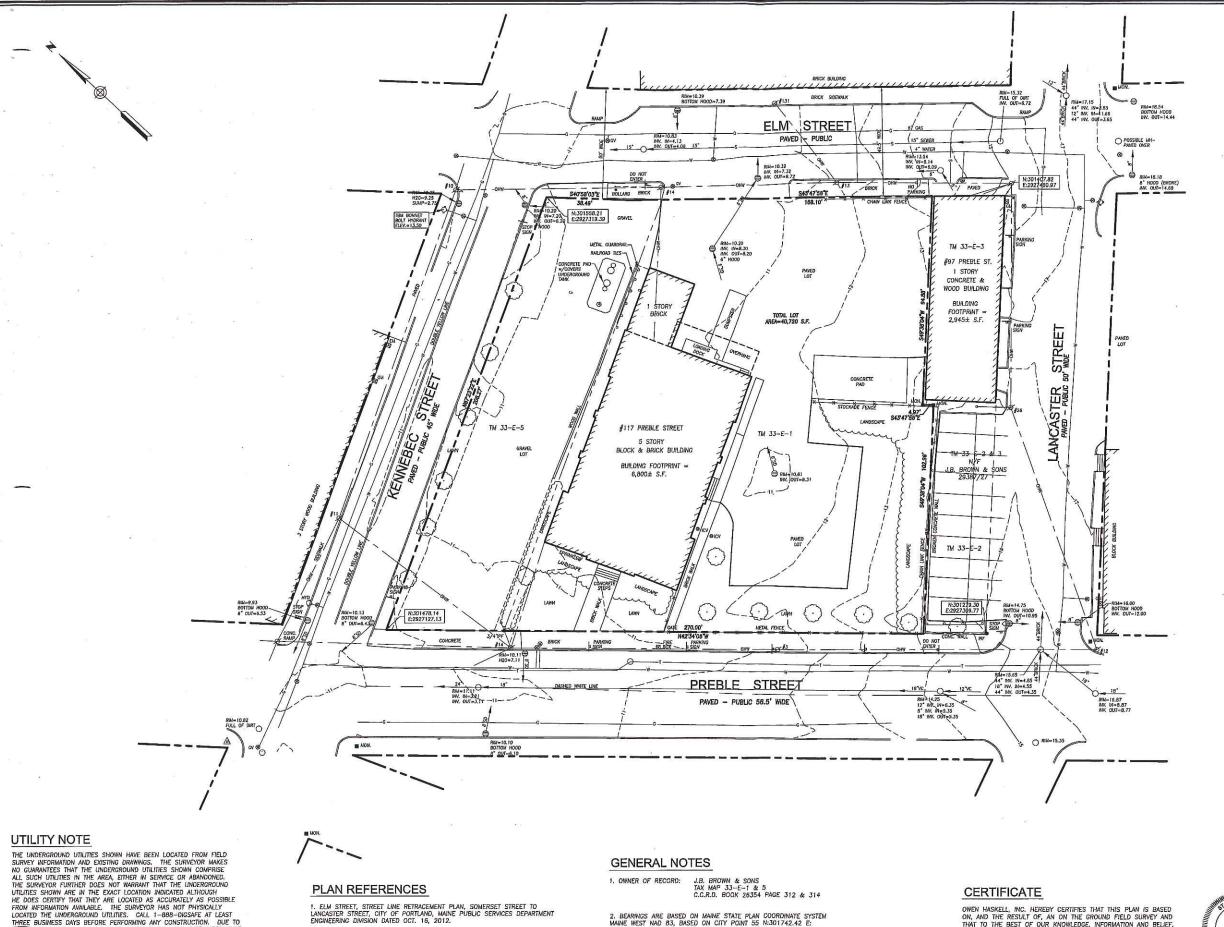

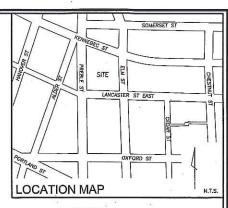

# **LEGEND**

IRON PIPE OR ROD FOUND MONUMENT FOUND UTILITY POLE MANHOLE ELECTRIC/GAS METER SIGN CATCH BASIN WATER VALVE OR SHUTOFF LIGHT POLE

O\$\$ DECIDUOUS TREE CONIFEROUS TREE FENCE

CURB —— OHW—— OVERHEAD WIRES \_\_\_ w \_\_\_ WATER LINE

G - T - SD - S - 10 - 10 GAS LINE TELEPHONE STORM DRAIN SANITARY SEWER

1' CONTOUR

THREE BUSINESS DAYS BEFORE PERFORMING ANY CONSTRUCTION. DUE TO OSTA CONFINED SPACE REQUIREMENTS, ALL INVERTS AND PIPE SIZES MUST BE VERIFIED PRIOR TO ANY CONSTRUCTION.



2. BAYSIDE TRAIL SOMERSET STREET EXTENTION, ELM STREET TO KENNEBEC STREET, CITY OF PORTLAND, MAINE PUBLIC SERVICES DEPARTMENT ENGINEERING DIVISION DATED JULY 3, 2012.

3. ALTA/ACSM LAND TITLE SURVEY ON PREBLE STREET, LANCASTER STREET EAST, ELM STREET & OXFORD STREET, PORTLAND, MAINE MADE FOR BAYSIDE I, LLC JAN. 26, 2000 BY OWEN HASKELL, INC. RECORDED IN PLAN BOOK 200 PAGE 40.

2. BEARINGS ARE BASED ON MAINE STATE PLAN COORDINATE SYSTEM MAINE WEST NAD 83, BASED ON CITY POINT 55 N-301742.42 E: 2927203.68 AND POINT 59 N-301442.06 E:2927035.61 FROM PLAN REFERENCE 1,

3. ELEVATIONS BASED ON NGVD 1929. CITY BENCHMARK TBM 307 PLAN REFERENCE 1. MDOT DISK "612-(1)-10 1983" IN CONCRETE BASE OF LIGHT POLE AT NORTHEAST CORNER ELM/SOMERSET ELEV.= 9.02.

OWEN HASKELL, INC. HEREBY CERTIFIES THAT THIS PLAN IS BASED ON, AND THE RESULT OF, AN ON THE GROUND FIELD SURVEY AND THAT TO THE BEST OF OUR KNOWLEDGE, INFORMATION AND BELIEF, IT CONFORMS TO THE BOARD OF LICENSURE FOR PROFESSIONAL LAND SURVEYORS CURRENT STANDARDS OF PRACTICE, WITH THE EXCEPTION OF HADEFEED NOT SET AT ALL CORDIFIED. EXCEPTION OF MARKERS NOT SET AT ALL CORNERS.

9/29/15 DATE

JOHN W. SWAN, PLS NO. 1038



REV. 1 9-28-15 REVISE LOT AREA


# **BOUNDARY & TOPOGRAPHIC SURVEY**

117 PREBLE STREET, PORTLAND, MAINE MADE FOR

MITCHELL & ASSOCIATES 70 CENTER STREET, PORTLAND, MAINE



_	PROI	ESSIONAL LAND SURVEYO	ORS
Drwn By	RS	Date	Job No.
Trace By	JLW	JULY 7, 2015	2015-109 P
Check By	JWS	Scale	Drwg. No.
Book No.	1134	1" = 20'	1

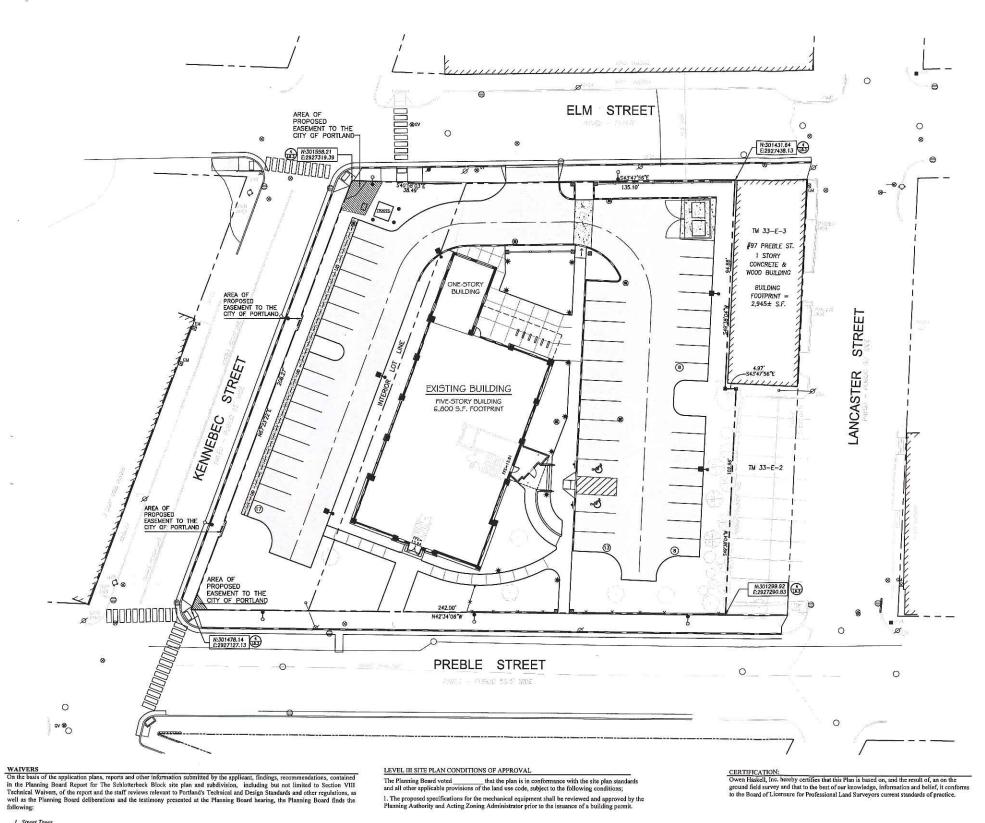

GENERAL NOTES

I. SITE AREA: 40,720 S.F. OR 0.93 ACRE

SCHLOTTERBECK BLOCK, LLC 77 SPRUCE STREET

J.B. BROWN & SONS 3. RECORD OWNER:

482 CONGRESS STREET P.O. BOX 207

PORTLAND, MAINE 04112

TAX MAP 33, BLOCK E, LOT 1 4. LOT DATA: C.C.R.D BOOK 26354, PAGE 312

AREA: 30,492 S.F.

TAX MAP 33, BLOCK E, LOT 5 C.C.R.D BOOK 26354, PAGE 314 AREA: 10.314 S.F.

- 5. THE SURVEYED PARCELS ARE SHOWN AS LOTS I AND 5, BLOCK E, ON THE CITY OF PORTLAND'S
- 6. A PORTION OF THE PARCEL IS LOCATED, BY SCALING METHODS, WITHIN ZONE C (AREAS OF MINIMAL FLOODING) AS SHOWN ON THE FLOOD INSURANCE RATE MAP FOR THE CITY OF PORTLAND, MAINE COMMUNITY PANEL NO. 230631-0013-B WITH AN EFFECTIVE DATE OF JULY 17, 1986. THE FLOOD ELEVATION FOR THE AZ ZONE WHICH ENCOMPASSES BACK COVE HAS AN ELEVATION OF 10 N.G.V.D. 1929. HOWEVER, THE TOPOGRAPHICAL SURVEY OF THE PARCEL SHOWS THE LOT ABOVE THE ELEVATION OF 10 N.G.V.D. (1929).
- UTILITIES SHOWN ARE BASED ON A PLAN ENTITLED BOUNDARY AND TOPOGRAPHIC SURVEY OF 117 PREBLE STREET, PERFORMED BY OWEN HASKELL, INC., DATED JULY 7, 2015.
- 9. ZONING DISTRICT: B-7 MIXED DEVELOPMENT DISTRICT ZONE

10. SPACE AND BULK STANDARDS:

PROPOSED 40,720 S.F. MINIMUM LOT SIZE: MINIMUM FRONTAGE: NONE 242 FEET FRONT SETBACK: SIDE SETBACK: NONE REQUIRED NONE REQUIRED 18 FEET 5 FEET REAR SETBACK: NONE REQUIRED 31 FEET MAX STREET SETBACK 10 FEET 18 FEFT (FXISTING) MAX. BUILDING LOT COVERAGE: MAX. BUILDING HEIGHT: 100 PERCENT 68 PERCENT 105 FEET N/A MIN, BUILDING HEIGHT: 45 FEET N/A

11. BICYCLE PARKING:

REOUIRED: 24 SPACES PROPOSED:

12. ALL WORK WITHIN THE ROAD RIGHT-OF-WAY AND ALL UTILITIES CONNECTING TO INFRASTRUCTURE WITHIN THE ROAD SHALL MEET CITY OF PORTLAND TECHNICAL MANUAL STANDARDS.

### PLAN REFERENCES

- ELM STREET, STREET LINE RETRACEMENT PLAN, SOMERSET STREET TO LANCASTER STREET, CITY OF PORTLAND, MAINE PUBLIC SERVICES DEPARTMENT ENGINEERING DIVISION DATED OCT. 16, 2012.
- 2. BAYSIDE TRAIL SOMERSET STREET EXTENTION, ELM STREET TO KENNEBEC STREET, CITY OF PORTLAND, MAINE PUBLIC SERVICES DEPARTMENT ENGINEERING DIVISION DATED JULY 3, 2012.
- ALTA/ACSM LAND TITLE SURVEY ON PREBLE STREET, LANCASTER STREET EAST, ELM STREET &
  OXFORD STREET, PORTLAND, MAINE MADE FOR BAYSIDE I, LLC JAN. 26, 2000 BY OWEN HASKELL, INC.
  RECORDED IN PLAN BOOK 200 PAGE 40.

LEGEND

PROPERTY LINE

	MONUMENT FOUND III	Ш
	UTILITY POLE Ø	Ш
	MANHOLE	Ш
	ELECTRIC/GAS METER ⊠ EM/GM	١'n
	SIGN	Ш
	CATCH BASIN	ĮΙ
	HYDRANT Q	
Approved: Portland Planning Board	WATER VALVE ⊗	Ш
late:	LIGHT POLE	Il
(200) <del>Part of the Part of the Control of the Contr</del>	FENCE X X	Ξ
hair,	GRANITE CURB	Iſ
177.1	SLIPFORM CONCRETE CURB	Ш
oard Members,	OVERHEAD WIRES —— OHW——	Ш
	WATER LINE W	Ш
	OAS LINE G ——	١'n
	TELEPHONE T	Ш
	STORM DRAIN SD	Ш
	SANITARY SEWER S	
	FASEMENT AREA	ΠL

Prepared For: Owner and Applicant: SCHLOTTERBECK BLOCK L.L.C. 77 Spruce Street Portland, Maine 04101 Tel.: 207-650-8979

Prepared By: MITCHELL & ASSOCIATES

RANSOM CONSULTING ENGINEERS 400 Commercial Street # 4 Portland, Maine 04101 Phone: 207-772-2891

GODUTI-THOMAS ARCHITECTS 44 Oak Street # 2 Portland, Maine 04101 Phone: 207-775-3184

> Maine Block Portland,

chlotterbeck Street S The Preble

Date: OCTOBER 5, 2015


Issued For: Revisions:

DEC. 1, 2015: REVISED PER STAFF REVIEW COMMENTS

Reproduction or reuse of this documen without the expressed written consent of Mitchell & Associates is prohibited.

© 2015

SUBDIVISION PLAN

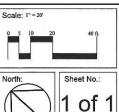


2. Asite Width
The Planning Board finds that the applicant has demonstrated that extraordinary conditions unique to this property exist that limit the ability to meet the aisle width standard of 24 feet and Mr. Errico has found that the proposed aisle widths provide safe on-site circulation; and the Board finds that the public interest and purposes of the land development plan are secured. The Planning Board therefore voted to waive Technical Manual 1.7.2.3. Minimum driveway width (hvo-way) to allow a 20 foot aisle width along Arbor Street and 20 feet along Forest Avenue.

SUBDIVISION PLAT CONDITIONS OF APPROVAL

The Planning Board voted that the plan is in conformance with the subdivision standards of the land use code, subject to the following conditions:

- The final sidewalk easements to provide public access shall be reviewed and approved by Corporation Counsel prior to the issuance of certificate of occupancy.
- The recording plat shall be revised noting all waivers and conditions for review and approval by the Planning Authority prior to recording. All waivers shall be recorded within 90 days of the Planning Board approval.

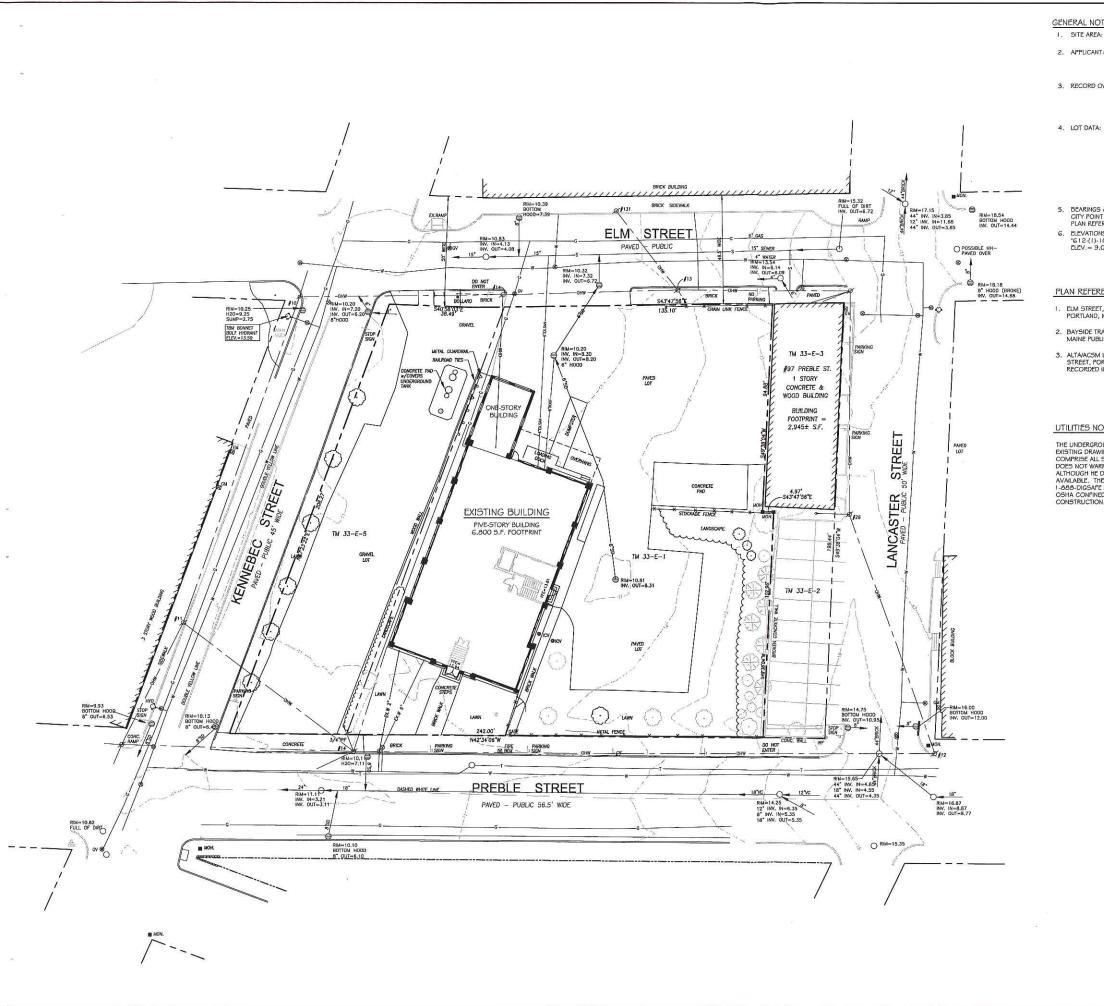

GENERAL NOTES

40,806 S.F. OR 0.93 ACRE

2. APPLICANT: SCHLOTTERBECK BLOCK, LLC

77 SPRUCE STREET PORTLAND, MAINE 04101

3. RECORD OWNER: J.B. BROWN ¢ SONS 482 CONGRESS STREET

P.O. BOX 207 PORTLAND, MAINE 04112

TAX MAP 33, BLOCK E, LOT I

C.C.R.D BOOK 26354, PAGE 312 AREA: 30,492 5.F.

TAX MAP 33, BLOCK E, LOT 5 C.C.R.D BOOK 26354, PAGE 314

AREA: 10.314 S.F.

BEARINGS ARE BASED ON MAINE STATE PLAN COORDINATE SYSTEM MAINE WEST NAD 63, BASED ON CITY POINT 55 N:301742.42 E: 2927203.66 AND POINT 59 N:301442.06 E:2927035.61 FROM FLAN REFERENCE 1.

ELEVATIONS BASED ON NGVD 1929. CITY BENCHMARK TBM 307 FLAN REFERENCE 1, MDOT DISK 'G12-(1)-10 1993' IN CONCRETE BASE OF LIGHT POLE AT NORTHEAST CORNER ELM/SOMERSET ELEV.= 9-02.

- FLM STREET STREET LINE RETRACEMENT PLAN SOMERSET STREET TO LANCASTER STREET CITY OF
- BAYSIDE TRAIL SOMERSET STREET EXTENTION, ELM STREET TO KENNEBEC STREET, CITY OF PORTLAND, MAINE PUBLIC SERVICES DEPARTMENT ENGINEERING DIVISION DATED JULY 3, 2012.
- ALTAJACSM LAND TITLE SURVEY ON PREBLE STREET, LANCASTER STREET EAST, ELM STREET ₺ OXFORD STREET, PORTLAND, MAINE MADE FOR BAYSIDE I, LLC JAN. 2G, 2000 BY OWEN HASKELL, INC. RECORDED IN PLAN BOOK 200 PAGE 40.

### UTILITIES NOTE

THE UNDERGROUND UTILITIES SHOWN HAVE BEEN LOCATED FROM FIELD SURVEY INFORMATION AND EXISTING DRAWINGS. THE SURVEYOR MAKES NO GUARANTEES THAT THE UNDERGROUND UTILITIES SHOWN COMPRISE ALL SUCH UTILITIES IN THE AREA, EITHER IN SERVICE OR ABANDONED. THE SURVEYOR FURTHER DOES NOT WARRANT THAT THE UNDERGROUND UTILITIES SHOWN ARE IN THE EXACT LOCATION INDICATED ALTHOUGH HE DOES CERTIFY THAT THEY ARE LOCATED AS ACCURATELY AS POSSIBLE FROM INFORMATION AVAILABLE. THE SURVEYOR HAS NOT PHYSICALLY LOCATED THE UNDERGROUND UTILITIES. CALL 1-888-DIGSAFE AT LEAST THREE BUSINESS DAYS BEFORE PERFORMING ANY CONSTRUCTION. DUE TO OSHA CONTINEO SPACE REQUIREMENTS, ALL INVERTS AND PIPE SIZES MUST BE VERIFIED PRIOR TO ANY CONSTRUCTION.

PROPERTY LINE IRON PIPE OR ROD FOUND

UTILITY POLE

CATCH BASIN

WATER VALVE LIGHT POLE

GRANITE CURB

WATER LINE

TELEPHONE

SANITARY SEWER

I' CONTOUR

GAS LINE

FENCE

SIGN

MONUMENT FOUND

10

Ø 0

-0-

Q

8

举

\_x\_x\_

----OHW----

\_\_\_ w \_\_\_

- G ---

[— T—

\_\_ 10 \_\_

ELECTRIC/GAS METER 

☑ EM/GM

Prepared For: Owner and Applicant: SCHLOTTERBECK BLOCK L.L.C.

Prepared By: MITCHELL & ASSOCIATES

70 Center Street Portland, Maine 04101 Fel.: 207-774-4427 RANSOM CONSULTING ENGINEER

400 Commercial Street # 4 Portland, Maine 04101 Phone; 207-772-2891

GODUTI-THOMAS ARCHITECTS 44 Oak Street # 2 Portland, Maine 04101 Phone: 207-775-3184

Maine

Block chlotterbeck

Street Preble

Date OCTOBER 5, 2015


Th


Issued For:

DEC. 1, 2015: REVISED PER STAFF

Reproduction or reuse of this document without the expressed written consent of Mitchell & Associates is prohibited. © 2015

EXISTING CONDITION PLAN

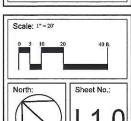

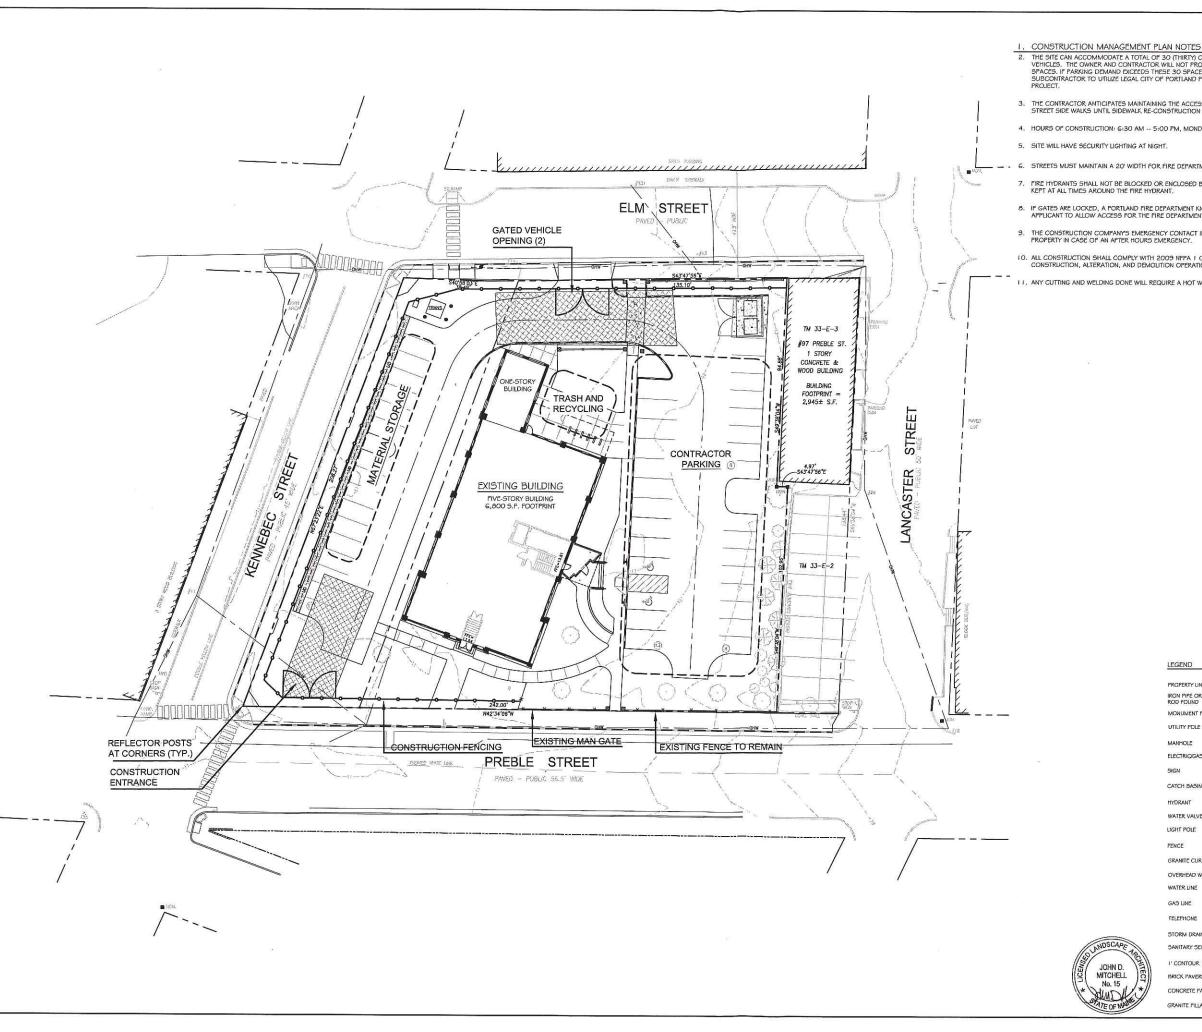

- THE SITE CAN ACCOMMODATE A TOTAL OF 30 (THIRTY) CONTRACTOR AND SUB-CONTRACTOR
  VEHICLES. THE OWNER AND CONTRACTOR WILL NOT PROVIDE PARKING BEYOND THEES 30 PARKING
  SPACES. IF PARKING DEMAND EXCECEDS THEES 30 SPACES, If WILL BE THE RESPONSIBILITY OF THE
  SUBCONTRACTOR TO UTILIZE LEGAL CITY OF PORTLAND PARKING SPACES IN THE VIGINITY OF THE
  BPOLICET.
- THE CONTRACTOR ANTICIPATES MAINTAINING THE ACCESSIBILITY OF THE ELM STREET AND PREBLE STREET SIDE WALKS UNTIL SIDEWALK RE-CONSTRUCTION OF THESE SIDEWALKS OCCURS.
- 4. HOURS OF CONSTRUCTION: 6:30 AM -- 5:00 PM, MONDAY THROUGH FRIDAY.
- 6. STREETS MUST MAINTAIN A 20' WIDTH FOR FIRE DEPARTMENT ACCESS AT ALL TIMES.
- FIRE HYDRANTS SHALL NOT BE BLOCKED OR ENCLOSED BY FENCING. A 3" FOOT CLEARANCE MUST BE KEPT AT ALL TIMES AROUND THE FIRE HYDRANT.
- IF GATES ARE LOCKED, A PORTLAND FIRE DEPARTMENT KNOX PADLOCK MUST BE PURCHASED BY THE APPLICANT TO ALLOW ACCESS FOR THE FIRE DEPARTMENT.
- THE CONSTRUCTION COMPANYS EMERGENCY CONTACT INFORMATION SHALL BE POSTED ON THE PROPERTY IN CASE OF AN AFTER HOURS EMERGENCY.
- ALL CONSTRUCTION SHALL COMPLY WITH 2009 NFPA I CHAPTER 16 SAFEGUARDS DURING BUILDING CONSTRUCTION, ALTERATION, AND DEMOLITION OPERATIONS.
- II. ANY CUTTING AND WELDING DONE WILL REQUIRE A HOT WORK PERMIT FROM FIRE DEPARTMENT.

LEGEND

MANHOLE

CATCH BASIN

WATER VALVE

FFNCF

WATER LINE

Prepared For: Owner and Applicant: SCHLOTTERBECK BLOCK L.L.C. 77 Spruce Street Portland, Maine 04101 Tel.: 207-650-8979

> Prepared By MITCHELL & ASSOCIATES Landscape Architects 70 Center Street Portland, Maine 04101 Tel.: 207-774-4427

RANSOM CONSULTING ENGINEERS 400 Commercial Street # 4 Portland, Maine 04101 Phone: 207-772-2891

GODUTI-THOMAS ARCHITECTS 44 Oak Street # 2 Portland, Maine 04101 Phone: 207-775-3184

Maine

Block

chlotterbeck 0 Ţ

Street

Preble

OCTOBER 5, 2015

Issued For:

PROPOSED

•

\* --

0

**Q** 

8

茶

\_<del>-x-x-</del>

\_\_\_\_OHW\_\_\_\_

\_\_\_\_ w \_\_\_

ELECTRICIGAS METER EM/GM

DEC. 1, 2015: REVISED PER STAFF REVIEW COMMENTS

© 2015


le: CONSTRUCTION MANAGEMENT PLAN







GAS LINE TELEPHONE --- SD ----STORM DRAIN SANITARY SEWER \_\_\_ 10 \_\_\_ (160) BRICK PAVERS CONCRETE PAVERS

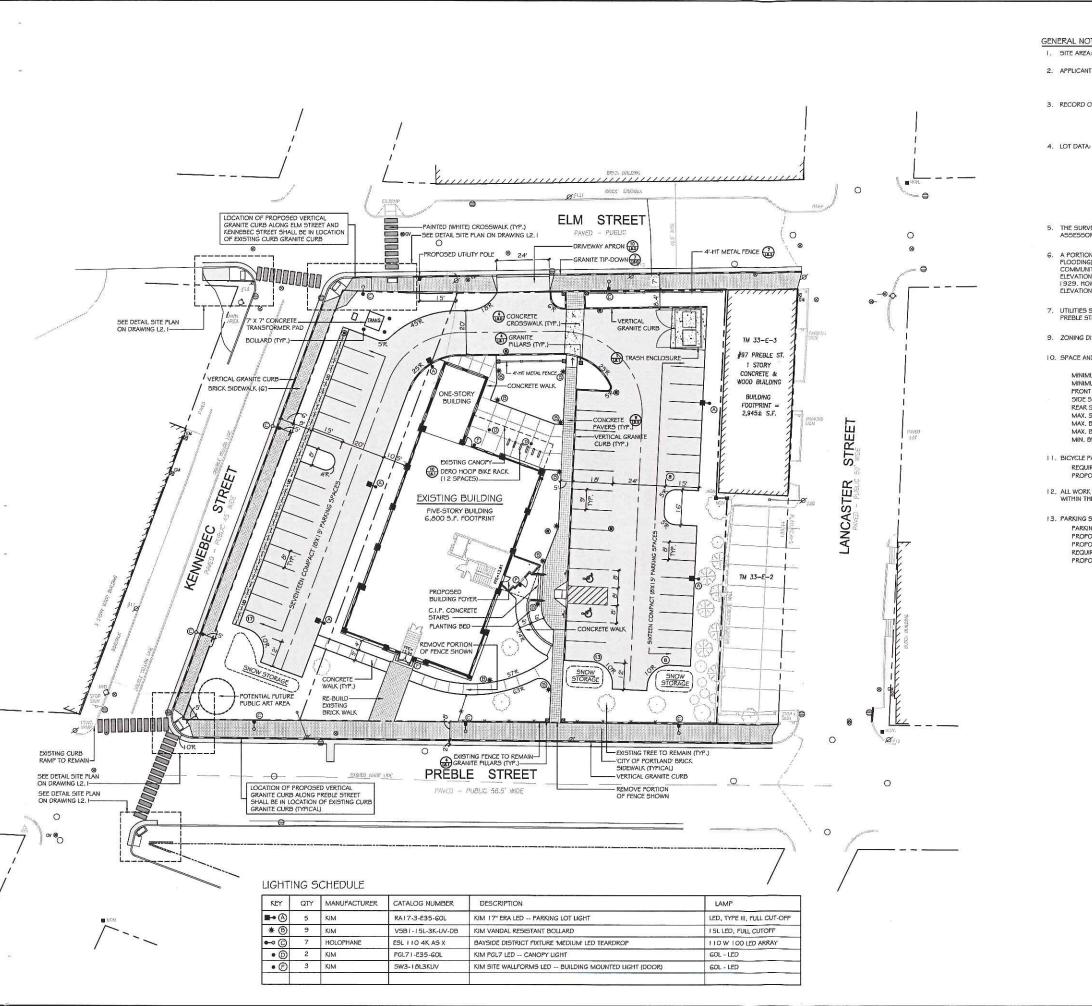

GENERAL NOTES

I. SITE AREA: 40.720 S.F. OR 0.93 ACRE

2. APPLICANT: SCHLOTTERBECK BLOCK, LLC

77 SPRUCE STREET PORTLAND, MAINE 04101

3. RECORD OWNER: J.B. BROWN ¢ 50N5 482 CONGRESS STREET P.O. BOX 207

PORTLAND, MAINE 04112

TAX MAP 33, BLOCK E, LOT I

C.C.R.D BOOK 26354, PAGE 312 AREA: 30,492 5.F.

TAX MAP 33. BLOCK E. LOT 5 C.C.R.D BOOK 26354, PAGE 314

AREA: 10,314 S.F.

THE SURVEYED PARCELS ARE SHOWN AS LOTS | AND 5, BLOCK E, ON THE CITY OF PORTLAND'S ASSESSORS MAP 33.

G. A PORTION OF THE PARCEL IS LOCATED, BY SCALING METHODS, WITHIN ZONE C (AREAS OF MINIMAL FLOODING) AS SHOWN ON THE FLOOD INSURANCE RATE MAP FOR THE CITY OF PORTIAND, MAINE COMMUNITY PANEL NO. 23005 I -001 3-B WITH AN EFFECTIVE DATE OF JULY 17, 1966. THE FLOOD ELEVATION FOR THE AZ ZONE WHICH ENCOMPASSES BACK COVE HAS AN ELEVATION OF 10 N.G.V.D. 1929. HOWEVER, THE TOPOGRAPHICLAL SURVEY OF THE PARCEL SHOWS THE LOT ABOVE THE ELEVATION OF 10 N.G.V.D. (1929).

UTILITIES SHOWN ARE BASED ON A PLAN ENTITLED BOUNDARY AND TOPOGRAPHIC SURVEY OF 117 PREBLE STREET, PERFORMED BY OWEN HASKELL, INC., DATED JULY 7, 2015.

9. ZONING DISTRICT: B-7 MIXED DEVELOPMENT DISTRICT ZONE

10. SPACE AND BULK STANDARDS:

MIN. BUILDING HEIGHT:

MINIMUM FRONTAGE: NONE **242 FEET** FRONT SETBACK: NONE REQUIRED 18 FEE REAR SETBACK NONE REQUIRED 31 FEET MAX. STREET SETBACK 10 FEET 18 FEET (EXISTING) MAX. BUILDING LOT COVERAGE: MAX. BUILDING HEIGHT: 100 PERCENT 105 FEET GB PERCENT

45 FEET

11. BICYCLE PARKING:

24 SPACES (22 RESIDENTIAL, 2 COMMERCIAL) REQUIRED: PROPOSED: 24 SPACES (12 EXTERIOR, 12 INTERIOR)

12. ALL WORK WITHIN THE ROAD RIGHT-OF-WAY AND ALL UTILITIES CONNECTING TO INFRASTRUCTURE WITHIN THE ROAD SHALL MEET CITY OF PORTLAND TECHNICAL MANUAL STANDARDS.

PROPERTY LINE

IRON PIPE OR ROD FOUND

UTILITY POLE

CATCH BASIN

WATER VALVE

GRANITE CURB OVERHEAD WIRES

LIGHT POLE

FENCE

MONUMENT FOUND

13. PARKING SUMMARY:

PARKING REQUIRED PER PARKING ANALYSIS: 50 SPACES PROPOSED PARKING: PROPOSED COMPACT (8' X 15"): 46 SPACES 33 SPACES (72%) REQUIRED A.D.A. ACCESSIBLE SPACES 2 SPACES PROPOSED A.D.A ACCESSIBLE SPACES 2 SPACES

SCHLOTTERBECK BLOCK L.L.C. repared By:

MITCHELL & ASSOCIATES
Landscape Architects
70 Center Street

Prepared For: Owner and Applicant

rtland, Maine 04101 1.: 207-774-4427 RANSOM CONSULTING ENGINEERS 00 Commercial Street # 4 ortland, Maine 04101 Phone: 207-772-2891

GODUTI-THOMAS ARCHITECTS 44 Oak Street # 2

Portland, Maine 04101 Phone: 207-775-3184

Maine

Portland,

Block

chlotterbeck

Street Preble P

Date:	
Duto.	OCTOBER 5, 2015


Revisions:

DEC. 1, 2015: REVISED PER STAFF REVIEW COMMENT


Reproduction or reuse of this docume without the expressed written consent of Mitchell & Associates is prohibited.

© 2015

LAYOUT AND LIGHTING PLAN

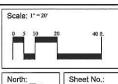



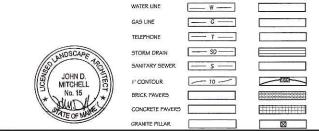

EXISTING

\_\_\_\_

0

8

茶

\_\_\_\_\_\_\_\_\_\_\_\_ \_\_\_\_

——онw——


0

ELECTRIC/GAS METER EM/GM


PROPOSED

•


\* --

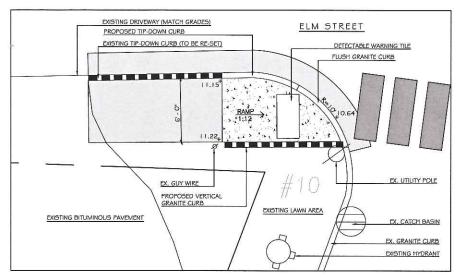


SIDEWALK RAMP: KENNEBEC STREET AND ELM

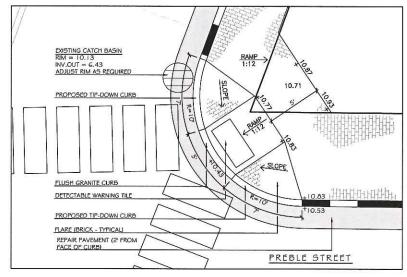

SIDEWALK RAMP: KENNEBEC STREET AND PREBLE STREET (NORTH)

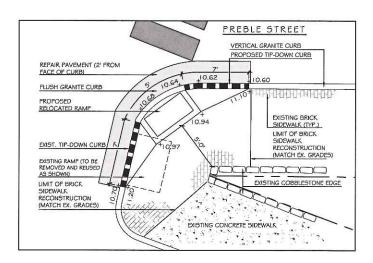


SIDEWALK RAMP: KENNEBEC STREET AND PREBLE STREET (SOUTH)

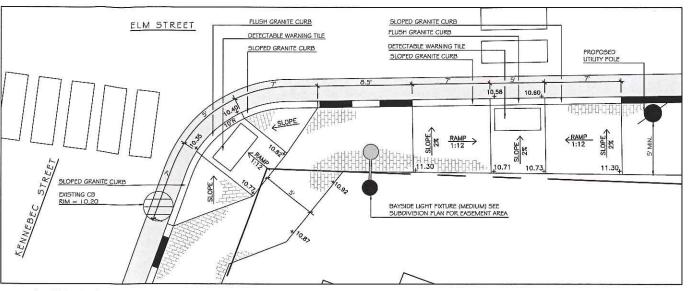

SIDEWALK RAMP: KENNEBEC STREET AND ELM

MITCHELL No. 15

NOTE: CONTRACTOR SHALL COORDINATE WITH CITY OF PORTLAND AND OWNER'S REPRESENTATIVE BEFORE CONSTRUCTING CURB CUTS.

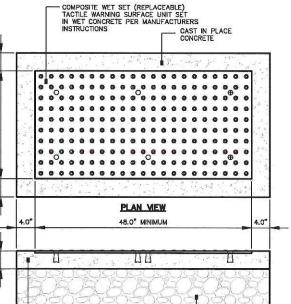


# SIDEWALK RAMP DETECTABLE WARNING TILE

SECTION VIEW

-10" COMPACTED BASE GRAVEL

## NOTES:

- COMPOSITE WET SET (REPLACEABLE) TACTILE WARNING SURFACE UNITS SHALL BE AS MANUFACTURED BY ADA SOLUTIONS, INC. (WWW.ADATILE.COM), OR APPROVED EQUAL.
- 2. CAST IN PLACE CONCRETE SHALL MEET SPECIFICATIONS FOR MDOT CLASS A STRUCTURAL CONCRETE, MINIMUM COMPRESSIVE STRENGTH 4,000 PSI. THE CONCRETE SHALL BE SEALED PRIOR TO SETTING PANELS. THE EXPOSED CONCRETE BORDER SHALL RECEIVE A GROOVED EDGE BETWEEN THE TILE AND CONCRETE, ALONG WITH A UNIFORM BROOM FINISH PERPENDICULAR TO THE FLOW OF PEDESTRIAN TRABELS.
- TRUNCATED DOMES SHALL BE ALIGNED IN ROWS, PARALLEL AND PERPENDICULAR TO THE PREDOMINANT DIRECTION OF TRAVEL. TRUNCATED DOME BRICKS AND GRANITE PAVERS ARE NOT ALLOWED. ARE NOT ALLOWED.
- FOR ALL SIDEWALK RAMPS MADE OF CONCRETE OR ASPHALT, FEDERAL YELLOW COLORED (#33538) TILES SHALL BE USED. FOLLOW MANUFACTURER'S INSTRUCTIONS FOR INSTALLATION.
- FOR ALL SIDEWALK RAMPS MADE OF BRICK, SEATTLE YELLOW (#23594) COATED COLORED TILES SHALL BE USED.

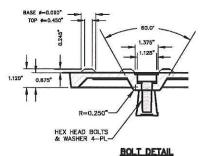

SIDEWALK RAMP DETECTABLE WARNING TILE

-CAST IN PLACE CONCRETE

The

Date: OCTOBER 5, 2015

Prepared For: Owner and Applicant: SCHLOTTERBECK BLOCK L.L.C.

Portland, Maine 04101 Tel.: 207-650-8979

Portland, Maine 04101 Phone: 207-775-3184

Block

chlotterbeck

Prepared By: MITCHELL & ASSOCIATES

RANSOM CONSULTING ENGINEERS 400 Commercial Street # 4 Portland, Maine 04101 Phone: 207-772-2891 GÖDUTI-THOMAS ARCHITECTS

Maine

Portland,

Preble

Issued For:


Revisions:

DEC. 1, 2015: REVISED PER STAFF REVIEW COMMENTS

uction or reuse of this documen without the expressed written consent of Mitchell & Associates is prohibited. © 2015

DETAIL SITE PLANS: SIDEWALK RAMPS

Scale: AS SHOWN

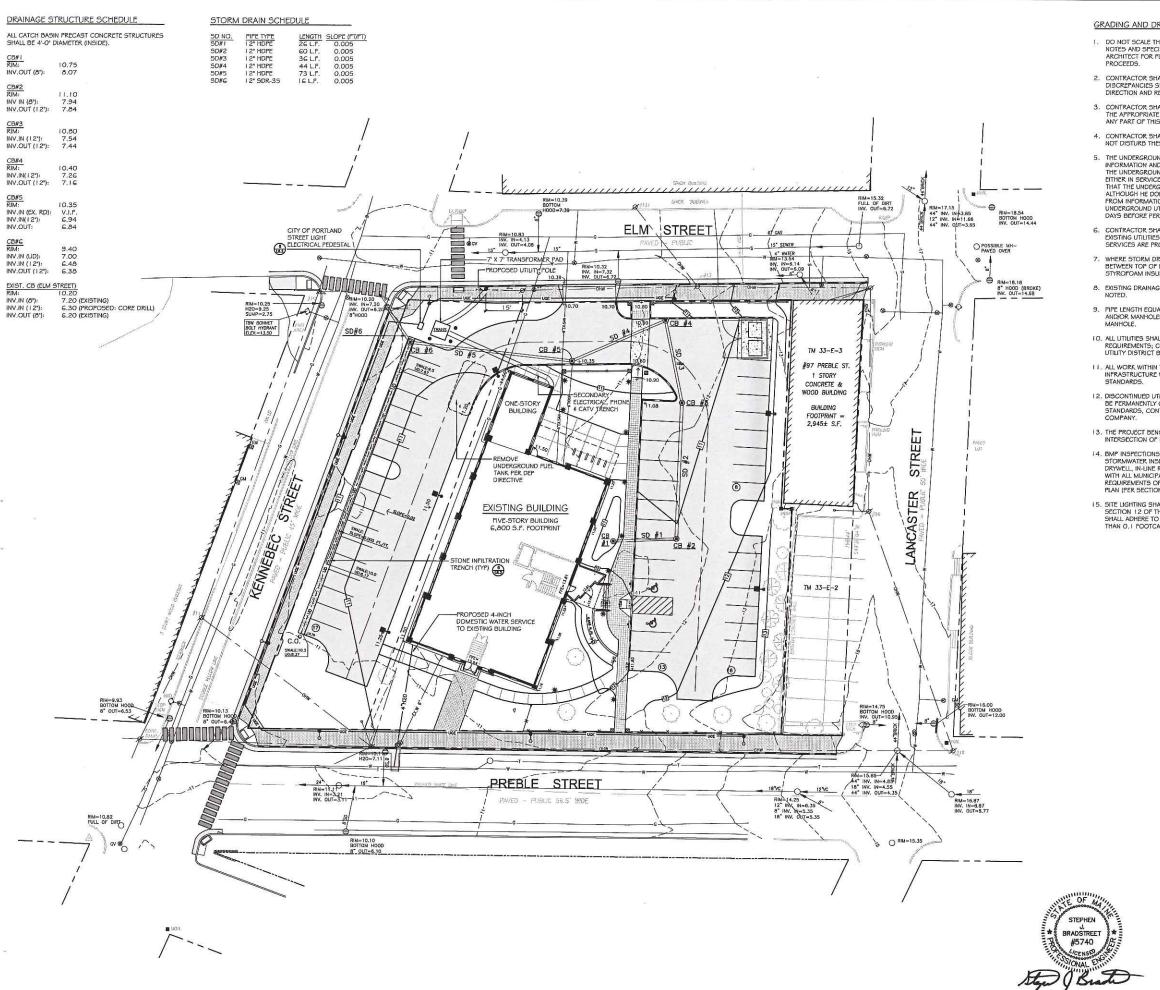

### GRADING AND DRAINAGE NOTES:

- DO NOT SCALE THESE DRAWINGS. ANY DISCREPANCIES BETWEEN DRAWINGS, DETAILS, NOTES AND SPECIFICATIONS SHALL BE IMMEDIATELY REPORTED TO THE LANDSCAPE ARCHITECT FOR FURTHER DIRECTION AND RESOLUTION BEFORE ADDITIONAL WORK, PROCEEDS.
- 2. CONTRACTOR SHALL VERIFY ALL DIMENSIONS AND GRADES ON THE GROUND. ANY DISCREPANCIES SHALL BE REPORTED IMMEDIATELY TO THE LANDSCAPE ARCHITECT FOR DIRECTION AND RESOLUTION PRIOR TO ANY FURTHER WORK.
- 3. CONTRACTOR SHALL FIFLD VERIFY LOCATION AND DEPTH OF ALL EXISTING LITHLITIES WITH HE APPROPRIATE UTILITY COMPANIES PRIOR TO EXCAVATION OF OR INSTALLATION OF ANY PART OF THIS WORK.
- 4. CONTRACTOR SHALL AVOID ALL AREAS NOT REQUIRING GRADING. CONTRACTOR SHALL NOT DISTURB THESE AREAS.
- 5. THE UNDERGROUND UTILITIES SHOWN HAVE BEEN LOCATED FROM FIELD SURVEY INFORMATION AND EXISTING DRAWINGS. THE SURVEYOR MAKES NO GUARANTEES THAT THE UNDERGROUND UTILITIES SHOWN COMPRISE ALL SUCH UTILITIES IN THE AREA, ETHER IN SERVICE OR ABANDONED. THE SURVEYOR FURTHER DOES NOT WARRANT THAT THE UNDERGROUND UTILITIES SHOWN ARE IN THE EXACT LOCATION INDICATED ALTHOUGH HE DOES CERTIFY THAT THEY ARE LOCATED AS ACCURATELY AS POSSIBLE FROM INFORMATION AVAILABLE. THE SURVEYOR HAS NOT PHYSICALLY LOCATED THE LIMPERGOLIND LITTIES. CALL DYGAFE IL ABOUT A 24 A 27323 AT LIFEST UNDERGROUND LITTIES. UNDERGROUND UTILITIES, CALL DIGSAFE (1-888-344-7233) AT LEAST THREE BUSINESS DAYS BEFORE PERFORMING ANY CONSTRUCTION.
- 6. CONTRACTOR SHALL CONDUCT TEST PIT EXCAVATION TO CONFIRM LOCATION OF EXISTING UTILITIES WHERE NEW UNDERGROUND ELECTRICAL, TELEPHONE AND CATV SERVICES ARE PROPOSED.
- 7. WHERE STORM DRAINS OR SEWER MAINS HAVE LESS THAN FOUR (4) FEET OF COVER BETWEEN TOP OF PIPE AND FINISH GRADE, INSULATE PIPE USING TWO (2) INCH THICK STYROFOAM INSULATION BOARD OVER AND ALONG SIDES OF THE PIPE.
- 8. EXISTING DRAINAGE CATCHBASIN SHALL BE CORED TO ACCEPT NEW DRAINAGE PIPE AS
- PIPE LENGTH EQUALS THE CENTER TO CENTER DISTANCES BETWEEN CATCH BASINS AND/OR MANHOLES MINUS ONE-HALF OF THE DIAMETER OF EACH CATCH BASIN OR MANHOLE.
- 10. ALL UTILITIES SHALL BE INSTALLED IN CONFORMANCE WITH INDIVIDUAL UTILITY DISTRICT REQUIREMENTS; CONTRACTOR SHALL COORDINATE INSTALLATION WITH APPROPRIATE UTILITY DISTRICT BEFORE INSTALLATION.
- II. ALL WORK WITHIN THE ROAD RIGHT-OF-WAY AND ALL UTILITIES CONNECTING TO INFRASTRUCTURE WITHIN THE ROAD SHALL MEET CITY OF PORTLAND TECHNICAL MANUAL STANDARDS.
- 1.2. DISCONTINUED UTILITY SERVICES INCLUDING WATER, GAS AND SANITARY SEWER SHALL BE FERMANENTLY CAPPED CONFORMING TO UTILITY COMPANY AND GITY OF PORTLAND STANDARDS, CONTRACTOR SHALL COORDINATE WITH PUBLIC SERVICES AND/OR UTILITY
- 13. THE PROJECT BENCH MARK IS BONNET BOLT OF FIRE HYDRANT LOCATED AT INTERSECTION OF ELM STREET AND KENNEBEC STREET. BENCHMARK ELEVATION: 13.50.
- 14. BMP INSPECTIONS: THE OWNER SHALL HIRE A QUALIFIED POST-CONSTRUCTION STORMWATER INSPECTOR TO ANNUALLY, INSPECT THE BMPS, INCLUDING CATCH BASIN, DRWHELL, IN-LINE ROOF FILTERS, PIPES AND RELATED STRUCTURES, IN ACCORDANCE WITH ALL MUNICIPAL AND STATE INSPECTION, CLEANING AND MAINTENANCE REQUIREMENTS OF THE APPROVED POST-CONSTRUCTION STORMWATER MANAGEMENT PLAN (PER SECTION 32 OF THE CITY OF PORTLAND CODE OF ORDINANCES).
- 15. SITE LIGHTING SHALL MEET THE CITY OF PORTLAND STANDARDS AS OUTLINED IN SECTION 12 OF THE CITY OF PORTLAND TECHNICAL DESIGN STANDARDS. SITE LIGHTING SHALL ADHERE TO SECTION 12.2.5 LIGHT TESEPASS-LIGHTING SHALL NOT BE GREATER THAN 0.1 FOOTCAMBLES AT THE PROPERTY LINE.

EGEND		
	EXISTING	PROPOSED
PROPERTY LINE	<b>—</b>	
RON PIPE OR ROD FOUND	0	
MONUMENT FOUND	702	
UTILITY POLE	Ø	
MANHOLE	0	
ELECTRIC/GAS METER	⊠ EM/GM	
BIGN	-un	
CATCH BASIN		•
TYDRANT	•	
WATER VALVE	⊗	
JGHT POLE	<b>*</b>	* =-=
ENCE	_x x	
GRANITE CURB		
OVERHEAD WIRES	онw	
WATER LINE	w	
GAS LINE	G	
TELEPHONE		
STORM DRAIN	SD	
SANITARY SEWER	s	
'CONTOUR	10	150
BRICK PAVERS		
CONCRETE PAVERS		
GRANITE PILLAR		
CLEANOUT		O c.o.
STONE INFILTRATION		UD
SECONDARY ELECTRIC FOR CITY LIGHTS)		UGE-

Prepared For: Owner and Applicant SCHLOTTERBECK BLOCK L.L.C.

Portland, Maine 04101 Tel.: 207-650-8979 Prenared By MITCHELL & ASSOCIATES

RANSOM CONSULTING ENGINEERS 400 Commercial Street # 4 Portland, Maine 04101 Phone: 207-772-2891

GODUTI-THOMAS ARCHITECTS


Maine Portland,

Block

chlotterbeck S 0 Preble P

S

Date:	OCTOBER 5, 2015
Issue	d For:
Revis	ions:
DEC.	I, 2015: REVISED PER STAFF REVIEW COMMENT

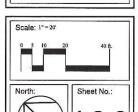

without the expressed written consent of Mitchell & Associates is prohibited © 2015

GRADING, DRAINAGE AND UTILITIES PLAN

### EROSION AND SEDIMENT CONTROL PLAN

THIS PLAN HAS BEEN DEVELOPED AS A STRATEGY TO CONTROL SOIL EROSION AND SEDIMENTATION DURING AND AFTER THE RE-DEVELOPMENT OF THE SCHILOTTERBECK AND FOSS BUILDING AT 117 PREBLE STREET IN FORTLAND, MAINE. THIS PLAN IS BASED ON THE MAINE REOSION AND SEDIMENTATION CONTROL HANDBOOK FOR CONSTRUCTION, BEST MANAGEMENT PRACTICES, MARCH, 2003.

### A. PROPOSED DEVELOPMENT

THE PROJECT CONSISTS OF THE RE-DEVELOPMENT OF AN EXISTING FIVE-STORY, 6,800 SQUARE FOOT BUILDING. THE BUILDING WILL INCLUDE 55 AFARTMENT UNITS AND 2,000 S.F. OF COMMERCIAL OFFICE SPACE. THE 40,702 S.F. PARCEL CURRENTLY CONSISTS OF THE BUILDING AND A PAVED PARKING LOT AND A GRAVEL PARKING LOT; 73% OF THE EXISTING SITE IS IMPERVIOUS. THE PROPOSED IMPERVIOUS LOT IMPERVIOUS IS 27,300 S.F. OR 67% OF THE SITE

### B. EROSION CONTROL PRACTICES/TEMPORARY MEASURES

THE FOLLOWING TEMPORARY MEASURES TO CONTROL EROSION AND SEDIMENTATION SHALL BE UTILIZED:

EACH GROUND AREA, OPENED OR EXPOSED, WHETHER DIRECTLY OR INDIRECTLY DUE TO THE DEVELOPMENT, SHALL BE MINIMIZED AND SHALL BE STABILIZED WITHIN 15 DAYS OF INITIAL DISTURBANCE OF SOIL AND SHALL BE PERMANENTLY STABILIZED WITHIN SEVEN DAYS OF FINAL GRADING, THIS STATEMENT APPLIES TO DISTURBED AREAS BEYOND THE LIMITS OF THE PROPOSED BUILDING. EXPOSED AREAS SHALL BE STABILIZED PRIOR TO A

TEMPORARY SOIL STABILIZATION SHALL BE EITHER BY TEMPORARY MULCHING. TEMPORARY SEEDING, PERMANENT BASE GRAVEL, OR ASPHALT BINDER COURSE AS FOLLOWS:

TEMPORARY SEEDING: SEED SHALL BE AROOSTOOK RYE APPLIED AT 2.60#/1000 SF, LIME SHALL BE AGRICULTURAL GROUND LIMESTONE APPLIED AT 13.8#/1000 SF, FERTILIZER SHALL BE 10-10-10 CLASSIFICATION APPLIED AT 13.8#/1000 SF, MULICH SHALL CONSIST OF HAY AND STRAW MULICH AND SPREAD EVENLY AT A RATE OF 70-90#/1000 SF, TEMPORARY SEEDINGS SHALL ONLY BE MADE BETWEEN APRIL 15 AND OCTOBER 1, AND SHALL NOT BE PLACED OVER SNOW.

TEMPORARY MULCHING: MULCH SHALL CONSIST OF CHOPPED HAY OR STRAW MULCH AND SPREAD BY MECHANICAL BLOWER EVENLY AT A RATE OF 150-200#/1000 SF. TEMPORARY MULCH SHALL BE REMOVED PRIOR TO PERMANENT SOIL STABILIZATION. MULCH MUST NOT BE PLACED OVER SNOW. SNOW SHALL BE REMOVED PRIOR TO MULCHING

PERMANENT BASE GRAVEL: BASE GRAVEL UNDER PAVEMENT SHALL BE SUITABLE AS TEMPORARY SOIL STABILIZATION UNDER THE FOLLOWING CONDITIONS:

a) SLOPES SHALL BE LESS THAN EIGHT PERCENT;
b) GRAVEL SHALL MEET THE SPECIFICATIONS FOR BASE OR SUBBASE GRAVEL FOR THE PROPOSED COMPLETED PAVEMENT.

C. EROSION CONTROL PRACTICES/PERMANENT MEASURES THE FOLLOWING PERMANENT MEASURES TO CONTROL EROSION AND SEDIMENTATION SHALL BE UTILIZED:

PERMANENT SEEDING SHALL BE PERFORMED DURING CONSTRUCTION OPERATIONS AS EACH DISTURBED AREA HAS BEEN BROUGHT TO FINISH GRADE. PERMANENT SEEDINGS SHALL BE MADE AS DORMANT SEEDING AFTER THE FIRST KILLING FROST. DORMANT SEEDING AND MULCH SHALL BE USED AT TWO TIMES THE PERMANENT EEDING AND MULCHING RATE SHOWN BELOW FOR BOTH LAWN AS WELL AS EMBANKMENTS. SEED, LOAM, LIME,

SEED: THE SEED MIXTURE SHALL CONSIST OF SEED PROPORTIONED BY WEIGHT. ALL SEED SHALL BE FRESH, CLEAN, NEW CROP'S SEED. HARMLESS INERT MATTER AND WEED SEEDS SHALL BE PERMITTED UP TO ONE PERCENT OF THE GROSS WEIGHT OF EACH VARIETY OF SEED. ALL SEED SUPPLIED SHALL BE PACKED IN APPROVED CONTAINERS BEARING THE MANUFACTURER'S MANE AND ANALYSIS OF CONTENTS. THE FOLLOWING MATERIALS AND APPLICATION RATES SHALL BE REQUIRED FOR PERMANENT SEEDING

CREEPING RED RESCUE: 0.69#/1000 SF KENTUCKY BLUEGRASS 1.84#/1000 SF

LOAM: SHALL BE FREE OF GRASSES, ROOTS, LARGE STONE AND INORGANIC DEBRIS. PLACE LOAM AT FOUR INCHES MINIMUM DEPTH OVER ALL DISTURBED AREAS. FINAL GRADING OF ALL LAWN AREAS TO BE APPROVED BY LANDSCAPE ARCHITECT BEFORE SEEDING.

LIME, LIME SHALL BE AGRICULTURAL GROUND LIMESTONE AND APPLIED AS PER. RECOMMENDATION OF A STATE COMMERCIAL SOIL TESTING LABORATORY, FERTILIZER: FERTILIZER SHALL BE 10-20-20 CLASSIFICATION AND APPLIED AS PER. RECOMMENDATION OF A STATE COMMERCIAL SOIL TESTING

MULCH: MULCH SHALL CONSIST OF HAY OR STRAW MULCH, MULCH SHALL BE SPREAD EVENLY AT A RATE OF TWO AND ONE HALF TONS PER ACRE OVER ALL SEEDING. AFTER APPLICATION, THE MULCH SHALL BE THOROUGHLY WETTED. IN STEEP AREAS, THE MULCH SHALL BE HELD IN PLACE BY THE USE OF JUTE EROSION CONTROL NETTING OR APPROVED ALTERNATIVE NETTING MATERIAL, NOTE: ALL EXPOSED SOIL MUST BE COVERED REGARDLESS OF MULCHING RATES SPECIFIED

THE CONTRACTOR SHALL MAINTAIN THE SEEDED AND MULCHED AREAS UNTIL FINAL ACCEPTANCE OR THE WORK MAINTENANCE SHALL CONSIST OF PROVIDING PROPER WATERING, PROTECTION AGAINST TRAFFIC AND REPAIRING ANY AREAS DAMAGED DUE TO WIND, WATER, EROSION, FIRE OR OTHER CAUSES, SUCH DAMAGED AREAS SHALL BE REPAIRED TO REESTABLISH THE CONDITION AND GRADE OF THE SOIL PRIOR TO SEEDING AND SHALL THEN BE REFERTILIZED, RESEEDED AND REMULCHED.

D. WINTER CONDITIONS

EXCAVATION AND EARTHWORK SHALL BE COMPLETED SUCH THAT NO MORE THAN I ACRE OF THE SITE IS
WITHOUT STABILIZATION AT ANY ONE TIME. UNIT THE EXPOSED AREA TO THOSE AREAS IN WHICH WORK, IS
EXPECTED TO BE UNDESTAKEN DURING THE PROCEDING IS DAYS AND THAT CAN BE MULCHED IN ONE DAY
PRIOR TO ANY SNOW EVENT. HAY AND STRAW MULCH RATE SHALL BE A MINIMUM OF I 50 LBS,/I,000 S.F. (3
TONS/ACRE) AND SHALL BE PROPERLY ANCHORED. THE CONTRACTOR SHALL INSTALL ANY ADDED MEASURES
WHICH MAY BE NECESSARY TO CONTROL EROSION/SEDIMENTATION FROM THE STIFL DEPENDED HON IT HON THE
ACTUAL SITE AND WEATHER CONDITIONS. CONTINUATION OF EARTHWORK OPERATIONS ON ADDITIONAL AREAS
SHALL NOT BEGIN LINIT LITHE PROPOSED SQUI SUBFRECON THE ABEA BRIDN WORKED HAS BEEN STABILIZED. IN SHALL NOT BEGIN UNTIL THE EXPOSED SOIL SURFACE ON THE AREA BEING WORKED HAS BEEN STABILIZED. IN ORDER TO MINIMIZE AREAS WITHOUT EROSION CONTROL PROTECTION

E. CONSTRUCTION SEQUENCE THE GENERAL SEQUENCE OF WORK SHALL BE AS FOLLOWS:

- INSTALL EROSION CONTROL DEVICES. (SILT FENCE, STABILIZED CONSTRUCTION ENTRANCE AND OR SEDIMENT
- DAKNIEK.)
  TEMPORABILY STABILIZE DISTURBED AREAS BY MULCHING ALL EXPOSED SOIL WITHIN 15 DAYS OF INITIAL DISTURBANCE.
  INSTALL STORMWATER SYSTEM;
  COMPLETE SITE CONSTRUCTION WORK;

MEASURES.

- CONSTRUCT PAVED ACCESS AND PARKING AREAS; INSTALL PERMANENT VEGETATION ON ALL EXPOSED AREAS WITHIN 15 DAYS OF FINAL GRADING; AND PERFORM CONTINUING MAINTENANCE ON ALL EROSION AND SEDIMENTATION CONTROL DEVICES AND

F. SITE INSPECTION 

\* MAINTENANCE
WEEKLY INSPECTIONS, AS WELL AS ROUTINE INSPECTIONS FOLLOWING RAINFALLS OF 0.5' OVER A CONSECUTIVE
24-HOUR PERIOD, SHALL BE CONDUCTED BY THE SITE CONTRACTOR OF ALL TEMPORARY AND PERMANENT
EROSION CONTROL DEVICES UNTIL FINAL ACCEPTANCE OF THE PROJECT. NECESSARY REPAIRS SHALL BE MADE TO
CORRECT UNDERMINING OR DETERIORATION. FINAL ACCEPTANCE SHALL INCLIDE A SITE INSPECTION TO VERIFY
THE STABILITY OF ALL DISTURBED AREAS AND SLOPES, UNTIL FINAL INSPECTION, ALL EROSION AND
SEDIMENTATION CONTROL MEASURES SHALL INMEDIATELY BE CLEANED, AND REPAIRED BY THE SITE
CONTRACTOR AFTER SCORE MEXISTS. DESCRIPCED AND THE PROPISAL OF ALL TEMPORARY PROGRAM CANTED OF THE SITE

CONTRACTOR AFTER SCORE MEXISTS. DESCRIPCION OF THE PROGRAM CANTED OF THE SITE


CONTRACTOR AFTER SCORE MEXISTS. DESCRIPCION OF THE PROGRAM CANTED OF THE SITE


CONTRACTOR AFTER SCORE MEXISTS. DESCRIPCEMENT OF THE SITE

CONTRACTOR AFTER SCORE MEXISTS. DESCRIPCION OF THE STATE


THE STABLES OF THE STATE OF THE CONTRACTOR AFTER STORM EVENTS, DISPOSAL OF ALL TEMPORARY EROSION CONTROL DEVICES SHALL BE THE RESPONSIBILITY OF THE SITE CONTRACTOR.


CONTINUED TEMPORARY MAINTENANCE AND LONG TERM PROVISIONS FOR PERMANENT MAINTENANCE OF AL EROSION AND SEDIMENTATION CONTROL PACIFITES AFTER ACCEPTANCE OF THE PROJECT SHALL BE THE RESPONSIBILITY OF THE SCHLOTTERBECK BLOCK LLC.

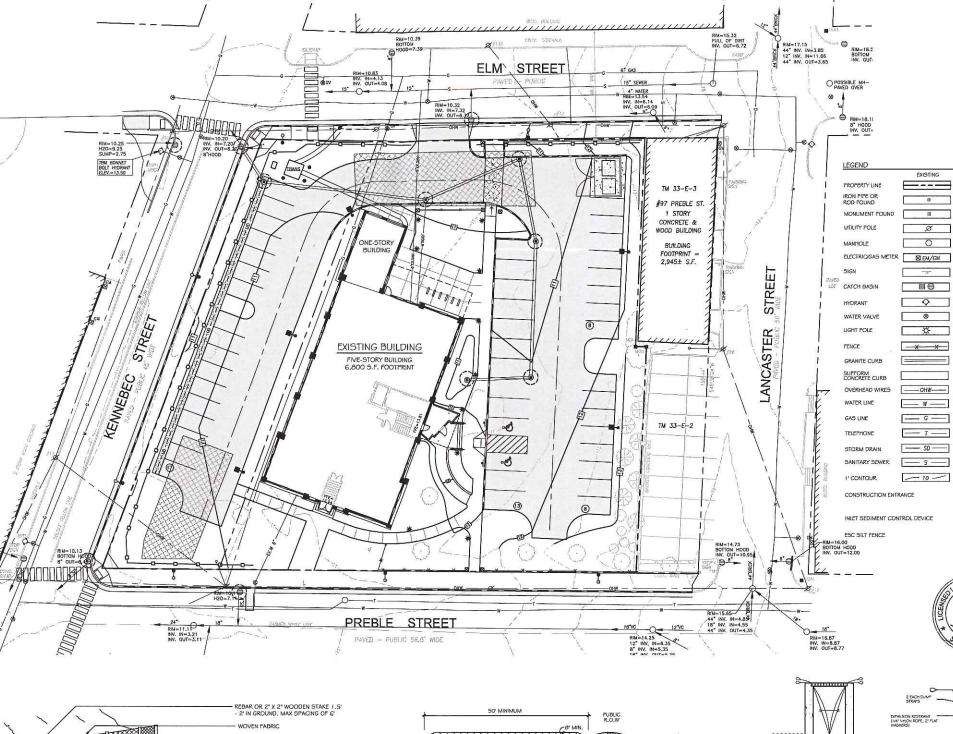


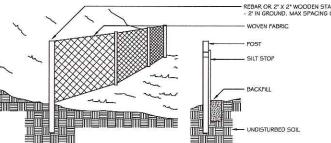

- 1. SILT FENCE TO BE INSTALLED PARALLEL TO EXISTING CONTOURS DOWNSLOPE FROM AREAS OF SOIL DISTURBANCE.
- SILT FENCE TO BE SECURELY ATTACHED TO THE UPSLOPE SIDE OF THE SUPPORTING STAKES.
- BOTTOM 4 TO 6 INCHES OF SILT FENCE TO BE BURIED IN SLOPE AND BACKFILLED WITH COMPACTED SOIL,
- . INSPECTION SHALL BE MADE AFTER EVERY RAINFALL WITH REMOVAL OF EXCESSIVE SEDIMENT AND REPAIR OF THE FENCE ACCOMPLISHED PROMPTLY.
- 5. SILT FENCE AND ACCUMULATED SEDIMENT SHALL BE REMOVED AS SOON AS PERMANENT EROSION CONTROL MEASURES HAVE BEEN SOON AS PERM ESTABLISHED.

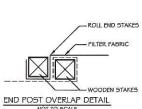

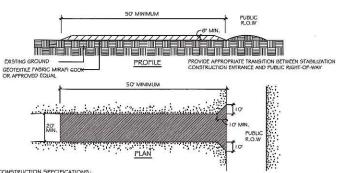

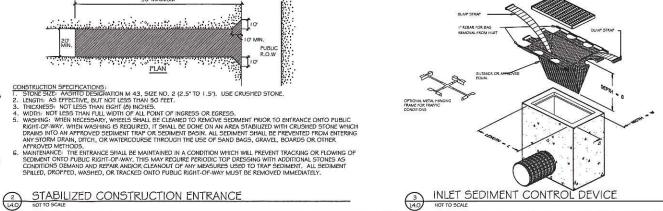

INSTALLATION DETAIL

O chlotterb  $\operatorname{Ih}$ OCTOBER 5, 2015 Revisions:

DEC. 1, 2015: REVISED PER STAFF REVIEW COMMENTS

action or reuse of this document

without the expressed written consent of Mitchell & Associates is prohibited.

© 2015

EROSION AND SEDIMENT CONTROL PLAN

Date:

S

Preble

Prepared For: Owner and Applicant:

Tel.: 207-650-8975

Portland, Maine 04101 Tel.: 207-774-4427

400 Commercial Street # 4 Portland, Maine 04101 Phone: 207-772-2891

Portland, Maine 04101 Phone: 207-775-3184

PROPOSEI

7

•

\* --

11.60

(0)

-0--0--0

JOHN D.

MITCHELL No. 15

BAG DETAIL

\_\_\_

a

12

Ø

0

SCHLOTTERBECK BLOCK L.L.C. Spruce Street

MITCHELL & ASSOCIATES

RANSOM CONSULTING ENGINEERS

GODUTI-THOMAS ARCHITECTS 44 Oak Street # 2

ठ

Ŏ


M

ਠੱ

Mai

Sheet No.

SILT FENCE SILT FE

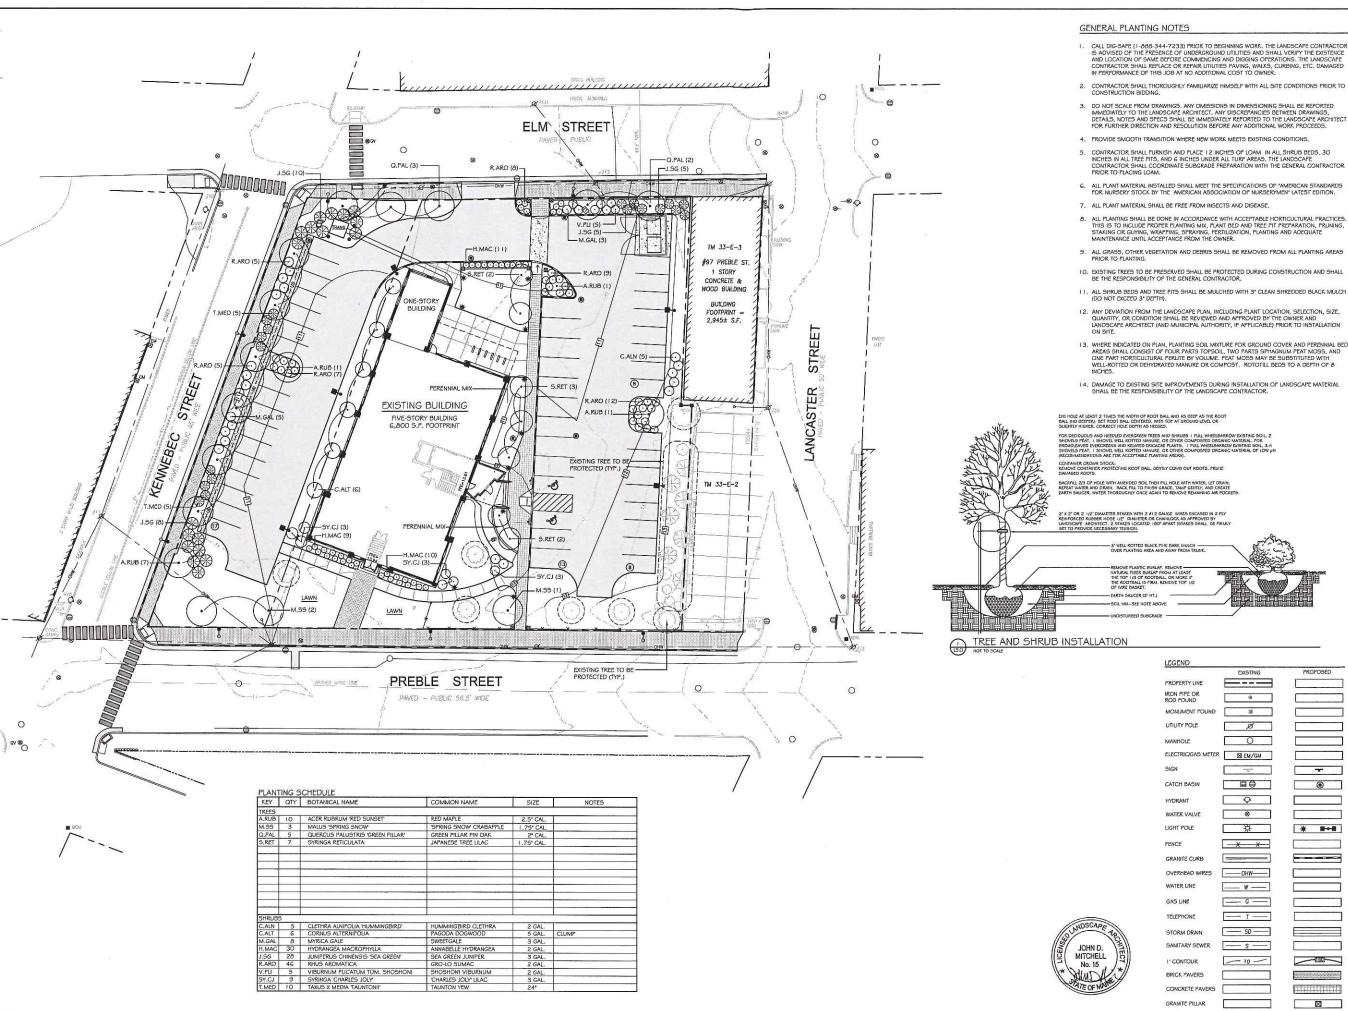

1. CALL DIG-SAFE (1-888-344-7233) PRIOR TO BEGINNING WORK, THE LANDSCAPE CONTRACTOR SED OF THE PRESENCE OF UNDERGROUND UTILITIES AND SHALL VERIFY THE EXISTENCE 19 AUVISED OF THE PRESENCE OF ORDERORAUMU UTILITIES AND STRAIL VERIFIT THE AUSTRICE.

AND LOCATION OF SAME BEFORE COMMENCING AND DISGING OPERATIONS. THE UNDSCAPE
CONTRACTOR SHALL REFLACE OR REFAIR UTILITIES PAVING, WALVS, CURBING, ETC. DAMAGED
IN PERFORMANCE OF THIS JOB AT NO ADDITIONAL COST TO OWNER.

- 3. DO NOT SCALE FROM DRAWINGS. ANY OMISSIONS IN DIMENSIONING SHALL BE REPORTED IMMEDIATELY TO THE LANDSCAPE ARCHITECT. ANY DISCREPANCIES BETWEEN DRAWINGS, DETAILS, NOTES AND SPECS SHALL BE MANEDIATELY REPORTED TO THE LANDSCAPE ARCHITECT FOR FURTHER DIRECTION AND RESOLUTION BEFORE ANY ADDITIONAL WORK PROCEEDS.
- 4. PROVIDE SMOOTH TRANSITION WHERE NEW WORK MEETS EXISTING CONDITIONS
- 5. CONTRACTOR SHALL FURNISH AND PLACE 12 INCHES OF LOAM. IN ALL SHRUB BEDS, 30 INCHES IN ALL TREE PITS, AND 6 INCHES UNDER ALL TURP AREAS. THE LANDSCAPE CONTRACTOR SHALL CONDINATE SUBGRADE FREPARATION WITH THE GENERAL CONTRACTOR.
- G. ALL PLANT MATERIAL INSTALLED SHALL MEET THE SPECIFICATIONS OF "AMERICAN STANDARDS FOR NURSERY STOCK BY THE AMERICAN ASSOCIATION OF NURSERYMEN" LATEST EDITION.
- 8. ALL PLANTING SHALL BE DONE IN ACCORDANCE WITH ACCEPTABLE HORTICULTURAL FRACTICES. THIS 15 TO INCLUDE PROPER PLANTING MIX, PLANT BED AND TREE PIT PREPARATION, PRUNING, STAKING OR GUYING, WRAPPING, SPRANTING, FERTILIZATION, PLANTING AND ADEQUATE MAINTENANCE UNTIL ACCEPTANCE FROM THE OWNER.
- ALL GRASS, OTHER VEGETATION AND DEBRIS SHALL BE REMOVED FROM ALL PLANTING AREAS PRIOR TO PLANTING.
- 10. EXISTING TREES TO BE PRESERVED SHALL BE PROTECTED DURING CONSTRUCTION AND SHALL BE THE RESPONSIBILITY OF THE GENERAL CONTRACTOR.
- ALL SHRUB BEDS AND TREE PITS SHALL BE MULCHED WITH 3" CLEAN SHREDDED BLACK MULCH (DO NOT EXCEED 3" DEPTH).
- ANY DEVIATION FROM THE LANDSCAPE PLAN, INCLUDING PLANT LOCATION, SELECTION, SIZE, QUANTITY, OR CONDITION SHALL BE REVIEWED AND APPROVED BY THE OWNER AND LANDSCAPE ARCHITECT (AND MUNICIPAL AUTHORITY, IF APPLICABLE) PRIOR TO INSTALLATION ON SITE.
- 13. WHERE INDICATED ON PLAN, PLANTING SOIL MIXTURE FOR GROUND COVER AND PERENNIAL BED AREAS SHALL, CONSIST OF FOUR PARTS TOPSOIL, TWO PARTS SHYLAGMUM PEAT MOSS, AND ONE FART HORTICULTURAL PERLIE BY VOLUME. FEAT MOSS MAY BE SUBSTITUTED WITH WELL-ROTTED OR DEHYDRATED MANURE OR COMPOST. ROTOTILL BEDS TO A DEPTH OF 8 NCHES.
- 14. DAMAGE TO EXISTING SITE IMPROVEMENTS DURING INSTALLATION OF LANDSCAPE MATERIAL SHALL BE THE RESPONSIBILITY OF THE LANDSCAPE CONTRACTOR.

FOR DECIDIOUS AND HERDLED EVERGREEN TREES AND SHRUBS I FULL WHEELBARROW ENSTING SOLL, 2 SHOWLS SHAT, I SHOWL WILL ROTTED MAKE, OR CITICE COMPOSITE ORGANIC MATERIAL FOR SHOURLEAST DEVERTIES AND RESTAUR DEFINED SOLD, SALD SHORE ENGINE WAS SHOURLEAST DEVERTIES AND RESTAUR DEFINED SOLL, 3-4 SHOWLS FLAT, I SHOWLE WILL KOTTED MANUE, OR CITICE COMPOSITED ORGANIC MATERIAL OF LOW pH (RECOMMUNICATION) ARE TOR ACCEPTUAL THATING AREA OF LOW.

FXISTING PROPOSED \_\_\_\_ MONUMENT FOUND 19 Ø 0 ELECTRIC/GAS METER ⊠ EM/GM • Q . 8 \*\* ★ ⊪→欄 \_\_<del>X</del>\_\_\_\_ \_\_\_\_ GRANITE CURB ——ОНW----OVERHEAD WIRES \_\_\_ w \_\_\_ \_\_\_ G \_\_\_ \_\_\_\_ SD \_\_\_\_ — s — 1150 \_\_ 10 \_\_ BRICK PAVERS CONCRETE PAVERS 

Prepared For: Owner and Applicant: SCHLOTTERBECK BLOCK L.L.C.

Prepared By

MITCHELL & ASSOCIATES Landscape Architects 70 Center Street Portland, Maine 04101 Tel.: 207-774-4427

RANSOM CONSULTING ENGINEERS 400 Commercial Street #4 Portland, Maine 04101 Phone: 207-772-2891

GODUTI-THOMAS ARCHITECTS 44 Oak Street # 2 Portland, Maine 04101 Phone: 207-775-3184

Mai lock Portland, M

S

chlotterb S 0 Prebl ب

Str

<u>o</u>


Date OCTOBER 5, 2015


Issued For:


DEC. 1, 2015: REVISED PER STAFF

Reproduction or reuse of this document without the expressed written consent of Mitchell & Associates is prohibited. © 2015

PLANTING PLAN

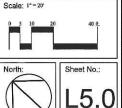

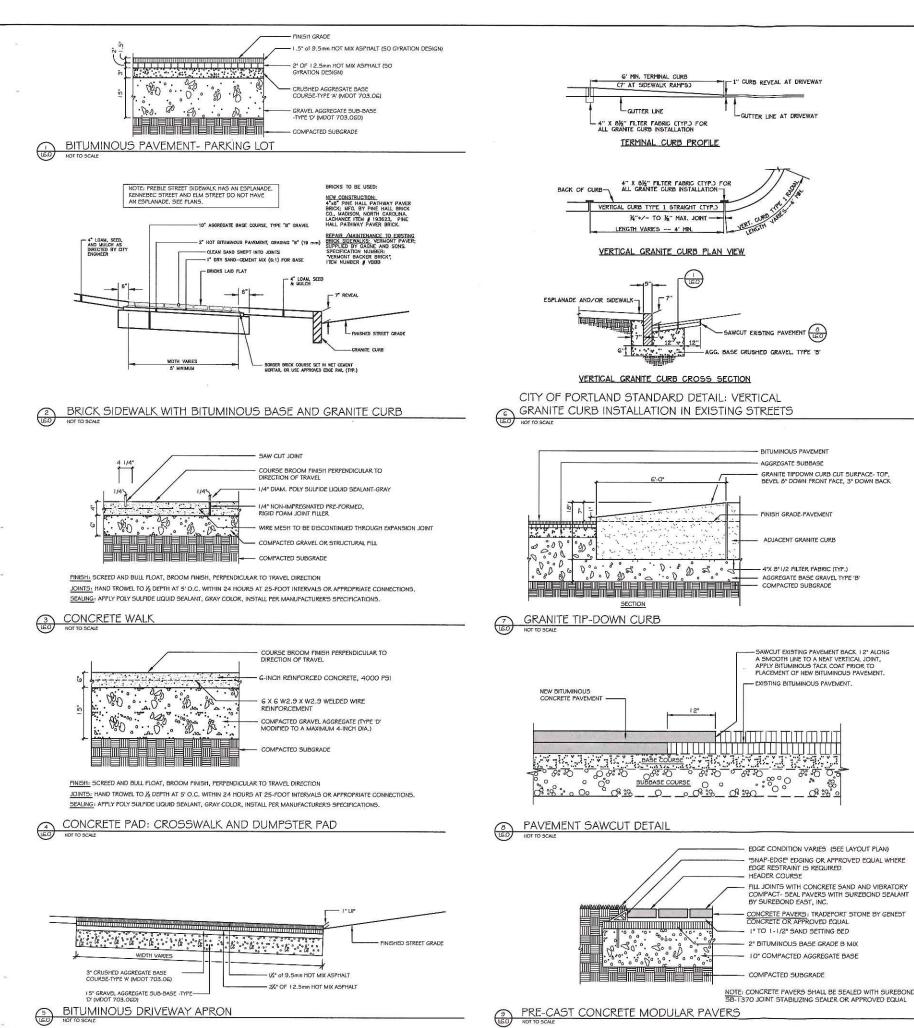

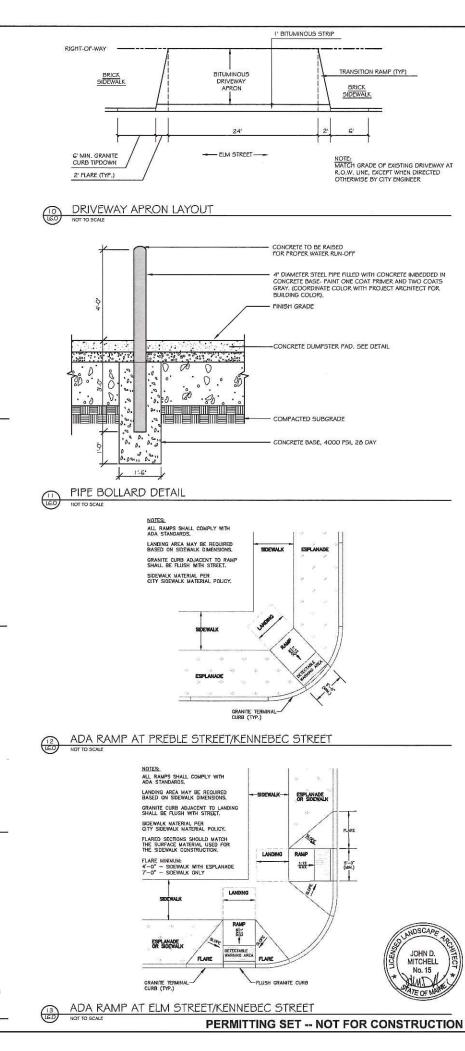

Prepared For: Owner and Applicant: SCHLOTTERBECK BLOCK L.L.C.

Prepared By: MITCHELL & ASSOCIATES

RANSOM CONSULTING ENGINEERS 400 Commercial Street # 4 Portland, Maine 04101 Phone: 207-772-2891

GODUTI-THOMAS ARCHITECTS

Maine

Portland,

Street

Preble

117

77 Spruce Street Portland, Maine 04101 Tel.: 207-650-8979

Portland, Maine 04101 Phone: 207-775-3184

Block

eck

chlotterb

0

The

Issued For:

DEC. 1, 2015: REVISED PER STAFF


Reproduction or rouse of this document without the expressed written consent of Mitchell & Associates is prohibited.

© 2015

SITE DETAILS

Scale: AS SHOWN

REVIEW COMMENT

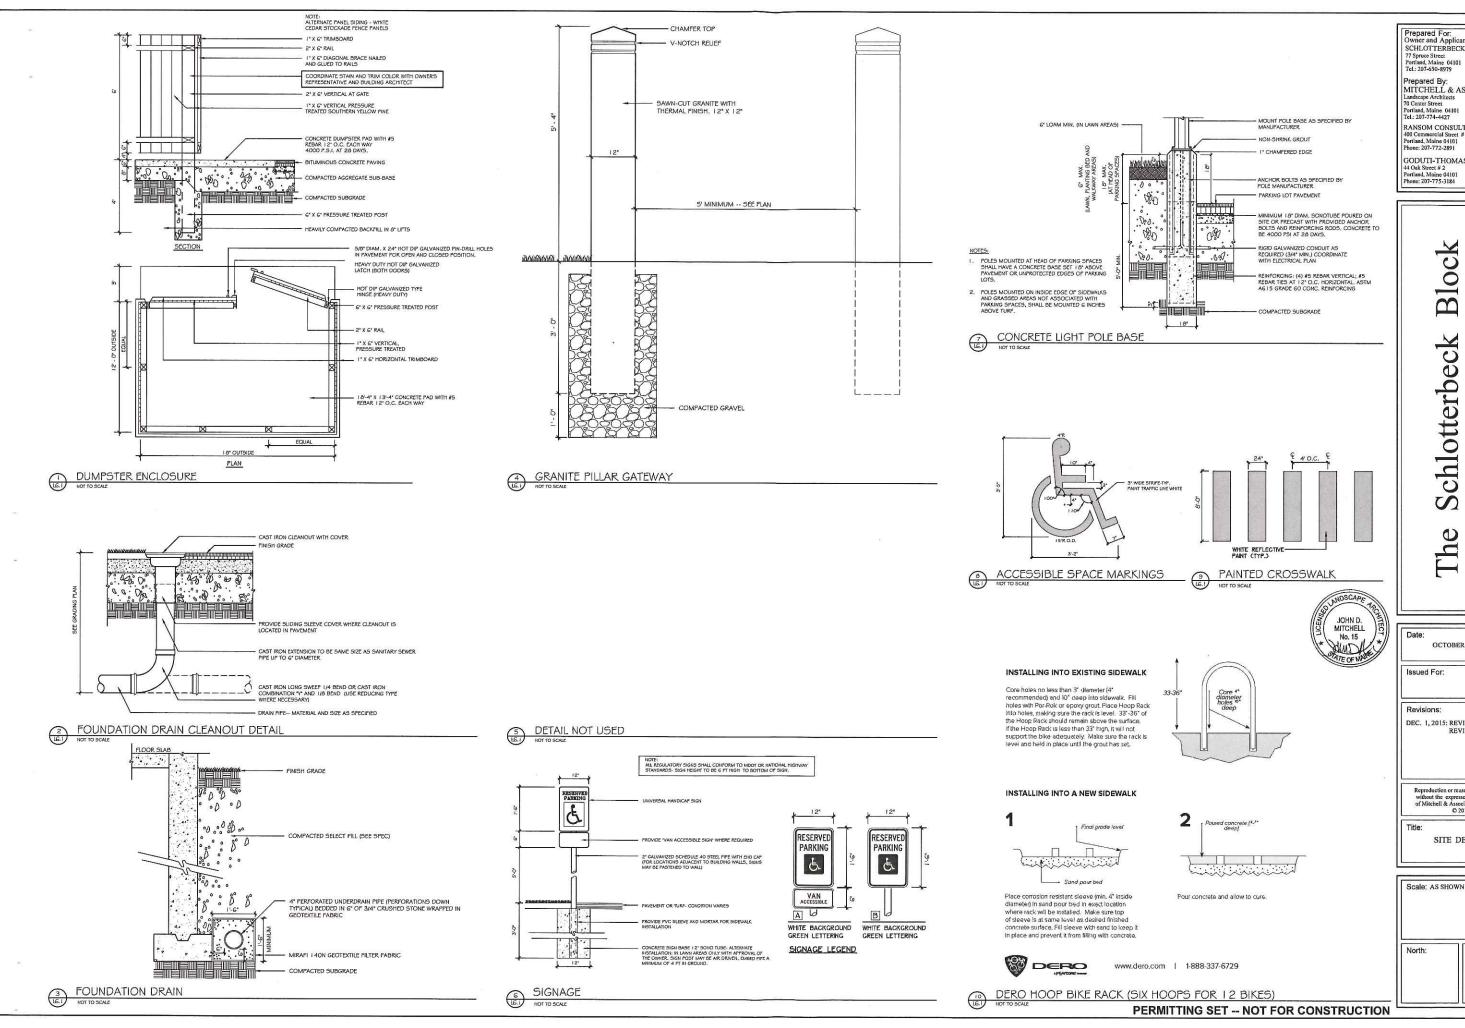

Prepared For: Owner and Applicant: SCHLOTTERBECK BLOCK L.L.C.
77 Spruce Street
Portland, Maine 04101
Tel.: 207-650-8979

Prepared By: MITCHELL & ASSOCIATES Landscape Architects

RANSOM CONSULTING ENGINEERS 400 Commercial Street # 4 Portland, Maine 04101 Phone: 207-772-2891

GODUTI-THOMAS ARCHITECTS 44 Oak Street # 2 Portland, Maine 04101 Phone: 207-775-3184

Maine Block

Portland,

S Ō chlotterb

Street Preble 117


OCTOBER 5, 2015


DEC. 1, 2015: REVISED PER STAFF REVIEW COMMENTS


Reproduction or reuse of this document without the expressed written consent of Mitchell & Associates is prohibited.
© 2015

SITE DETAILS


Sheet No.: \_6.1

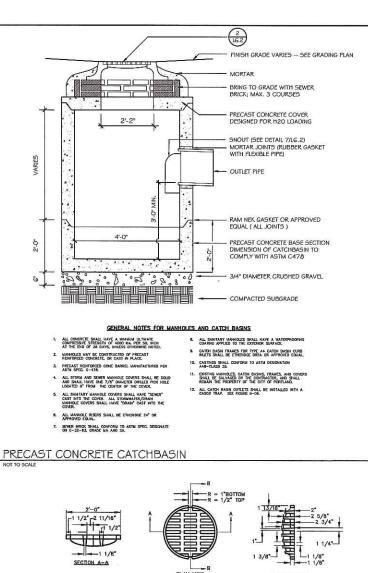

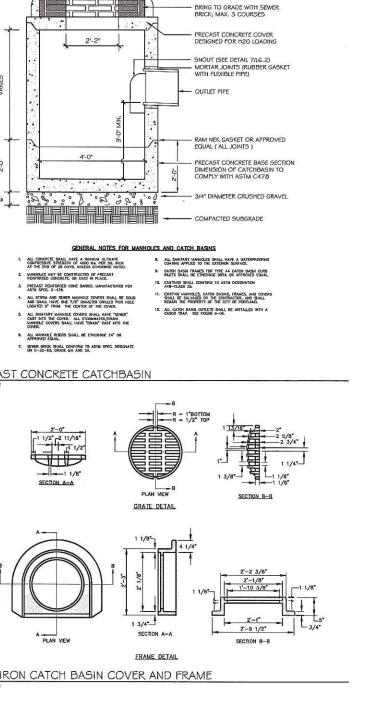


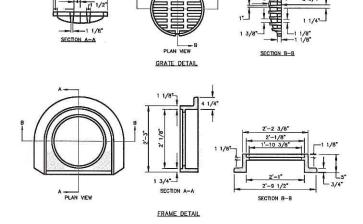

CAST IRON CATCH BASIN COVER AND FRAME

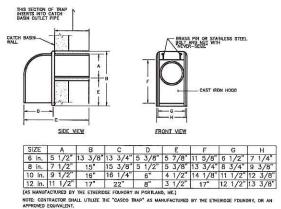

CASCO TRAP (ALL CATCHBASIN DRAINAGE STRUCTURES)

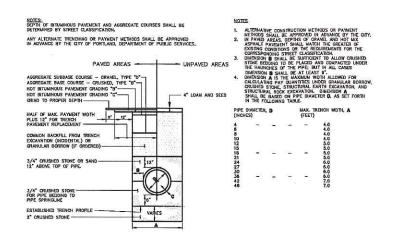


TYPICAL PIPE TRENCH INSTALLATION


TYPICAL PIPE INSTALLATION - NOTES

CITY OF PORTLAND TRENCH DETAIL

HOUSE CONNECTIONS AND CATCH BASINS CONNECTIONS TO THE MAIN LINE OF THE SEWER, SHALL CONSIST OF AN APPROPRIATE "Y BRANCH CONNECTION AS SHOWN ON THE PLANS, OR AS DIRECTED, ACTUAL." Y LOCATIONS FOR HOUSE CONNECTIONS AND CATCH BASIN CONNECTIONS SHALL BE OF ETERNINED DURING CONSTRUCTION. THE CONTRACTOR SHALL KEEP A COMPLETE RECORD OF "Y" LOCATIONS WHICH SHALL BE GIVEN TO THE CITY OF PORTLAND LIPON COMPLETION OF THE CONTRACT. ALL PVC TO PVC COUPLING SHALL BE "SOLID PVC COUPLINGS".

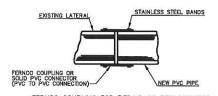


FERNCO COUPLING FOR REPAIR OR REPLACEMENT

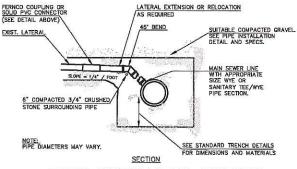


TYPICAL EXISTING LATERAL CONNECTION
NOT TO SCALE


CITY OF PORTLAND LATERAL CONNECTION DETAIL

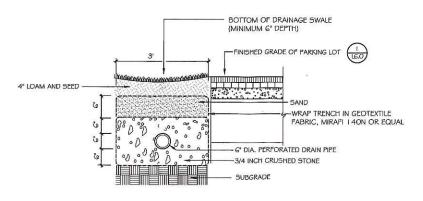



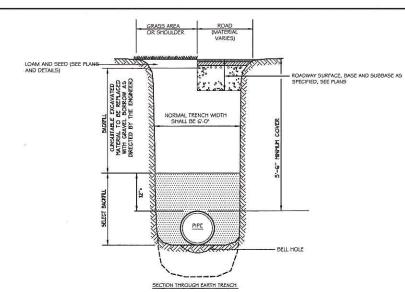

PORTLAND WATER DISTRICT PIPE TRENCH DETAIL

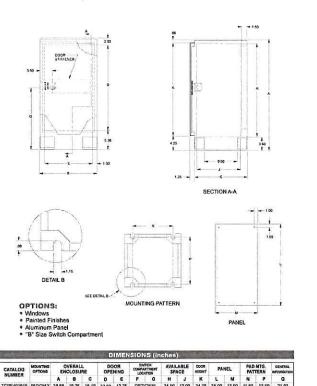

CITY OF PORTLAND STREET LIGHT PEDESTAL (TCPE40 | 6 | 5)

Block eck chlotterb S The

Prepared For: Owner and Applicant: SCHLOTTERBECK BLOCK L.L.C.

Prepared By: MITCHELL & ASSOCIATES

RANSOM CONSULTING ENGINEERS 400 Commercial Street # 4 Portland, Maine 04101 Phone: 207-772-2891

GODUTI-THOMAS ARCHITECTS

Maine

Portland,

Street

Preble

117

77 Spruce Street Portland, Maine 04101 Tel.: 207-650-8979

44 Oak Street # 2 Portland, Maine 04101 Phone: 207-775-3184

Date:

Issued For

Revisions:


DEC. 1, 2015: REVISED PER STAFF REVIEW COMMENT

duction or reuse of this documen without the expressed written consent of Mitchell & Associates is prohibited. © 2015

SITE DETAILS

STEPHEN #5740 Scale: AS SHOWN

PERMITTING SET -- NOT FOR CONSTRUCTION

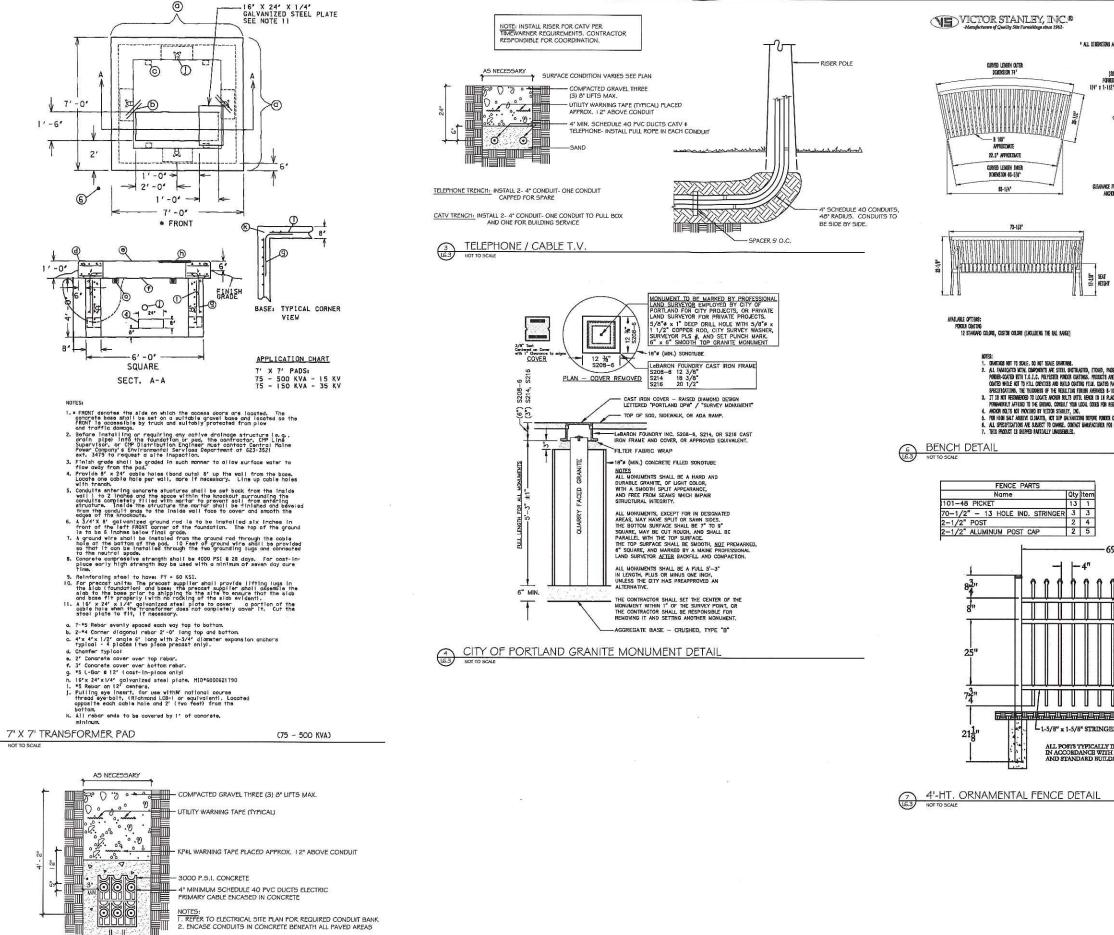

P.O. DRAMER 330 - DUNCTRY, NO. 20754 USA TOLL FREE; (800) 368-2573 (USA & CANACA) TEL (301) 855-8900 - FAX (410) 257-7579 \* ALL DINENSIONS ARE IN INCHES (28) STEEL SLATS ARE -FORMED FROM SECTIONS OF 1/4" x 1-1/2" SOLID STEEL BASS FORMED FROM 1" SQUARE SOLID STEEL BAR CLEARANCE FOR 1/2" -INTEGRAL WELDED CHOSS-MEMBERS Of 1-7/8" Tubulah Steel ANCHOR FOLTS STANDARD &" LENGTH SHORE SPECIFICATION, THE TRIGORES OF THE REALITHE FILIAM AMPAIRS 1-10 BILL 200-250 RECOME).

A TH S HAT EXEMPLES TO LOCK AROUND BUTS WITH 1800 HE IS HAVE. THIS VICIOUS STALET, DIC., PRODUCT MUST BE PROMERRY AFFIRE TO THE GROUN. CORRECT THAT LOCK CORES FOR REGILATIONS.

B. THE HIM SAIT ARRIVE OLIVERS, OFF OF DEVIALED REFER FORMER CORTED BY ANNUALE. SEE BRITTEN SPECIFICATIONS FOR DEVAILS.

ALL STREITCHAINS OF SAIRCY TO COMES, CONTACT WASHERING.

THIS PRODUCT IS BUTTEN PARTICLEY MANSSELED. (3) L1-5/8" x 1-5/8" STRINGER L1" SQUARE PICKET ALL POSTS TYPICALLY INSTALLED IN CONCRETE IN ACCORDANCE WITH LOCAL CONDITIONS AND STANDARD BUILDING PRACTICES

> JOHN D. MITCHELL No. 15

Prepared For: Owner and Applicant: SCHLOTTERBECK BLOCK L.L.C. Tcl.: 207-650-8979

MITCHELL & ASSOCIATES 70 Center Stree

Portland, Maine 04101 Tel.: 207-774-4427 RANSOM CONSULTING ENGINEER 400 Commercial Street # 4 Portland, Maine 04101 Phone: 207-772-2891

GODUTI-THOMAS ARCHITECTS
44 Oak Street # 2 Portland, Maine 04101 Phone: 207-775-3184

Maine S

Portland, Ŏ BI

S 0

> Street Preble 117

Date: OCTOBER 5, 2015

chlotterb

S

0

Th

Issued For

Revisions:

DEC. 1, 2015: REVISED PER STAFF REVIEW COMMENT

Reproduction or reuse of this document without the expressed written consent of Mitchell & Associates is prohibited.

© 2015

SITE DETAILS

Scale: AS SHOWN

Sheet No.: \_6.3

5 DETAIL NOT USED

NOT TO SCALE

1.5" SPACER

ELECTRIC TRENCH

16-3 NOT TO SCALE

PERMITTING SET -- NOT FOR CONSTRUCTION

Calculation Summary Label	Avq	Max	Min	Avg/Min	Max/Min	PtSpcLr	PtSpcTb
BACK PARKING	0.90	1.9	0.4	2.25	4.75	10	10
ENTRY DRIVE	1.43	3.1	0.4	3.58	7.75	10	10
FRONT PARKING	0.98	2.6	0.3	3.27	8.67	10	10
FULL SITE	0.62	3.6	0.0	N.A.	N.A.	10	10

Type	Symbol	Qty	Lum. Lumens	LLF	Lum. Watts	Description
A4N	0	1	3912	0.900	63.4	RA174E35-60L3K-NFO
A3N	0	5	3248	0.900	63.2	RA173E35-60L3K-NFO
С	0	7	6220	0.900	109	ESL 110 4K AS X 7 DS
D	0	2	4812	0.900	65.1	PGL71WE35-60L3K
F		2	1058	0.900	19.5	SW1-18LED-3500K
BL	•	10	1125	0.800	95	BOL FP45 13 L-CI XX-M50 00-1

NOTES:
1) EXACT MOUNTING DETAILS TO BE DETERMINED AT JOBSITE BY OTHERS.

2) CALCULATIONS MAY SHOW THE EFFECT OF SHADOWING CAUSED BY BUILDINGS AND

OBJECTS WITHIN THE CALCULATED SPACE OR IN THE SITE AREA.

3) READINGS SHOWN ARE INITIAL HORIZONTAL FOOTCANDLES ON A FLAT SITE UNLESS OTHERWISE INDIGATED.

4) THIS CALCULATION IS BASED ON LIMITED INFORMATION SUPPLIED BY OTHERS TO

THE SCHLOTTERBECK BLOCK 117 PREBLE STREET, PORTLAND MAINE SITE LIGHTING LAYOUT

WANEY LIGHTIN


SWANEY LIGHTING ASSOCIATES AND STANDARD ASSUMPTIONS OF THE SPACE AND/OR SITE.

5) CONFORMANCE TO CODES AND OTHER LOCAL REQUIREMENTS AS DETERMINED BY THE AHJ
ARE THE RESPONSIBILITY OF THE OWNER AND/OR THE OWNER'S REPRESENTATIVE.

6) THIS LAYOUT DRAWING MUST BE COORDINATED WITH THE SITE LOCATION FOR

CORRECT FIXTURE ORIENTATION.

OCHECH FIXE CHEET CONTROL OF THE PRINTED OR PLOTTED FROM ELECTRONIC FILES MAY OCCUR AT OTHER THAN THE DESIRED OR ASSUMED GRAPHIC SCALES. IT IS THE RESPONSIBILITY OF THE RECIPIENT TO VERIFY THAT THE PRINTED OR PLOTTED-TO-SCALE DRAWING IS PRINTED TO SCALE.

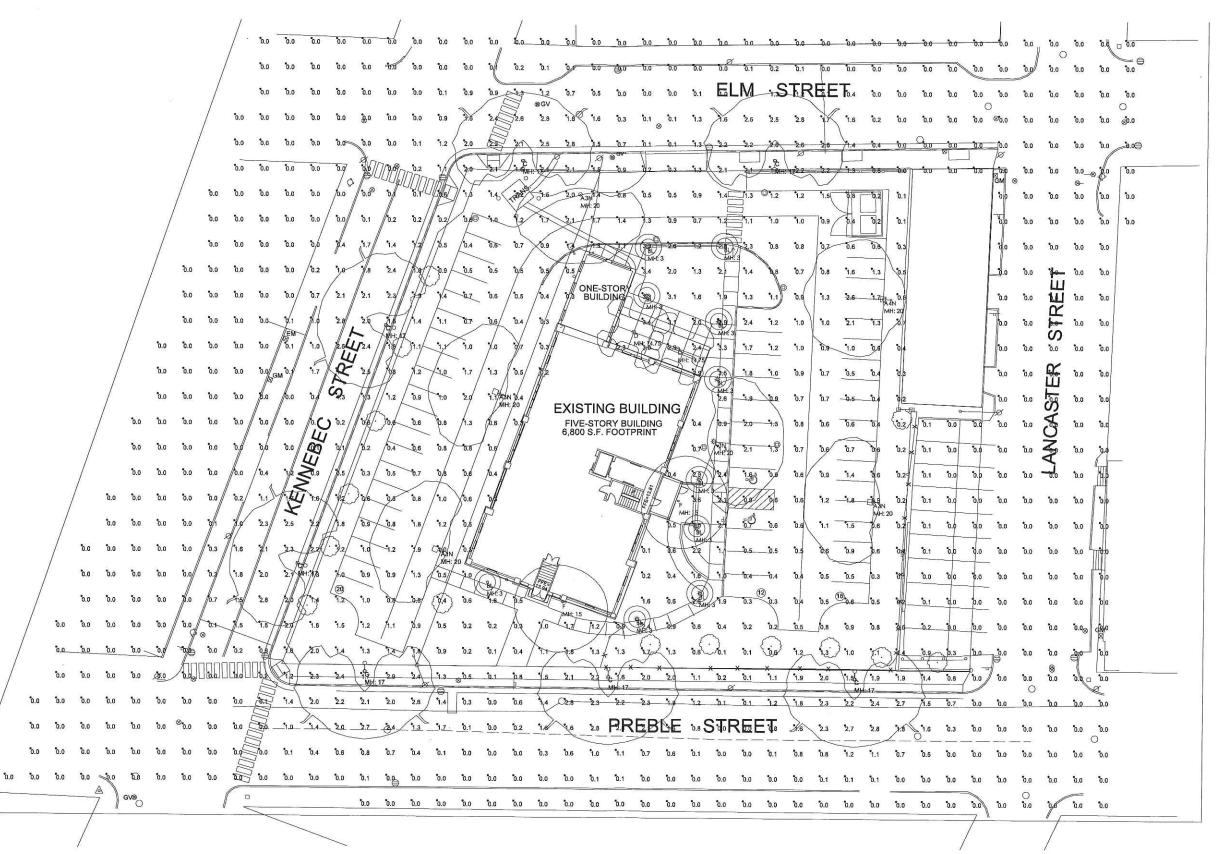

Calculation Summary							
Label	Avg	Max	Min	Avg/Min	Max/Min	PtSpcLr	PtSpcT
BACK PARKING	0.73	1.9	0.3	2.43	6.33	10	10
ENTRY DRIVE	1.25	3.1	0.3	4.17	10.33	10	10
FRONT PARKING	0.93	2.6	0.3	3.10	8.67	10	10
FULL SITE	0.26	3.6	0.0	N.A.	N.A.	10	10

Type	Symbol	Qty	Lum. Lumens	LLF	Lum. Watts	Description
A4N	0	1	3912	0.900	63.4	RA174E35-60L3K-NFO
A3N	0	5	3248	0.900	63.2	RA173E35-60L3K-NFO
С	0	7	6220	0.900	109	ESL 110 4K AS X 7 DS
D	0	2	4812	0.900	65.1	PGL71WE35-60L3K
F		2	1058	0.900	19.5	SW1-18LED-3500K
BL	•	10	1125	0.800	95	BOL FP45 13 L-CI XX-M50 00-

NOTES: 1) EXACT MOUNTING DETAILS TO BE DETERMINED AT JOBSITE BY OTHERS. 2) CALCULATIONS MAY SHOW THE EFFECT OF SHADOWING CAUSED BY BUILDINGS AND

OBJECTS WITHIN THE CALCULATED SPACE OR IN THE SITE AREA.


3) READINGS SHOWN ARE INITIAL HORIZONTAL FOOTCANDLES ON A FLAT SITE UNLESS OTHERWISE INDICATED.
4) THIS CALCULATION IS BASED ON LIMITED INFORMATION SUPPLIED BY OTHERS TO

4) THIS CALCULATION IS BASED ON LIMITED INFORMATION SUPPLIED BY OTHER AND ASSUMPTIONS OF THE SPACE AND/OR SITE, 5) CONFORMANCE TO CODES AND OTHER LOCAL REQUIREMENTS AS DETERMINED BY THE AHJ ARE THE RESPONSIBILITY OF THE OWNER AND/OR THE OWNER'S REPRESENTATIVE, 6) THIS LAYOUT DRAWING MUST BE COORDINATED WITH THE SITE LOCATION FOR


CORRECT FIXTURE ORIENTATION.

7) CHECK GRAPHIC SCALE. DOCUMENTS PRINTED OR PLOTTED FROM ELECTRONIC

# STREET LIGHTING TURNED OFF

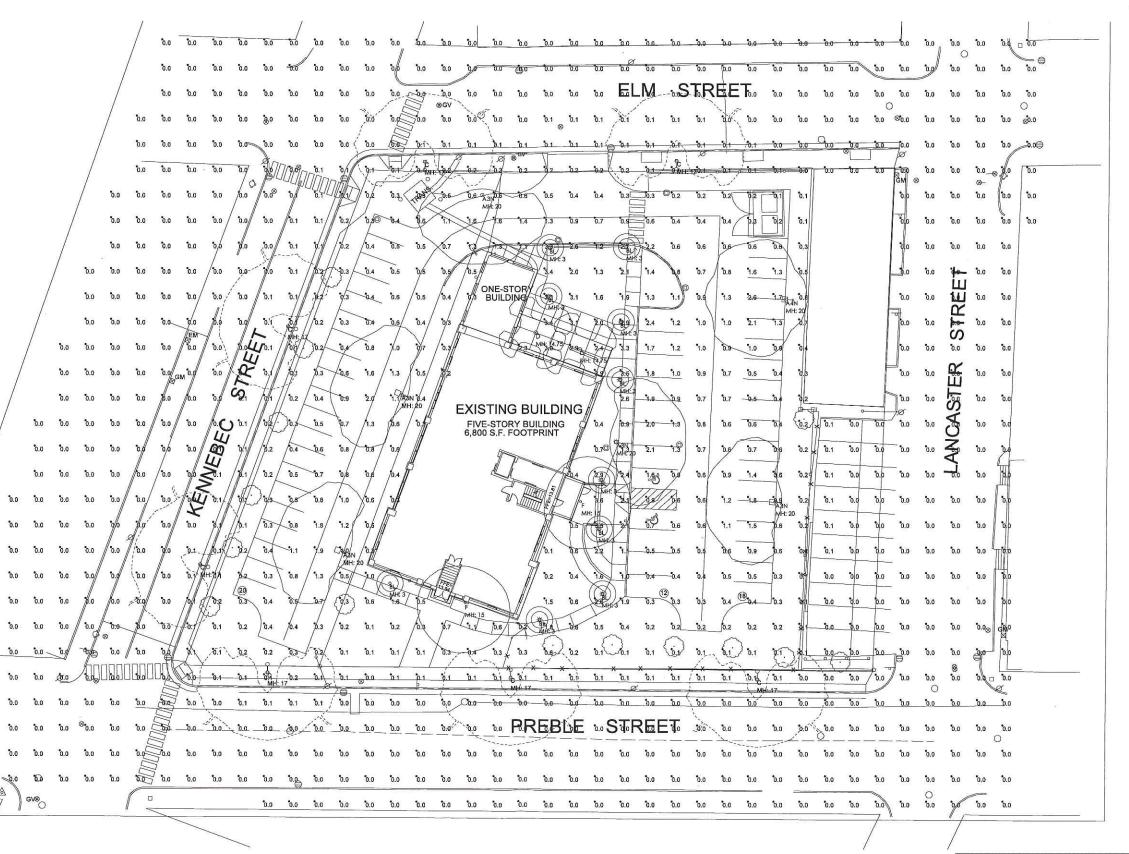



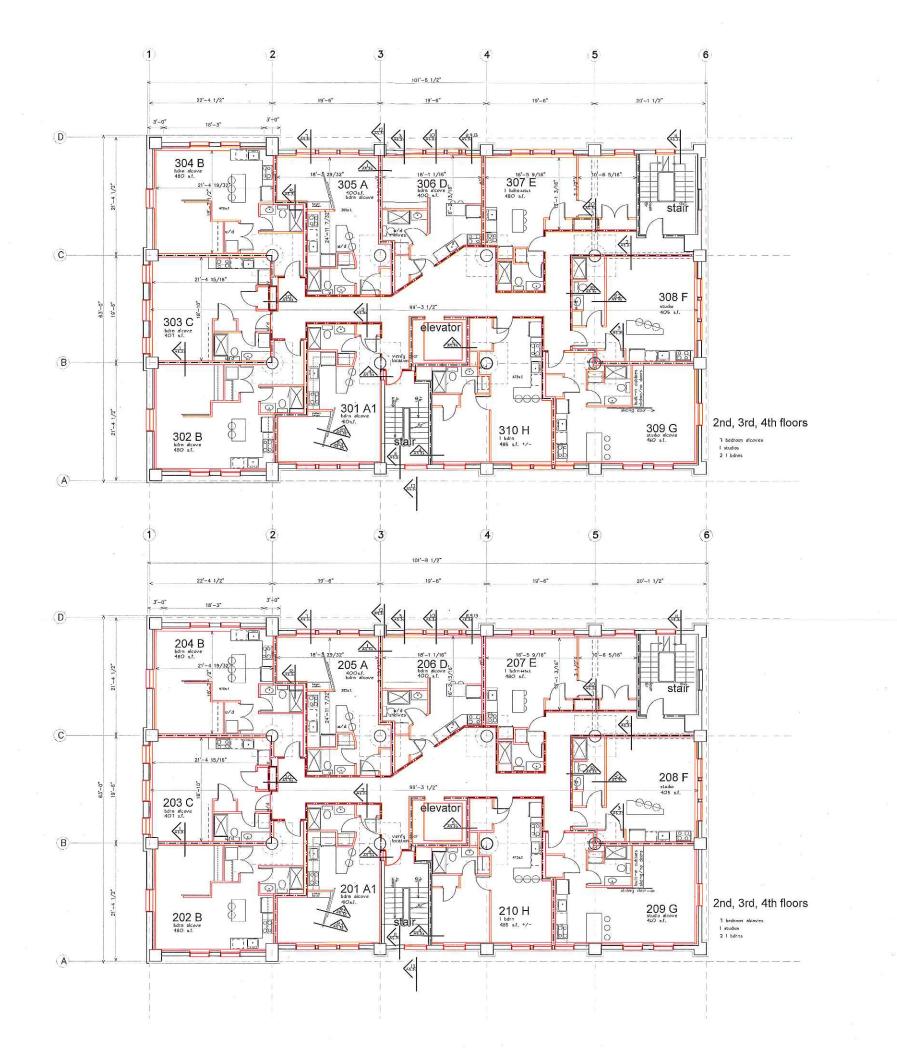

# Schlotterbeck Block

117 Preble Street Portland, Maine

# Schlotterbeck Block LLC

goduti/thomas architects

44 oak st.

portland, maine 04101

ph. 207-775-3184

fax 207-774-0846

revisions

date

sheet title

# 5th floor plan 2nd, 3rd, 4th floor plans

O' I' 4' 8' 16

scale 1/8"=1'-C

drawn by

project number
brewer
sheet number

111



# Schlotterbeck Block

117 Preble Street Portland, Maine

	rbeck		

44 oak	st.	
nortland	, maine 041	01
por trana	, maine 041	UI

fax 207-774-0846

revisions	
date	


# 5th floor plan 2nd, 3rd, 4th floor plans

sheet title


71.11 41	01	177
1 4	8	16
scale 1/8"=1'-0"		
drawn by		
MS		



sheet number

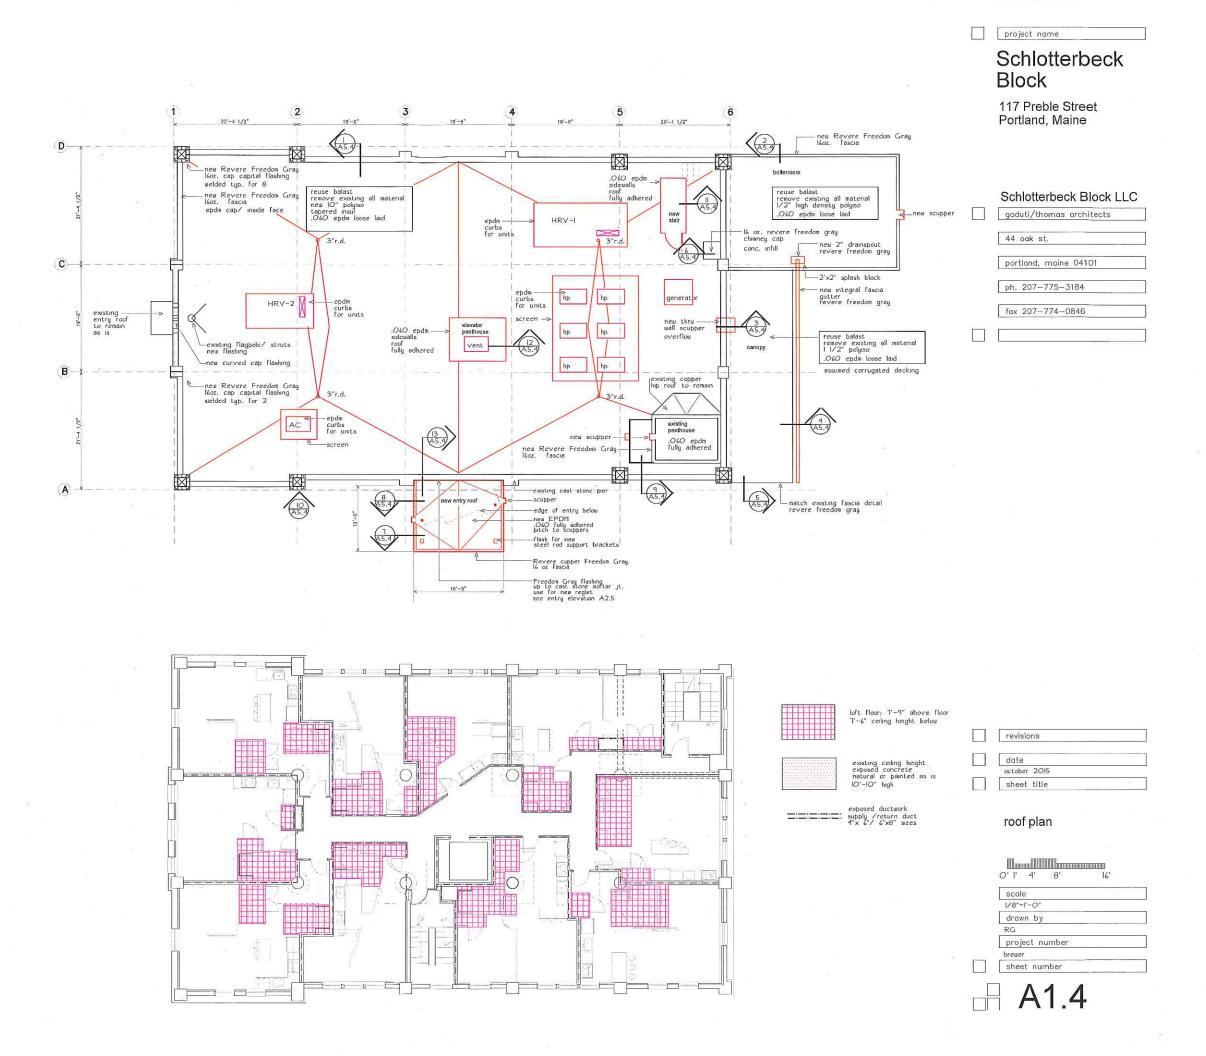



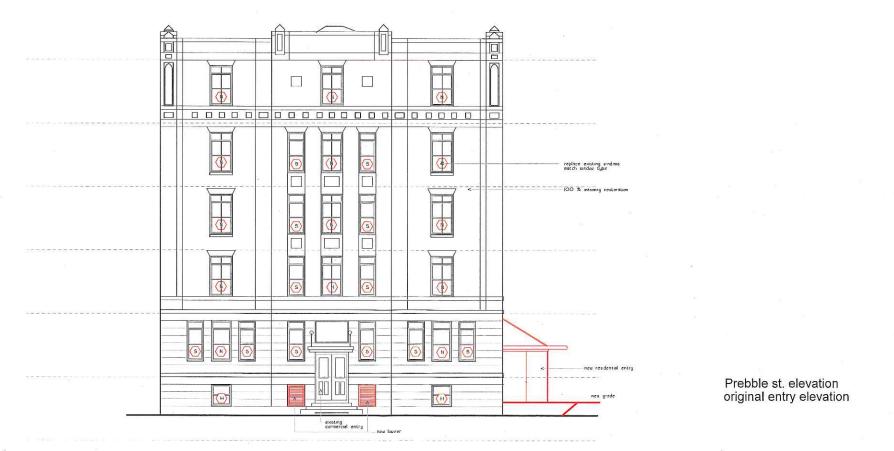

Schlotterhec

# Schlotterbeck Block

117 Preble Street Portland, Maine

~ 1	and the second control of the second control	
Soh	lotterbeck Block	
OUL	IUITEIDECK DIOCK	்டட

_ 9	uti/thon			
44	oak st.	e .		
port	land, m	aine	04101	
ph.	207-77	75-31	84	
fax	207-77	4-08	346	

revisions	evisions
-----------	----------

# date october 2015 sheet title

# elevations

)'  '	177
)' l' 4' 8'	16'
scale	
LONG STREET, LONG	
1/8"=1'-0"	
drawn by	
MS	- 3
project number	
schlotterbeck	
sheet number	







# Schlotterbeck Block

117 Preble Street Portland, Maine

# Schlotterbeck Block LLC

godu	iti/thomas	architects

44 oak st.

portland, maine 04101

ph. 207-775-3184

fox 207-774-0846

revisions

date october 2015

sheet title

# elevations

O' 1' 4' 8' 16'

scale

1/8"=1"-0"

drawn by


MS

project number
schlotterbeck

sheet number

A2.2



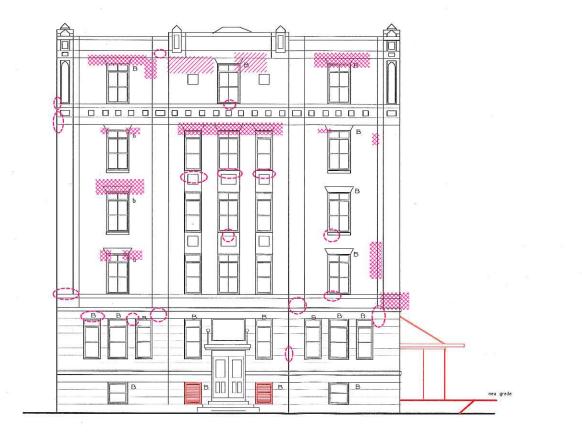

# Schlotterbeck Block

117 Preble Street Portland, Maine

# Schlotterbeck Block LLC

44	oak st.
por	tland, maine 04101
ph.	207-775-3184
fax	207-774-0846



hatch indicates area where masonry needs to be cut and repointed see detail O sheet A5.O



hatch indicates area where masoning needs to be repaired and repointed see detail O sheet A5.0

repair spalled cast stone

window Steel Lintel Schedule
type A: original lintel has been replaced
no work necessary
type B: original lintel in place
repar, replace
type C: replace existing lintel
with new galvarized lintel
type B/C: either repair or replace
inspect with lift

NOTES:
L wash all brick
product: Eco Chem, Restore One

 remove all loose cement based waterproof coating on existing cast stone apply near coating layer over all existing cast stone
 cut and bont all brick to cast stone joints and all cast stone to cast stone joints

4.% of misc. repointing incomplete (no lift)

	revisions	
	date	
-64	october 2015	
	sheet title	

# masonry repair elevations

0' 1' 4' 8'	16'
	2076
scale	
1/8"=1'-0"	
drawn by	
MS	
project number	
brewer	
sheet number	



Prebble st. elevation original entry elevation



# Schlotterbeck **Block**

117 Preble Street Portland, Maine

# Schlotterbeck Block LLC

44	oak st.
	1 4
por	tland, maine 04101
ph.	207-775-3184
fax	207-774-0846



hatch indicates area where masonry needs to be cut and repointed see detail O sheet A5.0



hatch indicates area where masonry needs to be repaired and repointed see detail O sheet A5.0 repair spalled cast stone



spalled cement coating repair

WINDOW STEEL LINTEL SCHEDULE type A: original lintel has been replaced no work necessary type B: original lintel in place repair, replace type C: replace extraints lintel with new galvanized lintel type B/C: either replace or replace inspect with lift

NOTES: I. uash all brick product: Eco Chem, Restore One

2. remove all loose cement based waterproof costing on existing dast stone apply new coating layer over all existing cast stone 3, cut and point all brick to cast stone joints and all cast stone to cast stone joints

revisions	
date _	
october 2015	
sheet title	

# masonry repair elevations

O' l' 4' 8' · 16' scale 1/8"=1'-0' drawn by project number brewer sheet number



Label	Avg	Max	Min	Avg/Min	Max/Min	PtSpcLr	PtSpcTb
BACK PARKING	0.90	1.9	0.4	2.25	4.75	10	10
ENTRY DRIVE	1.43	3.1	0.4	3.58	7.75	10	10
FRONT PARKING	0.98	2.6	0.3	3.27	8.67	10	10
FULL SITE	0.62	3.6	0.0	N.A.	N.A.	10	10

Type	Symbol	Qty	Lum. Lumens	LLF	Lum. Watts	Description
A4N	0	1	3912	0.900	63.4	RA174E35-60L3K-NFO
A3N	0	5	3248	0.900	63.2	RA173E35-60L3K-NFO
С	Õ	7	6220	0.900	109	ESL 110 4K AS X 7 DS
D	Ō	2	4812	0.900	65.1	PGL71WE35-60L3K
F	ΠŤ	2	1058	0.900	19.5	SW1-18LED-3500K
BL	(-)	10	1125	0.800	95	BOL FP45 13 L-CI XX-M50 00-\

1) EXACT MOUNTING DETAILS TO BE DETERMINED AT JOBSITE BY OTHERS.

2) CALCULATIONS MAY SHOW THE EFFECT OF SHADOWING CAUSED BY BUILDINGS AND OBJECTS WITHIN THE CALCULATED SPACE OR IN THE SITE AREA.


OBJECTS WITHIN THE CALCULATED SPACE OR IN THE SITE AREA.
3) READINGS SHOWN ARE INITIAL HORIZONTAL FOOTCANDLES ON A FLAT SITE
UNLESS OTHERWISE INDICATED.
4) THIS CALCULATION IS BASED ON LIMITED INFORMATION SUPPLIED BY OTHERS TO
SWANEY LIGHTING ASSOCIATES AND STANDARD ASSUMPTIONS OF THE SPACE AND/OR SITE
5) CONFORMANCE TO CODES AND OTHER LOCAL REQUIREMENTS AS DETERMINED BY THE AHJ

THE SCHLOTTERBECK BLOCK 117 PREBLE STREET, PORTLAND MAINE SITE LIGHTING LAYOUT

WANEY LIGHTING ASSOCIATES, INC

ARE THE RESPONSIBILITY OF THE OWNER AND/OR THE OWNER'S REPRESENTATIVE.
6) THIS LAYOUT DRAWING MUST BE COORDINATED WITH THE SITE LOCATION FOR

6) THIS LAYOUT DRAWING MUST BE COORDINATED WITH THE SITE LOCATION FOR CORRECT FIXTURE ORIGINATION.
7) CHECK GRAPHIC SCALE. DOCUMENTS PRINTED OR PLOTTED FROM ELECTRONIC FILES MAY OCCUR AT OTHER THAN THE DESIRED OR ASSUMED GRAPHIC SCALES. IT IS THE RESPONSIBILITY OF THE RECIPIENT TO VERIFY THAT THE PRINTED OR PLOTTED-TO-SCALE DRAWING IS PRINTED TO SCALE.

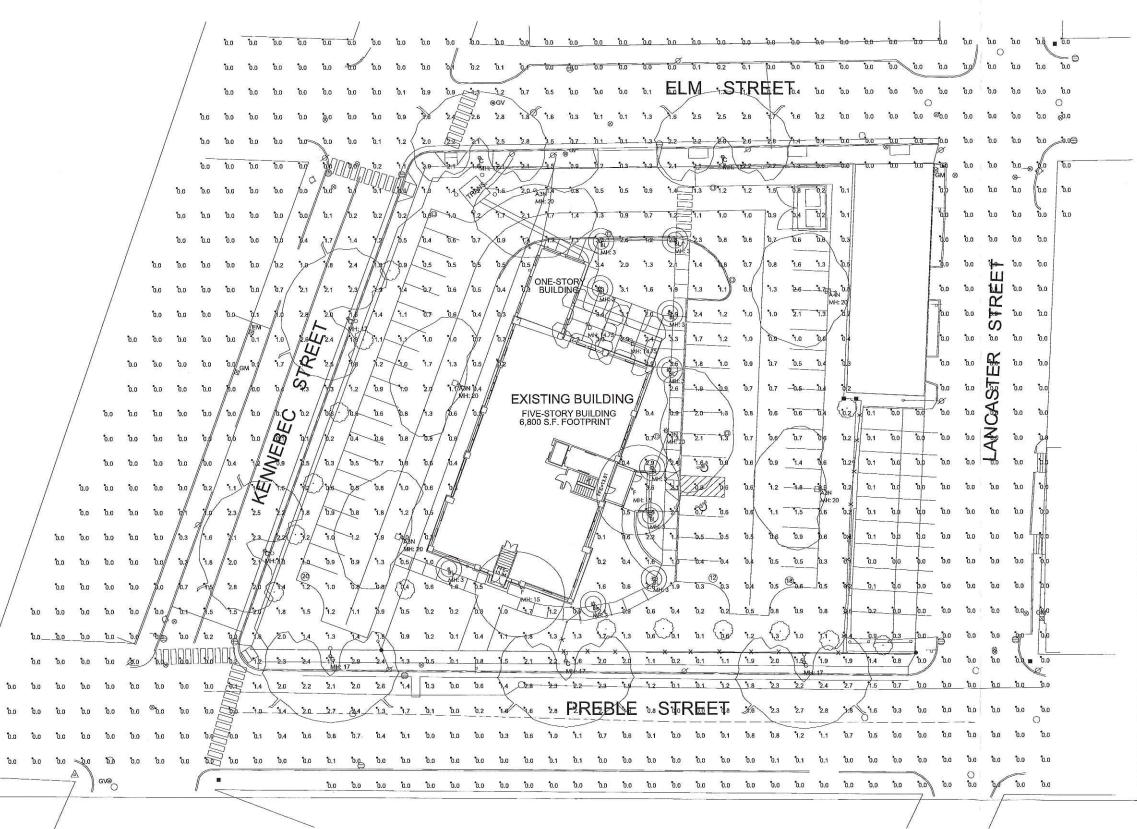

Label	Avg	Max	Min	Avg/Min	Max/Min	PtSpcLr	PtSpcTb
BACK PARKING	0.73	1.9	0.3	2.43	6.33	10	10
ENTRY DRIVE	1.25	3.1	0.3	4.17	10.33	10	10
FRONT PARKING	0.93	2.6	0.3	3.10	8.67	10	10
FULL SITE	0.26	3.6	0.0	N.A.	N.A.	10	10

Туре	Symbol	Qty	Lum. Lumens	LLF	Lum. Watts	Description
A4N	0	1	3912	0.900	63.4	RA174E35-60L3K-NFO
A3N	0	5	3248	0.900	63.2	RA173E35-60L3K-NFO
C	0	7	6220	0.900	109	ESL 110 4K AS X 7 DS
D	0	2	4812	0.900	65.1	PGL71WE35-60L3K
F		2	1058	0.900	19.5	SW1-18LED-3500K
BL	$\Theta$	10	1125	0.800	95	BOL FP45 13 L-CI XX-M50 00-

- 1) EXACT MOUNTING DETAILS TO BE DETERMINED AT JOBSITE BY OTHERS. 2) CALCULATIONS MAY SHOW THE EFFECT OF SHADOWING CAUSED BY BUILDINGS AND

- 2) CALCULATIONS MAY SHOW THE EFFECT OS SHADOWING CAUSED BY BUILDINGS AND OBJECTS WITHIN THE CALCULATED SPACE OR IN THE SITE AREA.

  3) READINGS SHOWN ARE INITIAL HORIZONTAL FOOTCANDLES ON A FLAT SITE UNLESS OTHERWISE INDICATED.


  4) THIS CALCULATION IS BASED ON LIMITED INFORMATION SUPPLIED BY OTHERS TO SWANEY LIGHTING ASSOCIATES AND STANDARD ASSUMPTIONS OF THE SPACE ANDIOR SITE.

  5) CONFORMANCE TO CODES AND OTHER LOCAL REQUIREMENTS AS DETERMINED BY THE AHJ
- 5) CONFORMANCE TO CODES AND OTHER LOCAL REQUIREMENTS AS DETERMINED BY ARE THE RESPONSIBILITY OF THE OWNER AND/OR THE OWNER'S REPRESENTATIVE.


  6) THIS LAYOUT DRAWING MUST BE COORDINATED WITH THE SITE LOCATION FOR CORRECT FIXTURE ORIENTATION.

  7) CHECK GRAPHIC SCALE. DOCUMENTS PRINTED OR PLOTTED FROM ELECTRONIC FILES MAY OCCUR AT OTHER THAN THE DESIRED OR ASSUMED GRAPHIC SCALES. IT IS THE RESPONSIBILITY OF THE RECIPIENT TO VERIEY THAT THE PRINTED OR DID CONTENT TO SCALE DRAWING US BRINTED TO SCALE S. OR PLOTTED-TO-SCALE DRAWING IS PRINTED TO SCALE.

# STREET LIGHTING TURNED OFF

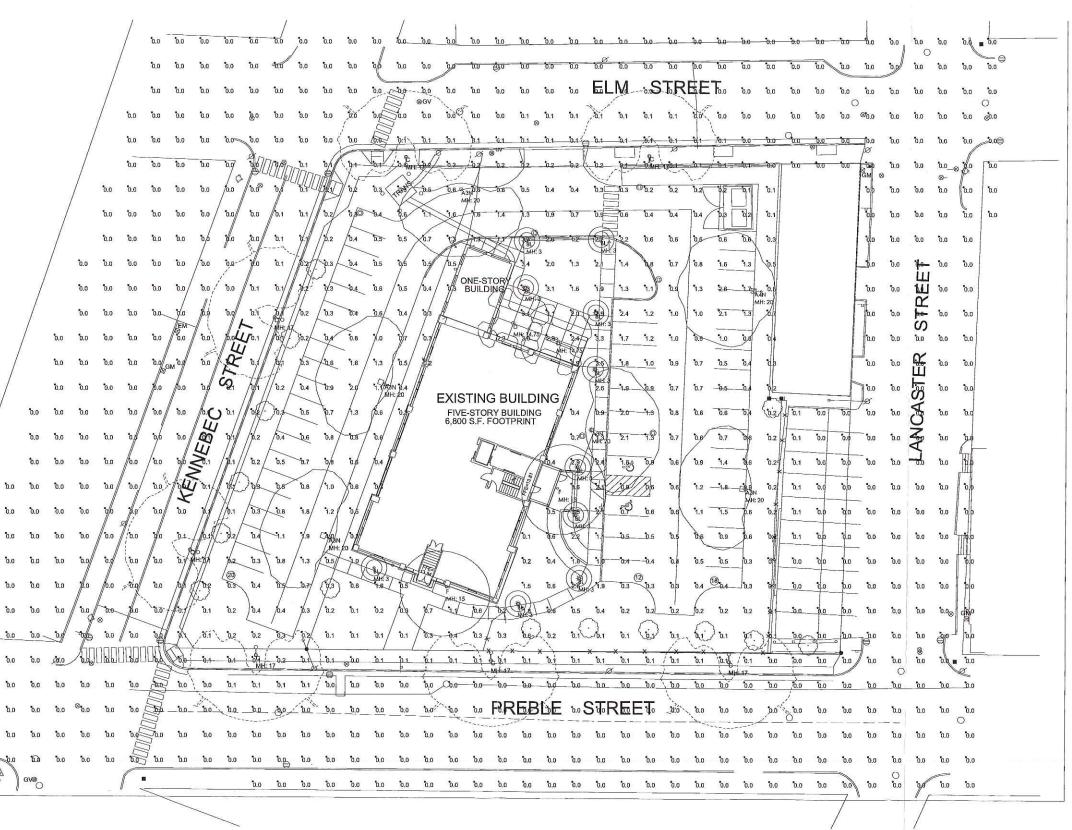

THE SCHLOTTERBECK BLOCK 117 PREBLE STREET, PORTLAND MAINE SITE LIGHTING LAYOUT

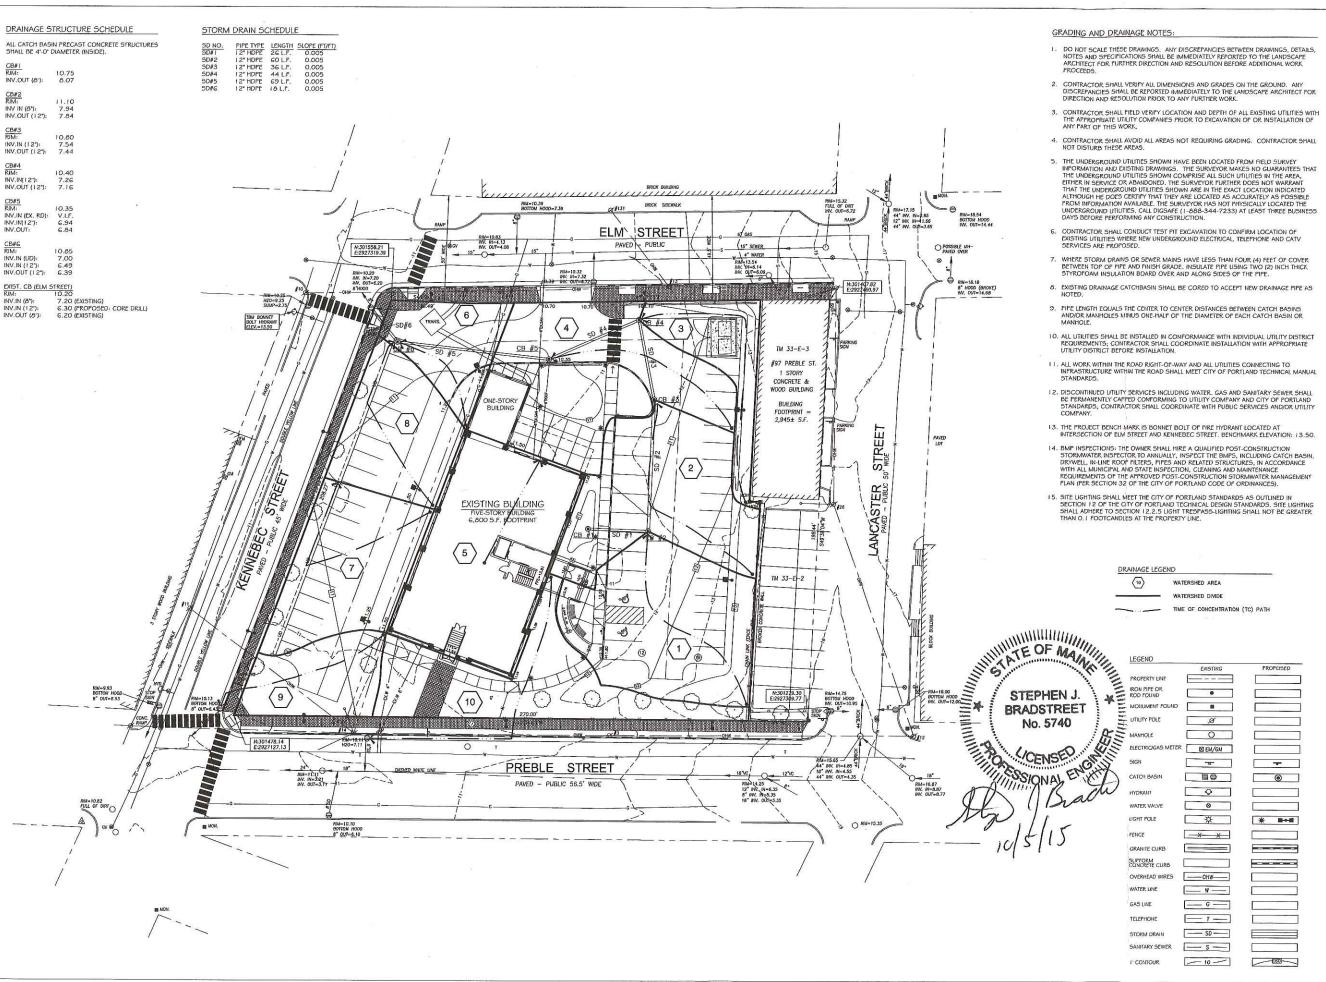

Prepared For:
Owner and Applicant:
SCHLOTTERBECK BLOCK L.L.C.
77 Sprace Street

Prepared By: MITCHELL & ASSOCIATES

> O Center Street ortland, Maine 04101 el.: 207-774-4427

GODUTI-THOMAS ARCHITECTS 44 Oak Street # 2 Portland, Maine 04101 Phone: 207-775-3184

eck Block
Portland, Maine

The Schlotterbo

Street

Preble

Date:
SEPTEMBER 29, 2015

Issued For:

Revisions:

Reproduction or reuse of this document without the expressed written consent of Mitchell & Associates is prohibited.
© 2015

Title:
POST-DEVELOPMENT STORMWATER PLAN

