SHELL IMPROVEMENTS

50 WHARF STREET PORTLAND MAINE

SHEET NUMBER Reviewed for Code Compliance Permitting and Inspections Department G1-0 GENERAL NOTES, ABBREVIATIONS, AND LEGENS G1-1 LIFE SAFETY PLAN ARCHITECTURAL A1-0 FLOOR PLAN A1-1 ENLARGED RAMP PLAN A2-0 ELEVATIONS A2-1 RENDERINGS A7-0 DOOR SCHEDULE

PERMIT DRAWINGS

MAY 3, 2018

REVISED 06/25/18 - PER HISTORIC REVIEW

ARCHITECT

RYAN SENATORE ARCHITECTURE

565 CONGRESS STREET, SUITE 304, PORTLAND, MAINE 04101 207-650-6414

2: CODE COMPLIANCE:

ALL WORK SHALL CONFORM TO THE LATEST EDITION OF STATE, LOCAL AND OTHER CODES WHICH APPLY TO THIS PROJECT OR HAVE JURISDICTION.

IT IS THE RESPONSIBILITY OF THE CONTRACTOR TO COORDINATE ALL DISCIPLINES AND TRADES SO THAT ALL BUILDING SYSTEMS AND COMPONENTS CAN BE ASSEMBLED WITHOUT CONFLICTS. IN THE EVENT THAT THE CONSTRUCTION DOCUMENTS DEFINE CONDITIONS WHICH PROHIBIT, OR MAY PROHIBIT, SUCH ASSEMBLY, THE CONTRACTOR SHALL BRING TO THE ARCHITECTS ATTENTION, IN WRITING AND IN A TIMELY FASHION, SUCH CONDITION. THE CONTRACTOR SHALL NOT PROCEED WITH RELATED WORK WITHOUT A WRITTEN RESOLUTION

CLARIFICATION FROM THE ARCHITECT THE CONTRACTOR AND HIS/HER SUBCONTRACTORS SHALL BE RESPONSIBLE FOR PROVIDING MATERIALS AND SYSTEMS SHOWN IN THE CONSTRUCTION DOCUMENTS REGARDLESS OF WHERE THE INFORMATION IS LOCATED. WHERE COMPONENTS OF A SYSTEM ARE INDICATED THE CONTRACTOR SHALL BE RESPONSIBLE FOR PROVIDING ALL LABOR AND MATERIALS NECESSARY TO COMPLETE THE SYSTEM.

4: DISCREPANCIES & CLARIFICATIONS:

THIS PROJECT INVOLVES THE FIT-UP OF AN EXISTING BUILDING. EXISTING DIMENSIONS SHOWN ON THE DRAWINGS ARE BELIEVED TO BE ACCURATE, BUT CANNOT BE GUARANTEED, MEASURE AND VERIFY DIMENSIONS IN FIELD PRIOR TO FABRICATION AND CONSTRUCTION. IT IS THE RESPONSIBILITY OF THE CONTRACTOR TO BRING TO THE ARCHITECTS ATTENTION, IN WRITING, ANY DISCREPANCIES OR AMBIGUITIES IN THE DRAWINGS AND/OR SPECIFICATIONS. THE CONTRACTOR SHALL NOT PROCEED WITH RELATED WORK WITHOUT A WRITTEN RESOLUTION OR CLARIFICATION FROM THE ARCHITECT.

UNLESS INDICATED OTHERWISE, CENTER WALL FRAMING AND PARTITION FRAMING ON COLUMN LINES. FLOOR PLAN DIMENSIONS ARE TO CENTER OF FRAMING, FACE OF CONCRETE FACE OF CMU, OR FROM COLUMN CENTERLINES, UNLESS INDICATED OTHERWISE. DOORS AND WINDOWS ARE DIMENSIONED TO CENTERLINES UNLESS INDICATED OTHERWISE.

UNLESS INDICATED OTHERWISE, CENTER BUILDING ELEMENTS WITHIN OR BETWEEN OTHER BUILDING ELEMENTS WHEN CONDITIONS OR THE DRAWINGS INDICATE OR IMPLY THAT SUCH IS THE INTENT, WHETHER OR NOT DIMENSIONS ARE INCLUDED

WHERE CONDITIONS OR THE DRAWINGS INDICATE OR IMPLY THAT SYMMETRY IS INTENDED, INFORMATION PROVIDED AT ONE SIDE APPLIES EQUALLY TO BOTH SIDES, UNLESS CONDITIONS CLEARLY PRECLUDE SUCH APPLICATION.

ALL HANDICAPPED ACCESSIBLE BATHROOMS, GRAB BARS, AND DOOR OPENINGS SHALL MEET THE REQUIREMENTS OF TITLE 94-348, CHAPTER 5 OF THE MAINE HUMAN RIGHTS COMMISION TITLE LATEST EDITION & THE DEPARTMENT OF JUSTICE ADA STANDARDS FOR ACCESSIBLE DESIGN.

WORK FROM THE GIVEN DIMENSIONS ONLY. SCALE IS INDICATED ON THE DRAWINGS FOR CONVENIENCE ONLY. IT IS NOT INTENDED THAT INFORMATION BE DETERMINED BY SCALING THE DRAWINGS SINCE SOME ITEMS MAY NOT BE TO SCALE.

10: WATER-RESISTANT GWB:

INSTALL WATER-RESISTANT GYPSUM WALL BOARD IN ALL REST ROOMS & TOILET ROOMS OR AT ANY WALL WITH PLUMBING

10A: HIGH IMPACT GWB:

INSTALL HIGH IMPACT GYPSUM WALL BOARD IN ALL STAIRWELLS

INTERIOR ELEVATIONS MAY BE REVERSED FROM AND/OR SIMILAR TO ACTUAL CONDITIONS. SEE FLOOR PLANS FOR WINDOW AND DOOR QUANTITIES AND LOCATIONS, FOR CASEWORK LAYOUTS, AND FOR MONITOR LOCATIONS.

12: BUILDING INSULATION:

PROVIDE AS INDICATED IN WALL SECTIONS AND IN ACCORDANCE WITH PARTITION TYPES. WHETHER OR NOT SHOWN IN DETAILS AND OTHER DRAWINGS. FOR CLARITY, INSULATION MAY NOT BE SHOWN IN SOME CASES, EVEN IF IT IS TO BE PROVIDED.

13: BLOCKING:

INSTALL BLOCKING BEHIND ALL SURFACE-APPLIED FIXTURES TRIM. CASEWORK, SHELVES, BRACKETS, TOILET ACCESSORIES. CHAIR RAILS, PICTURE RAILS, GRAB BARS, BASE MOLDINGS, AND AS OTHERWISE REQUIRED, WHEN SUCH ITEMS ARE APPLIED ON STUD WALLS.

14: PENETRATIONS AT STRUCTURAL MEMBERS: BEFORE PENETRATING JOISTS, BEAMS OR OTHER STRUCTURAL MEMBERS, CONSULT WITH THE ARCHITECT.

15: DAMAGED WORK:

BUILDING OR SITE COMPONENTS WHICH ARE AFFECTED BY NEW WORK, DEMOLITION, OR WHICH MAY BE DAMAGED BY THE GENERAL CONTRACTOR OR ANY SUB-CONTRACTOR SHALL BE REPLACED OR RESTORED TO ORIGINAL CONDITION AND COLOR TO MEET THE APPROVAL OF THE ARCHITECT.

VERIFY THE SIZE AND LOCATION OF ALL UNDERGROUND UTILITIES AND REPORT ANY DISCREPANCIES TO THE ARCHITECT IN WRITING. DO NOT PROCEED WITH WORK UNTIL THE DISCREPANCY HAS BEEN RESOLVED TO THE SATISFACTION OF THE ARCHITECT.

17: RATED CONSTRUCTION:

PROVIDE RATED CONSTRUCTION AS REQUIRED BY CODE, AS SPECIFIED, AND AS INDICATED ON DRAWINGS. IT IS THE RESPONSIBILITY OF THE CONTRACTOR TO PROVIDE AND INSTALL ALL COMPONENTS REQUIRED TO CREATE SUCH RATED CONSTRUCTION, REGARDLESS OF WHETHER OR NOT SUCH COMPONENTS ARE INDICATED. PROVIDE CONTINUITY OF SUCH RATED CONSTRUCTION AROUND AND BETWEEN SPACES, INCLUDING AT CHASES AND AT FLOORS, TO MAINTAIN COMPLETE SEPARATIONS, EVEN IF NOT SPECIFICALLY INDICATED.

18: SHOP DRAWINGS:

SUBMIT SHOP DRAWINGS TO THE ARCHITECT FOR REVIEW PRIOR TO FABRICATIONS. SUBMITTALS REQUIRED INCLUDE, BUT ARE NOT LIMITED TO, SHOP DRAWINGS FOR ALL PREFABRICATED CONCRETE, STEEL, MILLWORK & SIGNAGE, SAMPLES OF ALL PROPOSED PAINTS, METALS, WALL COVERINGS, LAMINATES, SOLID SURFACE MATERIALS, CERAMIC TILE, AND HARDWARE. SUBMIT MANUFACTURERS' DATA FOR ALL LIGHTING SYSTEMS, AND HARDWARE.

THE GENERAL CONTRACTOR SHALL OBTAIN AND PAY FOR ANY BUILDING PERMITS REQUIRED AND CARRY ANY INSURANCE COVERAGES REQUIRED.

20: INTERIOR FINISHES: ALL INTERIOR FINISHES AND FURNISHINGS ARE TO BE CLASS 'A' FIRE-RATED AND ARE TO COMPLY WITH IBC CHAPTER-8 (INTERIOR FLAME SPREAD).

21: ELECTRICAL DESIGN:

REFER TO ELECTRICAL DRAWINGS AND SPECIFICATIONS

22: WASTE REMOVAL: THE GENERAL CONTRACTOR SHALL DISPOSE OF ALL WASTE AND DEBRIS OFF THE PREMISES.

23: LANDLORD COORDINATION: THE GENERAL CONTRACTOR MUST COORDINATE WITH THE

BUILDING OWNER ALL ACTIVITIES INCLUDING BUT NOT LIMITED TO WORK WHICH WILL GENERATE EXCESSIVE NOISE AND MODIFICATION TO UTILITIES. WORK MUST NOT INTERFERE WITH EXISTING SMOKE DETECTORS, ALARMS OR BUILDING SYSTEM MANAGEMENT

24: TEMPORARY FACILITIES:

PROVIDE ALL TEMPORARY FACILITIES AND SERVICES. CONSTRUCTION AND SUPPORT FACILITIES, AND SECURITY AND PROTECTION AS NEEDED TO PROTECT NEW AND EXISTING CONSTRUCTION FOR THE DURATION OF A COMPLETE INSTALLATION.

25: FINAL CLEANING:

EMPLOY EXPERIENCED WORKERS FOR FINAL CLEANING. CLEAN EACH SURFACE TO THE CONDITION EXPECTED IN A COMMERCIAL BUILDING CLEANING PROGRAM.

26: MANUFACTURERS INSTRUCTIONS: ALL MATERIALS & EQUIPMENT SHALL BE INSTALLED ACCORDING TO MANUFACTURER'S SPECIFICATIONS.

GUARANTEE: ALL MATERIALS AND WORKMANSHIP SHALL BE GUARANTEED FOR A PERIOD OF ONE YEAR FROM THE DATE OF

FINAL ACCEPTANCE UNLESS OTHERWISE SPECIFIED FOR A LONGER PERIOD OF TIME ON A CERTAIN ITEM.

ALL MATERIAL USED FOR THE CONSTRUCTION OF THIS PROJECT, WHETHER BUILDING MATERIALS OR

APPURTENANCES, SHALL BE NON-ASBESTOS CONTAINING

MATERIAL.

29: HAZARDOUS FUMES: THE GENERAL CONTRACTOR SHALL CONFIRM THAT ALL MATERIAL AND FINISHES SPECIFIED AND THEIR FABRICATION OR INSTALLATION WILL NOT RELEASE FUMES OR AROMAS DURING CONSTRUCTION WHICH MAY BE A HAZARD OR NUISANCE TO PERSONNEL

30: PEST CONTROL

SEAL AND CAULK AROUND ALL PENETRATIONS, CRACKS AND CREVICES AND ANY OPENINGS CAPABLE OF HARBORING INSECTS/RODENTS.

31. EXPOSED UTILITIES:

ALL EXPOSED UTILITY WIRES AND PIPES (ELECTRICAL, PLUMBING, ETC.) SHALL BE INSTALLED IN A WAY THAT DOES NOT OBSTRUCT OR PREVENT THE CLEANING OF FLOORS, WALLS, AND CEILING AREAS. THEY SHALL BE INSTALLED A MINIMUM OF 6" OFF FLOORS AND 1" OFF WALLS, CEILINGS AND

32. OWNER SUPPLIED EQUIPMENT:

EQUIPMENT SUPPLIED BY THE OWNER AND INSTALLED BY THE GENERAL CONTRACTOR: EQUIPMENT INFORMATION AND SPECIFICATIONS ARE TO BE THE MOST CURRENT AVAILABLE AT THE TIME OF DOCUMENTATION PREPARATION. THE GENERAL CONTRACTOR SHALL BE RESPONSIBLE FOR VERIFYING WITH THE OWNER THE **EXACT DIMENSIONS AND EQUIPMENT CONNECTION** REQUIREMENTS (INCLUDING ELECTRICAL CIRCUIT REQUIREMENTS) OF EQUIPMENT TO BE SUPPLIED. THE GENERAL CONTRACTOR SHALL MAKE ALL FINAL CONNECTIONS AS NOTED ON THE DRAWINGS, INSTALL THE SET UP IN WORKING ORDER, CHECK WARRANTIES, TEST AND NOT VOID WARRANTIES. THE GENERAL CONTRACTOR SHALL COORDINATE WITH THE OWNER DELIVERY, STORAGE AND INSTALLATION OF ALL OWNER SUPPLIED EQUIPMENT. THE GENERAL CONTRACTOR SHALL STORE EQUIPMENT IF REQUESTED BY THE OWNER UNTIL INSTALLATION. SEE DRAWINGS FOR OTHER OWNER SUPPLIED/GENERAL CONTRACTOR INSTALLED ITEMS.

33: FIRE PROTECTION NOTE:

EXISTING SPRINKLERHEADS. ALARM SYSTEM AND DETECTORS ARE TO BE MODIFIED TO CONFORM. WITH THE PROPOSED PLAN. COORDINATE WITH THE ARCHITECT, ANY MODIFICATION OR LOCATIONS WHERE EXISTING SYSTEMS ARE AFFECTED BY THE NEW DESIGN.

34: SOILS AT FOOTINGS:

REPORT THE LOCATION OF ALL UNSUITABLE SOILS AND MATERIALS BELOW ANTICIPATED LEVEL OF FOOTING TO THE ARCHITECT PRIOR TO THE SETTING OF FORMS.

35: ACCESS PANELS:

CONTRACTOR IS RESPONSIBLE FOR COORDINATING QUANTITY AND LOCATION OF ALL REQUIRED ACCESS PANELS FOR ALL MEP CONTROLS, CLEANOUTS, DAMPERS, PULL BOXES, ETC.

36: EXISTING HAZARDOUS MATERIALS

ALL HAZARDOUS MATERIALS INCLUDING BUT NOT LIMITED TO ASBESTOS AND LEAD PAINT ARE TO BE HANDLED. ENCAPSULATED, ABATED AND DISPOSED OF IN ACCORDANCE WITH ANY AND ALL FEDERAL, STATE AND LOCAL REQUIREMENTS AND REGULATIONS.

37: INDUSTRY STANDARDS: ALL WORK SHALL BE PERFORMED IN ACCORDANCE WITH

INDUSTRY STANDARDS. STANDARDS INCLUDE BUT ARE NOT LIMITED TO THE FOLLOWING: AAMA AMERICAN ARCHITECTURAL MANUFACTURERS

ASSOCATION

ACI AMERICAN CONCRETE INSTITUTE AMERICAN NATIONAL STANDARDS INSTITUTE ANSI AMERICAN SOCIETY FOR TESTS AND MATERIALS AWI ARCHITECTURAL WOODWORK INSTITUTE "CUSTOM GRADE"

AMERICAN WELDING SOCIETY INSULATING GLASS MANUFACTURERS ALLIANCE NAAMM NATIONAL ASSOCIATION OF ARCHITECTURAL METAL MANUFACTURERS

NRCA NATIONAL ROOFING CONTRACTORS ASSOCIATION NATIONAL TILE CONTRACTORS ASSOCIATION NTCA SMACNA SHEET METAL AND AIR CONDITIONING NATIONAL ASSOCIATION

WDMA WINDOW AND DOOR MANUFACTURERS ASSOCIATION

ABBREVIATIONS LABORATORY ACOUSTICAL CEILING TILE AREA DRAIN **AMINATED** POUND AMERICANS WITH DISABILITIES ACT ACCESSIBILITY'S GUIDELINES ADAAG FFT-HAND LEAD COATED COPPER ABOVE FINISHED FLOOR AIR-HANDLING UNIT ARCHITECT/ARCHITECTURAL MATERIAL MAXIMUM ACOUSTIC WALL PANEL MEDIUM-DENSITY OVERLAY **MEMBRANE** BASE BUILDING GENERAL CONTRACTOR BUILDING LINE MEZZANINE BLDG BLKG BSMT BTWN MANUFACTURER BLOCKING BASEMENT MINIMIIM MISCELL ANEOUS BETWEEN BY OTHERS MASONRY OPENING MOUNTED COURSE (MASONRY) MARKER BOARD CORNER GUARD COAT HOOK NORTH NOT IN CONTACT CENTER LINE CEILING NOT TO SCALE CONCRETE MASONRY UNIT CLEAN OUT COLUMN COL CONC COND CONST CONT CORR CONCRETE CONDITION CONNECT/CONNECTION CONSTRUCTION UTSIDE DIAMETER/OUTSIDE DIMENSION OPNG OPP OPP H OPENING CONTINUOUS OPPOSITE HAND ORIENTED STRAND BOARD CABINET UNIT HEATER OUNCE PURCHASED BY OWNER INSTALLED BY PBOIBC DRINKING FOUNTAIN CONTRACTOR PRECAST PL PLAM DIMENSION DOWN DOOR PLASTIC LAMINATE PREFABRICATE DRY STAND PIPE DRAWING POUNDS PER SQUARE FOOT POUNDS PER SQUARE INCH FI EVATION PARTITION LECTRICAL POLYVINYL CHLORIDE PLYWOOD ENTRANCE PRESSURE TREATED QUAL QUIPMENT PERF PERFORATED XPANSION QUARRY TILE EXPANSION BOL QUARTER EXPANSION JOINT EPDM EWC ETHYLENE PROPYLENE DIENE MONOMER R ELECTRIC WATER COOLER RISER/RADIUS RADIUS REFLECTED CEILING PLAN FLAT BAR FIRE EXTINGUISHER AND CABINET ROOF DRAIN FLOOR DRAIN FIRE EXTINGUISHER REINFORCING BAR EFRIGERATOR REINFORCED FIRE EXTINGUISHER CABINET FIRE TREATED WOOD REQUIRED RESILIENT REVERSE FACE OF BRICK ROUGH OPENING FACE OF CONCRETE RIGHT OF WAY FACE OF STUDS FIRE SUPPRESSION SYSTEM SCHEDULE SQUARE FEET SCHED FIBER REINFORCED GYPSUM

FIN TUBE RADIATION

GENERAL CONTRACTOR

GLASS/GLAZING/GLAZED

GLUE-LAMINATED WOOD

GYPSUM WALL BOARD

GROUND-FAULT INTERRUPTER

HORIZONTAL HORSE POWER/HIGH POINT/HEAT PUMP

INSIDE DIMENSION/INSIDE DIAMETER INCHES

HEATING VENTILATION AIR CONDITIONING UV

FUME HOOD

GALVANIZED GRAB BAR

HANDICAP

HOUR HOT WATER

INFORMATION

INSULATION

DRAWING LEGEND

EARTH

CONCRETE MASONRY UNIT

RIGID INSULATION

BATT INSULATION

POROUS FILL

CONCRETE

WOOD - ROUGH

GYPSUM BOARD

CELLULOSE INSULATION

LIN WD

HOLLOW METAL

FH

GA GALV GB

HORIZ

HVAC

INFO INSUL

SPECIFICATION

TANDARD

ELEPHONE

TOP OF STEEL

TOP OF CONCRETE

UNIT VENTILATOR

VERIFY IN FIELD

WITHOUT

WEIGHT

AND NUMBER

DOOR NUMBER

WINDOW NUMBER

REVISION NUMBER

FLOOR-CEILING TYPE

ROOF SYSTEM TYPE

FLOORING TYPE TRANSITION

WOOD WIDE FLANGE

VINYL COMPOSITION TILE

TYPICAL TELEVISION

TEEL TORAGE


STOR STRUCT

SQUARE STAINLESS STEEL

SOUND TRANSMISSION CLASS

UNDERWRITERS LABORATORIES, INC.

STRUCTURE/STRUCTURAL

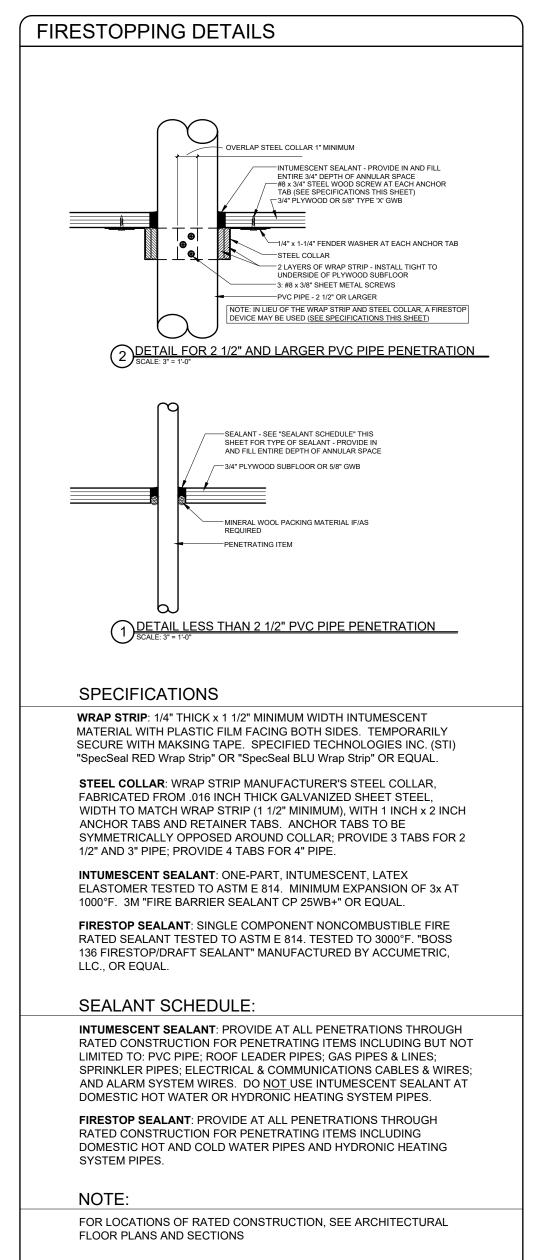

ELEVATION COMPASS LETTER

- SHEET WHERE ELEVATION LOCATED

SHEET WHERE SECTION LOCATED

- SHT WHERE DETAIL LOCATED

PARTITION TYPE TAG

PARTITION HEIGHT DESIGNATION

PARTITION TYPE

1HR FIRE RATED WALL


2HR FIRE RATED WALL


INTERIOR ELEVATION SYMBOL

ELEVATION NUMBER

SECTION NUMBER

SECTION MARK

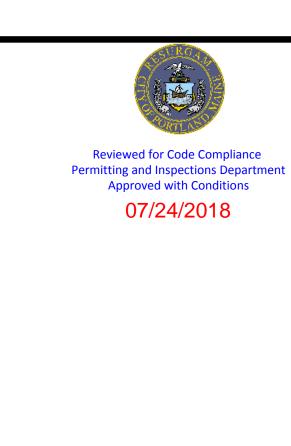

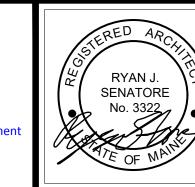

© 2018 RYAN SENATOF ARCHITECTURE

ORT

RYAN SENATORE **ARCHITECTURE** 565 CONGRESS STREET PORTLAND, MAINE 04101 207-650-6414 senatorearchitecture.com

REVISIONS:


CONSULTANTS:

MAY 3, 2018 PROJECT No. RJS, JPI DRAWN BY: CHECKED BY: AS NOTE SCALE:

GENERAL NOTES, ABBREVIATIONS.

SHEET TITLE:



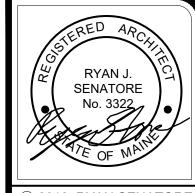

SHELL FIT-UP
PORTLAND, MAINE

50

RYAN SENATORE
ARCHITECTURE
565 CONGRESS STREET
PORTLAND, MAINE 04101
207-650-6414

senatorearchitecture.com

REVISIONS:

CONSULTANTS:

DATE: MAY 3, 2018
PROJECT No. 1778
DRAWN BY: RJS, JPF
CHECKED BY: RJS

SCALE: AS NOTED

SHEET TITLE:

SHEET TITLE:

CODE REVIEW
PLAN


G1-1


LEGEND

----- 1 HOUR SEPARATION


EXIT

FIRE EXTINGUSHER

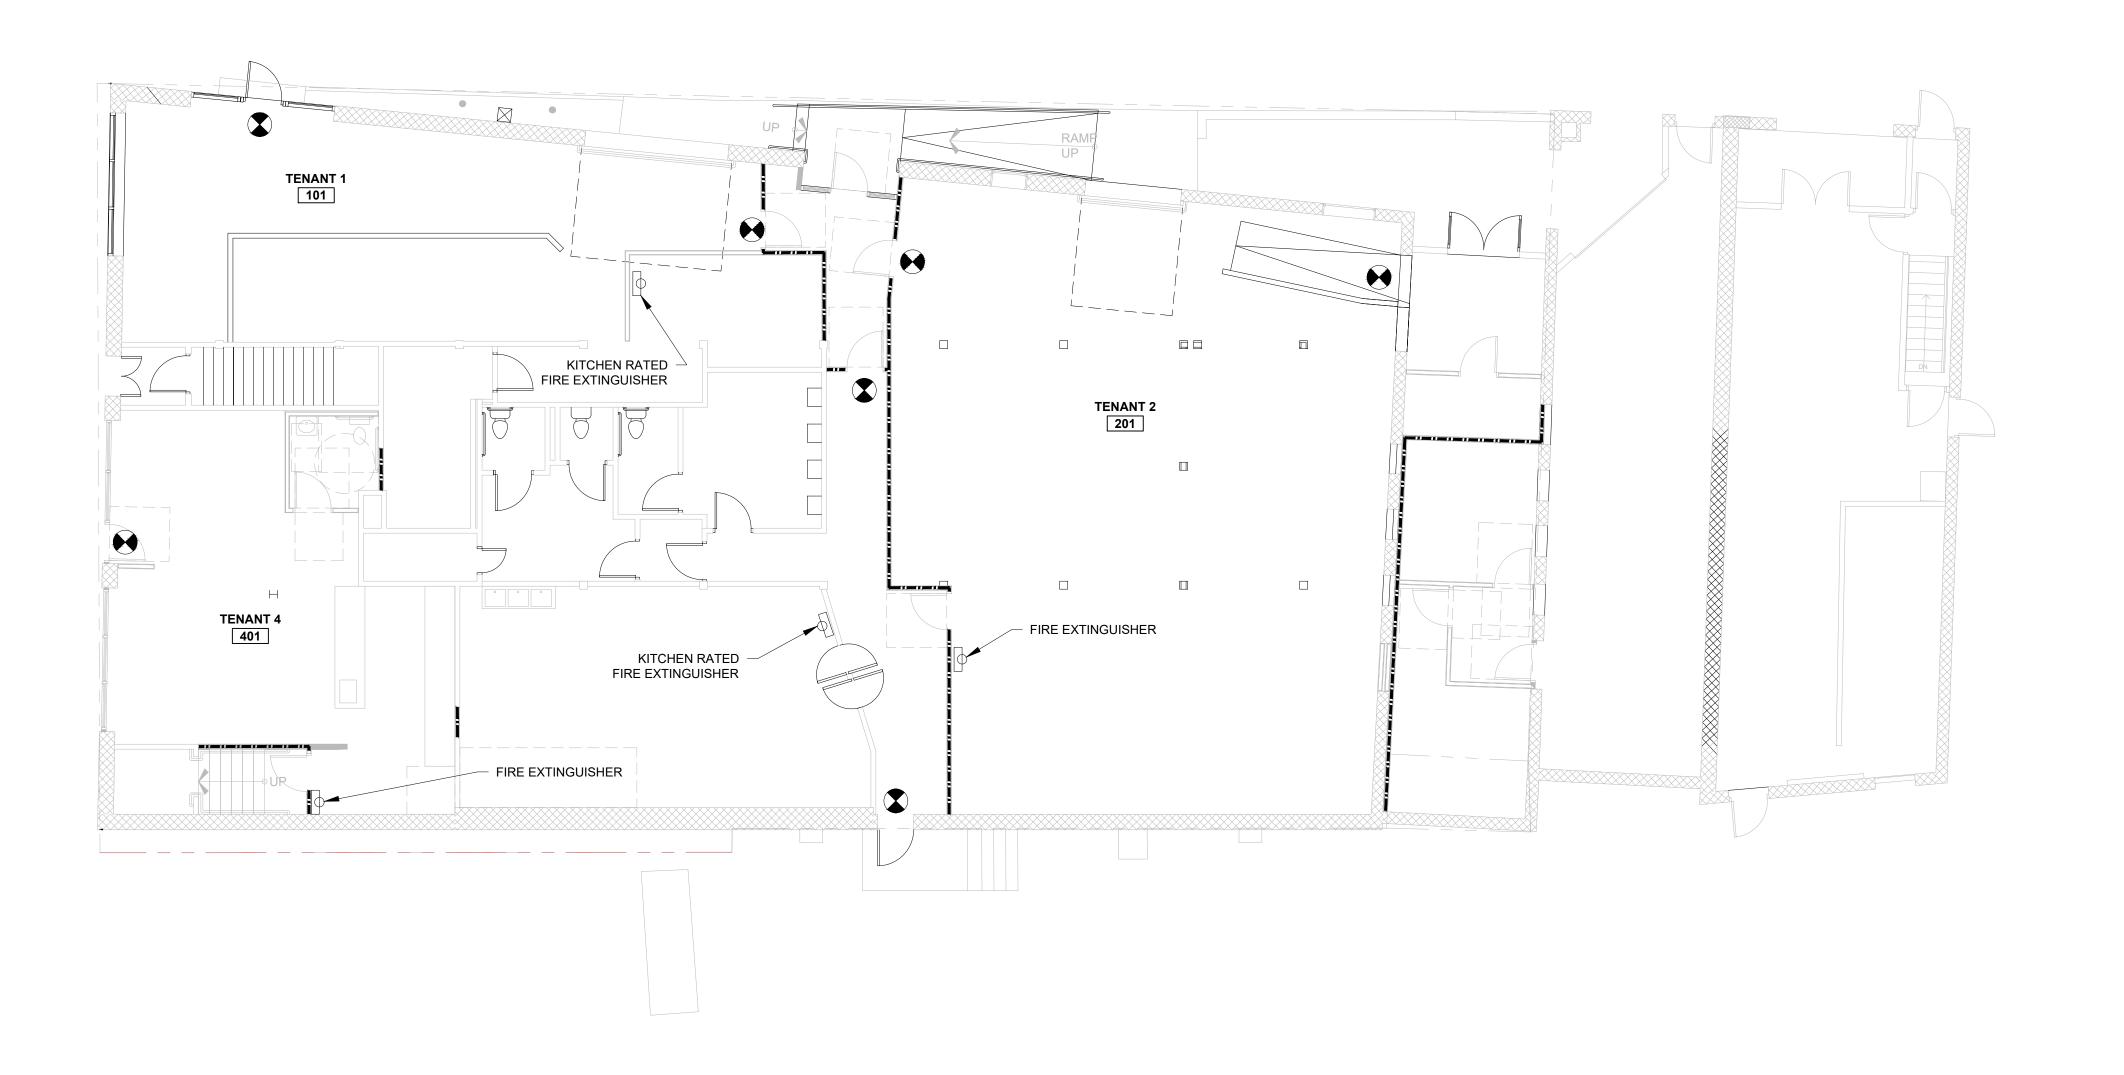

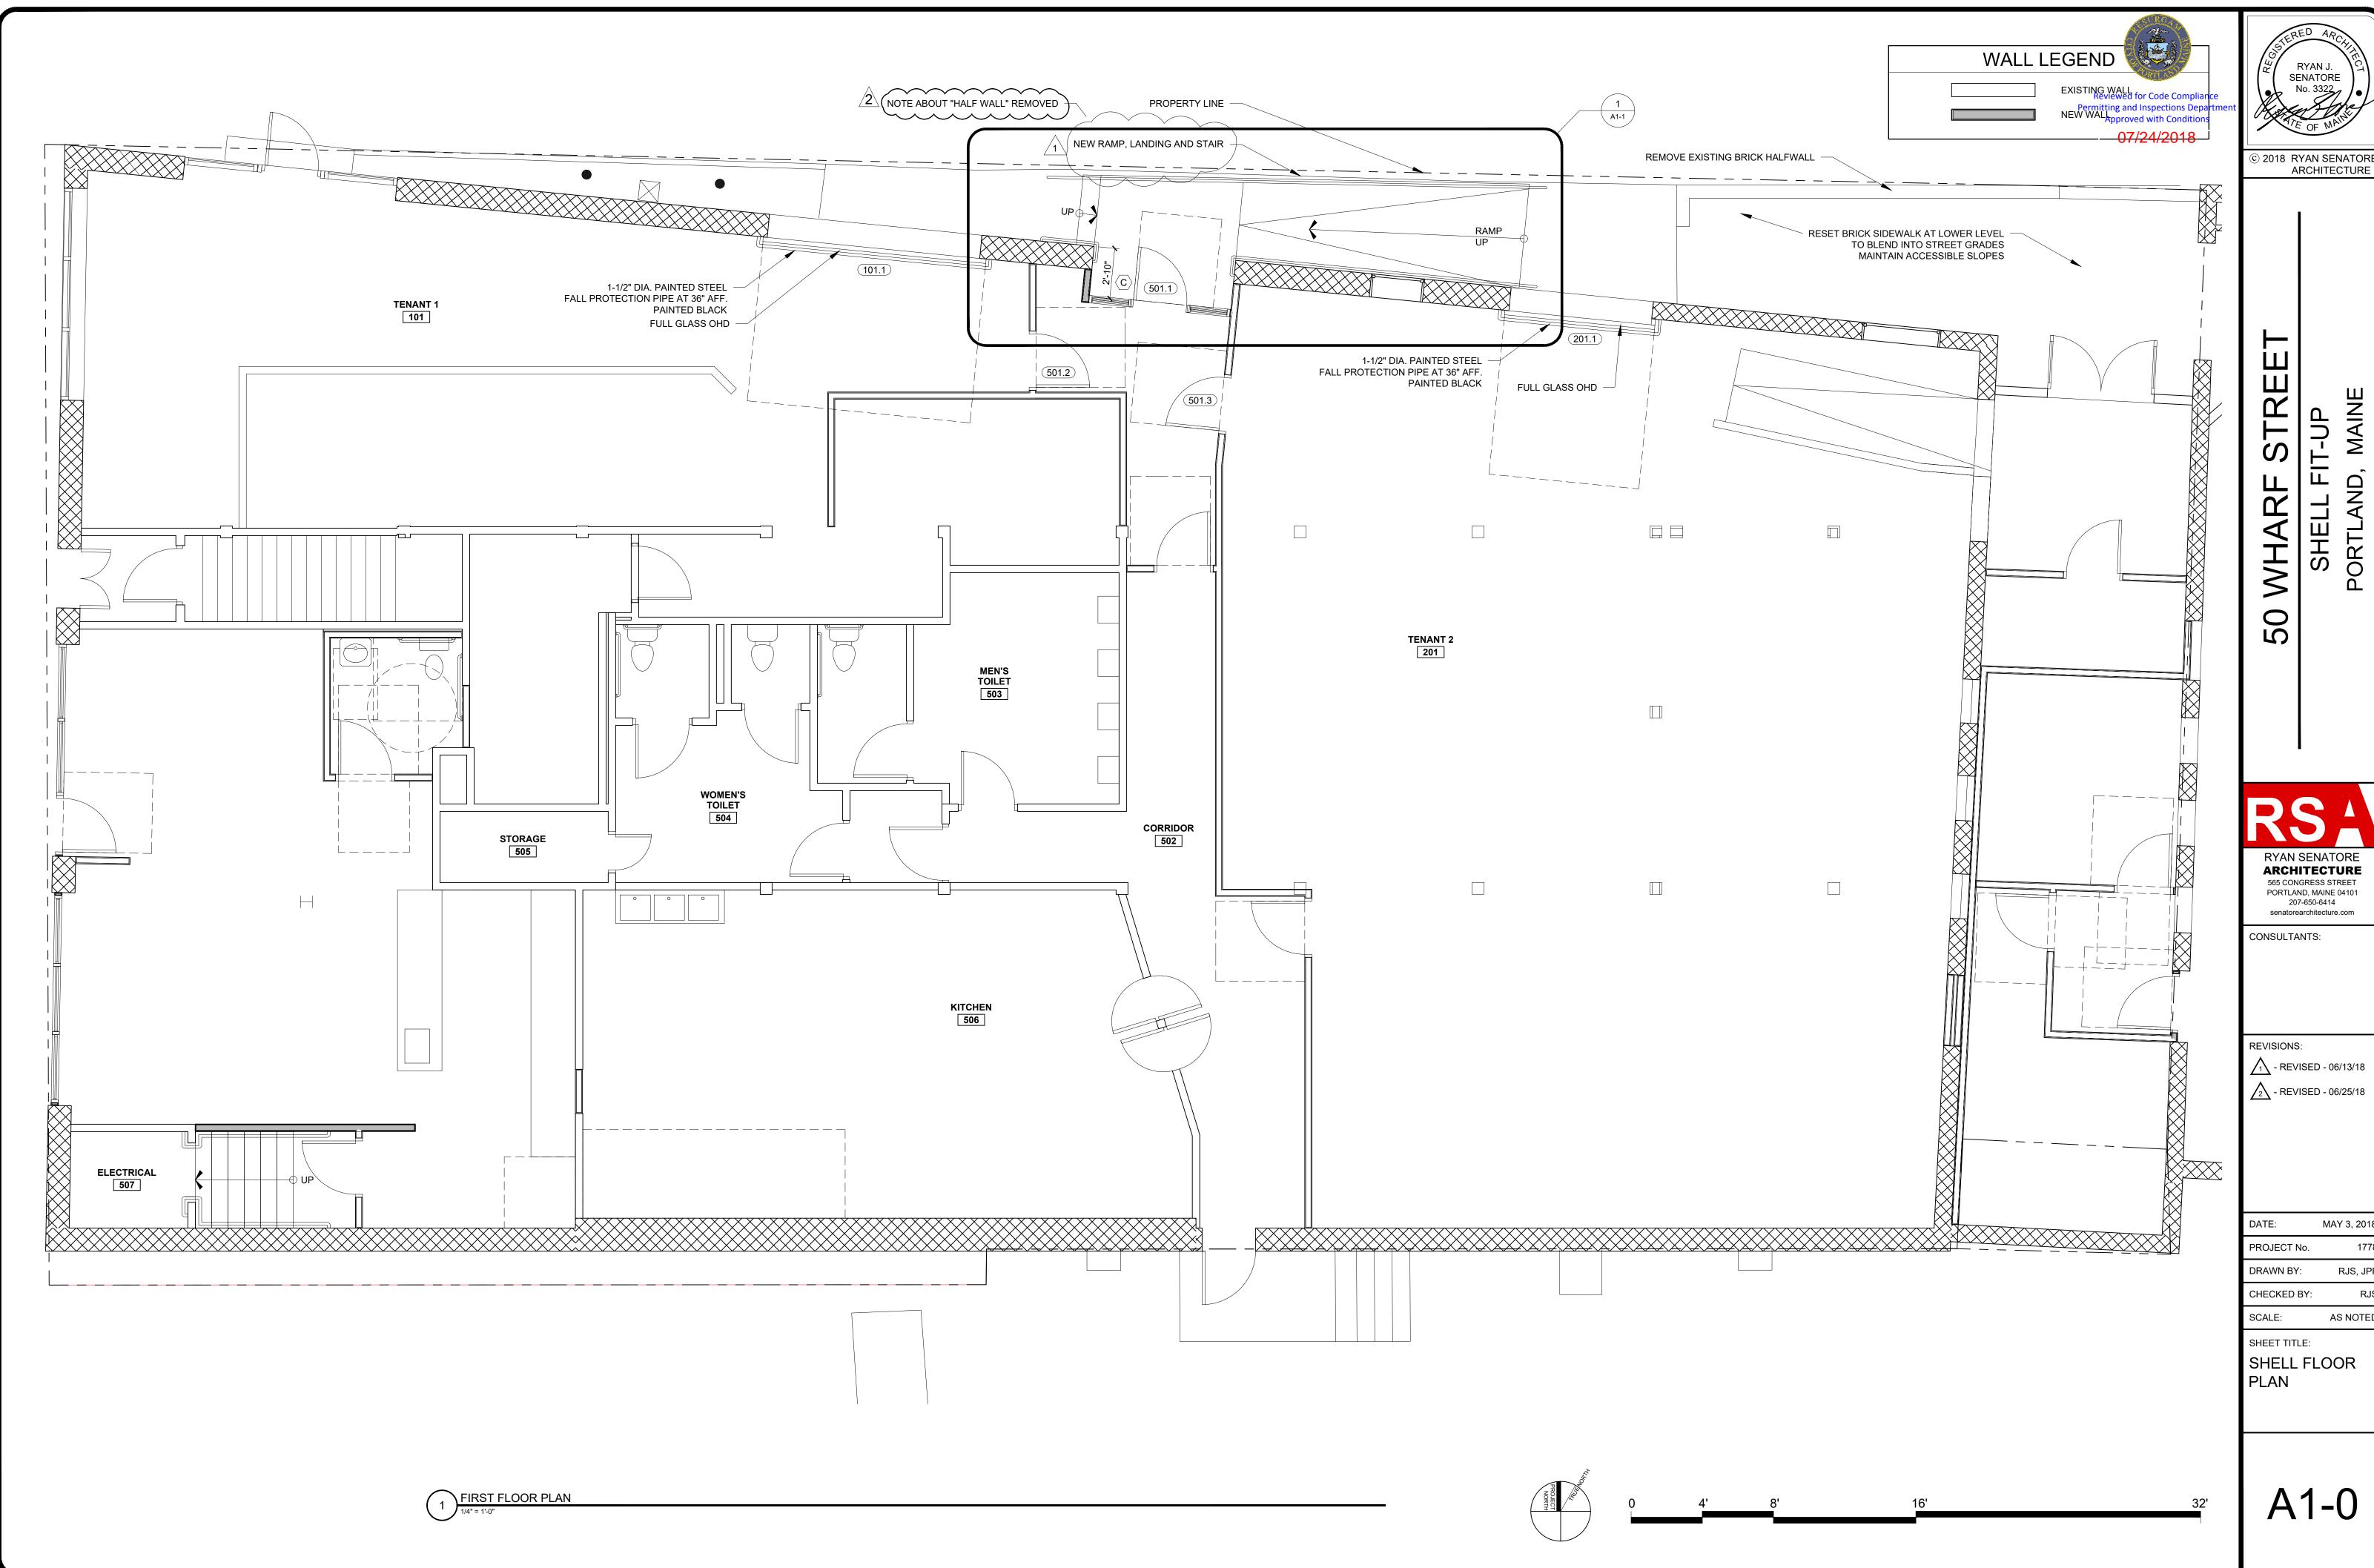


MAY 3, 2018

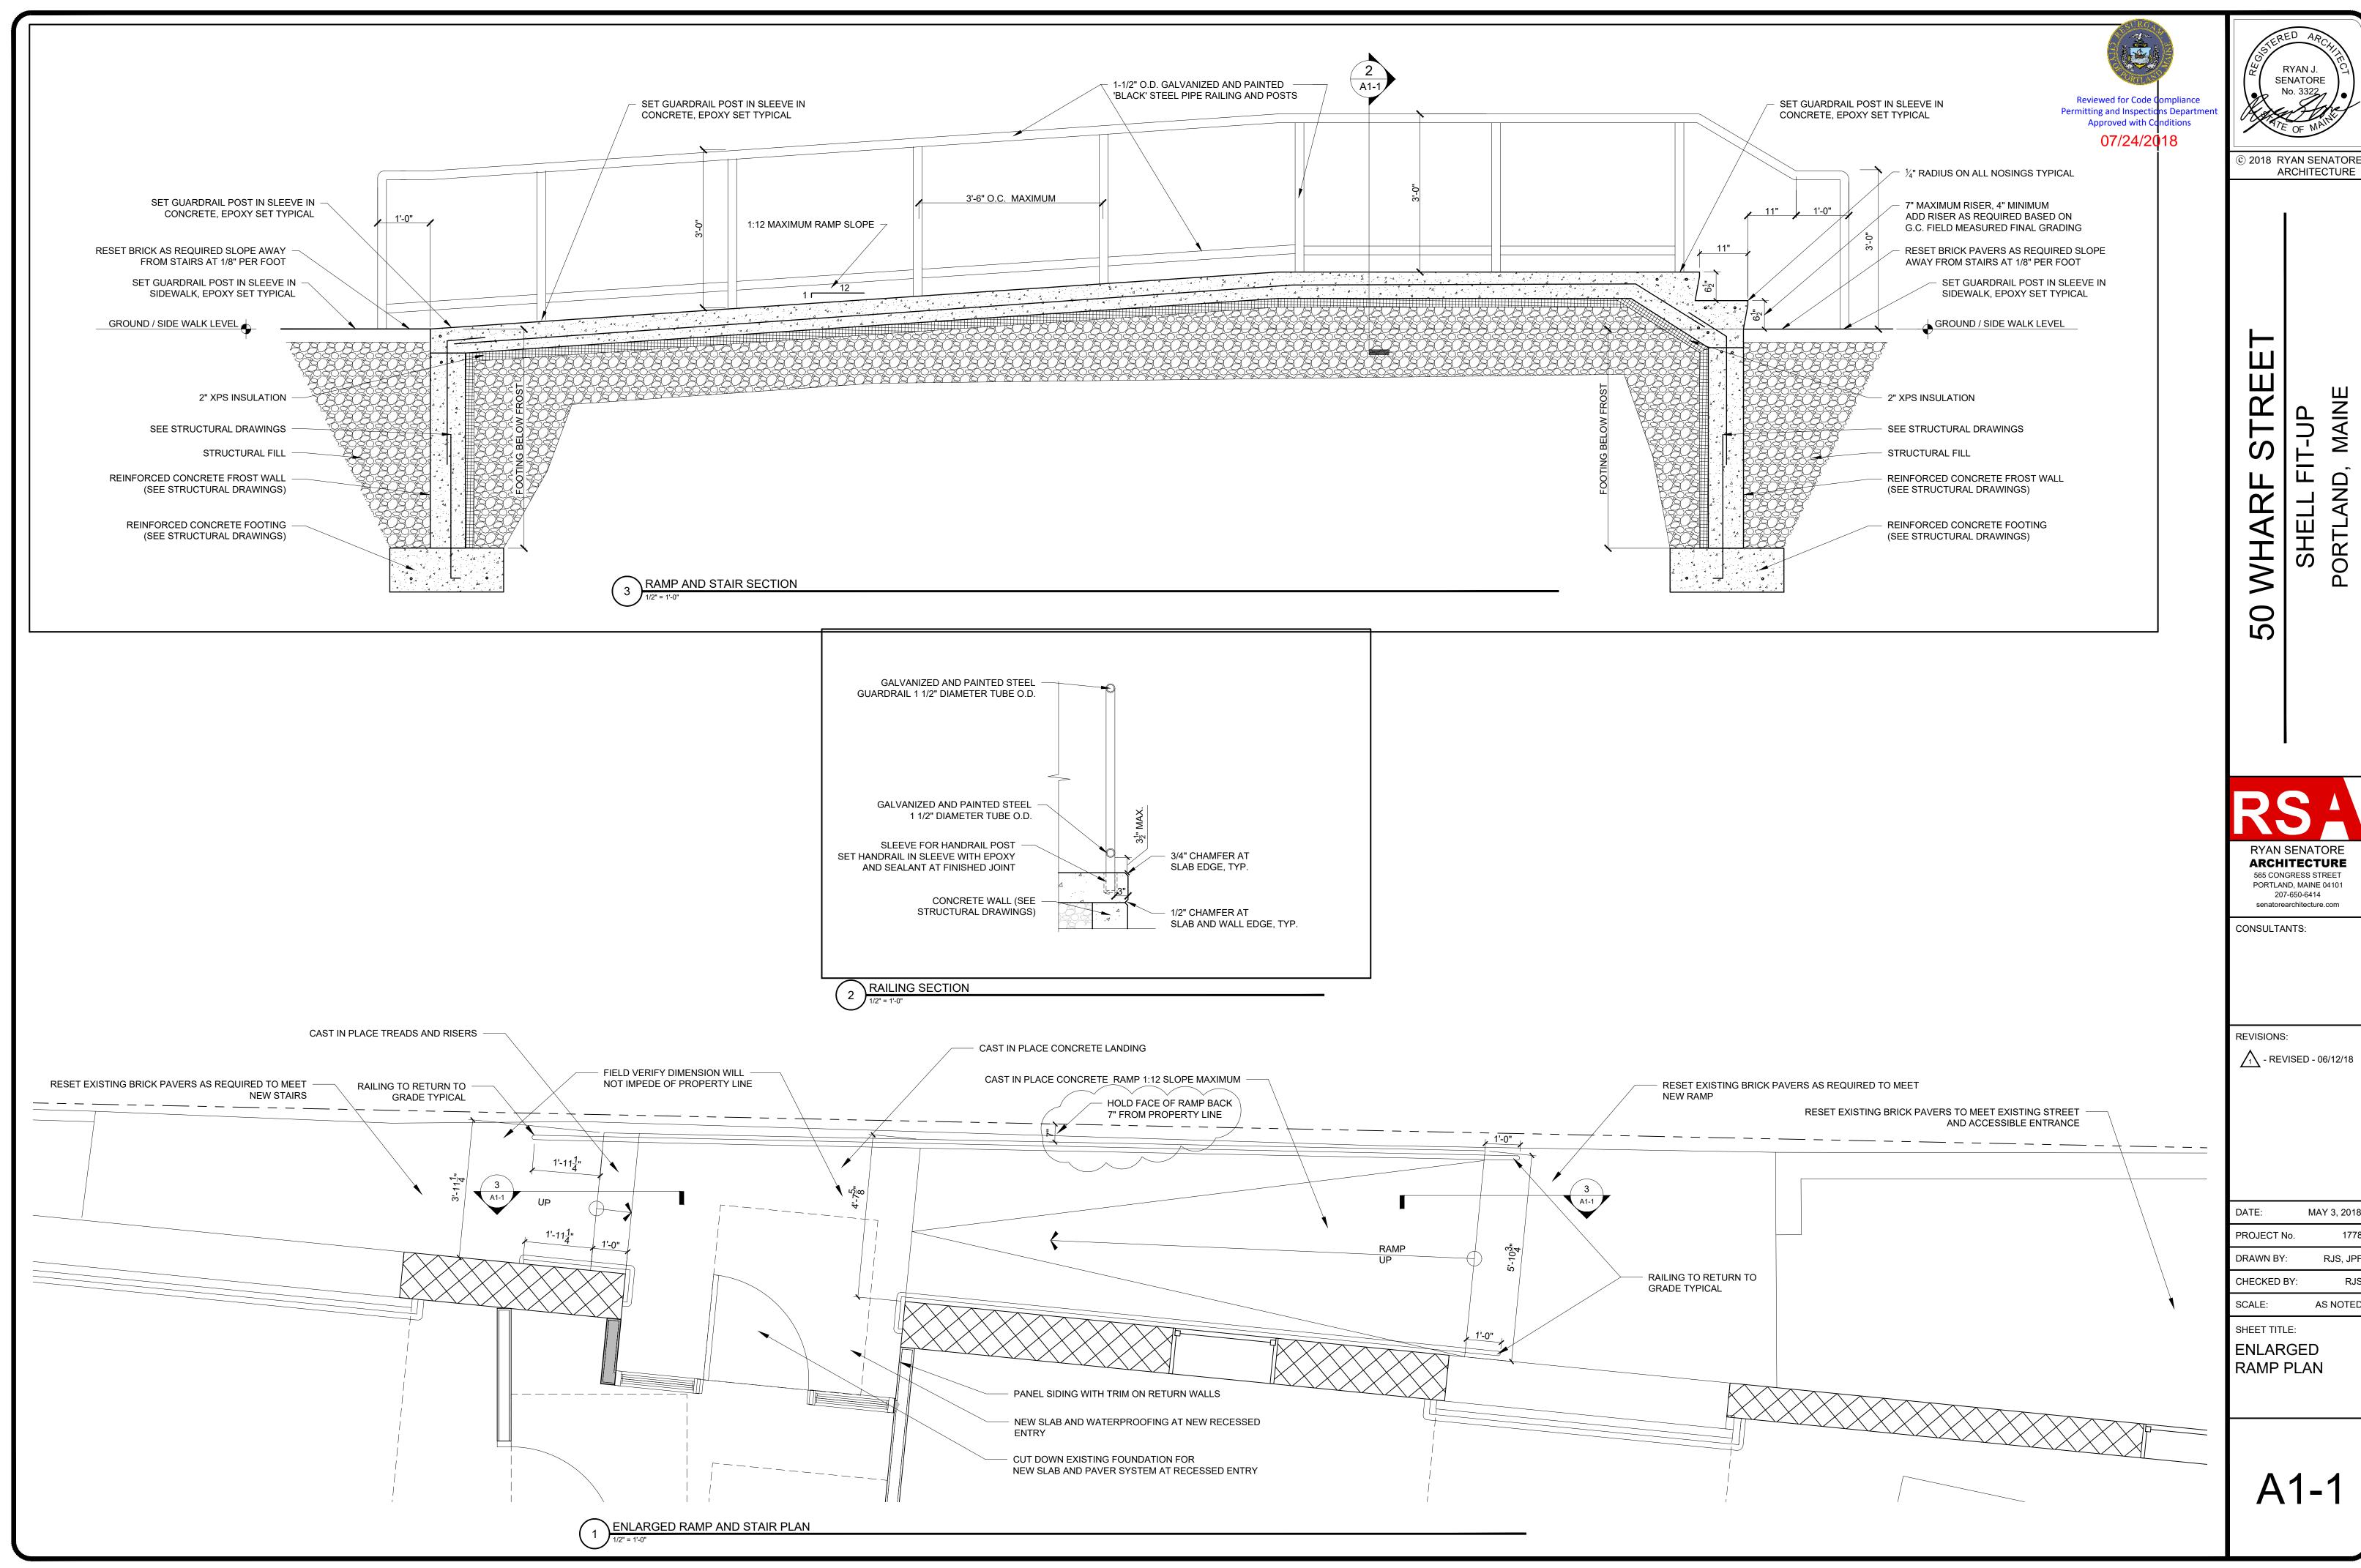



MAY 3, 2018



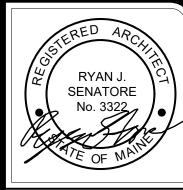

PORTLAND,

RYAN SENATORE **ARCHITECTURE** 565 CONGRESS STREET PORTLAND, MAINE 04101

CONSULTANTS:

207-650-6414 senatorearchitecture.com

REVISIONS:


1\ REVISION - 06/25/18

MAY 3, 2018 PROJECT No. DRAWN BY: RJS, JPF CHECKED BY: AS NOTED

SCALE: SHEET TITLE:

ELEVATIONS 1



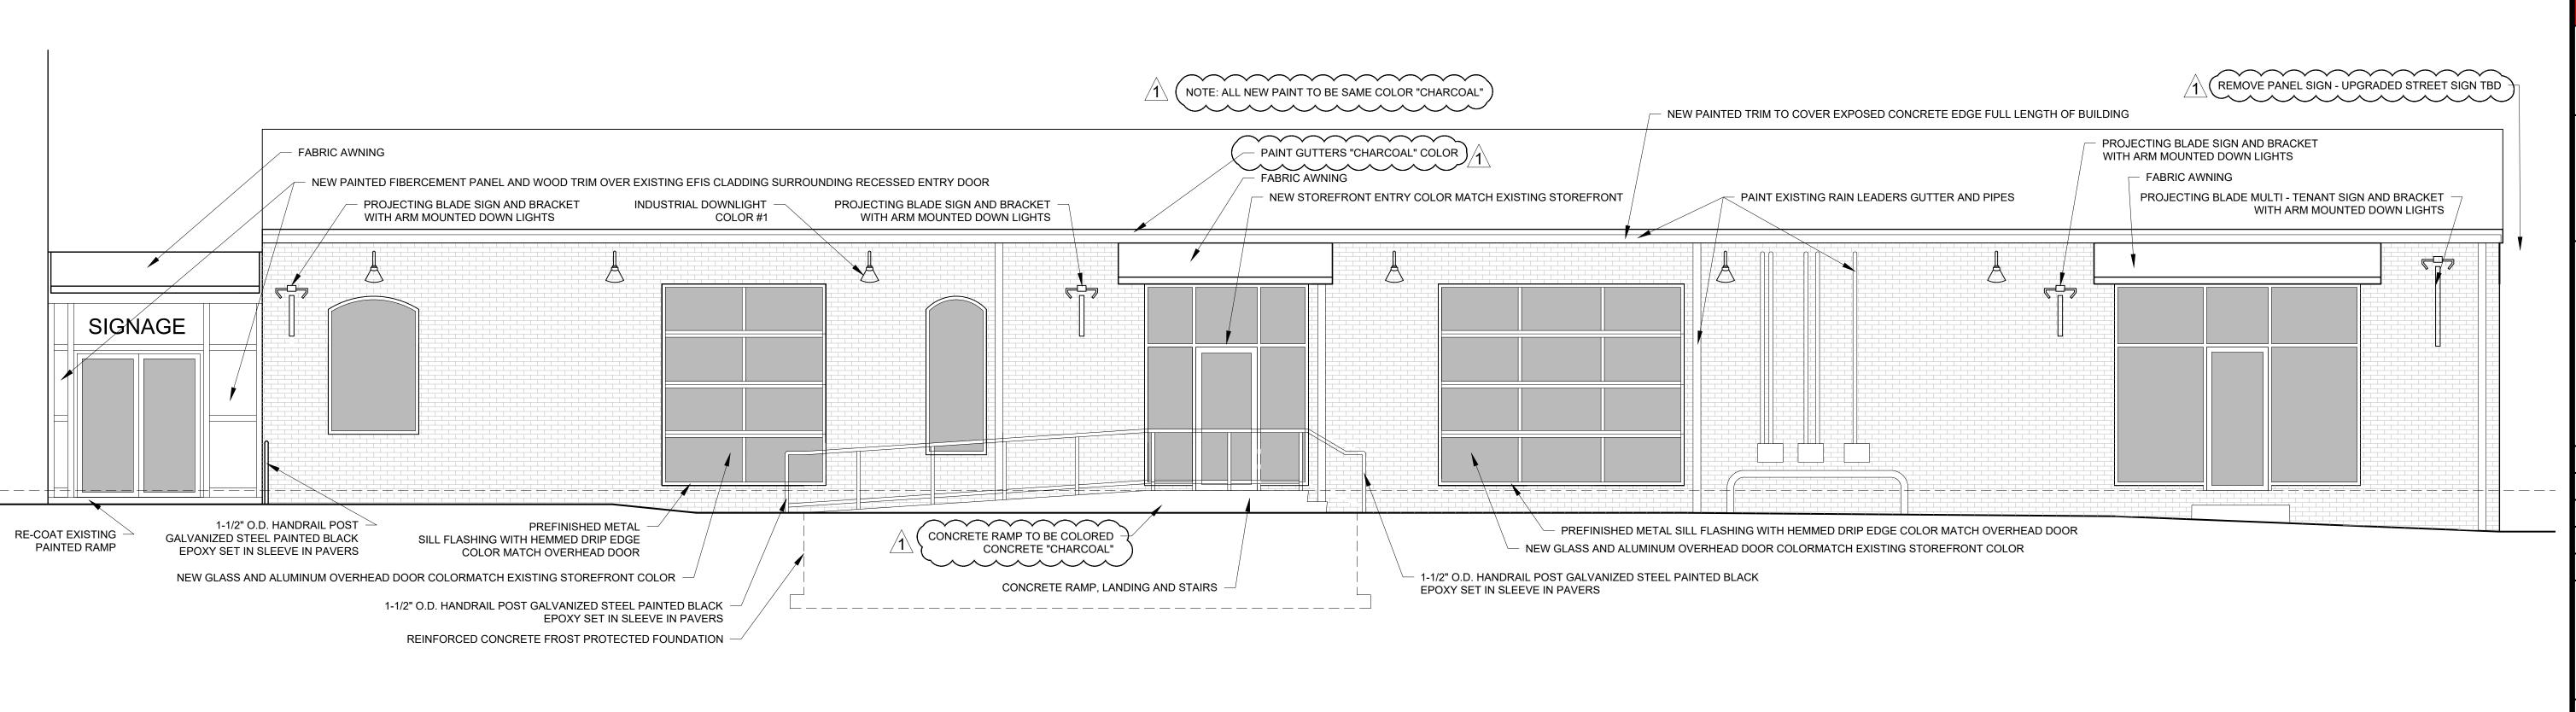

WHARF STREET ELEVATION





SHELL FI-PORTLAND, 50

RYAN SENATORE
ARCHITECTURE
565 CONGRESS STREET
PORTLAND, MAINE 04101
207-650-6414
senatorearchitecture.com

CONSULTANTS:

REVISIONS:

MAY 3, 2018 PROJECT No. CHECKED BY: AS NOTED SCALE:

SHEET TITLE: RENDERINGS

VIEW LOOKING WEST ON WHARF STREET

1/4" = 1'-0"



1 VIEW LOOKING EAST ON WHARF STREET



DOOR NOTES:

2.) FRAME ALL OPENINGS WITH ELEVATIONS

4.) ALL DOOR HARDWARE TO BE 'LEVER' TYPE

1.) ALL EXTERIOR GLAZING TO BE LOW-E ARGON FILLED INSULATED GLAZING UNITS

3.) SEAL EXTERIOR DOORS TO ROUGH OPENING WITH LOW EXPANDING FOAM INSULATION - SEE DETAILS

SENATORE No. 3322 07/24/2018

© 2018 RYAN SENATORE ARCHITECTURE

SHELL FI PORTLAND,

RYAN SENATORE

ARCHITECTURE

565 CONGRESS STREET

PORTLAND, MAINE 04101

207-650-6414

senatorearchitecture.com

CONSULTANTS:

REVISIONS:

MAY 3, 2018 PROJECT No. RJS, JPF DRAWN BY: CHECKED BY:

SCALE: AS NOTED SHEET TITLE:

DOOR SCHEDULE

	5.) ALL EXTERIOR DOORS TO BE WEATHERSTRIPPED6.) ALL DOORS TO HAVE SOLID CORES
BLACK' COLOR FRAME Solution Soluti	FRAME TYPES:
SUB-FLOOR ELEVATION	GLAZING SCHEDULE KEY GLAZING TYPE GL-1 INSULATED CLEAR TEMPERED GLAZING GL-2 FIRE RATED INSULATED GLAZING GL-3 CLEAR TEMPERED GLASS GL-4 CLEAR INSULATED TEMPERED GLASS GL-5 FIRE RATED GLAZING
A B C D E DOOR TYPES	1 2 STEEL

DOOR SCHEDULE																				
DOOR							FRAME							GENERAL						
'PE	IDTH	SIZE 날	HCKNESS	ATERIAL	HSIN	SULATED	'PE	ATERIAL	HRESHOLD				.OSER	RE RATING INUTES)	F.O.B. ACCESS	PH - PEEPHOLE LENSE				
	<u> </u>			-		Ž v							ਰ -		Ĕ	E REMARKS FULL GLASS ALUMINUM OVERHEAD DOOR, VERIFY SIZE WITH EXISTING OPENING				
C	<u> </u>				PTD	Y	-	_	-	-	_	_	-	_	-	FULL GLASS ALUMINUM OVERHEAD DOOR, VERIFY SIZE WITH EXISTING OPENING				
D	3'-0"				PTD	Υ	-	AL	-	-	-	-	Υ	<u> </u>	-	STOREFRONT DOOR WITH SIDELIGHTS AND TRANSOM, PANIC HARDWARE, THERMALLY BROKEN				
В	3'-0"	7'-0"	1 3/4"	STL	PTD	Υ	2	STL	-	-	-	-	Υ	60	-	PANIC HARDWARE				
В	3'-0"	7'-0"	1 3/4"	STL	PTD	Y	2	STL	-	-	-	-	Υ	60	-	PANIC HARDWARE				
	D B	E 10'-0" C 8'-0" D 3'-0" B 3'-0"	B 3'-0" 7'-0"	SIZE SIZE	SIZE Harmonia SIZE	SIZE	SIZE HANDER HAND	SIZE B 10'-0" 9'-10" 1 3/4" AL PTD Y - B 3'-0" 7'-0" 1 3/4" STL PTD Y 2	SIZE	SIZE	SIZE	SIZE	SIZE	DOOR FRAME DETAILS DETAILS	DOOR FRAME DETAILS DETAILS	DOOR FRAME DETAILS DETAILS DETAI				





UNION STREET PORTLAND, MAINE

RYAN SENATORE
ARCHITECTURE
565 CONGRESS STREET
PORTLAND, MAINE 04101
207-650-6414 senatorearchitecture.com

CONSULTANTS:

REVISIONS:


DATE: 20 FEBRUARY 2018 DRAWN BY: RRT, RJS, JP CHECKED BY:

SCALE: AS NOTED SHEET TITLE: PHOTOS



4 EXISTING VIEW LOOKING EAST ON WHARF STREET

PAINT ALL GUTTERS - "CHARCOAL" (TYICAL)

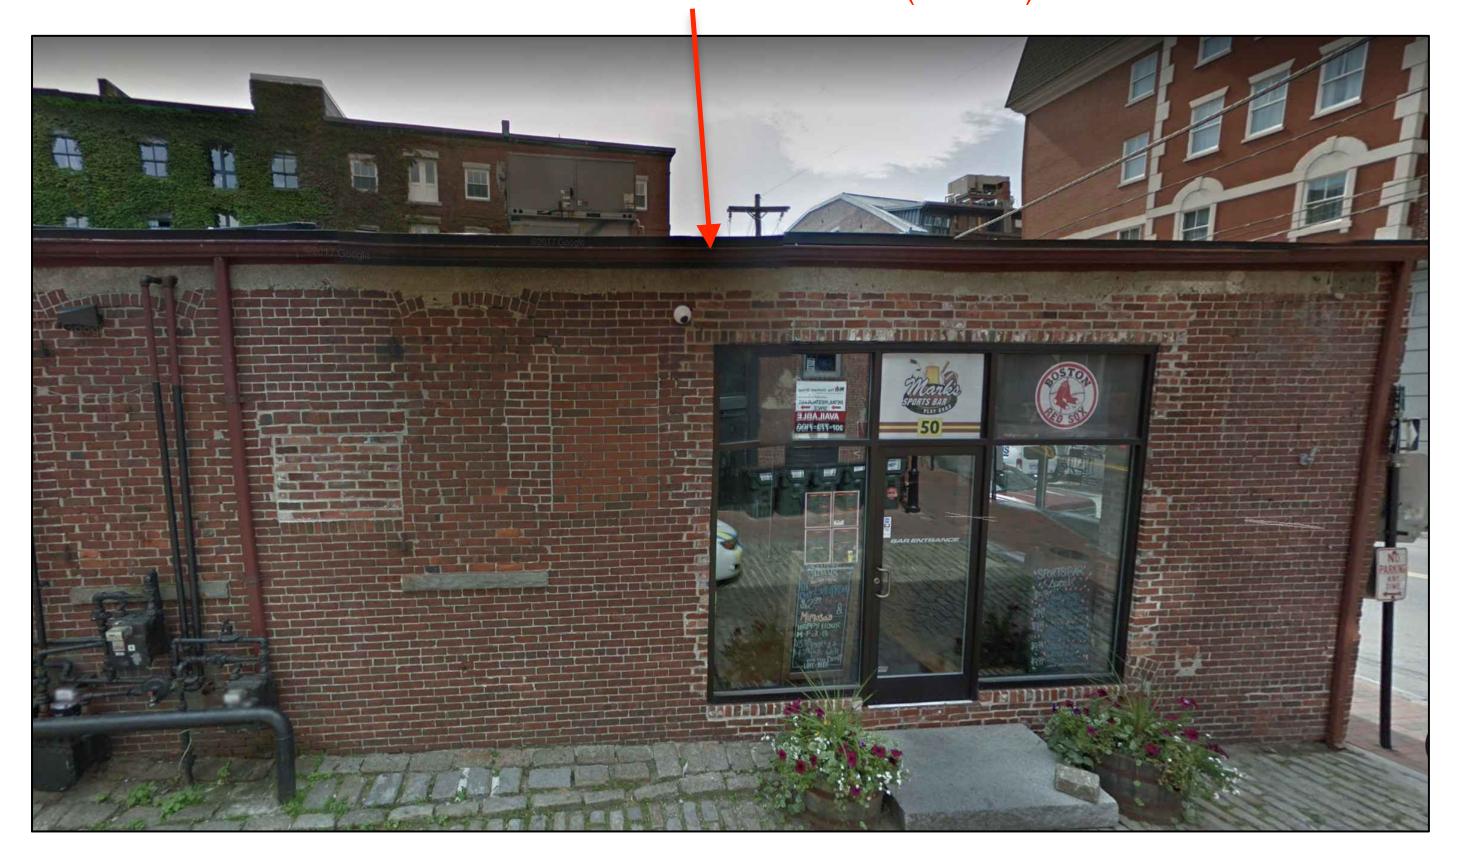


EXISTING VIEW LOOKING SOUTH ON WHARF STREET



2 EXISTING VIEW LOOKING WEST ON WHARF STREET


PAINT ALL EXISTING TRIM - "CHARCOAL" (TYICAL)

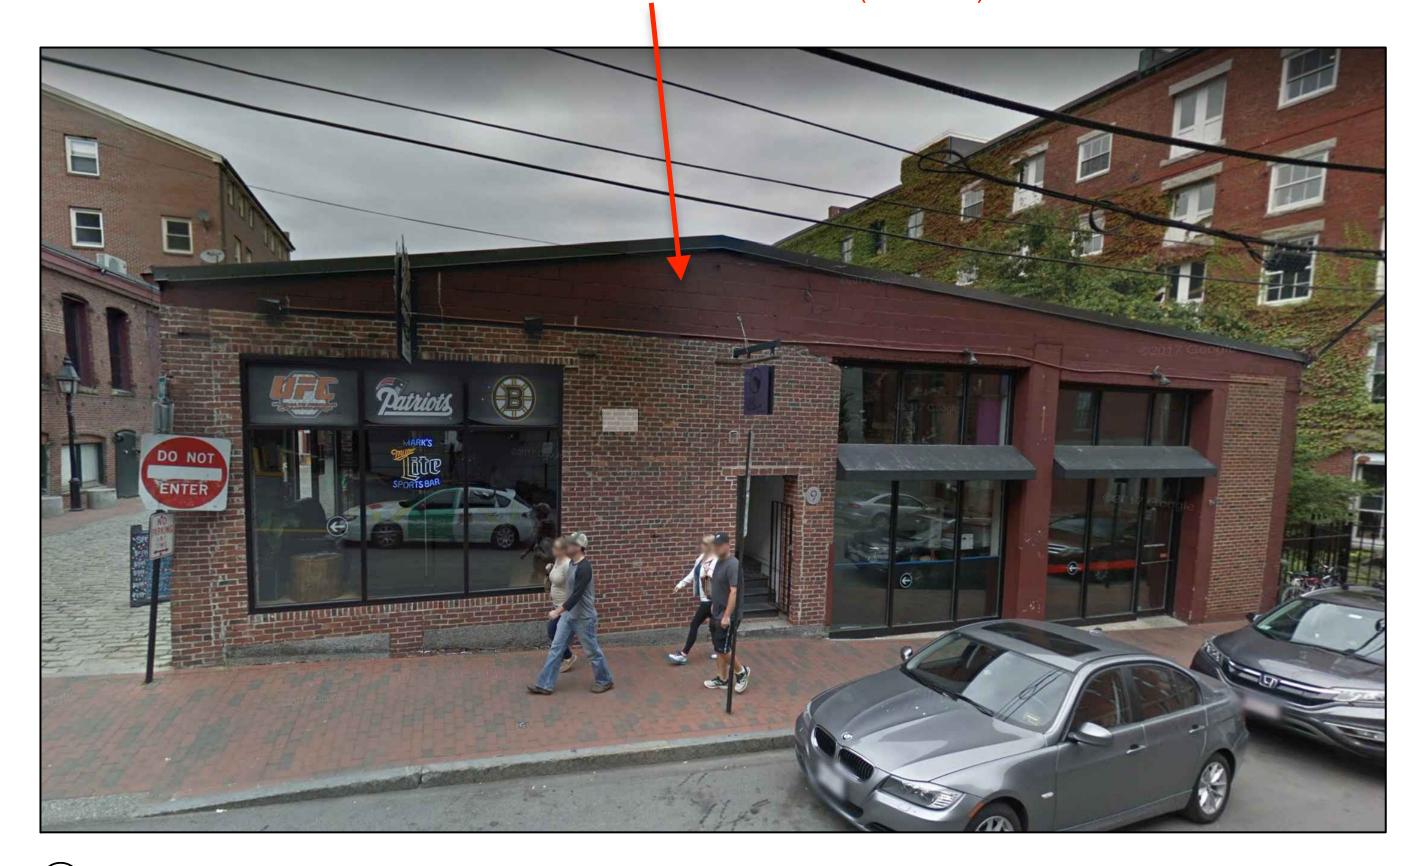

EXISTING VIEW FROM UNION STREET

P1



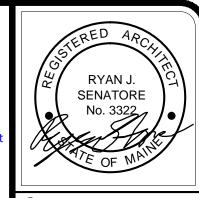

STREE

MAINE 50

RS 🐴 RYAN SENATORE ARCHITECTURE 565 CONGRESS STREET PORTLAND, MAINE 04101 207-650-6414

CONSULTANTS:

senatorearchitecture.com

REVISIONS:


MAY 3, 2018 PROJECT No.


DRAWN BY: CHECKED BY:

SCALE:

SHEET TITLE: RAMP

FOUNDATION AND SLAB

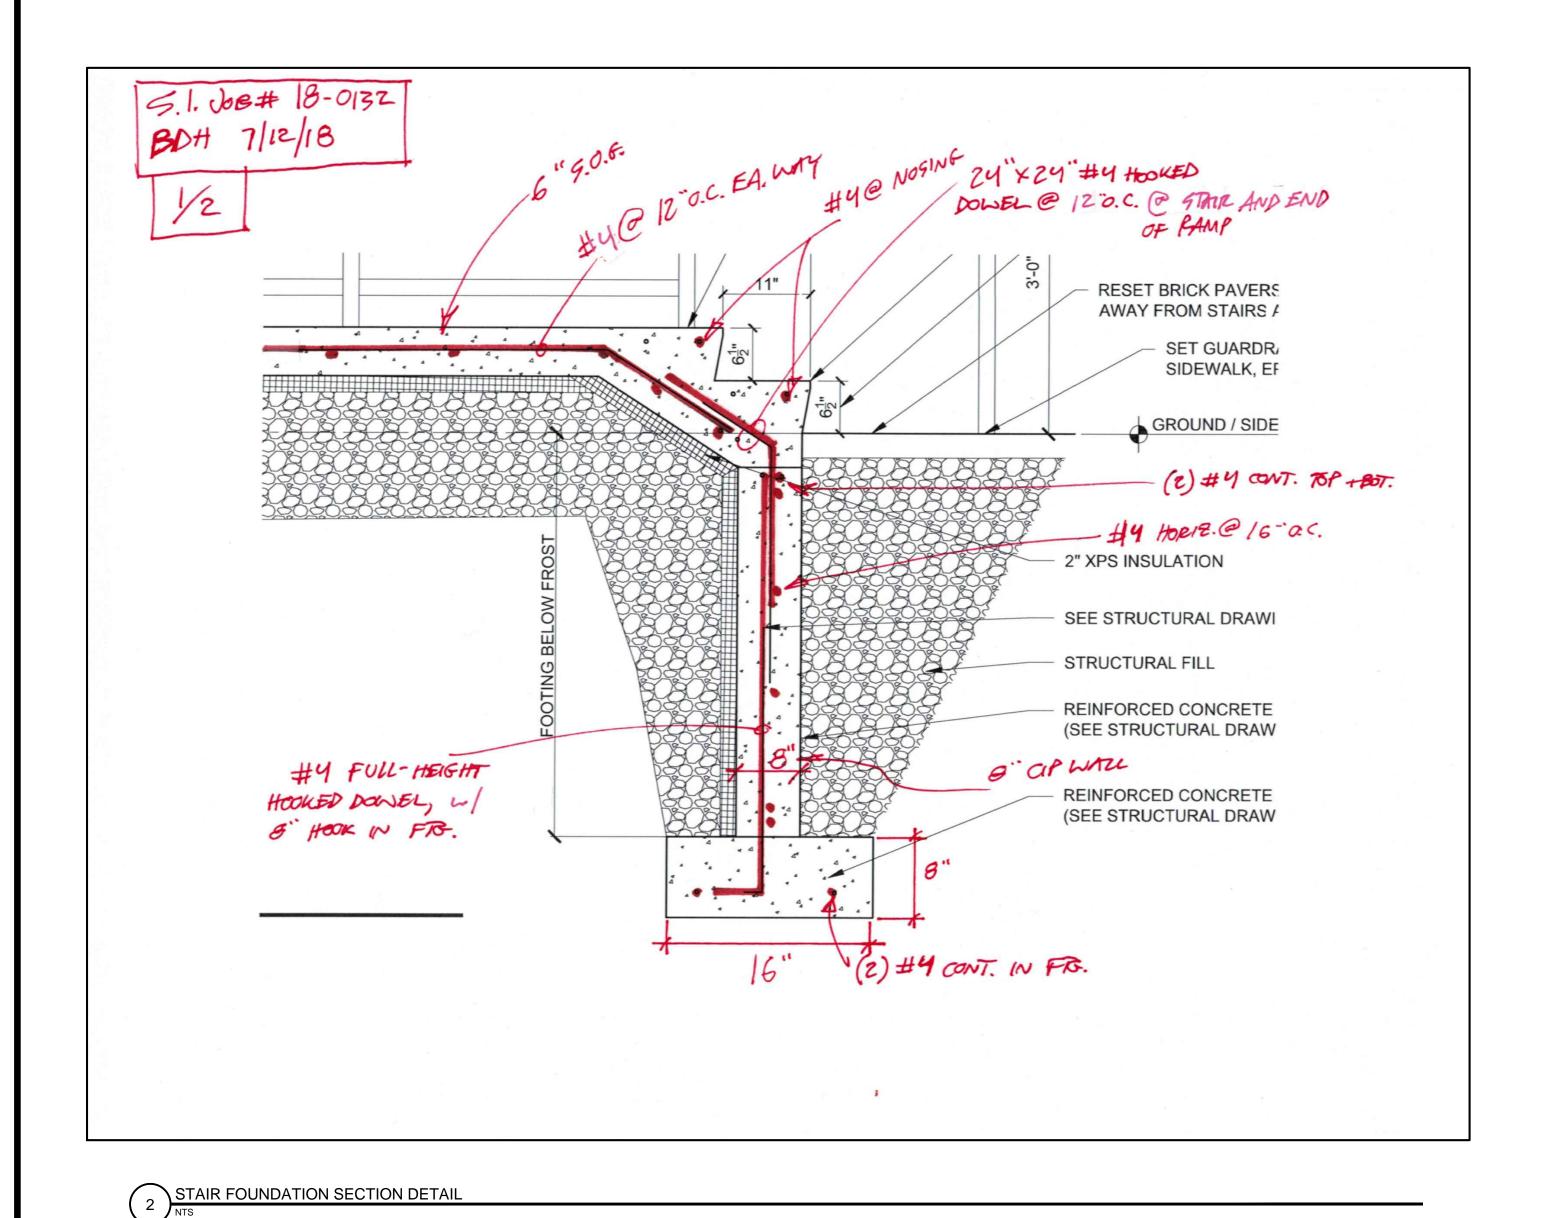

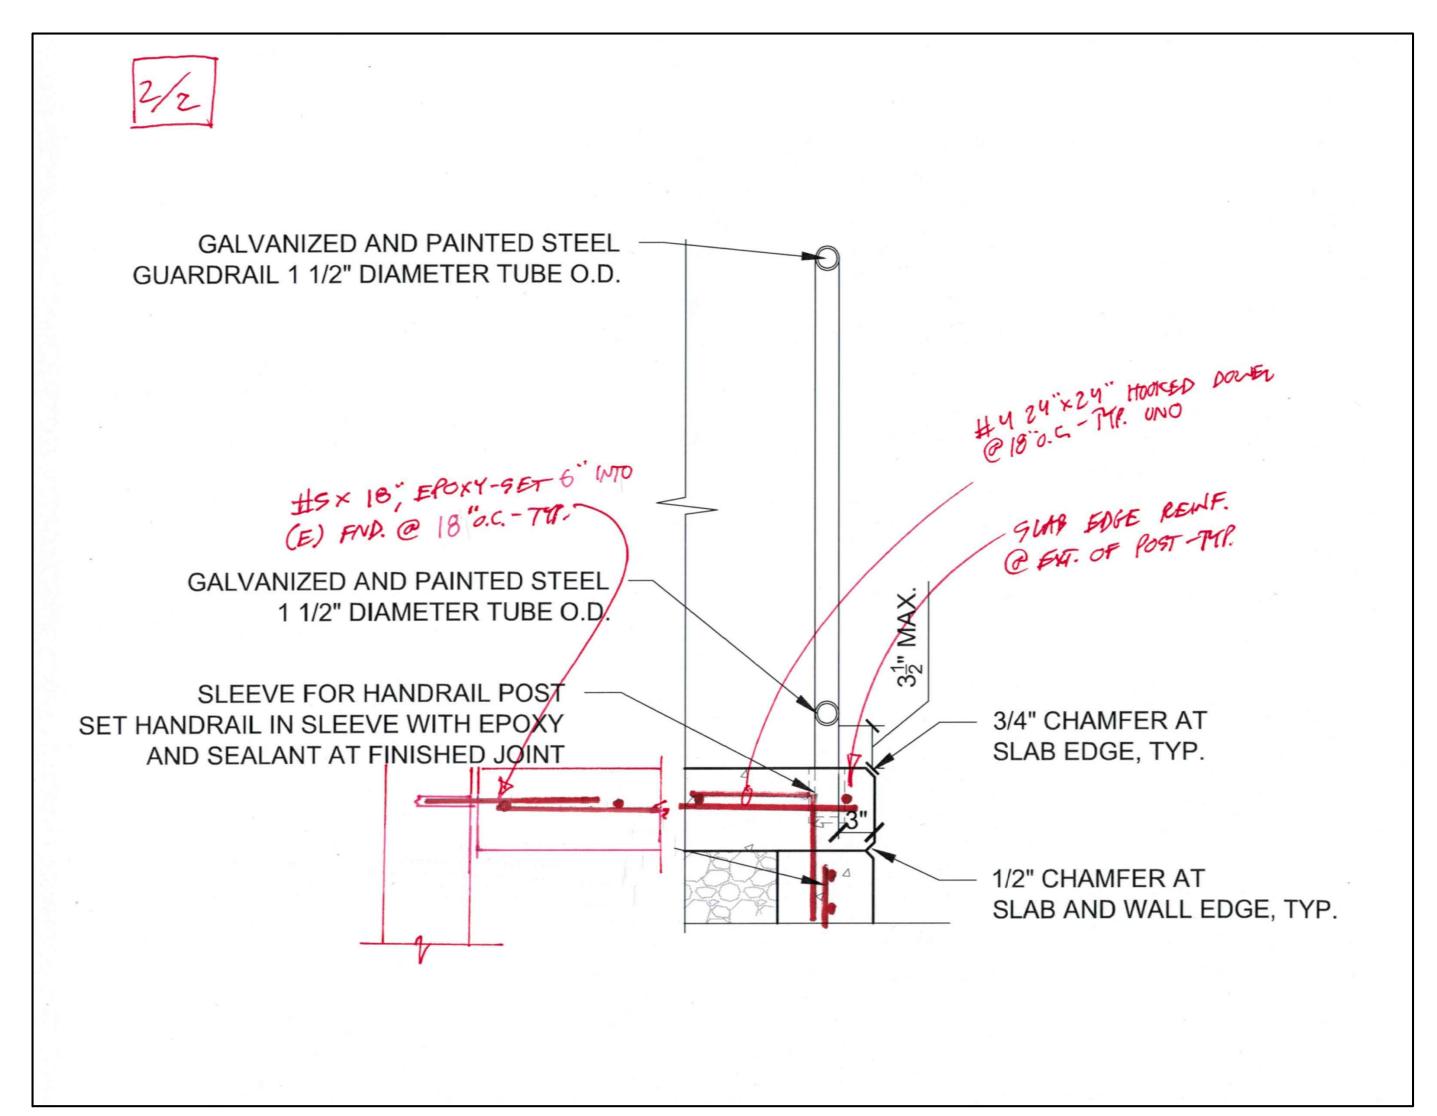

1 RAMP SECTION DETAIL