


HYDRAULIC CALCULATION INFORMATION							
LOCATION: 3RD FLR MEZZ, UNIT 3C (AREA #1)							
BASIS OF DESIGN: NFPA 13, 2016 EDITION DENSITY AREA OF COVERAGE .1 (4) SPRINKLERS (K=4.9)							
OCCUPANCY: RESIDENTIAL							
SPRINKLERS:	TOTAL 4	THRD 1/2"	ORIFICE 7/16"	TEMP 155			
SYSTEM DEMAND AT BASE OF RISER (BOR):							
PRESSURE		FLOW	HOSE				
95.87 PSI 81		39 GPM	0				
SAFETY MARGIN: 6.66 PSI							

HYDRAULIC CALCULATION INFORMATION						
LOCATION: 3RD FLR MEZZ, UNIT 3A (AREA #2)						
BASIS OF DESIGN: NFPA 13, 2016 EDITIONDENSITYAREA OF COVERAGE.1(4) SPRINKLERS (K=4.0)						
OCCUPANCY: RESIDENTIAL						
SPRINKLERS:	TOTAL TI 4 1	HRD /2"	ORIFICE 7/16"			
SYSTEM DEMAND AT BASE OF RISER (BOR):						
PRESSURE	FLO		HOS	E		
91.24 PSI	71.22 (GPM	0			
SAFETY MARGIN: 11.39 PSI						

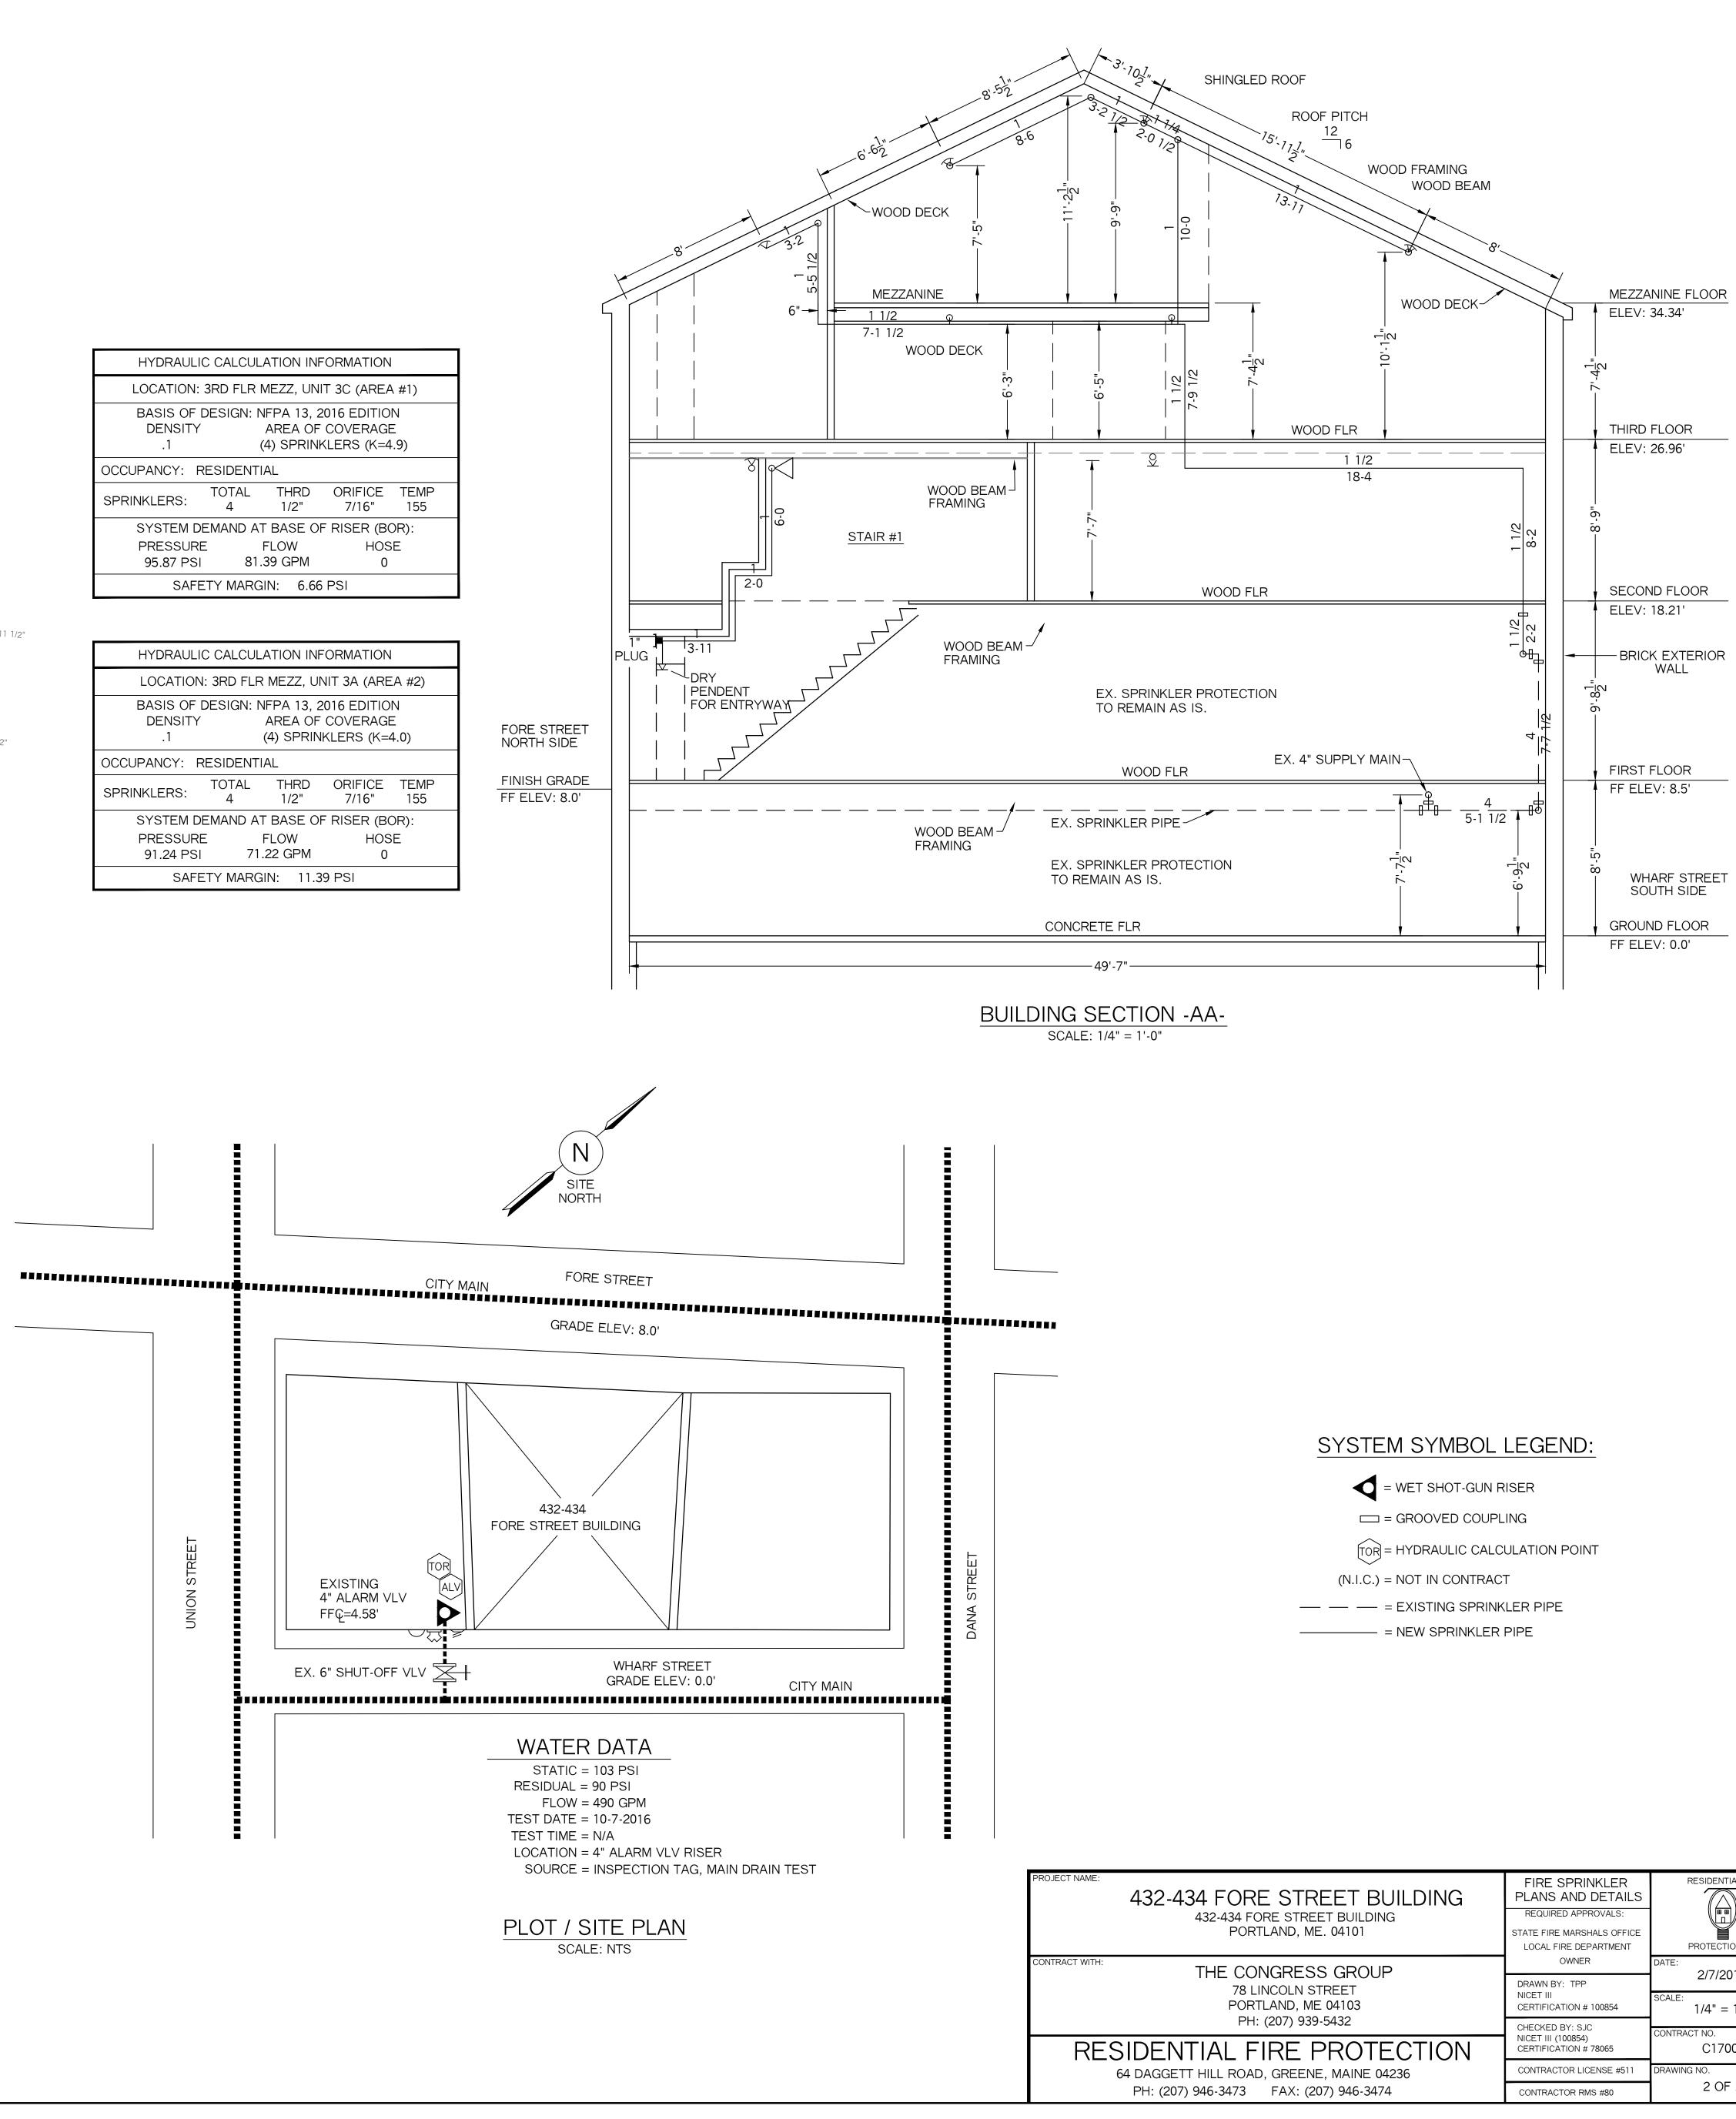

FIRE SPRINKLER PLANS AND DETAILS	RESIDENTIAL FIRE		
REQUIRED APPROVALS: STATE FIRE MARSHALS OFFICE LOCAL FIRE DEPARTMENT	PROTECTION, LLC		
OWNER	DATE: 2/7/2017		
DRAWN BY: TPP NICET III CERTIFICATION # 100854	SCALE: 1/4" = 1'-0"		
CHECKED BY: SJC NICET III (100854) CERTIFICATION # 78065	CONTRACT NO. C17002		
CONTRACTOR LICENSE #511	DRAWING NO.		
CONTRACTOR RMS #80	2 OF 2		