
## SOIL BEARING WALL AND COLUMN FOOTINGS DESIGNED FOR AN ASSUMED SOIL BEARING OF 2000 PSF. IF ADEQUATE SOIL BEARNIG IS NOT ENCOUNTERED AT THE INDICATED BOTTOM OF FOOTING LOCATION, CONTRACTOR IS TO REPORT TO THE ARCHITECT BEFORE PROCEEDING WITH THAT PART ALL EXCAVATIONS FOR THE FOUNDATION SHALL BE APPROVED BY THE ENGINEER BEFORE PLACING ANY CONCRETE FOOTINGS. CONCRETE STRENGTH OF CONCRETE AT 28 DAYS TO BE 3000 PSI. BOTTOM OF ALL FOOTINGS TO BE ON ADEQUATE SOILD BEARING. ALL SLABS ON FILL TO BE 4" THICK UNLESS NOTED OTHERWISE. CONCRETE REINFORCING ALL REINFORCING STEEL TO BE ASTM-A615 GRADE 60, DETAILED AND FABRICATED IN ACCORDANCE WITH THE "ACI MAUAL OF STANDARD PRACTICE" (ACI-315-LATEST). WOOD FRAMING ALL WOOD MARKED SPF OR NOT MARKED ON THE DRAWINGS ARE TO HAVE THE FOLLOWING MINIMUM ALLOWABLE WORKING STRESSES: HORIZONTAL SHEAR STRESS Fb = 875 PSI BENDING STRESS SINGLE MEMEBER USE MODULUS OF ELASTICITY E = 1400000 PSI COMPRESSION PARALLEL TO GRAIN Fc = 1150 PSI COMPRESSION PERPENDICULAR TO GRAIN Fc = 425 PSI ALL TIMBER FRAMING SHALL BE IN ACCORDANCE WITH THE AITC TIMBER CONSTRUCTION MANUAL - LATEST EDITION, AND THE NFPA NATIONAL DESIGN SPECIFICATION FOR WOOD CONSTRUCTION (NDS) 2005 EDITION. INDIVIDUAL TIMBER FRAMING SHALL BE VISUALLY GRADED, MINIMUM No1/No2 SPRUCE-PINE-FIR KILN DRIED TO 19% MAXIMUM MOISTURE CONTENT UNLESS NOTED OTHERWISE ON DRAWINGS. WOOD I-JOISTS (TJI), LAMINATED VENEER LUMBER (LVL) AND PARALLEL STRAND LUMBER (PSL) SHALL BE AS SPECIFIED ON THE DRAWINGS. PRESSURED TREATED LUMBER SHALL BE USED FOR SILL MEMBERS, EXTERIOR EXPOSURE, OR WHRE SHOWN ON THE DRAWINGS. TIMBER SHALL BE SOUTHERN YELLOW PINE TREATED WITH PRESERVATIVE. ALL PLYWOOD SHALL BE APA PERFORMACE RATED. PLYWOOD SHALL BE NAILED TO THE FRAMING AS FOLLOWS (U.N.O.): ROOFS: 8d NAILS AT 6" ON EDGES AND 12" AT INTERMEDIATE SUPPORTS. WALLS: 8d NAILS AT 6" ON EDGES AND 12" AT INTERMEDIATE SUPPORTS. FLOOR SHEATHING SHALL BE 5/8" APA PERFORMANCE RATED STURD-I- FLOOR TONGUE AND GROOVE PANELS. PLYWOOD SHALL BE BLUED/SCREWED TO FLOOR FRAMING AT 8" O.C. ALL BUILT-UP BEAMS AND COLUMNS SHALL BE NAILED AS FOLLOWS (MIN.): BEAMS: (2) 10d NAILS AT 12" O.C. IN EACH PIECE. COLUMNS: 10d NAILS AT 12" O.C. JOIST HANGERS, BEAM HANGERS, POST BASES AND CAP PLATES SHALL BE A

INDICATED ON THE DRAWINGS AND MANUFACTURED BY SIMPSON COMPANY.
REFER TO MANUFACTURER'S LITERATURE FOR PROPER HANDLING AND

CONTRACTOR SHALL VERIFY ALL DIMENSIONS AND EXISTING CONDITIONS

CONTRACTOR SHALL REPORT ANY VARIATIONS FOUND AT THE SITE BEFORE

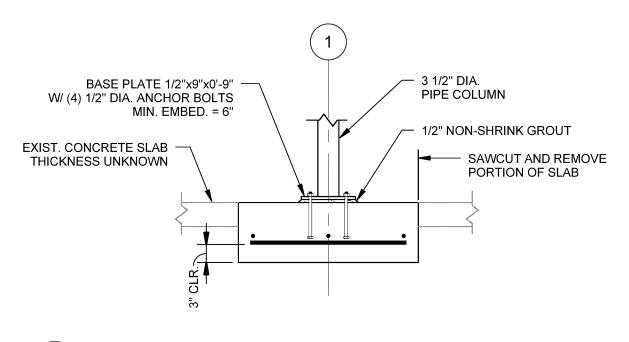



INSTALLATION GUIDELINES.

BEFORE PROCEEDING WITH THE WORK.

DESIGN CODE = 2009 IBC AND ASCE 7-05

lw = 1.00 (CATEGORY II)

EXPOSURE CATEGORÝ = C

INT. PRESSURE COEF. (GCpi) = +/- 0.18

PROCEDDING WITH THAT PART OF THE WORK.

RESTAURANT AND BAR = 100 PSF

BASIC WIND SPEED (V) = 100 MPH (3 SEC GUST)

MISCELLANEOUS

DESIGN INFORMATION

LIVE LOADS:


SNOW LOAD:


WIND LOAD:

Pg = 60 PSF Ce = 1.0 Ct = 1.0 Is = 1.0 Pf = 42 PSF

SECTION AT CONCRETE FOOTING

SCALE: 3/4" = 1'-0"

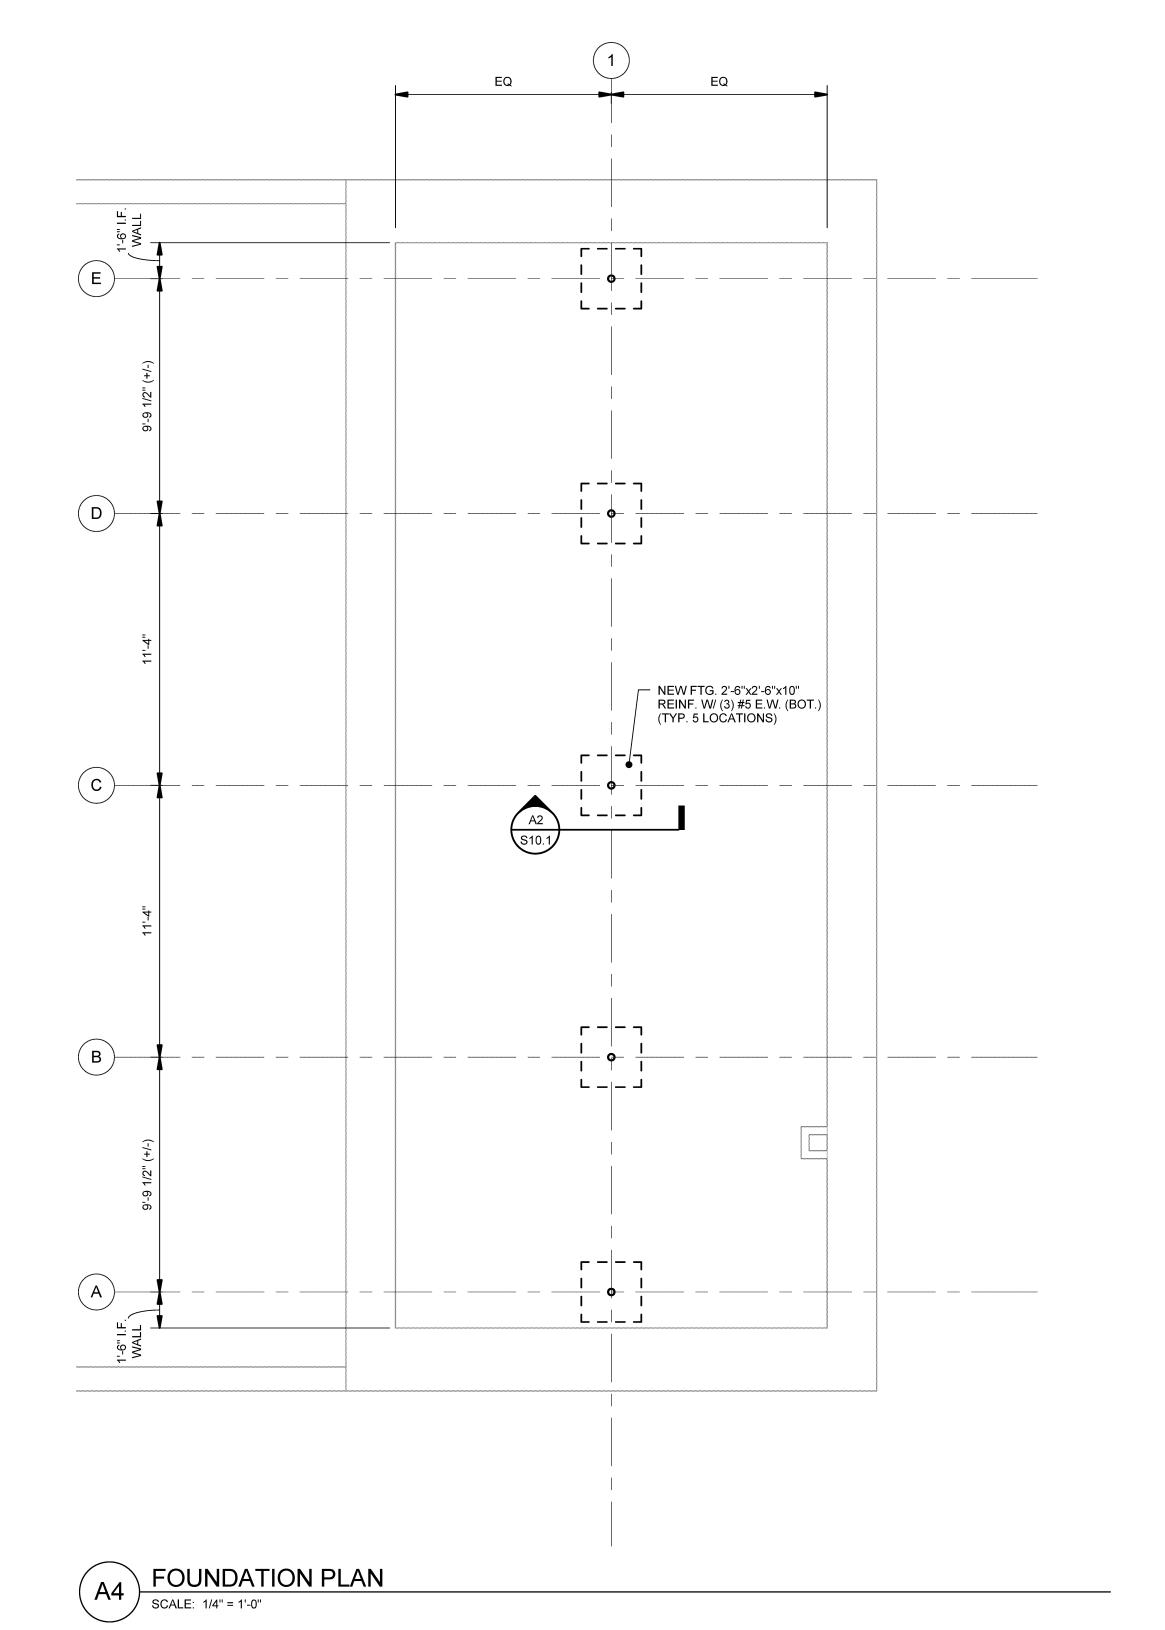

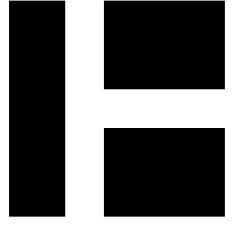

## HARRIMAN

AUBURN PORTLAND MANCHESTER

## **GOULD RESTAURANT**


414 FORE STREET PORTLAND, ME 04101

FORTEAND, INIC 04101	
Harriman Project No.	12752
Key Plan	Proj North

Issues and Revisions

Mark Date Description

- 05-31-13 ISSUED FOR CONSTRUCTION

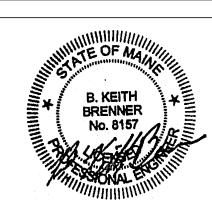

Drawing Scales As indicated	0 2' 4' 6'
0 6" 1' 2' 3/4" = 1'-0"	v an kan
No. Alexander	N. Mariena
PA / PE: BKB	© 2013 Harriman Associates
Drawn By: MRM	

FOUNDATION PLAN, NOTES AND DETAILS

S10.1