


DOOR AND FRAME SCHEDULE																	
DOOR NO.	LOCATION			DOOR						FRAME				HARDWARE SET	COMMENTS		
	ROOM NO.	ROOM NAME	PANEL QTY	PANEL TYPE	PANEL WIDTH	HEIGHT	THICK	MATL	FINISH		TYPE	FINISH				DETAILS	
									PUSH	PULL		PUSH	PULL			HEAD	JAMB
1030B	1001	ELEVATOR LOBBY	SINGLE	AG-R	3'-0"	8'-6"	1/2"	EX	EX	EX	EX	EX	EX	EX	EX	EX	EXISTING TO REMAIN
1030C	1001	ELEVATOR LOBBY	SINGLE	AG-R	3'-0"	8'-6"	1/2"	EX	EX	EX	EX	EX	EX	EX	EX	EX	EXISTING TO REMAIN
1030D	1030 (EX)	OPEN OFFICE	SINGLE	AG-R	3'-0"	8'-6"	1/2"	GL	CLR	CLR				6/A00.31	3	CARD READER	
1030E	1030 (EX)	OPEN OFFICE	SINGLE	AG-R	3'-0"	8'-6"	1/2"	GL	CLR	CLR				6/A00.31	3	CARD READER	
1030F	1030 (EX)	OPEN OFFICE	SINGLE	AG-R	3'-0"	8'-6"	1/2"	GL	CLR	CLR				6/A00.31	3	CARD READER	
1030G	1030 (EX)	OPEN OFFICE	SINGLE	AG-R	3'-0"	8'-6"	1/2"	GL	CLR	CLR				6/A00.31	3	CARD READER	
1039	1039	OPEN OFFICE	SINGLE	AG-R	3'-0"	8'-6"	1/2"	GL	CLR	CLR				6/A00.31	3	CARD READER	
1046	1046	OFFICE	SINGLE	F	3'-0"	8'-4 1/2"	1 3/4"	WD	STN	STN	1	CLR	CLR	1/A00.31	2/A00.31	1	
1047	1047	APPLICATION ROOM	SINGLE	F	3'-0"	8'-4 1/2"	1 3/4"	WD	STN	STN	1	CLR	CLR	1/A00.31	2/A00.31	2	
1048	1048	OFFICE	SINGLE	F	3'-0"	8'-4 1/2"	1 3/4"	WD	STN	STN	1	CLR	CLR	1/A00.31	2/A00.31	1	


HARDWARE SETS		
DESCRIPTION	SPECIFICATION	COMMENTS
HS-1		
FULL MORTISE HINGES, 4.5"x4.5"	BB1191, WHITE METAL	
PASSAGE FUNCTION LATCHSET	SL8890 SERIES: YALE, MONROE SERIES, LN ROSE, US26D	
DOOR STOP - FLOOR MOUNTED	IVES FS436	
DOOR SILENCER	DON-JO 1608	
COAT HOOK	PETER PEPPER PRODUCTS 2012, POLISHED ALUMINUM	
HS-2		
FULL MORTISE HINGES, 4.5"x4.5"	BB1191, WHITE METAL	
PASSAGE FUNCTION LATCHSET	SL8890 SERIES: YALE, MONROE SERIES, LN ROSE, US26D	
DOOR STOP - FLOOR MOUNTED	IVES FS436	
DOOR SILENCER	DON-JO 1608	
HS-3		
CENTER POINT PIVOT SET	MODEL 178, FINISH 626	
BACK TO BACK BAR PULL	ROCKWOOD SKEWTEK RM 4200, BRUSHED STAINLESS STEEL	
ANGLE STOP WITH SILENCER AT HEAD	IVES AS895, FINISH 626	
CONCEALED OVERHEAD CLOSER	RTS 88 SERIES, FINISH 626	
MAGNETIC LOCK	M490 SENSOR LOCK, FINISH 628B	
PUSH BUTTON RELEASE	M490 SENSOR LOCK, FINISH 628B	
AUTO EGRESS MOTION SENSOR	M490 SENSOR LOCK, FINISH 628B	
CARD READER		BY SECURITY VENDOR

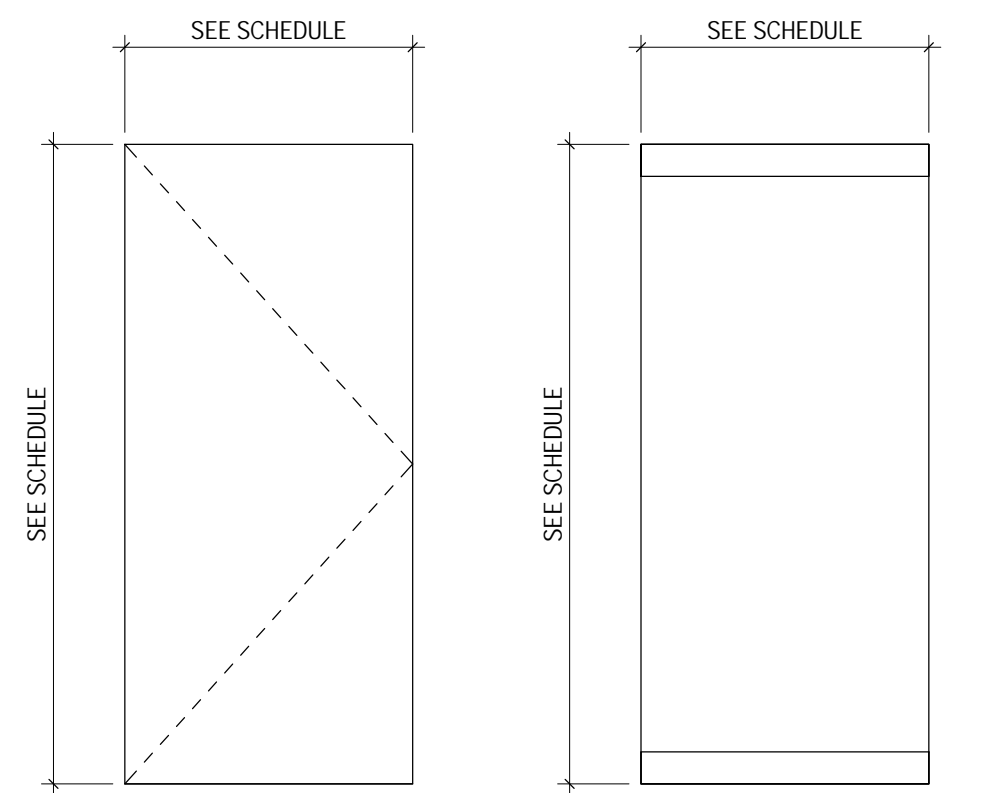

F FLUSH PANEL AGR ALL GLASS W/ RAILS

DOOR PANEL TYPES


1/2" = 1'-0"

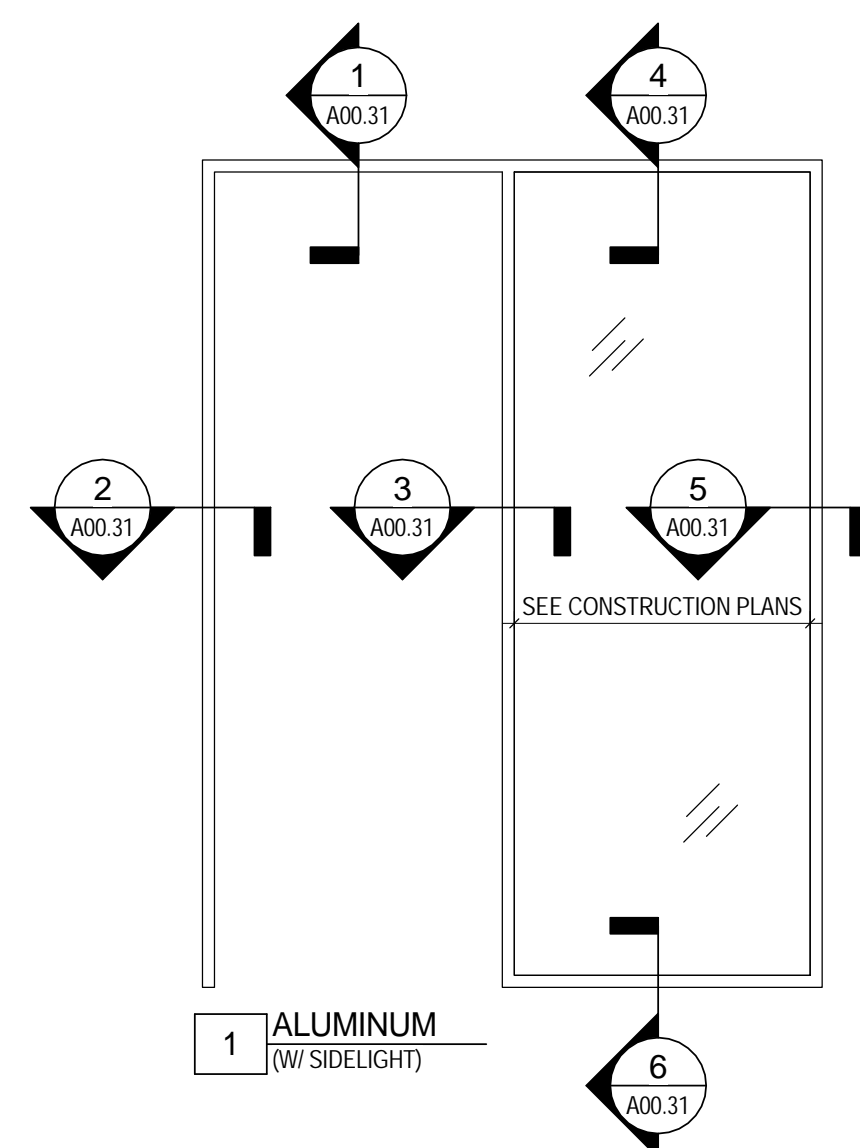

FRAME TYPES

1/2" = 1'-0"

DOOR AND FRAME SCHEDULE NOTES	
1	SEE DOOR SCHEDULE FOR DOOR TYPE AND SIZE.
2	WOOD SPECIES TO BE QUARTER SLICE WHITE ASH EBONY STAIN, PROVIDE SAMPLE FOR ARCHITECT'S APPROVAL.
3	DOOR FRAMES TO BE ALUMINUM CLEAR ANNOXIDIZED FINISH.
4	SUBMIT DOOR HARDWARE SCHEDULE, KEYING SCHEDULE AND APPLICABLE PRODUCT LITERATURE TO ARCHITECT FOR APPROVAL PRIOR TO ORDERING AND INSTALLATION.
5	PROVIDE TWO KEYS FOR EACH LOCKSET. FURNISH KEYS TO OWNER.
6	SEE HARDWARE SCHEDULE FOR HARDWARE SET.
7	ALL HARDWARE TO MATCH BANK OF AMERICA DESIGN STANDARDS.
8	HARDWARE SET #3 - FAIL SAFE, TIED TO BUILDING LIFE SAFETY SYSTEM, ALWAYS ACTIVE IN PATH OF EGRESS. G.C. TO PROVIDE REQUIRED SIGNAGE BY CODE, SIGN TO READ: "PUSH TO EXIT". COORDINATE FINAL SIGN DESIGN AND LOCATION WITH ARCHITECT. G.C. TO COORDINATE HARDWARE WITH GLASS DOOR MFR.
9	CAULK DOOR JAMB AND HEADS WHERE GAPS EXCEED 1/16", TYPICAL.
10	PROVIDE THREE JAMB ANCHORS AND ONE BASE ANCHOR PER JAMB AT GYPSUM WALLBOARD PARTITIONS, TYPICAL.
11	PROVIDE FRAME ROUGH OPENINGS AS RECOMMENDED BY FRAME MANUFACTURER.
12	PROVIDE STANDARD DOOR FRAME PROFILES AS REQUIRED TO MEET ADJACENT CONDITIONS.
13	PROVIDE ANCHORS AND ACCESSORIES AS REQUIRED FOR CONDITIONS AS RECOMMENDED BY THE MANUFACTURER.
14	DOORS SHALL OPERATE FREELY WITHOUT BINDING.
15	DOOR FRAMES SHALL BE SECURED RIGIDLY IN PLACE AND BRACED TO FLOOR AND STRUCTURE ABOVE TO PREVENT BREAK OUT TO PARTITIONS.
16	DOOR UNDERCUTS SHALL BE KEPT TO A MINIMAL DIMENSION AND SHALL BE UNIFORM THROUGHOUT PROJECT, U.N.O.
17	NO THROUGH-BOLTING WILL BE ACCEPTED. DOOR TO BE REINFORCED INTERNALLY.
18	INSTALLATION OF ALL DOORS AND HARDWARE SHALL MEET MIN. "A.D.A." REQUIREMENTS. IF ANY CONFLICTS ARISE, THE ITEM MUST BE BROUGHT TO THE ARCHITECT'S ATTENTION PRIOR TO CONSTRUCTION.
19	ERECT ALL DOOR FRAMES AND ADJACENT WALLS TO CONFORM TO THE APPLICABLE PLAN CONFIGURATION. NOTIFY ARCHITECT OF ANY CONFLICTS PRIOR TO INSTALLATION OF DOOR FRAMES AND ADJACENT WALLS.
20	ALL DOORS SHALL COMPLY WITH THE CLEARANCES FOR APPROACHES MEETING MINIMUM ADA REQUIREMENTS.
21	ALL HARDWARE SHALL BE UNLOCKED IN THE DIRECTION OF EGRESS, REGARDLESS OF OTHER LOCK FUNCTIONS.
22	ALL HARDWARE TO BE BRUSHED STAINLESS STEEL OR SATIN CHROME FINISH.

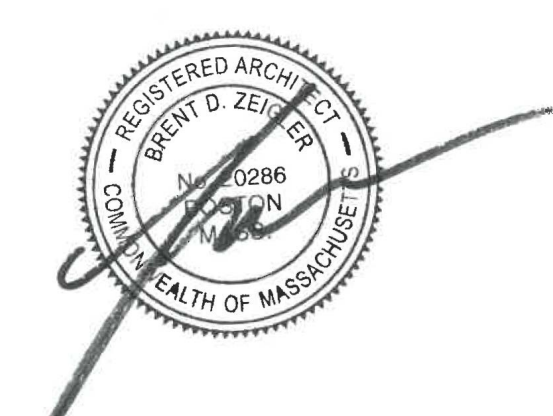

REVISIONS

CONSTRUCTION DOCUMENTS

BANK OF AMERICA - HOME LOANS

BANK OF AMERICA
1 MONUMENT SQUARE, PORTLAND ME

TITLE
DOOR TYPES & SCHEDULE

DATE **JOB NO.**
06/29/17 17.0239

DRAWING NO.
A00.30

ISSUED FOR CONSTRUCTION