




1 TRUSS SYSTEM ELEVATION
3/16" = 1'-0"

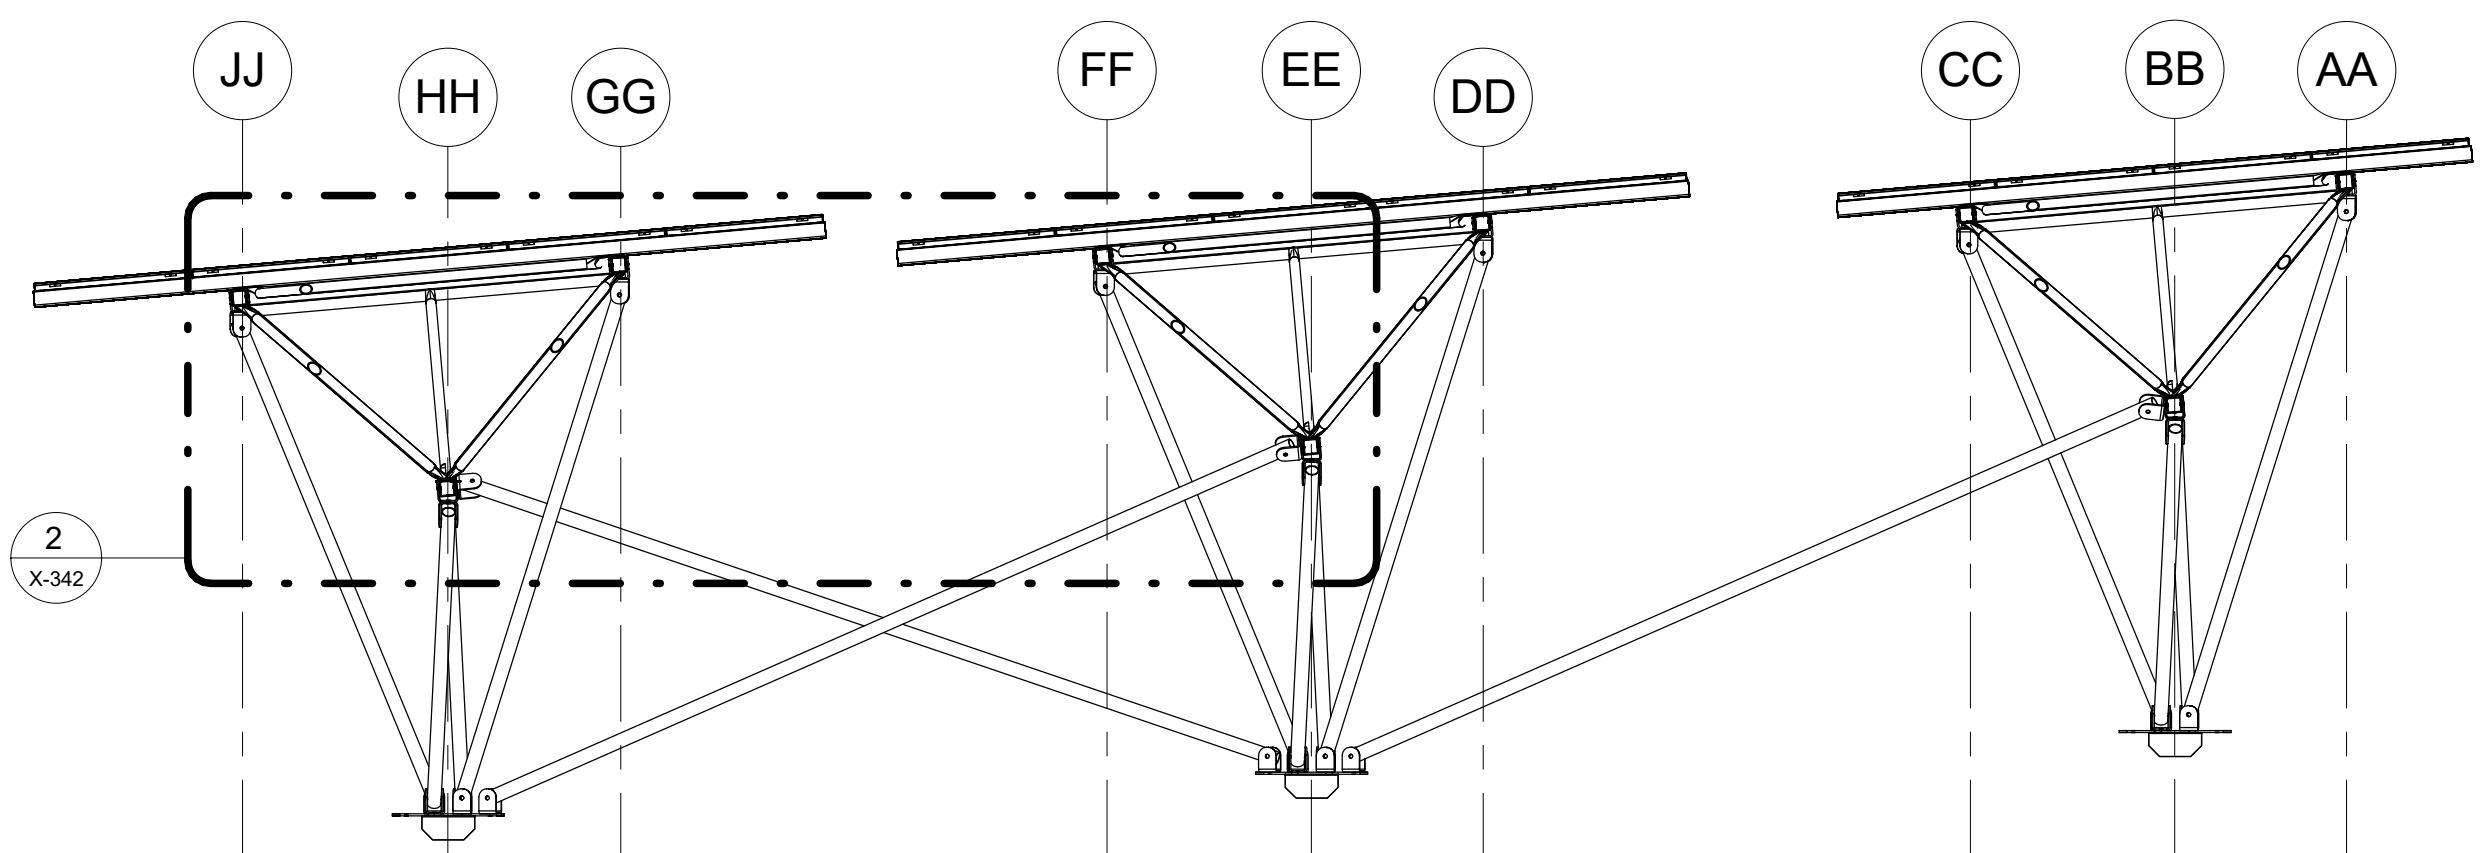

2 SYSTEM SECTION
1/4" = 1'-0"

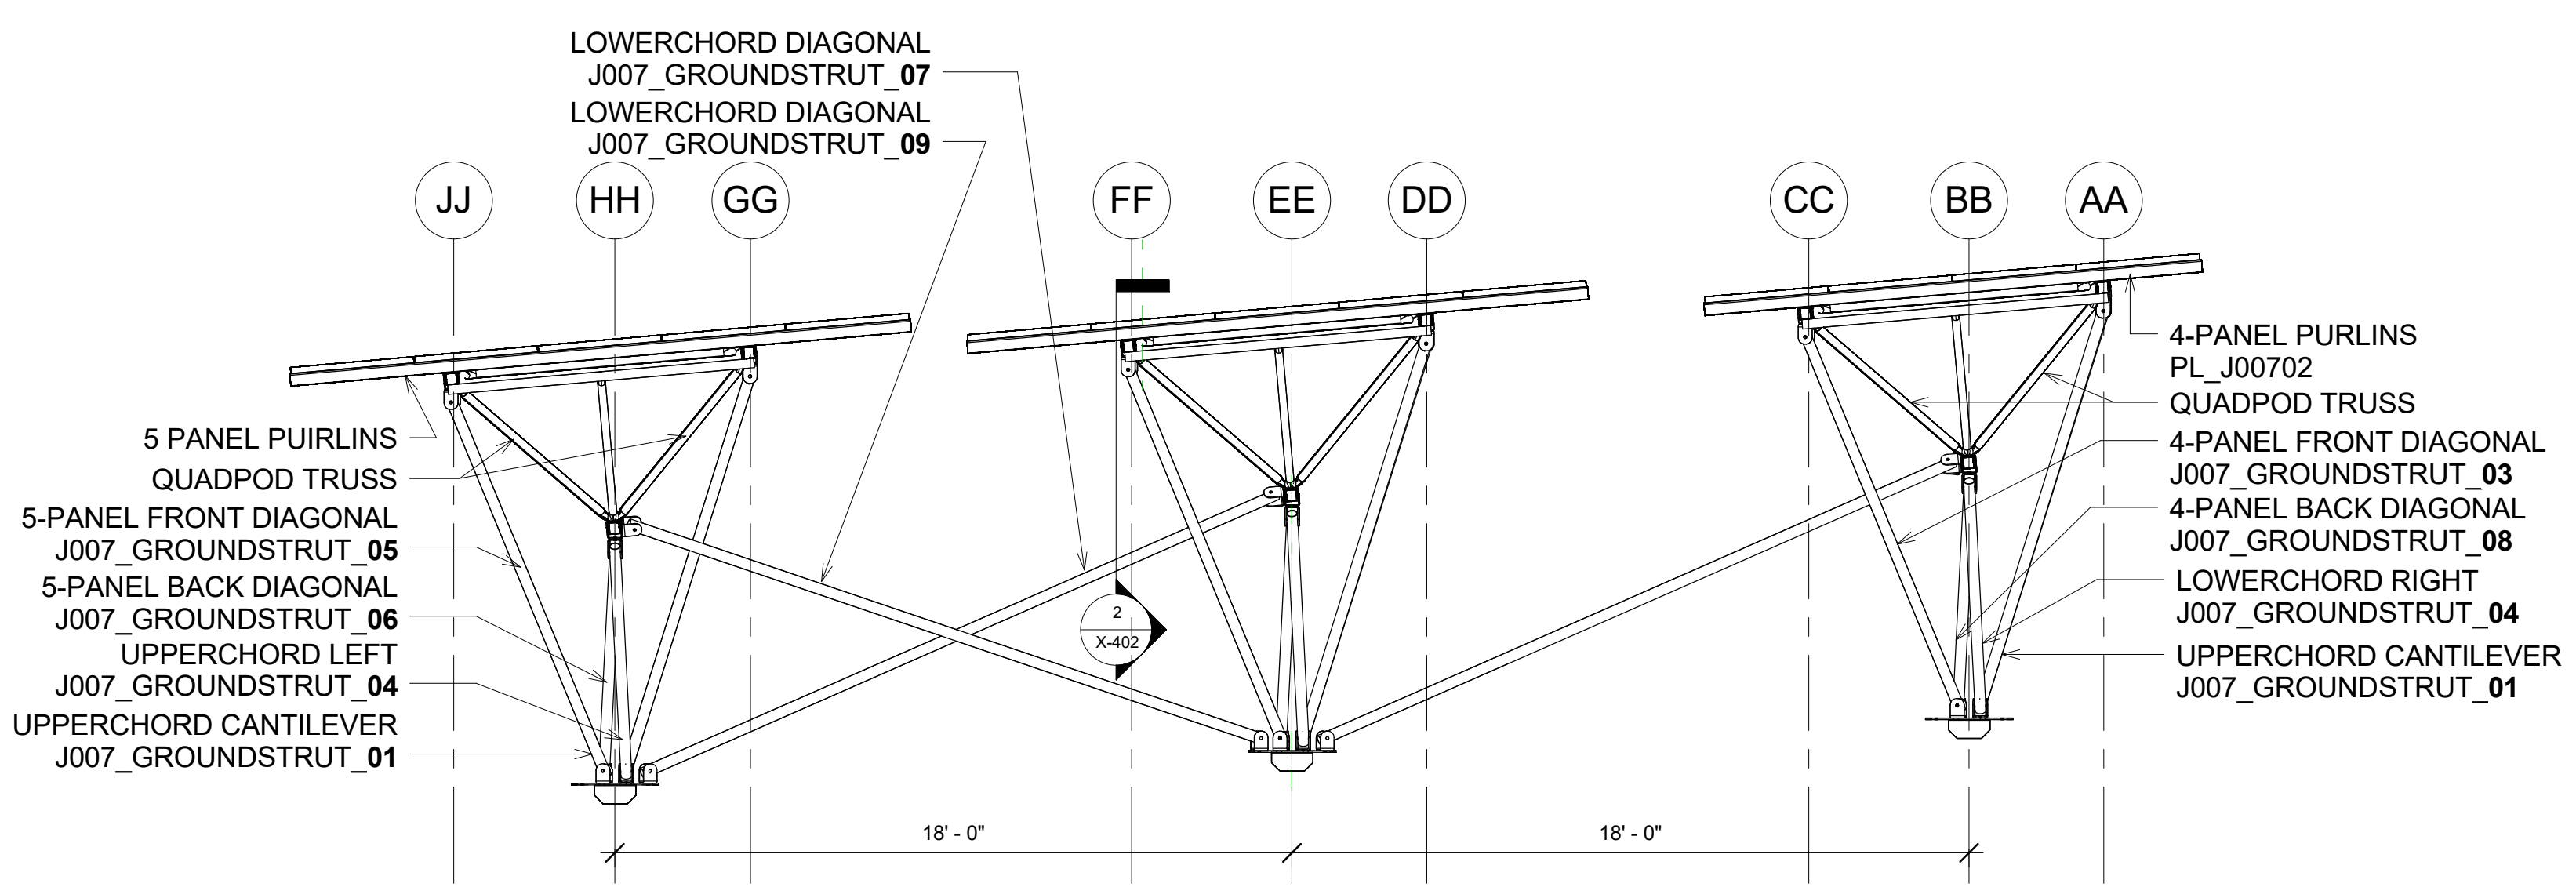

3 SYSTEM EAST ELEVATION
1/4" = 1'-0"

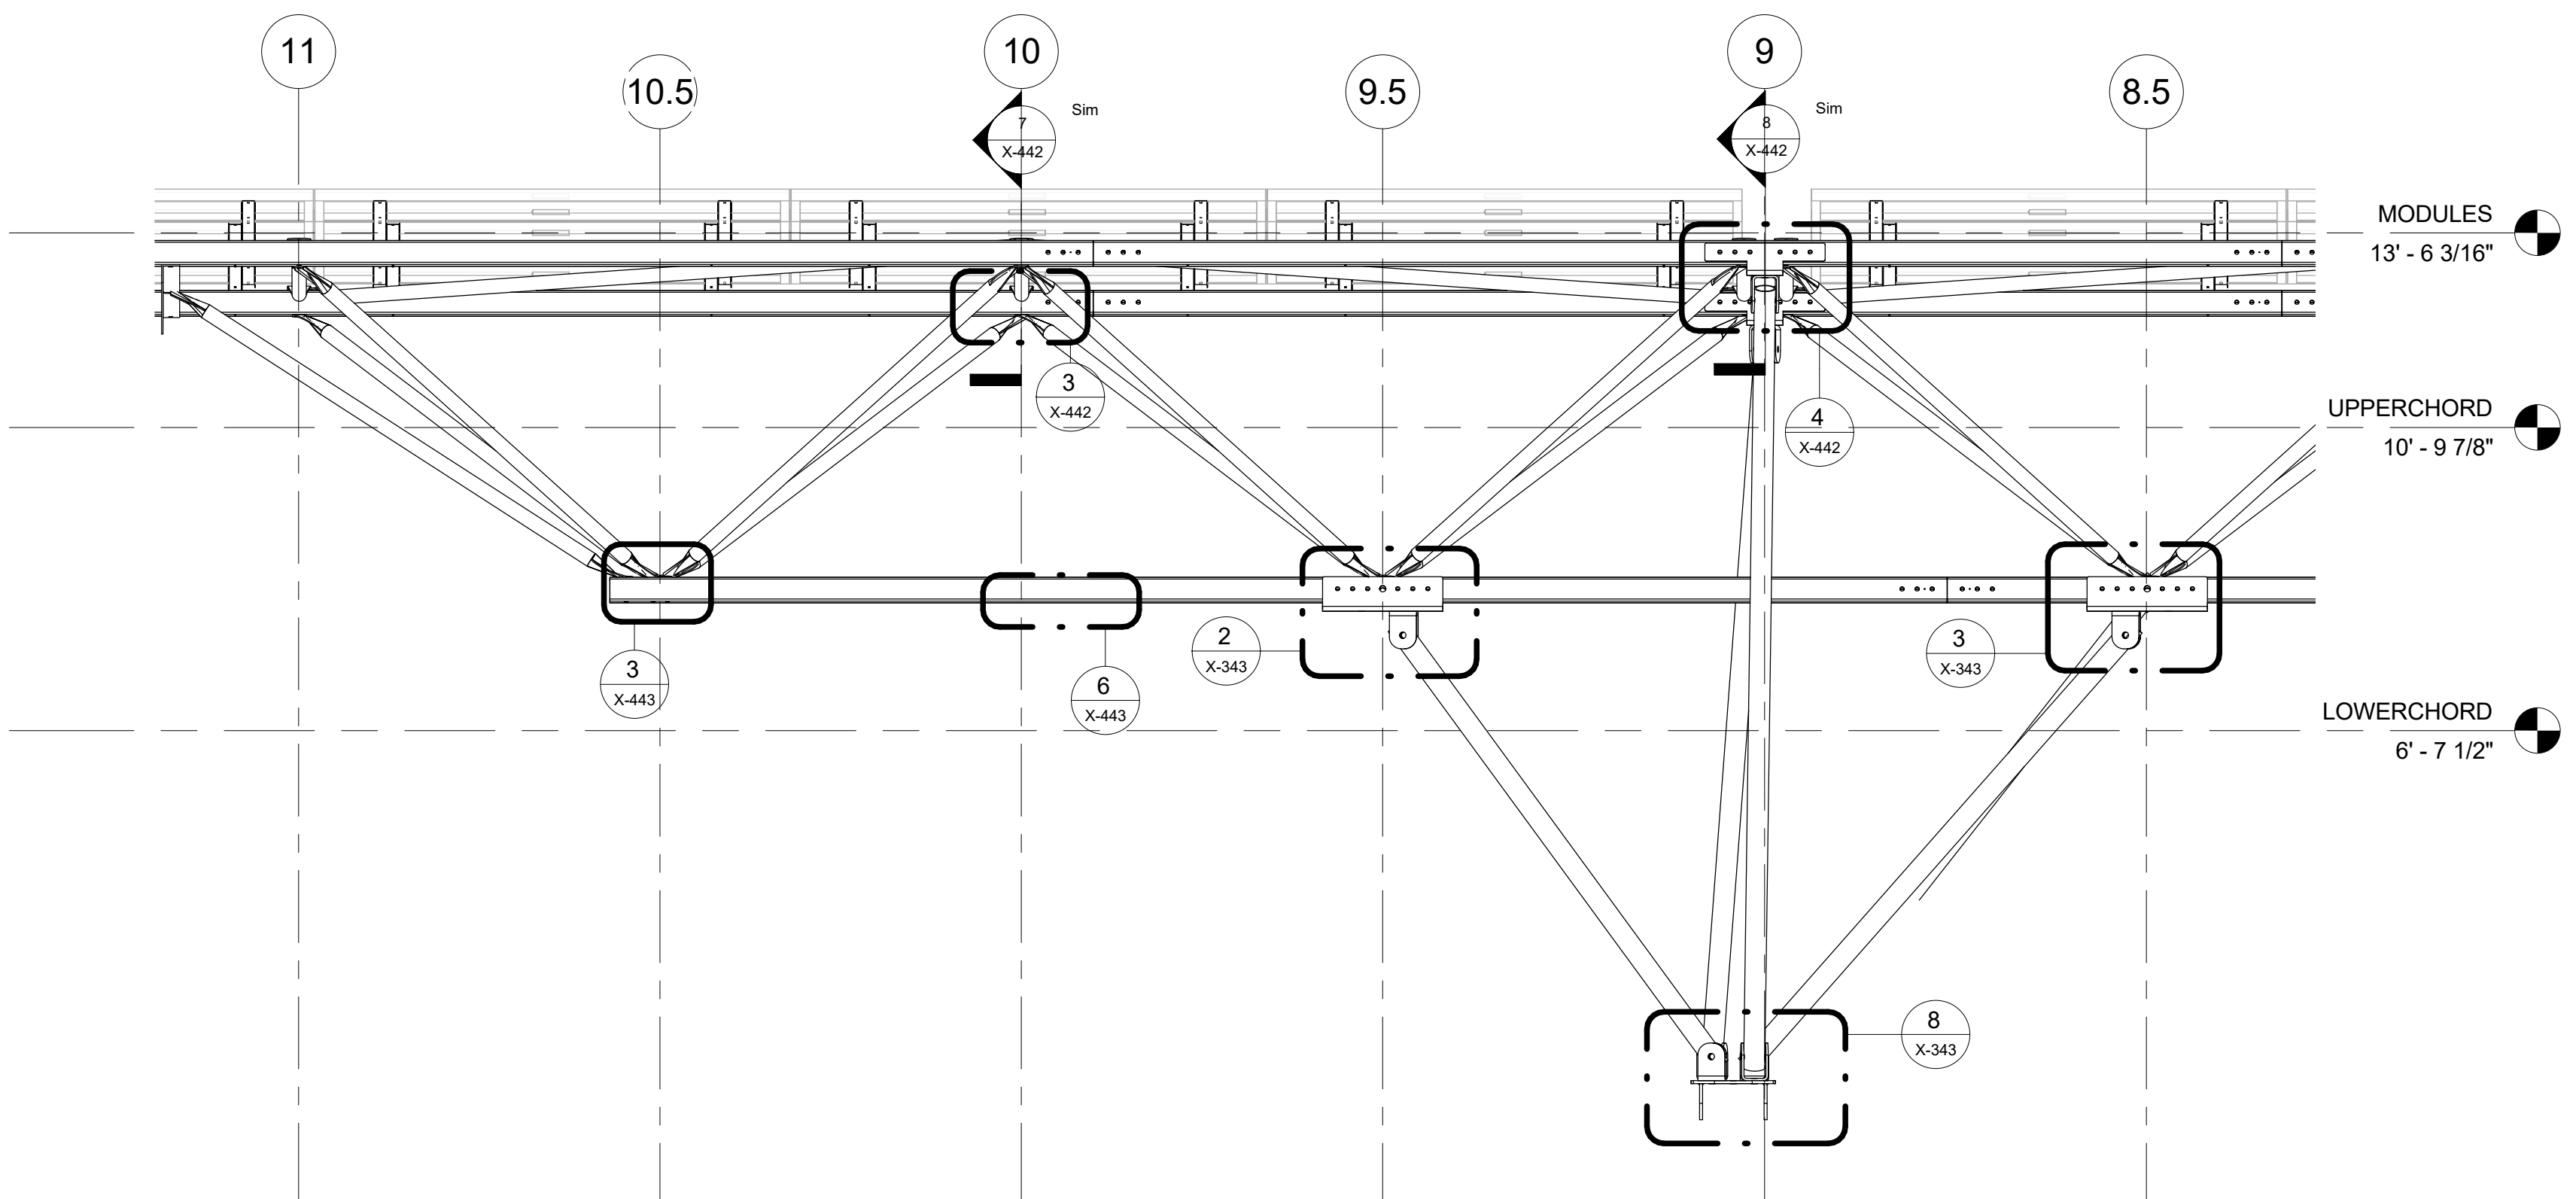

4 ENLARGED ELEVATION - TRUSS DETAIL 2
1/2" = 1'-0"

QUEST RENEWABLES
 75 5th ST. NW, SUITE 2150
 ATLANTA, GA 30308

www.questrenewables.com
 (404) 536-5787



STRUCTURAL CONSULTANT:
AO STRUCTURES
 P.O. BOX 413
 CARNELIAN BAY, CA,
 96140
 916.514.8586
 www.AOstructures.com

CLIENT:
REVISION ENERGY
 142 PRESUMPCOT ST.
 PORTLAND, ME 04103
 (207)221-6342
 joshd@ReVisonEnergy.com

FORE STREET PARKING GARAGE
 PARKING DECK CANOPY
 425 FORE ST,
 PORTLAND, ME 04101

QUADPOD CANOPY SYSTEM
 193.6 kW DC
 578 PV MODULES
 5.00° DEGREE TILT
 150.00° DEGREE AZIMUTH

#	DESCRIPTION	DATE
1	ISSUED FOR PERMIT	04/05/2017

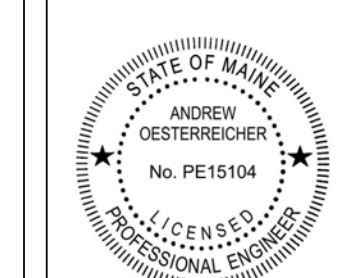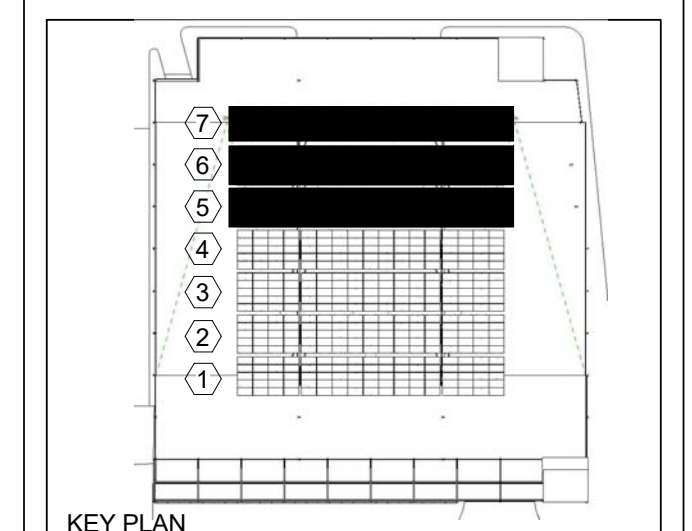

SEALS

CONFIG 02 - TRUSS CONFIGURATION ELEVATIONS

PROJECT NUMBER J007
 DATE 03/31/2017
 DRAWN BY JK CHECKED BY WA

X-322