


PROFILE STA. 0+00 TO STA. 1+40
 HORIZONTAL SCALE: 1" = 20'
 VERTICAL SCALE: 1" = 4'

STRUCTURE TABLE			
NAME	DIA.	RIM	INV N./SIZE/FROM
BOX FILTER	6"x4"	30.90'	28.23/4"PVC/CB-3
CB-2	4'	30.75	26.81/10"PVC/CB-3
CB-3	4'	30.71	27.88/4"PVC/BOX FILTER
DMH-4	4'	24.99	19.04/10"PVC/DMH-5
DMH-5	4'	26.57	19.26/10"PVC/DMH-4
DMH-6	4'	30.85	26.88/10"PVC/CB-2
GREASE TRAP	6.3'x10'	29.26	1/4"PVC/RELEASE TRAP
*THROAT OPENING OF BOX FILTER			

PIPE TABLE		
PIPE NAME	SIZE	LENGTH
PIPE 1	12" PVC	22'
PIPE 2	10" PVC	3'
PIPE 3	10" PVC	12'
PIPE 4	4" PVC	5'

NOTE:

- PROFILE ALIGNMENT = CENTERLINE OF
- MANHOLE CENTERLINE = CENTERLINE OF
- STA. 0+00 = FACE OF BUILDING (ROOF AND FLOOR DRAIN CONNECTION)

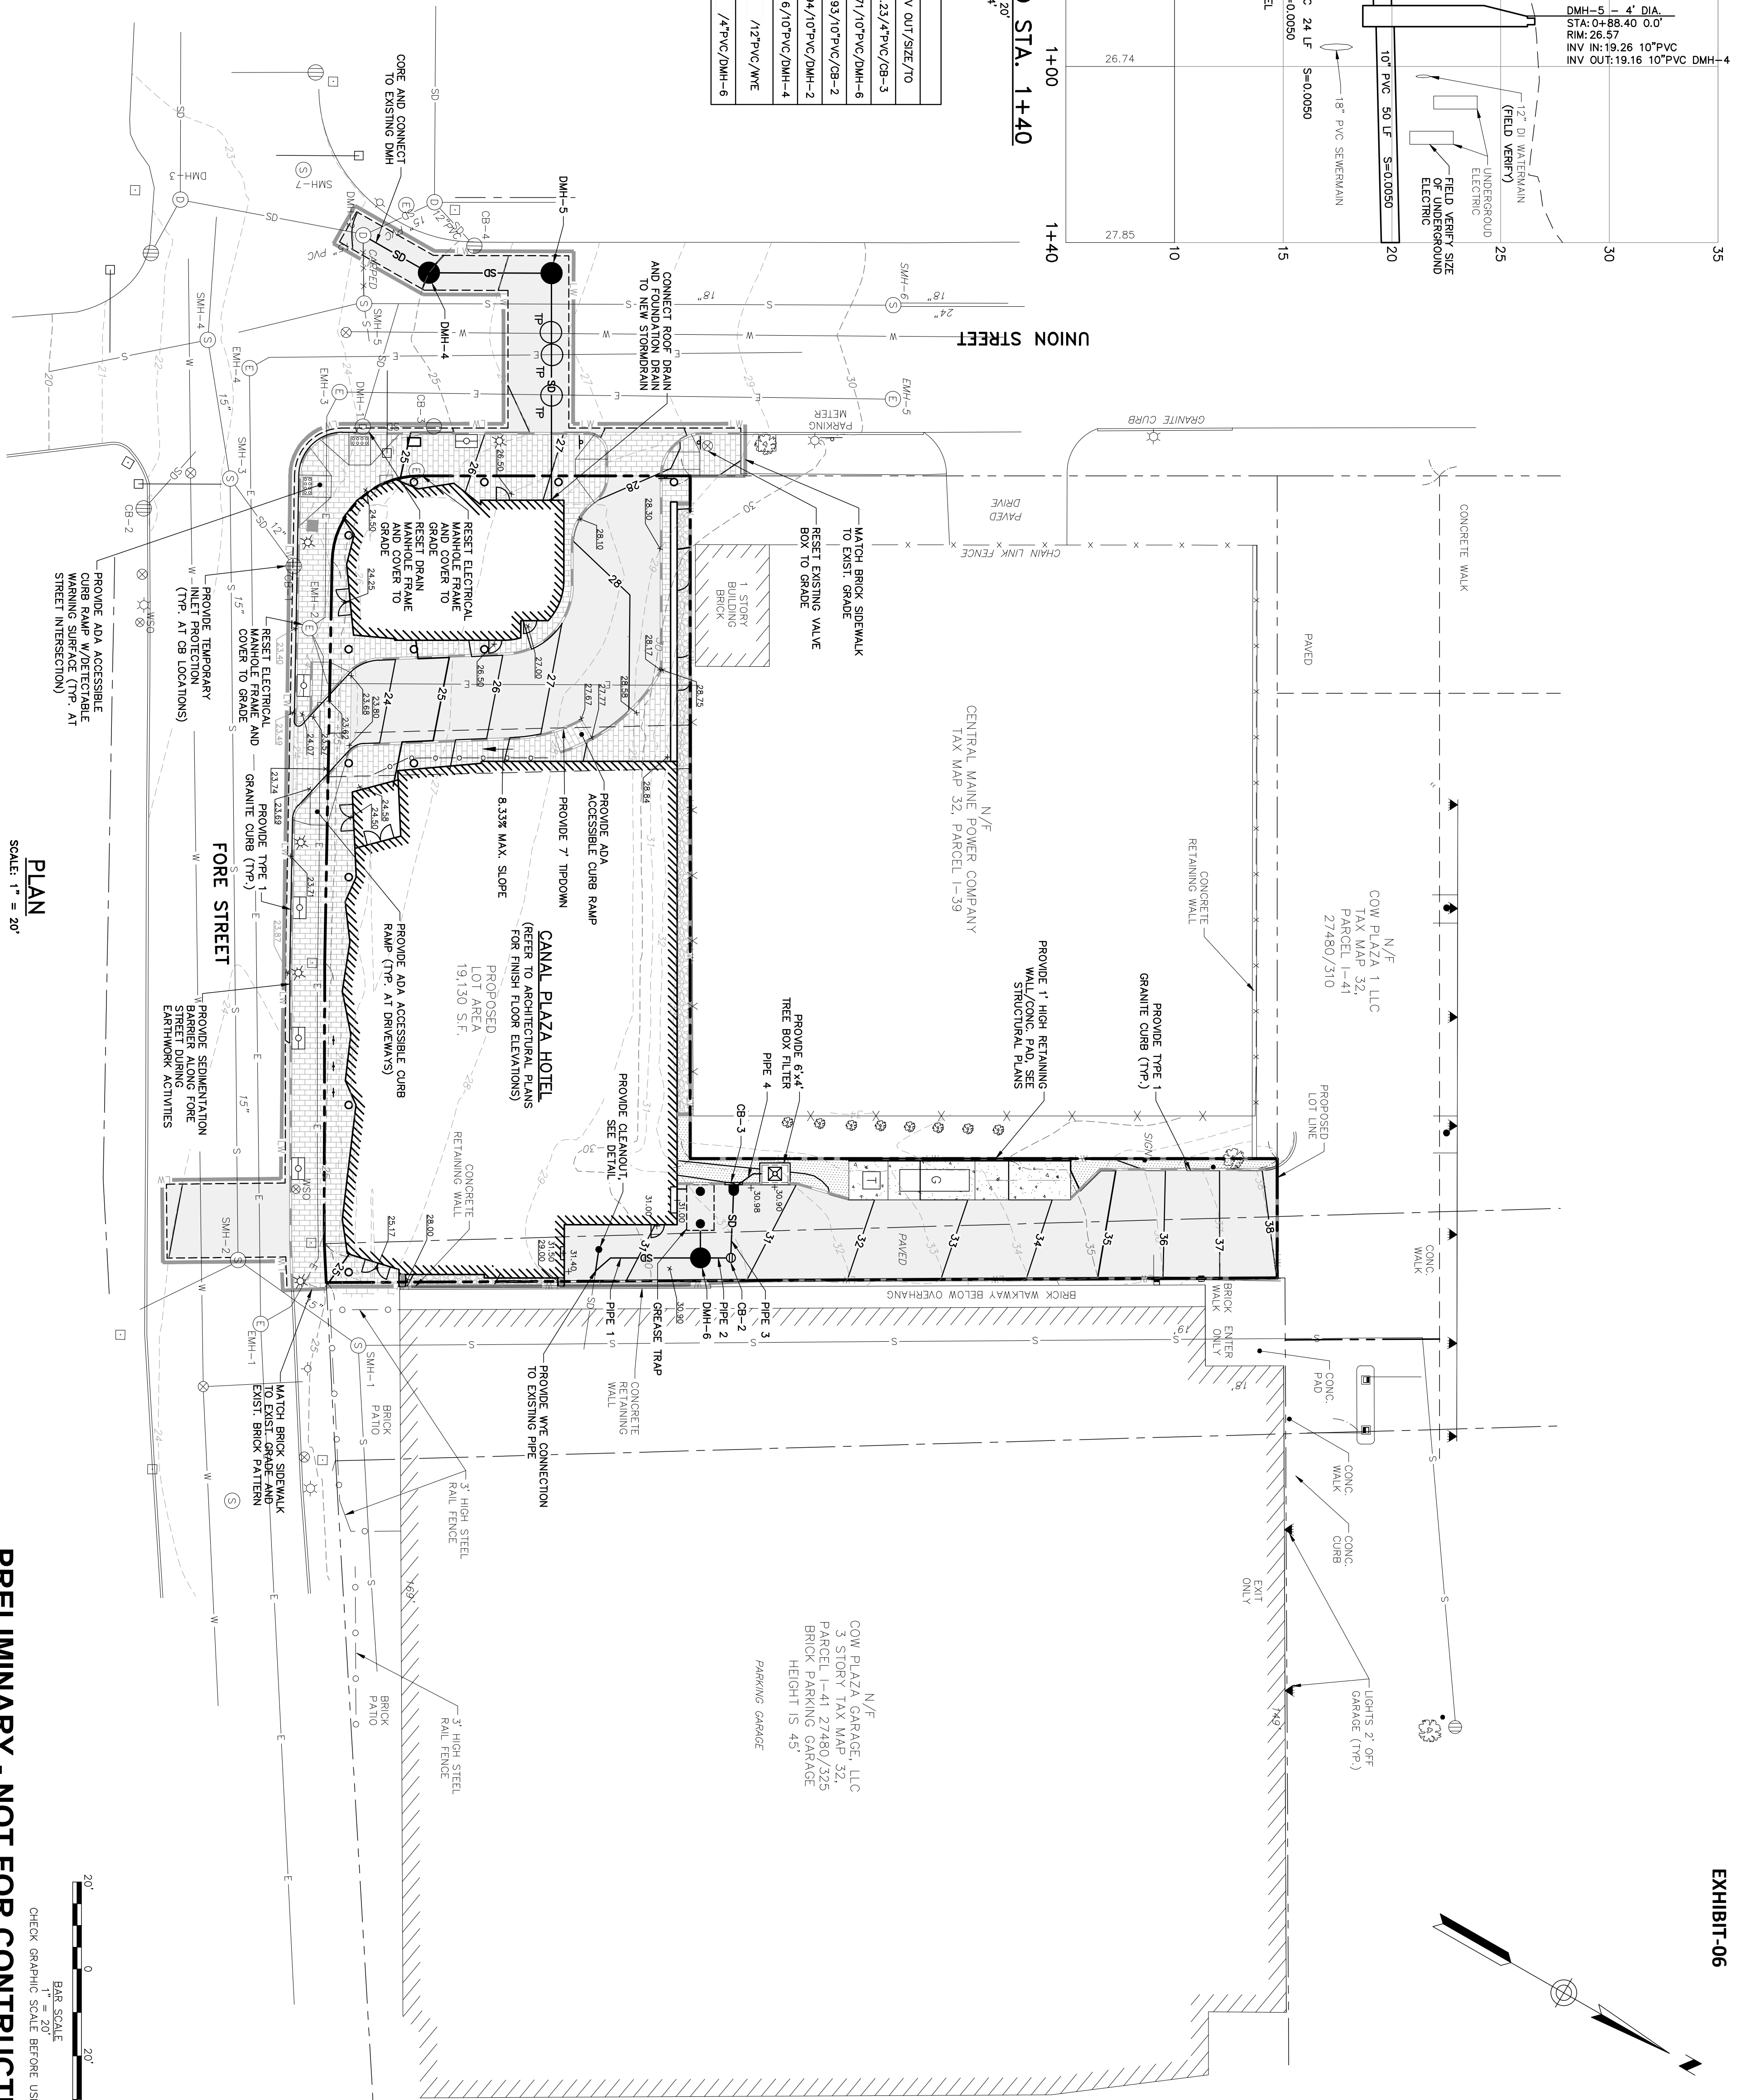

PLAN
 SCALE: 1" = 20'

PRELIMINARY - NOT FOR CONSTRUCTION

EXHIBIT-06

JOB NO.: 225869A.01 DATE: OCTOBER 2012 SCALE: 1" = 20' SHEET: 3 OF 9	COW PLAZA HOTEL, LLC 100 COMMERCIAL STREET, SUITE 306 PORTLAND, MAINE, C/O TIM SOLEY	CANAL PLAZA HOTEL	GRADING, DRAINAGE, AND EROSION CONTROL PLAN	DESIGNED BY: MDLM DRAWN BY: JBC	CHECKED BY: DLC 22586901-C200A.DWG	9/28/2012			41 Hutchins Drive Portland, Maine 04102 800.426.4262 www.woodardcurran.com COMMITMENT & INTEGRITY DRIVE RESULTS
				1 FINAL SITE PLAN APPLICATION SUBMISSION	DESCRIPTION	DATE			