



HVAC LEGEND

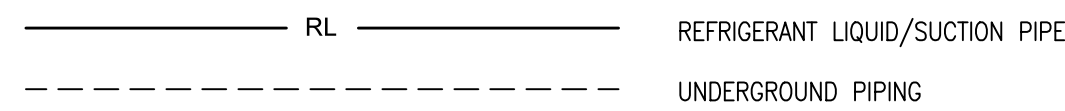

HVAC ABBREVIATIONS

ERV ENERGY RECOVERY VENTILATOR
 HVAC HEATING, VENTILATION, & AIR-CONDITIONING
 RL REFRIGERANT LIQUID
 RS REFRIGERANT SUCTION


ELECTRICAL LEGEND

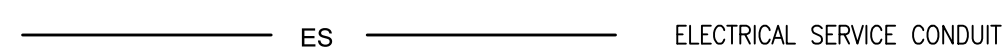

ELECTRICAL ABBREVIATIONS


ES ELECTRICAL SERVICE

PLUMBING LEGEND

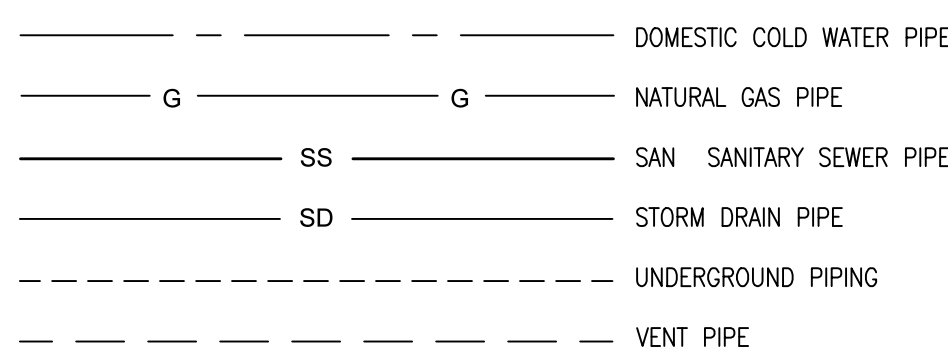

PLUMBING ABBREVIATIONS

DCW DOMESTIC COLD WATER
 DWV DRAIN/WASTE/VENT
 G NATURAL GAS
 SAN SANITARY
 SD STORM DRAIN
 SS SANITARY SEWER
 VTR VENT THROUGH ROOF

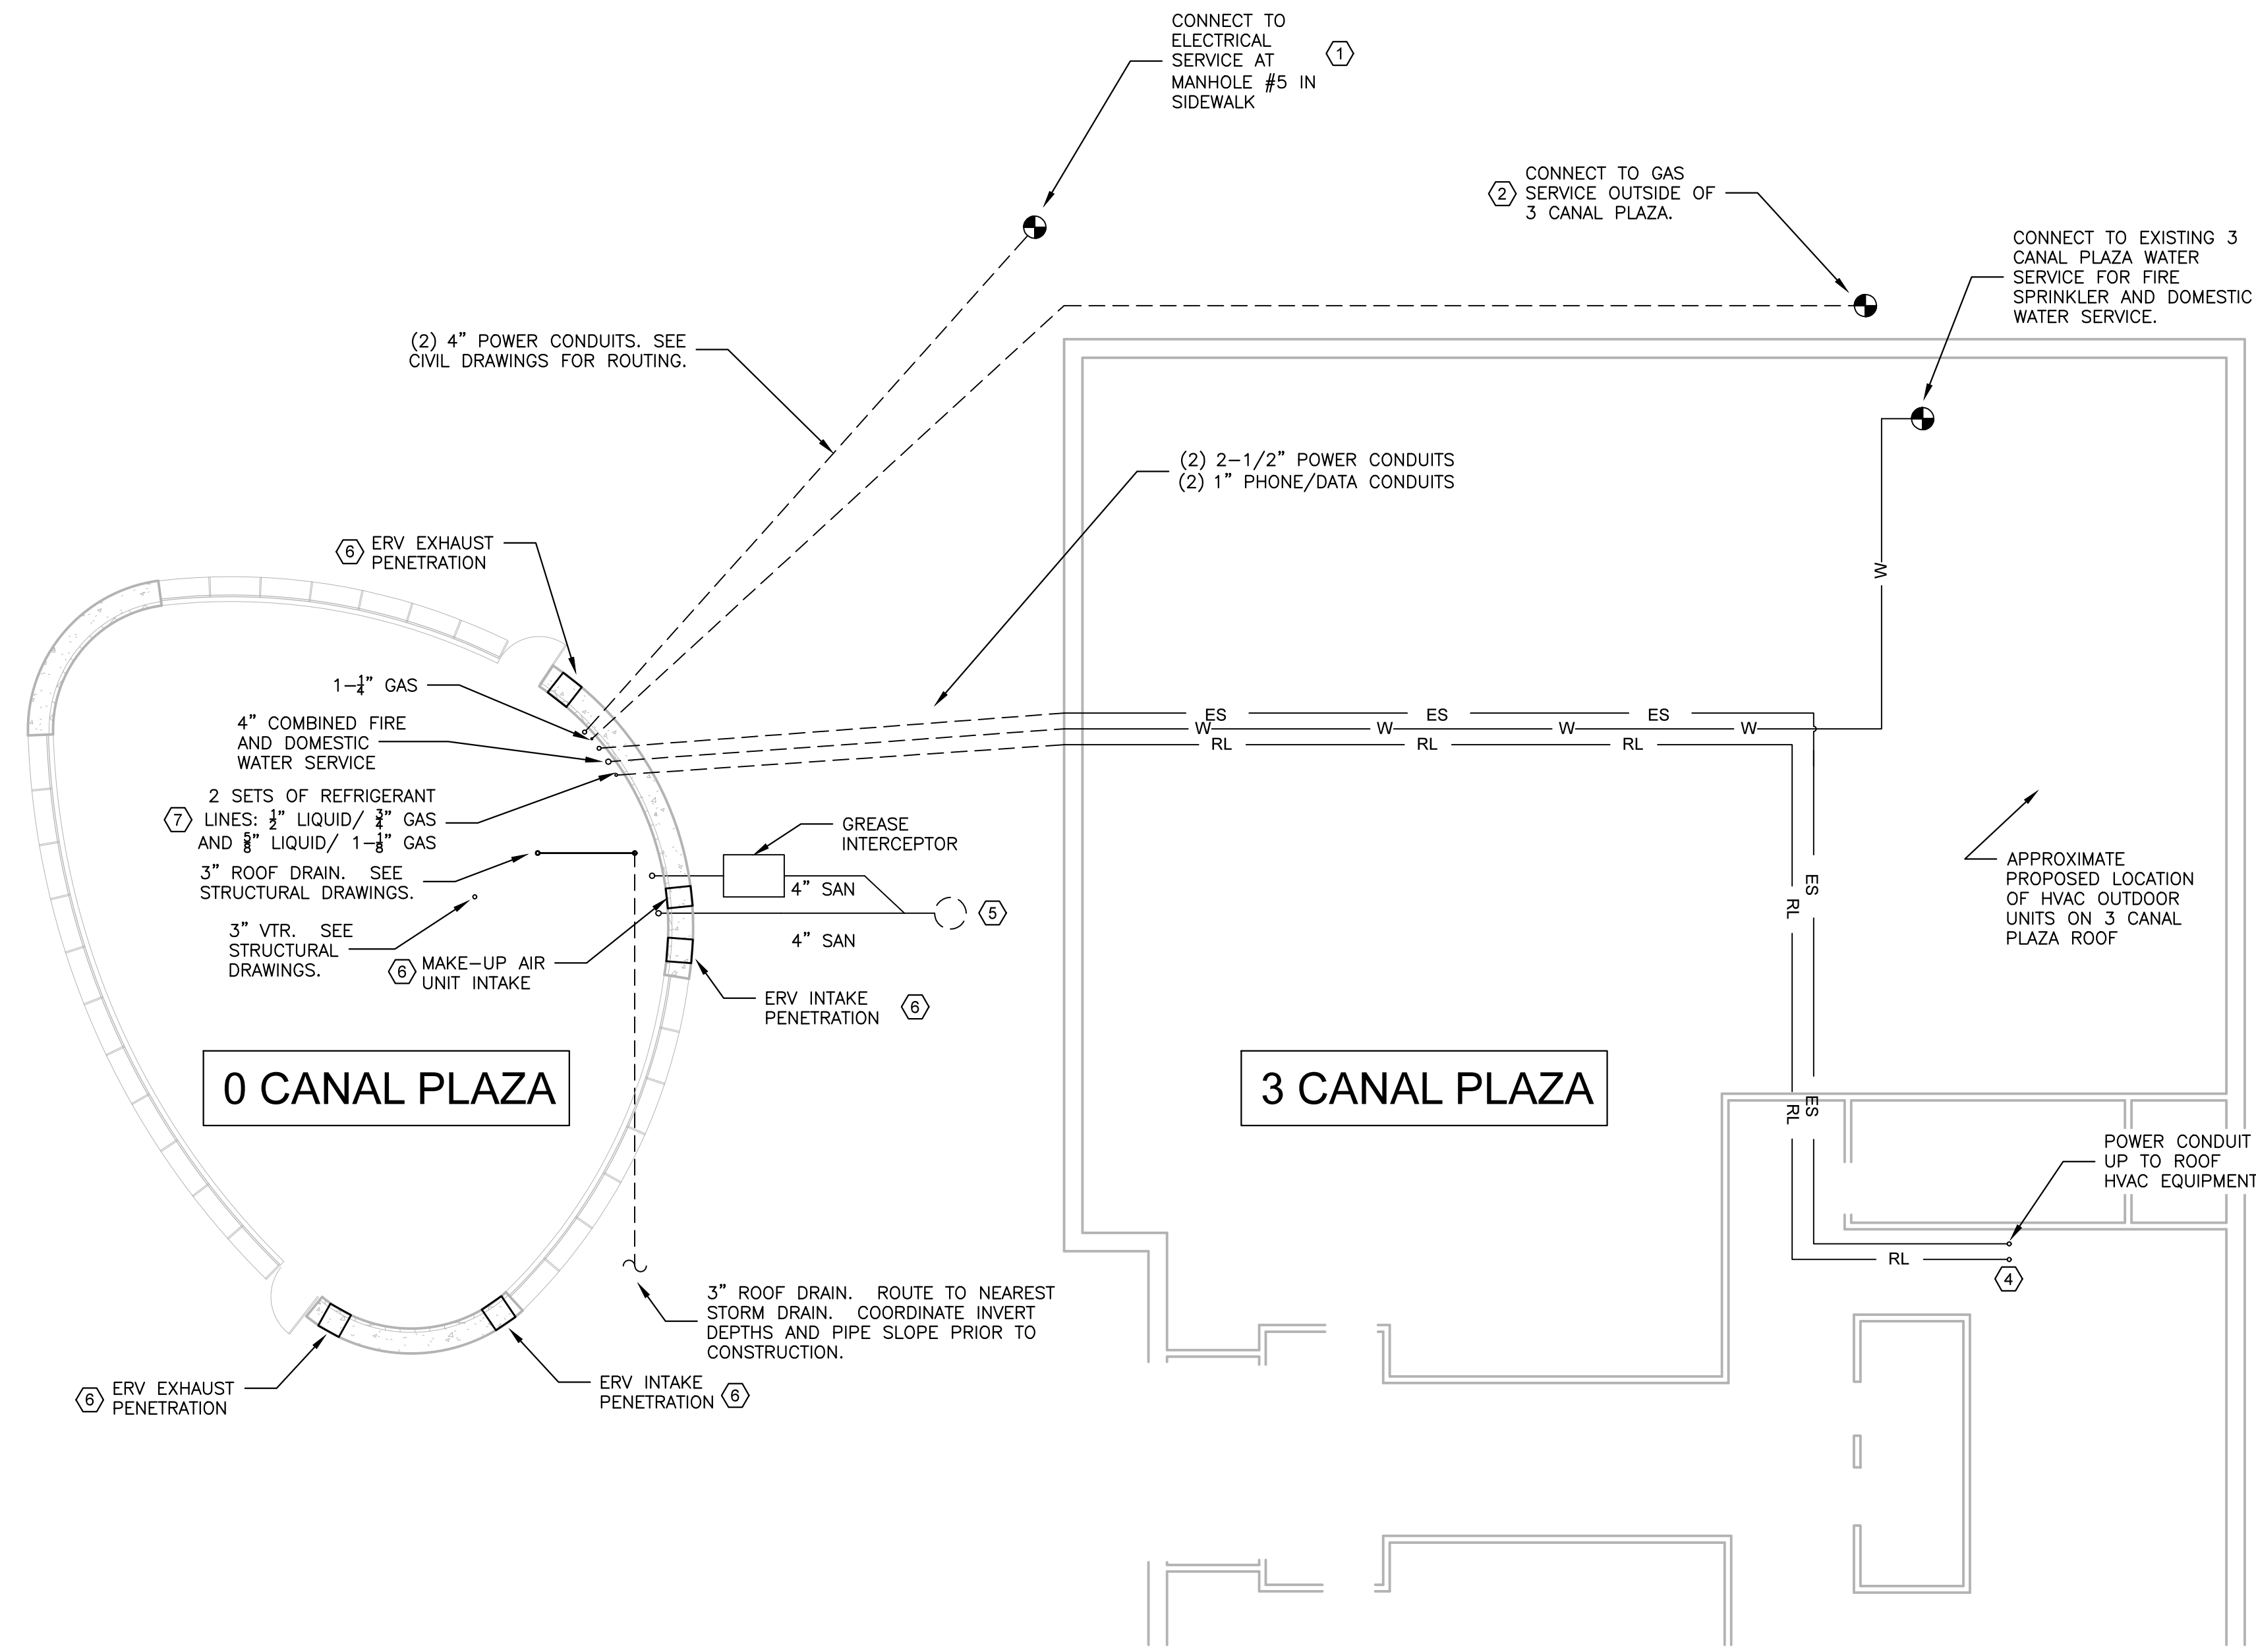

(A) MEP PLAN
 1/8" = 1'0"

GENERAL NOTES

- ALL LOCATIONS ARE DIAGRAMMATIC ONLY. DESIGN-BUILD CONTRACTOR WILL HAVE TO VERIFY FIELD CONDITIONS AND FINAL DESIGN REQUIREMENTS.
- ORGANIZATION AND LOCATION OF UTILITY CONNECTIONS MAY BE ADJUSTED BASED ON FIELD CONDITIONS AND FINAL DESIGN REQUIREMENTS.

KEY NOTES

- SEE DWG. MEP 600 FOR ELECTRICAL SINGLE LINE DIAGRAM. SEE CIVIL DRAWINGS FOR CONDUIT ROUTING TO MANHOLE #5. FINALIZE CONNECTION REQUIREMENTS WITH CENTRAL MAINE POWER.
- COORDINATE WITH UTIL. SEE CIVIL DRAWINGS FOR UNDERGROUND GAS PIPE ROUTING.
- CONNECT DOWNSTREAM OF EXISTING 3 CANAL PLAZA WATER METER, BUT UPSTREAM OF ANY 3 CANAL PLAZA ISOLATION VALVES. INSTALL NEW WATER METER TO SUB-METER 0 CANAL PLAZA. CONFIRM ACCEPTABLE CONFIGURATION WITH PORTLAND FIRE DEPARTMENT AND PORTLAND WATER DISTRICT PRIOR TO CONSTRUCTION.
- TWO SETS OF REFRIGERANT LIQUID AND SUCTION LINES (INCLUDES PLUS POWER AND COMMUNICATIONS), AND ELECTRICAL POWER UP TO 3 CANAL PLAZA ROOF.
- CONNECT TO SEWER MANHOLE. SEE CIVIL DRAWINGS. COORDINATE INVERT DEPTHS AND PIPE SLOPE PRIOR TO CONSTRUCTION.
- SEPARATE INTAKES FROM ALL EXHAUSTS BY A MINIMUM OF 10 FEET, OR AS REQUIRED BY CODE. SEE ARCHITECTURAL AND STRUCTURAL DRAWINGS FOR PRECISE LOCATION OF BOND-OUTS.
- SEE DWG. MEP 600 FOR REFRIGERANT LINE SIZES AND OUTDOOR CONDENSER INFORMATION. COORDINATE REFRIGERANT LINE ROUTING WITH OWNER. COORDINATE OUTDOOR CONDENSER LOCATION ON ROOF WITH OWNER.

NOT FOR CONSTRUCTION

REV.	DESCRIPTION:	BY:	DATE:

BRIDGING DOCUMENTS
RIPCORD ENGINEERING
 PO BOX 4175
 PORTLAND, ME 04101
 207.331.7900

CLIENT: EAST BROWN COW
 100 COMMERCIAL STREET
 PORTLAND
 MAINE
 ARCHITECT: CANAL 5 STUDIO
 1 CANAL PLAZA #888
 PORTLAND
 MAINE


SITE: 0 CANAL PLAZA

TITLE: MEP PLAN

SCALE AT A1: 1/8"=1'0"	DATE: 9/19/16	DRAWN: SMB	CHECKED: SMB
PROJECT NO: 15-016	DRAWING NO: MEP100	REVISION: B	

OUTDOOR CONDENSING UNIT													
TAG	HEATING CAPACITY AT 5 DEG F (BTU/H)	COOLING CAPACITY AT 95 DEG F (BTU/H)	H X W X D (INCHES)	WEIGHT (LBS)	LIQUID LINE (IN)	SUCTION LINE (IN)	VOLTAGE	PHASE	HERTZ	MCA	MANUFACTURER	MODEL	NOTES
OU-1	80,000	72,000	66 X 37 X 30	497	1/2	3/4	208 / 230	3	60	59	DAIKIN	PUHY-HP72TJMU-A-BS	1,2,3
OU-2	80,000	72,000	66 X 37 X 30	497	1/2	3/4	208 / 230	3	60	59	DAIKIN	PUHY-HP72TJMU-A-BS	1,2,3

- NOTES:
- MOUNT A MINIMUM OF 24 INCHES ABOVE THE ROOF FOR SNOW. USE COMPATIBLE MOUNTING PLATFORM FROM QUICKSLING OR BIGFOOT.
 - ORDER SEA COAST MODEL FOR SALT AIR PROTECTION.
 - IF TWO OUTDOOR UNITS ARE INSTALLED, THEY MUST BE CONNECTED TO 0 CANAL PLAZA VIA A TWINNING KIT . REFRIGERANT LINES FROM TWINNING KIT TO BUILDING ARE 5/8" LIQUID, 1-1/8" GAS.

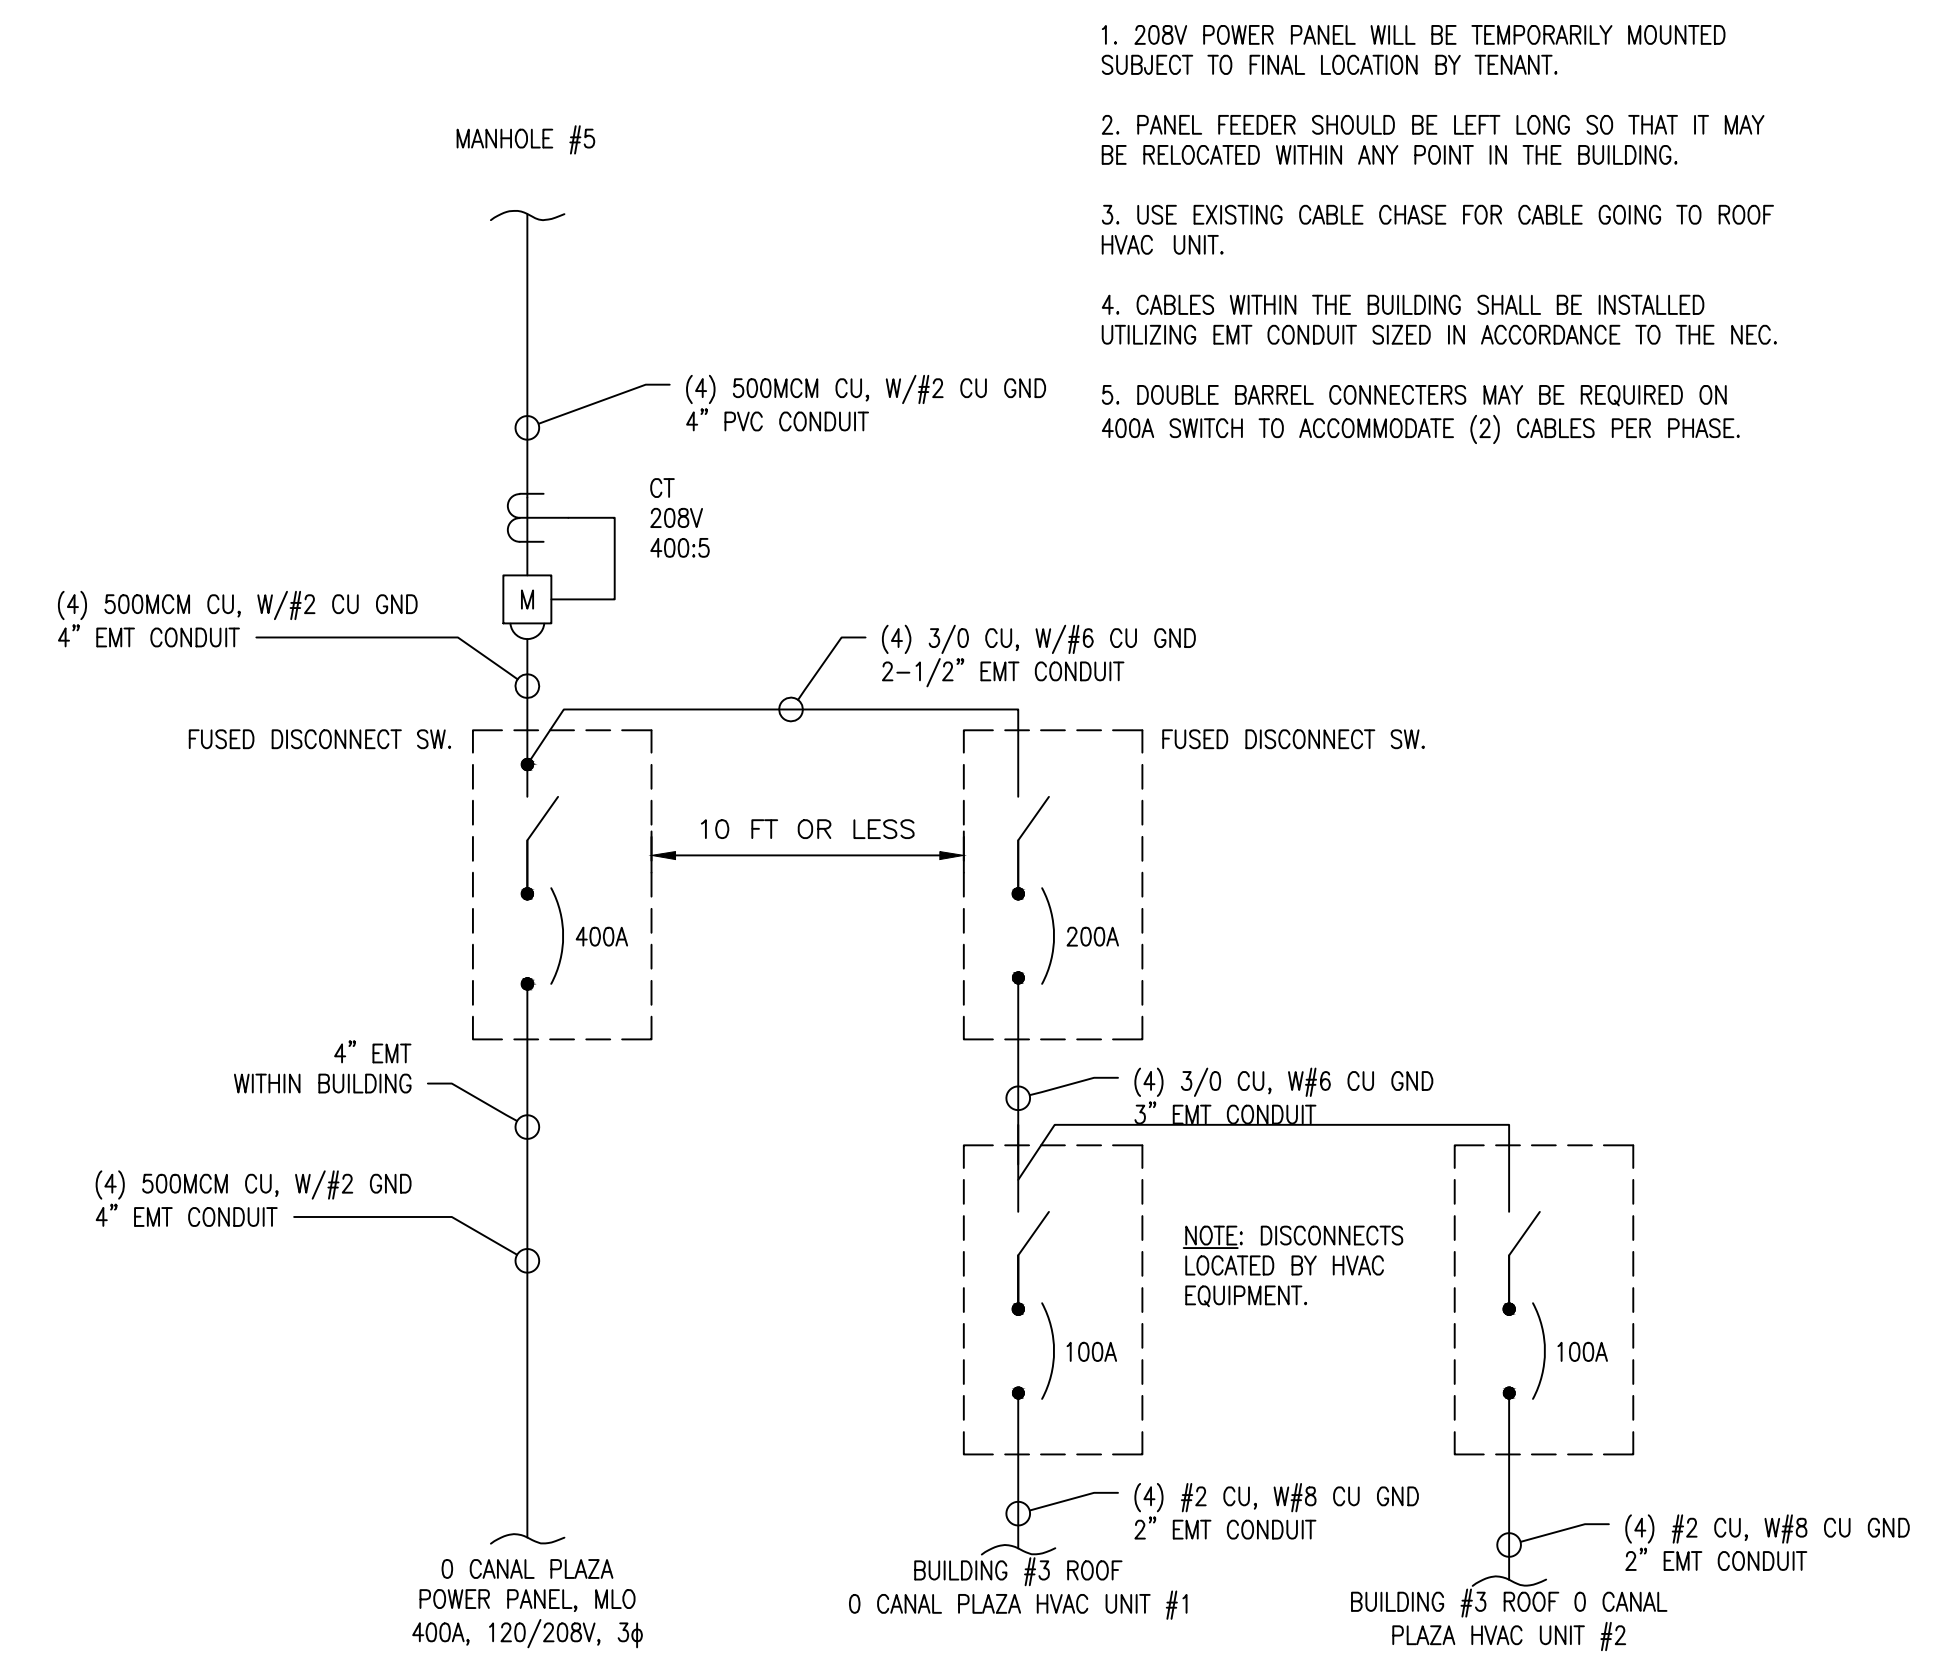

- 208V POWER PANEL WILL BE TEMPORARILY MOUNTED SUBJECT TO FINAL LOCATION BY TENANT.
- PANEL FEEDER SHOULD BE LEFT LONG SO THAT IT MAY BE RELOCATED WITHIN ANY POINT IN THE BUILDING.
- USE EXISTING CABLE CHASE FOR CABLE GOING TO ROOF HVAC UNIT.
- CABLES WITHIN THE BUILDING SHALL BE INSTALLED UTILIZING EMT CONDUIT SIZED IN ACCORDANCE TO THE NEC.
- DOUBLE BARREL CONNECTERS MAY BE REQUIRED ON 400A SWITCH TO ACCOMMODATE (2) CABLES PER PHASE.

(A) ELECTRICAL SINGLE LINE DIAGRAM

ELECTRICAL LEGEND	ABBREVIATIONS
CURRENT TRANSFORMER	A AMP
CIRCUIT BREAKER	CT CURRENT TRANSFORMER
METER	V VOLT
FUSED DISCONNECT SW.	CU COPPER
DISCONNECT SW.	GND GROUND
	SW SWITCH
	AL ALUMINUM
	MLO MAIN LUG ONLY

NOT FOR CONSTRUCTION

REV:	DESCRIPTION:	BY:	DATE:
STATUS:	BRIDGING DOCUMENTS		

RIPCORD ENGINEERING
PO BOX 4175
PORTLAND, ME 04101
207.331.7900

CLIENT: EAST BROWN COW
100 COMMERCIAL STREET
PORTLAND
MAINE

ARCHITECT: CANAL 5 STUDIO
1 CANAL PLAZA #888
PORTLAND
MAINE

SITE: 0 CANAL PLAZA

TITLE: MEP SCHEDULES & SCHEMATICS

SCALE AT A1:	DATE:	DRAWN:	CHECKED:
NTS	9/19/16	SMB	SMB
PROJECT NO:	DRAWING NO:	REVISION:	
15-016	M600	B	