


ZINC-PLATED STEEL HARDWARE INCLUDING 1/2" DIA. THREADED ROD WITH PLATE-WASHER-NUT CONNECTION

THRU-BOLT MOUNTING DETAIL NOT TO SCALE

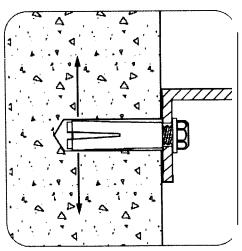

LOK-BOLT" ANCHORING SYSTEM AS MFG BY POWERS FASTENERS, NEW ROCHELLE, NY OR EQUAL:

A PRE-ASSEMBLED SINGLE UNIT SLEEVE ANCHOR FOR ANCHORING INTO SOLID AND HOLLOW CONCRETE AND MASONRY SUBSTRATES

PATENTED COMPRESSION RING PULLS FIXTURE FLUSH TO THE WORK SURFACE

AVAILABLE IN CARBON STEEL AND TYPE 304 STAINLESS STEEL; SEVERAL HEAD STYLES

SIZE RANGE: $\frac{1}{4}$ " DIA. x **5/8**" TO $\frac{3}{4}$ " DIA. x **7** $\frac{1}{2}$ "

SEE http://www.powers.com/product_06160.html

SLEEVE-ANCHOR MOUNTING DETAIL NOT TO SCALE



Neokraft Signs Inc. 686 Main Street Lewiston, Maine 04240 Telephone: 207.782.9654 Facsimile: 207.782.0009 1.800.339.2258 http://www.neokraft.com

Custom Sign Fabrication

Excepi for designs supplied by the client, oll ideas, plans or arrangements indicated on this drawing are copyrighted and owned by Neokrafl Signs Inc. ond shall not be reproduced, used by or disclosed to any person, firm or corporation without written permission of Neokrofl Signs Inc.

Temple Street Parking Garage3382

PERMIT DRAWING

Drawing No.: 6 of 9


Drawn by: DS

Dote: DS PERFLAND, ME



DOUBLE-FACE PROJECTING WALL SIGN


SCALE: 3/8"= 1'-0"

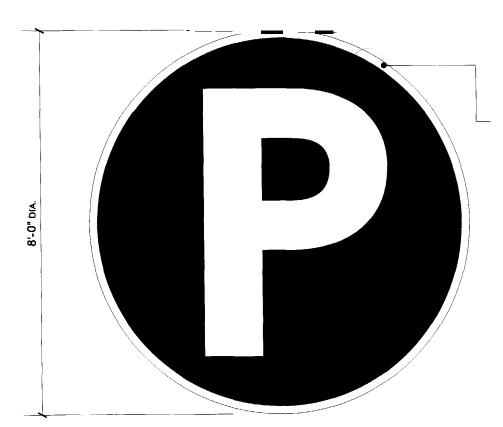

8" DEEP CIRCULAR ALUMINUM FRAME CABINET

LEXAN FACE, TRANSLUCENT VINYL BACKGROUND

ALUMINUM SIGN FRAME WILL BE ATTACHED FLUSH TO THE WALL WITH (6) 3/8" x 3%" ZINC-PLATED STEEL LAG BOLTS THROUGH 4 MM ALUMINUM COMPOSITE MATERIAL (DIBOND) CLADDING AND PLYWOOD/ALUMINUM COMPOSITE INTO EXISTING 1/2" PLYWOOD SHEATHING

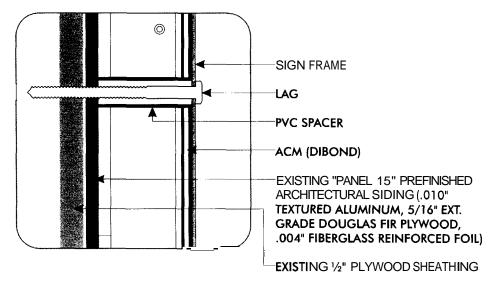

LAG-BOLT MOUNTING DETAIL NOT TO SCALE



Neokraft Signs Inc. 686 Main Street Lewiston, Maine 04240 Telephone: 207.782.9654 Facsimile: 207.782.0009 1.800.339.2258 http://www.neokraft.com


Custom Sign Fabrication

Except for designs supplied by the client, all ideas plans or arrangements indicated on this drawing are copyrighted and owned by Neokrofi Signs Inc. and shall not be reproduced, used by or disclosed to any person, firm or corporation without written permission of Neokroft Signs Inc.

4'-0"

SAME FABRICATION AS 8' DIA. SIGN

ALUMINUM SIGN FRAME WILL BE ATTACHED FLUSH TO THE WALL WITH (4) 3/8 x 3" SLEEVE ANCHORS INTO **BRICK**

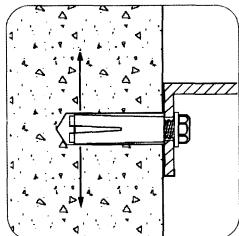

LOK-BOLT"" ANCHORING SYSTEM AS MFG BY POWERS FASTENERS, NEW ROCHELLE, NY OR EQUAL:

A PRE-ASSEMBLED SINGLE UNIT SLEEVE ANCHOR FOR ANCHORING INTO SOLID AND HOLLOW CONCRETE AND MASONRY SUBSTRATES

PATENTED COMPRESSION RING PULLS FIXTURE FLUSH TO THE WORK SURFACE


AVAILABLE IN CARBON STEEL AND TYPE 304 STAINLESS STEEL; SEVERAL HEAD STYLES

SIZE RANGE: 1/4" DIA. x 5/8" TO 3/4" DIA. x 7 1/2"

SEE http://www.powers.com/product 06160.html

INTERNALLY ILLUMINATED WALL SIGNS SCALE: 1/2"=1'-0"

(1) EACH OF (2) REQUIRED

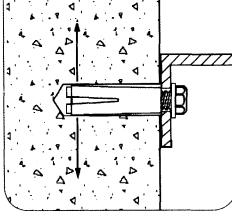

NOT TO SCALE

SLEEVE-ANCHOR MOUNTING DETAIL

Temple Street Parking Garage 3382

PERMIT DRAWING

Location: 11 Temple St. Portland, ME Drawing No.: 7 of 9 Drawn by: DS 04.05.2005 Date:



1'-6"


HOWARD INDUSTRIES GREEN L.E.D. MESSAGE DISPLAY [TCL718], 4" CHARACTER

(1) LAG MOUNTING ON BRICK WALL; (1) SLEEVE-ANCHOR MOUNTING ON ALUMINUM COMPOSITE MATERIAL (DIBOND) WALL

L.E.D. ELECTRONIC MESSAGE DISPLAY WALL SIGNS


SCALE: 1/2"=1'-0"

(2) EACH OF (2) REQUIRED

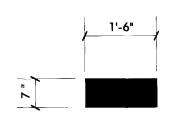

HOWARD INDUSTRIES RED L.E.D. MESSAGE DISPLAY [TCL718], 4" CHARACTER

(1) LAG MOUNTING ON BRICK WALL; (1) SLEEVE-ANCHOR MOUNTING ON ALUMINUM COMPOSITE MATERIAL (DIBOND) WALL

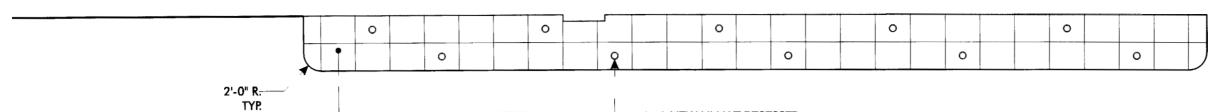

-NEW ACM (DIBOND) SOFFIT, PLATINUM WHITE, 6'-2" x 101'

REFLECTED CEILING PLAN—ACM (DIBOND) SOFFIT

SCALE: 3/32"=1'-0"

-(10) NEW HI-HAT RECESSED LIGHT FIXTURES

NOTE: "DIBOND"" MATERIAL IS AN ALUMINUM COMPOSITE MATERIAL (ACM) THAT IS MADE OF TWO STRONG SHEETS OF .012" ALUMINUM

BISTREDICTO ADURABBLEO EXARBIMECTOREAT

- -COIL-COATED POLYESTER PAINT FINISH
- -UL RECOGNIZED COMPONENT FOR ELECTRICAL SIGNAGE (UL 94V-0)
- —CLASS I AND CLASS A FIRE RATING
- -NCHRP 350 APPROVED






Neokraft Signs Inc. 686 Main Street Lewiston, Maine 04240 Telephone: 207.782.9654 Facsimile: 207.782.0009 1.800.339.2258 http://www.neokraft.com

Custom Sign Fabrication

Excepi For designs supplied by the client, all ideas, plans or arrongements indicated on this drawing ore copyrighted and owned by Neokrafl Signs Inc. ond shall not be reproduced, used by or disclosed to any person, firm or corporation without written permission of Neokrofl Signs Inc.

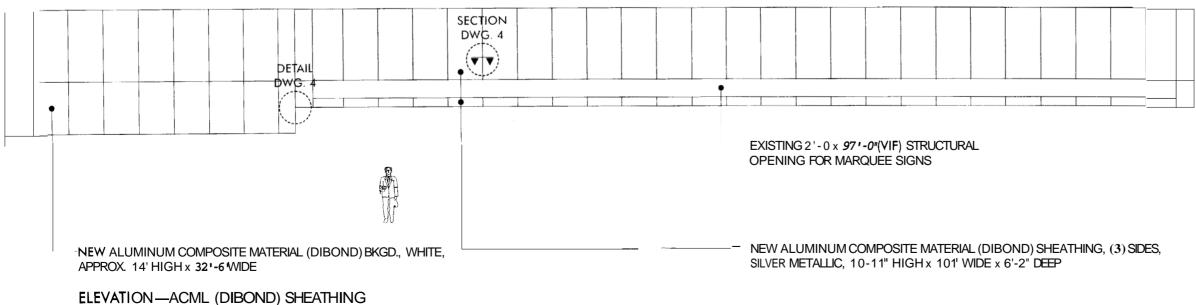


Temple Street Parking Garage 3382

PERMIT DRAWING


	Location:	11 Tem	ple St .	
		Portlan	d, ME	
	Drawing No	o.: 3 of 9		
	Drawn by:	DS		
EPT. OF E	Date: BUILDING H DEPORTLA	NSPECT ND, ME	7896	
	PR 2 5 2			
	RECEI	/ED		

SCALE: 3/32"= 1'-0"



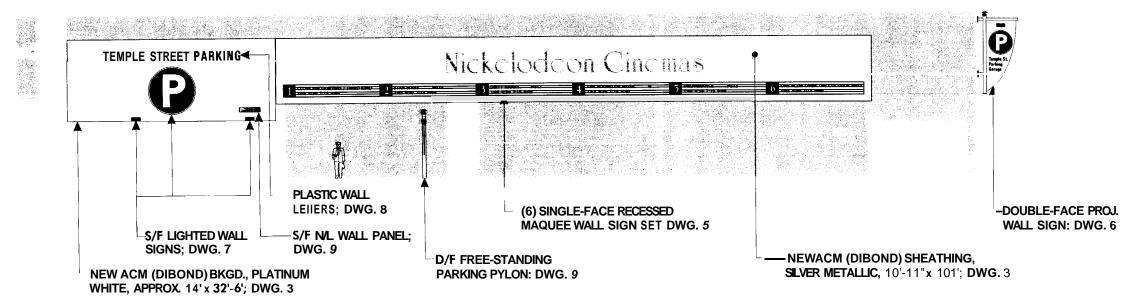

PARTIAL TEMPLE STREET ELEVATION—PROPOSED SIGNS NOT TO SCALE

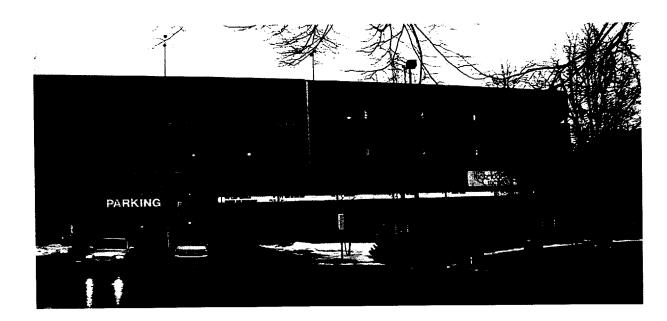

EXISTING CONDITION

NOTE: "DIBOND"" MATERIAL IS AN ALUMINUM COMPOSITE MATERIAL (ACM) THAT IS MADE OF TWO STRONG SHEETS OF .0 72 ALUMINUM BONDED TO A THERMOPLASTIC CORE

- -STRONG & DURABLE, EXTREMELY FLAT
- -COIL-COATED POLYESTER PAINT FINISH
- -- UL RECOGNIZED COMPONENT FOR ELECTRICAL SIGNAGE (UL 94V-0)
- -CLASS 1 AND CLASS A FIRE RATING
- -NCHRP 350 APPROVED



Neokraft Signs Inc. 686 Main Street Lewiston, Maine 04240 Telephone: 207.782.9654 Facsimile: 207.782.0009 1.800.339.2258 http://www.neokroft.com

Custom Sign Fobrication

Except for designs supplied by the client, all ideas, plans or arrangements indicated on this drowing are copyrighted and owned by Neokraft Signs Inc. and shall not be reproduced, used by or disclosed to any person, firm or corporation without written permission of Neokraft Signs Inc.

Temple Street Parking Garage 3382

PERMIT DRAWING

11 Temple St. Location: Portland, ME Drawing No.: 1 of 9 Drawn by: DS Date: 04.05.2005



23'-3"

TEMPLE STREET PARKING




FORMED PLASTIC WALL LETTERS

SCALE: 1/2"=1'-0"

(2) SETS TOTAL


UNIVERS 67, (1) SET WHITE, (1) SET BLACK

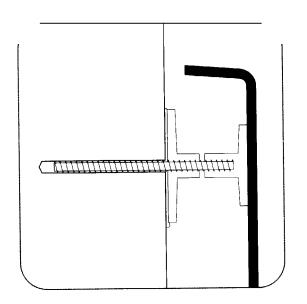

ALUMINUM STUDS, SET AND SEALED IN HOLES WITH SILICONE ADHESIVE

SILICONE ADHESIVE AT PLASTIC PADS

COMBINATION STUD-PAD-MOUNT1NG (BRICK WALL)
HALF-SCALE

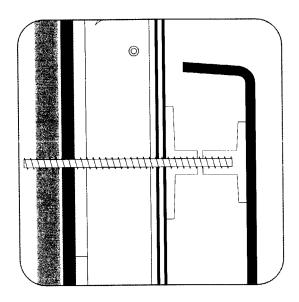

ALUMINUM STUDS, SET AND SEALED IN HOLES WITH SILICONE ADHESIVE

SILICONE ADHESIVE AT PLASTIC PADS

COMBINATION STUD-PAD-MOUNTING (ACM WALL)
HALF-SCALE

Letter Letter Face Depth Height Area Si	Area Load Force Wind Side Load Force
---	--------------------------------------

Screw				
minor			Total screws	
thread	Screw	Minimum	cross-	Total Screws
diameter	s4Xeesach	Shobore worfs	ar eact sion:ainh.	Shear
,,	(psi/each)	Screws	area (sq. in.)	Strength lbs.
0.25	0.049	4	0.196	3142

Assumptions and Facts

The point of failure will be the aluminum screws in shear at the minor thread diameter

144 mph wind speed is equal to 82.7 lbs/sq ft (0.574 lbs/sq in) Tensile trength at break for 3003 Aluminum is 16,000 ps: Average face area of a sign letter is 0.6 x height squared

Neokrafi Signs Inc. 686 Main Street Lewiston, Maine 04240 Telephone: 207.782.9654 Facsimile: 207.782.0009 1.800.339.2258 http://www.neokroft.com

Custom Sign Fabrication

Except for designs supplied by the client, all ideas, plans or arrangements indicated on this drawing are copyrighted ond owned by Neokraft Signs Inc. and shall not be reproduced, used by or disclosed to dry person, firm or corporation without written permission of Neokrafi Signs Inc.

Temple Street Parking Garage 3382

PERMIT DRAWING


Location: 11 Temple St.

Portland, ME

Drawing No.: 8 of 9

Drawn by: DS



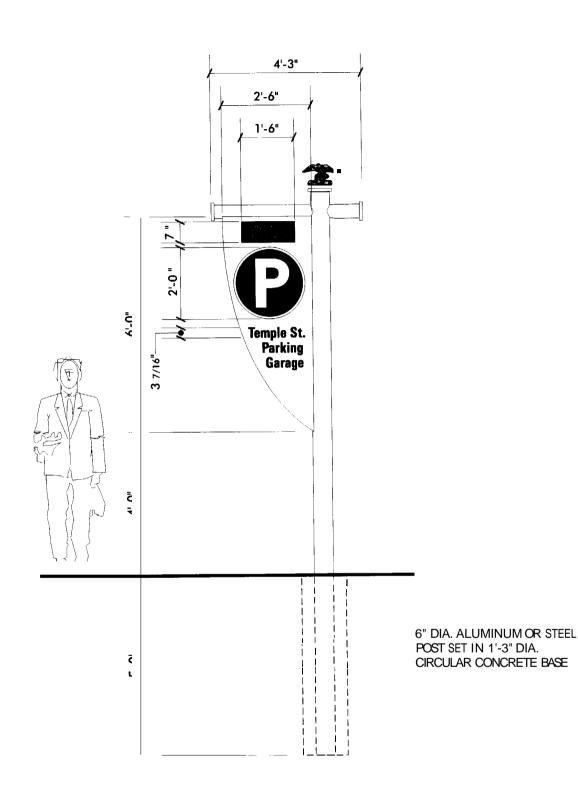

Park PUBLIC 858000 PARKING

.063" ALUMINUM, WHITE

GSP INTENSE BLUE (220-47) VINYL BACKGROUND WITH KNOCK-OUT WHITE COPY

-ATTACH TO ALUMINUM COMPOSITE
MATERIAL (DIBOND) COVERED WALL WITH (4)
1/4" x 3" ZINC-PLATED STEEL LAG BOLTS
THROUGH ACM CLADDING AND
PLYWOOD/ALUMINUM COMPOSITE INTO
EXISTING 1/2" PLYWOOD SHEATHING

FIAT ALUMINUM WALL PANEL WITH VINYL GRAPHICS

SCALE: 1/2"=1'-0"

(1) REQUIRED



Neokrafi Signs Inc. 686 Main Street Lewiston, Maine 04240 Telephone: 207.782.9654 Facsimile: 207.782.0009 1.800.339.2258 http://www.neokraft.com

Custom Sign Fabrication

Except for designs supplied by the client, oll ideas, plans or arrangements indicated on this drawing are copyrighted and owned by Neokrah Signs Inc. and shall not be reproduced, used by or disclosed to any person, firm or corporation without written permission of Neokrah Signs Inc.

Temple Street Parking Garage 3382 PERMIT DRAWING

Location: 11 Temple \$t,
Portland, ME

Drawing No.: 9 of 9

Drawn by: DS

Date: 04.05.2005

SPECTIONET

LAG-BOLT MOUNTING DETAIL NOT TO SCALE

SIGN PANEL

ZINC-PLATED STEEL SCREW

—ALUMINUM COMPOSITE MATERIAL
(DIBOND)

EXISTING "PANEL 15" PREFINISHED
ARCHITECTURAL SIDING (.010"
TEXTURED ALUMINUM, 5/16 EXT.
GRADE DOUGLAS FIR PLYWOOD,
.004" FIBERGLASS REINFORCED FOIL)


EXISTING 1/2" PLYWOOD SHEATHING DEPT. OF BUILDING INSPECTION FILE
CITY OF PORTLAND, ME

APR 2 5 2005 | RECEIVED

G:\DESIGN\03382PIZZAP)Temple St Pking)ext id)PERMIT.cdr Monday, April 11, 2005 2:09:39 PM

SCALE: 3/8"= 1'-0"


DOUBLE-FACE PARKING PYLON

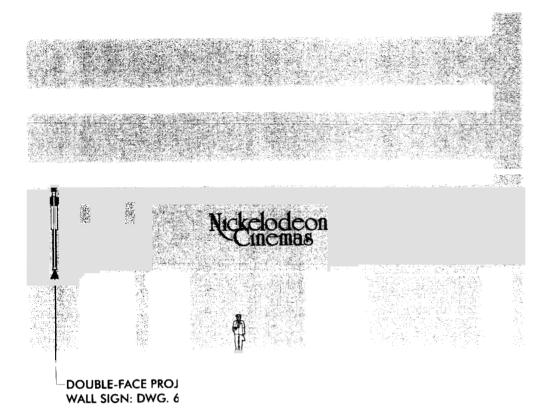

PARTIAL MIDDLE STREET ELEVATION—PROPOSED SIGNS NOT TO SCALE



EXISTING CONDITION NO SCALE

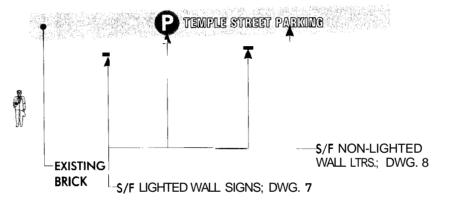

PARTIAL EXCHANGE STREET ELEVATION—PROPOS ED SIGNS
NOT TO SCALE



EXISTING CONDITION
NO SCALE



Neokraft Signs Inc. 686 Main Street Lewiston, Maine 04240 Telephone: 207.782.9654 Facsimile: 207.782.0009 1.800.339.2258 http://www.neokraft.com

Custom Sign Fabrication

Except for designs supplied by the client, all ideas, plans or arrangements indicated on this drowing are copyrighted and owned by Neokraft Signs Inc. and shall not be reproduced, used by or disclosed to any person, firm or corporation without written permission of Neokraft Signs Inc.

Temple Street Parking Garage 3382


PERMIT DRAWING

Drawing No.: 2 of 9

Drown by: DS

Date: 04.05.2005



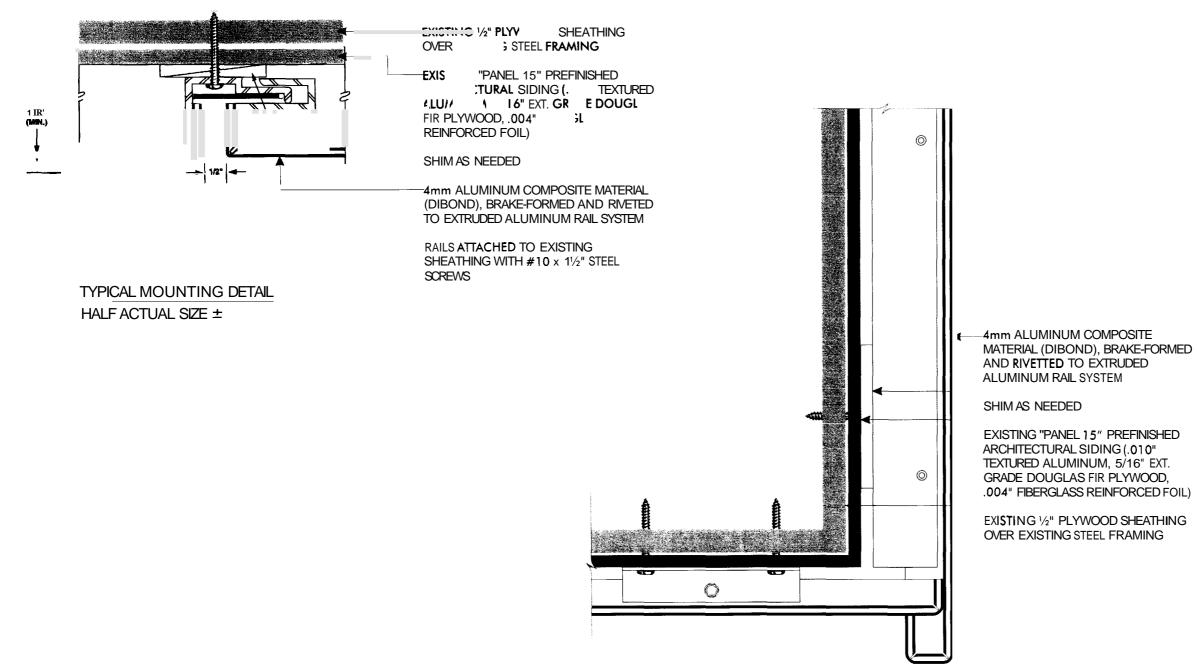

Neokraft S I G N S

Neokroft Signs Inc. 686 Main Street Lewiston, Maine 04240 Telephone: 207.782.9654 Facsimile: 207.782.0009 1.800.339.2258 http://www.neokraft.corn

Custom Sign Fabrication

Except for designs supplied by the client, oll ideos, plans or arrangements indicated on this drawing ore copyrighted ond owned by Neokroft Signs Inc. ond shall not be reproduced, used by or dixlosed to any person, firm or corporation without written permission of Neokroft Signs Inc.

Temple Street Parking Garage3382

PERMIT DRAWING

Location:	11 Temple St.		
	Portland, ME		
Drawing No	.: 4 of 9		
Drawn by:	DS		
Date:	04.05.2005		
Gen Ref.:			

SOFFIT CORNER DETAIL
HALF ACTUAL SIZE ±

DEP	T. OF BUILDING INSPECTION CITY OF PORTLAND, ME
	APR 2 5 2006
	RECEIVED

2'-0"

-(16) PER SIGN #14 \times 1 $\frac{1}{2}$ " SELF-TAPPING ZINC-PLATED STEEL SCREWS, 24" O.C., INTO EXISTING STEEL FRAMING

ALUMINUM EXTRUSION CABINET, DIVIDER & RETAINERS


WHITE TRANSLUCENT LEXAN FACES

GSP RED TRANSL [230-33] VINYL NUMERAL FIELD; (2) LINES OF 6" SLOTTED CHANGEABLE LETTERS, BLACK

SINGLE-FACE INT. ILLUM. RECESSED MARQUEE WALL SIGNS


SCALE: 1/2"=1'-0" (6) REQUIRED

0 EXISTING STEEL FRAMING WITH OPENINGS FOR EXISTING SIGNS TO BE REPLACED NEW ALUMINUM COMPOSITE MATERIAL (DIBOND) SHEATHING NEW ALUMINUM EXTRUSION SIGN BOXES

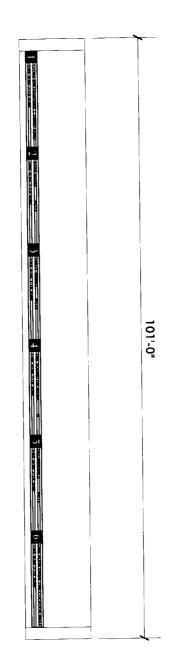

SCALE: 1/16"=1'-0" INSTALLATION CONFIGURATION

SCALE: 1"=1'-0" MOUNTING DETAIL

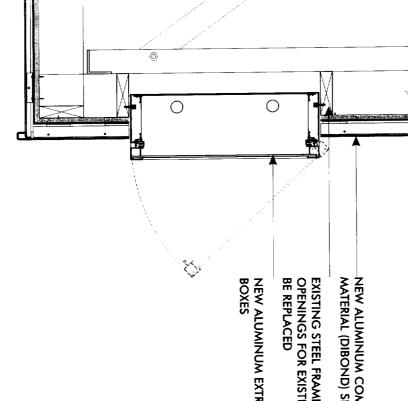





DIRTY

N.

Neokraft Signs Inc. 686 Main Street Lewiston, Maine 04240 Telephone: 207.782.9654 Facsimile: 207.782.0009 1.800.339.2258 Custom Sign Fabrication http://www.neokraft.com


Except for designs supplied by the client, all ideas, plans or arrangements indicated on this drawing are copyrighted and owned by Neokarth Signs Inc. and shall not be reproduced, used by or disclosed to any person, firm or corporation without written permission of Neokraft Signs Inc.

Parking Garage Temple Street

PERMIT DRAWING


	Drawn by:	Drawing No.: 5 of 9		Location:	
PA OF TOOK	DS	5 of 9	Portland, ME	11 Temple St.	

DEPT. OF BUILDING INSPECTION CITY OF PORTLAND, OF Ref.: RECEIVED APR 2 ى 2005 04.0**L**005

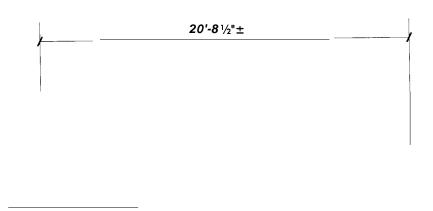


REMOVE NEON; RETROFT TO LOW-VOLTAGE RED L.E.D. ILLUMINATION, CONNECTION THROUGH WALL (<24V) TO REMOTE TRANSFORMER

NEW ILLUMINATION FOR EXISTING LIGHTED WALL LEHERS SCALE: 3/16"=1'-0" (1) SET

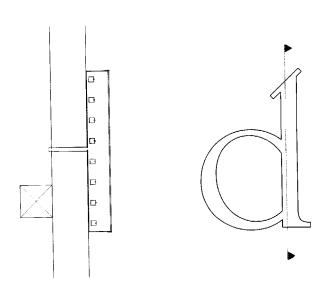

B TYPICAL L.E.D. LIGHTING DETAIL NO SCALE

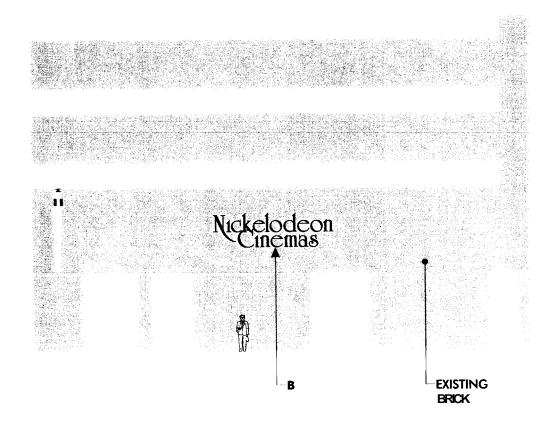

PARTIAL MIDDLE STREET ELEVATION NOT TO SCALE



EXISTING CONDITION _ _ _ NO SCALE



Neokroft Signs Inc. 686 Main Street Lewiston, Maine 04240 Telephone: 207.782.9654 Facsimile: 207.782.0009 1.800.339.2258 http://www.neokroft.com

Custom Sign Fobricotion

Except for designs supplied by the client, all ideas, plans or arrangements indicated on this drowing are copyrighted and owned by Neokraft Signs Inc. and shall not be reproduced, used by or disclosed to any person, firm or corporation without written permission of Neokraft Signs Inc.

Nickelodeon Cinemas 3383

PERMIT DRAWING

Location: 11 Temple St.

Portland, ME

Drawing No.: 2 of 2

Drawn by: DS

Date: 03.07.2005

Revised: 04.05.2005

Gen Ref.:

DEPT. OF BUILDING INSPECTION

CITY OF PORTLAND, ME



T Nickelodeon Cinemas

43'-7 1/2"±

RED FACES. SILVER TRIM AND RETURNS

LOW-VOLTAGE RED L.E.D. ILLUMINATION, CONNECTION THROUGH WALL (<24Y) TO REMOTE TRANSFORMER

1/4"x 31/2" ZINC-PLATED STEEL LAG BOLT CONNECTION THROUGH LEHER BACKS, NEW ACM (DIBOND) SHEATHING AND EXISTING 1/2" THICK PLYWOOD SHEATHING—MIN. (4) BOLTS PER LETTER

NO LEIJER WILL WEIGH MORE THAN 50 LBS.

FABRICATED INTERNALLY ILLUMINATED WALL LETTERS


SCALE: 1/8"=1'-0'

(1) SET REQUIRED

Nickelodeon Cinemas

PARTIAL TEMPLE STREET ELEVATION—LIGHTED WALL LEIIERS

NOT TO SCALE $(1/16"=1'-0"\pm)$

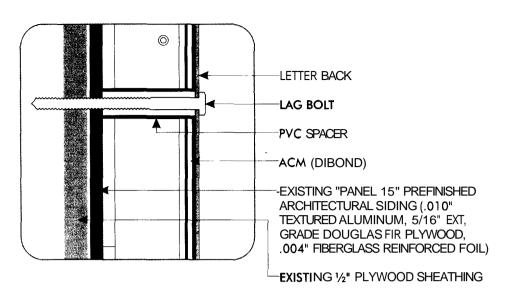

LAG-BOLT MOUNTING DETAIL
NOT TO SCALE

NOTE "DIBOND"" MATERIAL IS AN ALUMINUM COMPOSITEMATERIAL (ACM) THAT'S MADE OF TWO STRONG SHEETS OF .012" ALUMINUM BONDED TO A THERMOPLASTIC CORE

- -STRONG & DURABLE, EXTREMELY FIAT
- -COIL-COATED POLYESTER PAINT FINISH
- -UL RECOGNIZED COMPONENT FOR ELECTRICAL SIGNAGE (UL 94V-0)
- -CLASS | AND CLASS A FIRE RATING
- -NCHRP 350 APPROVED



Neokraft Signs Inc. 686 Main Street Lewiston, Maine 04240 Telephone: 207.782.9654 Facsimile: 207.782.0009 1.800.339.2258 http://www.neokroft.com

Custom Sign Fabrication

Except for designs supplied by the client, all ideas, plans or orrongements indicated on this drawing are copyrighted and owned by Neokroft Signs Inc. ond shall not be reproduced, used by or disclosed to any person, firm or corporation without written permission of Neokraft Signs Inc.

wind Face Wind Side Depth Height Area Side Area Load Force Load Force (sq in **)** 2**8**8 (lbs) minor Total screws Screw Minimum Total Screws thread cross-Area No of Shear sectional diameter (psi/each) Screws Strength lbs 0049

Assumptioffailure will do the aluminum screws in shear at the minor

read diameter

144 mph wind speed is equal to 82 7 lbs/sq ft (0 574 lbs/sq in) Tensile trength at break for3003 Aluminum is 15,000 ps/ Average face area of a sign letter is 0.6 x height squared.

Nickelodeon Cinemas 3383

PERMIT DRAWING

Location: 11 Temple St.

Portland, ME

Drawing No.: 1 of 2

Drawn by: DS

Date: 03.07.2005



43'-7 ½"±

RED FACES. SILVER TRIM AND RETURNS

LOW-VOLTAGE RED LE.D. ILLUMINATION, CONNECTION THROUGH WALL (<24V) TO REMOTE TRANSFORMER


1/4"x 31/2" ZINC-PLATED STEEL LAG BOLT CONNECTION THROUGH LEIIER BACKS, NEW ACM (DIBOND) SHEATHING AND EXISTING 1/2" THICK PLYWOOD SHEATHING—MIN. (4) BOLTS PER LEIIER

NO LEIIER WILL WEIGH MORE THAN 50 LBS.

FABRICATED INTERNALLY ILLUMINATED WALL LETTERS

SCALE: 1/8"=1'-0"

(1) SET REQUIRED

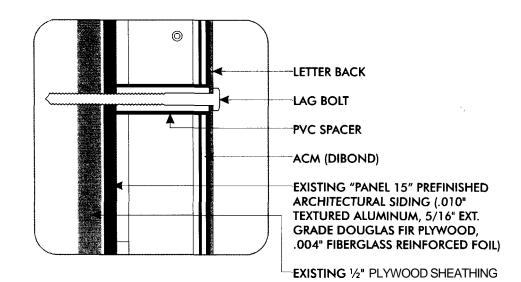

LAG-BOLT MOUNTING DETAIL NOT TO SCALE

NOTE: "DIBOND"" MATERIAL IS AN ALUMINUM COMPOSITE MATERIAL (ACM) THAT IS MADE OF TWO STRONG SHEETS OF .012" ALUMINUM BONDED TO A THERMOPLASTIC CORE

- -STRONG & DURABLE, EXTREMELY FLAT
- -COIL-COATED POLYESTER PAINT FINISH
- —UL RECOGNIZED COMPONENT FOR ELECTRICAL SIGNAGE (UL 94V-0)
- -CLASS 1 AND CLASS A FIRE RATING
- -NCHRP 350 APPROVED



Neokraft Signs Inc. 686 Main Street Lewiston, Maine 04240 **Telephone:** 207.782.9654 Facsimile: 207.782.0009 1.800.339.2258 http://www.neokraft.com

Custom Sign Fobricotion

Except for designs supplied by the client, all ideas, plans or arrangemenis indicated on this drawing are copyrighted and owned by Neokrafi Signs Inc. and shall not be reproduced, used by or disclosed to any person, firm or corporation without written permission of Neokrafi Signs Inc.


Nickelodeon Nickelodeon Cinemas 3383

PERMIT DRAWING

Portland, ME

Location: 11 Temple \$t.

Drowing No.: 1 of 2

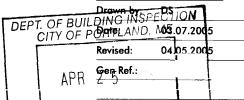

APR Gen Ref.:


RECEIVED

Nickelodeon Cinemas

PARTIAL TEMPLE STREET ELEVATION—LIGHTED WALL LEIIERS

NOT TO SCALE $(1/16" = 1'-0" \pm)$


G:\DESIGN\03383PATRIO\Nickelodeon CinemaslTemple Stlext id.cdr Tuesday, April 05, 2005 12:37:48 PM

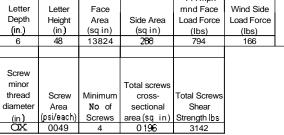


Assumptions and Facts


The point of failure will be the aluminum screws in shear at the minor thread diameter

144 mph wind speed is equal to 82 7 lbs/sq ft (0 574 lbs/sq in) Tensile trength at break for 3003 Aluminum is 16,000 psi Average face area of a sign letter is 0.6 x height squared

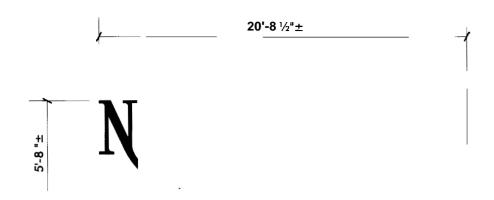

REMOVE NEON; RETROFIT TO LOW-VOLTAGE RED LE.D. ILLUMINATION, CONNECTION THROUGH WALL (<24V) TO REMOTE TRANSFORMER

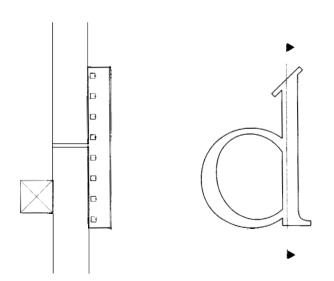

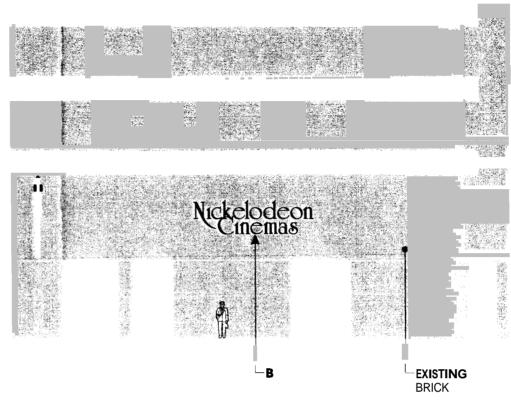

PARTIAL MIDDLE STREET ELEVATION

NOT TO SCALE



EXISTING CONDITION

NO SCALE



Neokraft Signs Inc. 686 Main Street Lewiston, Maine 04240 Telephone: 207.782.9654 Facsimile: 207.782.0009 1.800.339.2258 http://www.neokraft.com

Custom Sign Fabrication

Except for designs supplied by the client, all ideas, plans or arrangements indicated on this drawing are copyrighted and owned by Neokrafi Signs Inc. and shall not be reproduced, used by or disclosed to any person, firm or corporation without written permission of Neokrafi Signs Inc.

Nickelodeon Cinemas 3383

PERMIT DRAWING

Location: 11 Temple \$t.

Portland, ME

Drawing No.: 2 of 2

Drawn by: DS

Date: 03.07.2005
Revised: 04.05.2005

Gen Ref.: