

PROJECT SITE:

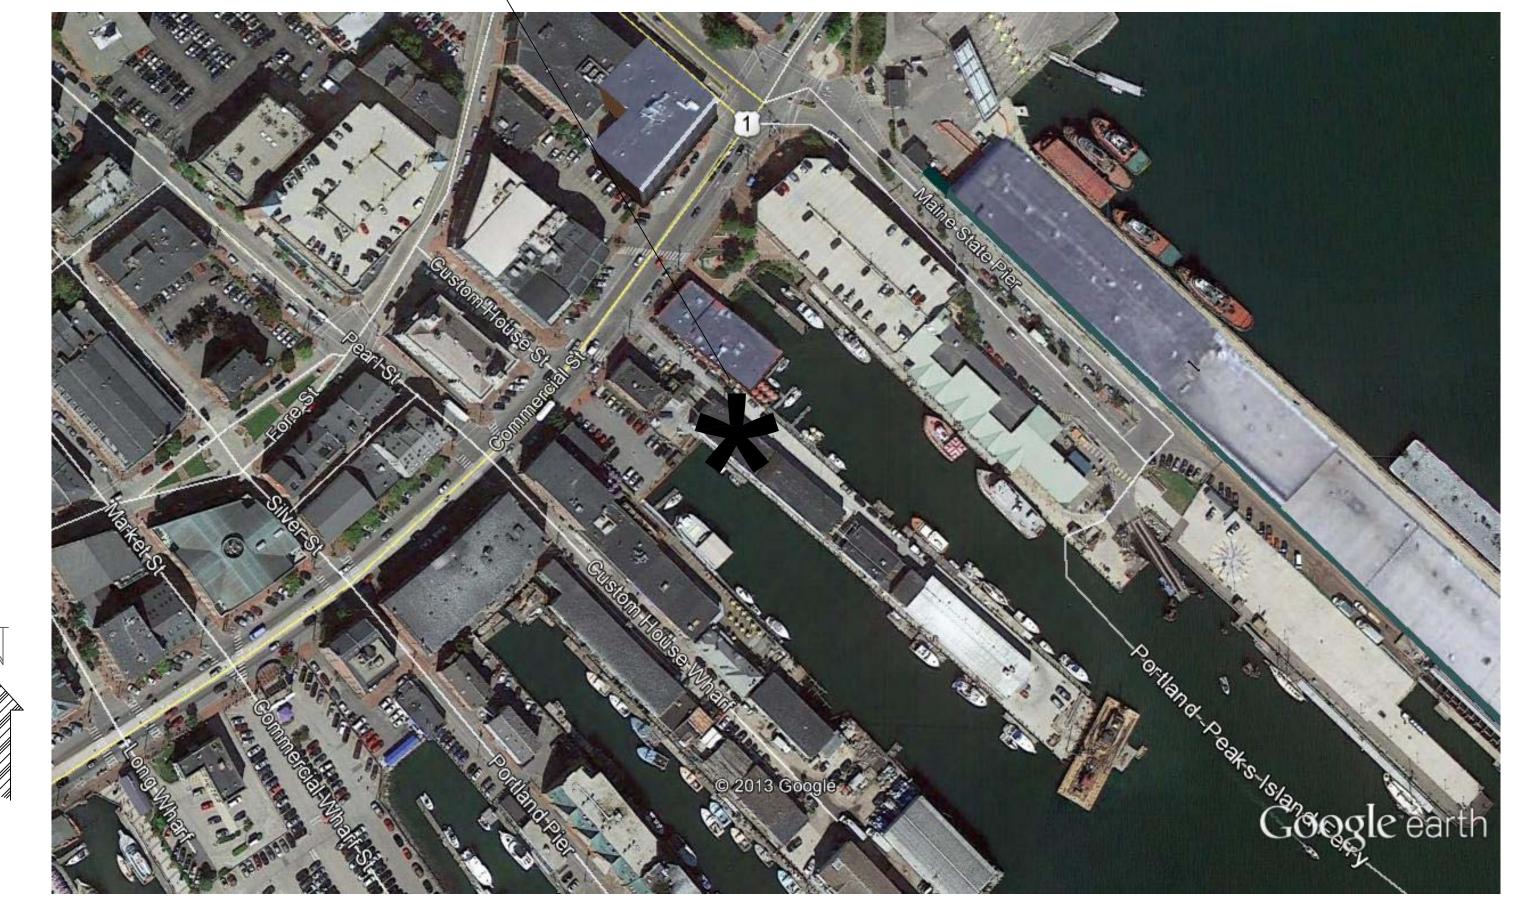

SITE PLAN SCALE: N.T.S.

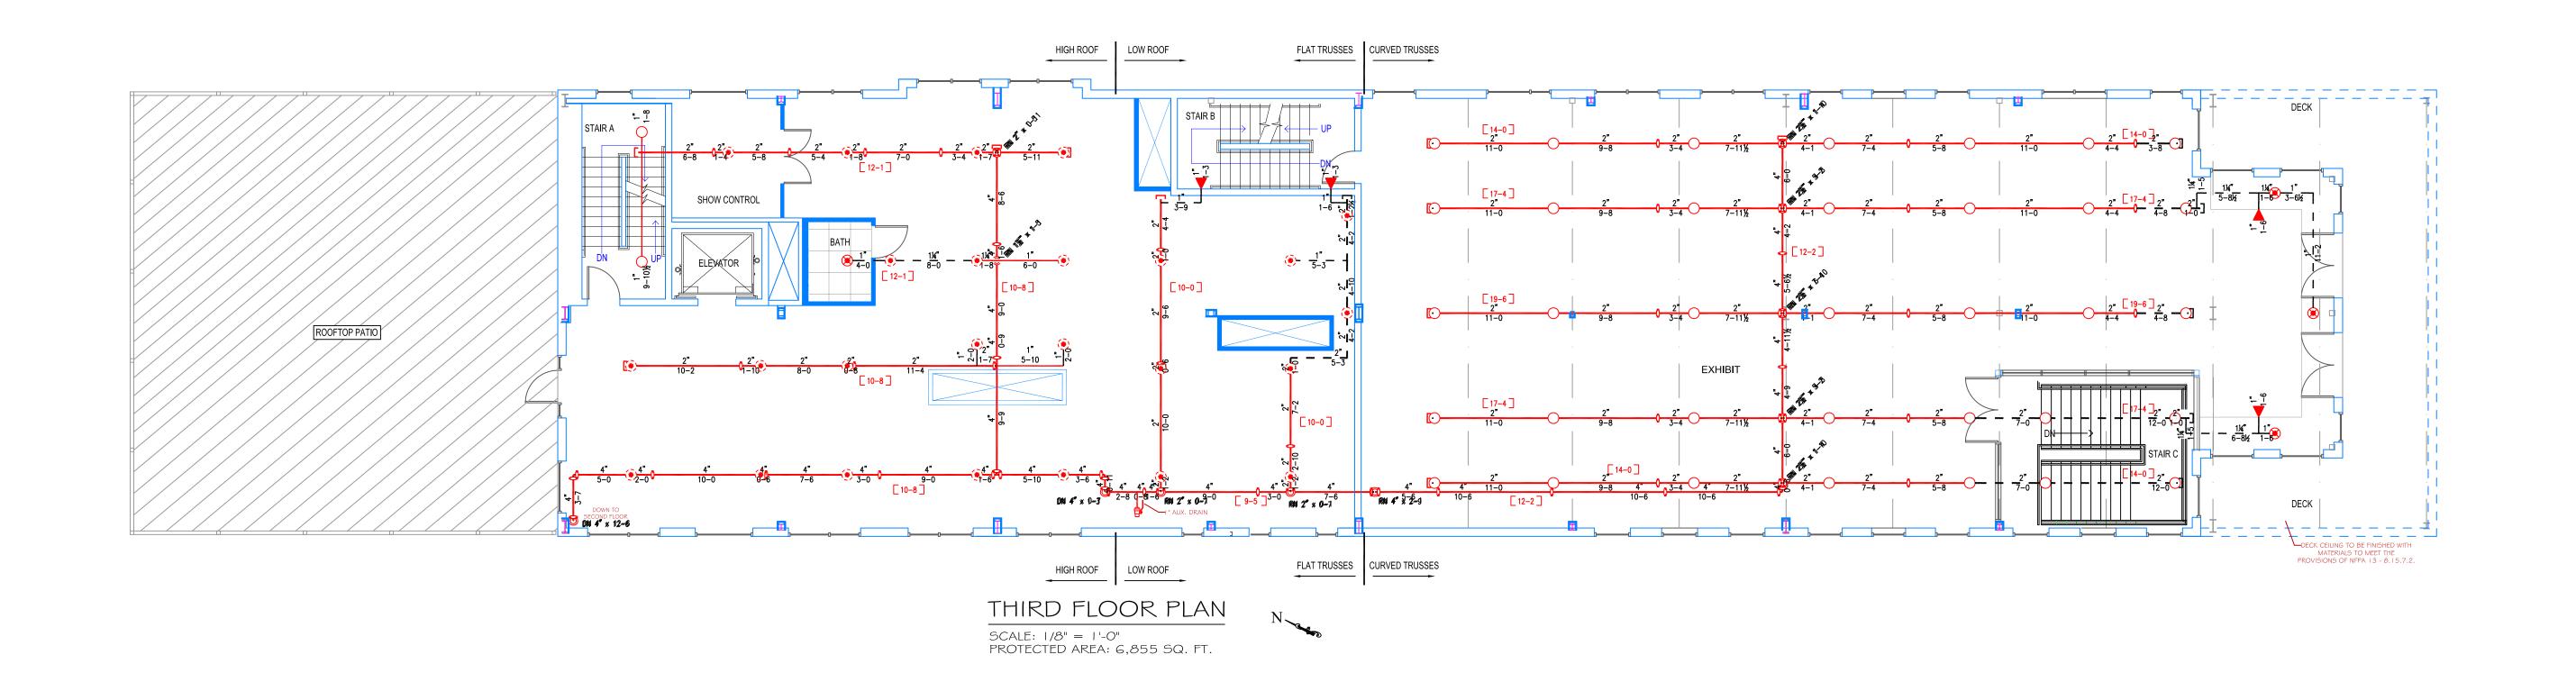

HIGH TECH FIRE PROTECTION P.O. BOX 156

MINOT, ME. 04258-0258 TEL:(207) 998-2551 FAX:(207) 998-4187

MAINE LICENSE # 102 ARCHITECT:

ARCHITECTS PORTLAND, ME

LEGEND:

O RN PIPE RISER UP O DN PIPE RISER DOWN

—— STEEL PIPE (EXISTING) STEEL PIPE (NEW) **WET SYSTEM RISER**

A HYDRAULIC CALC. POINT XX-X PIPE ELEVATION A.F.F.

DESIGN NOTES: ALL PIPING 1 1/2" AND LARGER TO BE SCHEDULE 10 STEEL W/ GROOVED FITTING. *ALL PIPING 1 1/4" AND SMALLER TO BE SCHEDULE 40 STEEL WITH THREADED

*POSITION, LOCATION, SPACING, AND USE OF SPRINKLERS AND HANGERS SHALL BE IN ACCORDANCE WITH NFPA 13 2010 ed. *HYDRAULIC CALCULATION PROCEDURES HAVE BEEN DONE IN ACCORDANCE WITH NFPA 13 2010 ed. (SEE PLANS FOR LOCATION OF REMOTE AREAS, HYDRAULIC REFERENCE POINTS, AND SYSTEM DEMANDS)

*ALL ELECTRICAL WORK TO BE DONE BY OTHERS. *DIMENSIONS AND LOCATIONS GIVEN FOR SPRINKLER HEADS AND PIPE MAY VARY TO ACCOMODATE ACTUAL FIELD CONDITIONS. *OWNER TO PROVIDE SUFFICIENT HEAT TO PREVENT FREEZING IN WATER FILLED SPRINKLER PIPE AND EQUIPMENT. *OTHER TRADES TO COORDINATE THEIR WORK WITH SPRINKLER CONTRACTOR. ALL NEWLY INSTALLED SPRINKLER HEADS ARE TO BE QUICK RESPONSE U.N.O. *OWNER IS RESPONSIBLE FOR MAINTAINING THE SPRINKLER SYSTEM/S IN ACCORDANCE WITH THE CURRENT EDITION OF NFPA 25, "INSPECTIONS TESTING AND MAINTENANCE OF WATER BASED FIRE PROTECTION SYSTEMS" AND/OR ALL APPLICABLE FEDERAL, STATE, AND LOCAL LAWS, CODES AND ORDINANCES.

GLOBE* MODEL GL5615 37 / 155° K=5.6 1/2" BRASS UPRIGHT (130 SQ. FT. ORD. HAZARD)

> GLOBE* MODEL GL5601 4 /155° K=5.6

1/2" SEMI RECESSED WHITE PENDENT (225 SQ. FT. SPACING - LIGHT) (130 SQ. FT. SPACING - ORD.)

> **GLOBE*** MODEL GL5601 25 / 155° K=5.6

1/2" WHITE PENDENT (225 SQ. FT. SPACING - LIGHT) (130 SQ. FT. SPACING - ORD.)

GLOBE* MODEL GL5626 K=5.6 1/2" WHITE SEMI-RECESSED HORIZONTAL SIDEWALL

(100 SQ. FT. ORD. HAZARD) (196 SQ. FT. LIGHT HAZARD)

* OR APPROVED EQUAL

TOTAL HEADS ON SHEET: 70 SCALE:

SCALE 1/8"=1'-0" DATE: JULY 15, 2015

DESIGNER: JEREMY A. FOSS MAINE RMS #808 NICET LEVEL III CERT. #126801 CHECKED BY: E. POULIN (RMS# 515)

NICET LEVEL IV CERT. # 108534 LOCATION:

68 COMMERCIAL ST. PORTLAND, ME

MAINE WHARF TENANT FIT-UP (THIRD FLOOR)
FIRE PROTECTION PLAN
(NFPA 13 2010 ed.)

DRAWING NO.:

FP-1.2