

IBC 2009 CODE DATA	
USE GROUP CLASSIFICATION	BUSINESS
TYPE OF CONSTRUCTION	EXISTING TO REMAIN
EXISTING BUILDING AREA	EXISTING TO REMAIN
PROPOSED BUILDING AREA	EXISTING TO REMAIN
TOTAL AREA OF WORK	112 SF
BUILDING HEIGHT (STORES/ FEET)	4 STORES
BUILDING AREA LIMITATION - SQ FT (TABLE 503)	EXISTING TO REMAIN
BUILDING HEIGHT LIMITATION - STORES (TABLE 503)	EXISTING TO REMAIN
INCREASE STREET FRONTAGE (80% AREA) - SQ FT	.
INCREASE AUTOMATIC SPRINKLER SYSTEM AREA (200% AREA) - SQ FT	.
INCREASE AUTOMATIC SPRINKLER SYSTEM HEIGHT (1 STORY)	N/A
TRAVEL COMMON PATH LIMIT (ALLOWABLE/ ACTUAL)	100/ NONE
TRAVEL DEAD-END LIMIT (ALLOWABLE/ ACTUAL)	50/ NONE
TRAVEL EXIT ACCESS TRAVEL DISTANCE LIMIT (ALLOWABLE/ ACTUAL)	300/ 53
FIRE SUPPRESSION SYSTEM	NONE
NUMBER OF REQUIRED EXITS	ONE
EXIT ACCESS FIRE RATINGS	
FIRE WALLS/ BARRIERS	
OCCUPANCY SEPARATION	ETR
PARTY WALLS	ETR
STAR ENCLOSURES	ETR
SHAFTS	ETR
EXIT ACCESS CORRIDORS	ETR
FIRE PROTECTION OF STRUCTURE	
PRIMARY STRUCTURAL FRAME	ETR
SECONDARY STRUCTURAL FRAME	ETR
LOAD BEARING WALLS - EXTERIOR	ETR
LOAD BEARING WALLS - INTERIOR	ETR
NON-LOAD BEARING WALLS - EXTERIOR	ETR
NON-LOAD BEARING WALLS - INTERIOR	ETR
FLOOR CONSTRUCTION	ETR
ROOF CONSTRUCTION	ETR
OCCUPANT LOAD	112 People
BUSINESS	112 SF 100 SF/ PERSON = 1
GENERAL NOTES	

NFPA 101 2009 & 220 2006 CODE DATA	
USE GROUP CLASSIFICATION	BUSINESS
TYPE OF CONSTRUCTION	EXISTING TO REMAIN
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FIRE SUPPRESSION SYSTEM	NONE
NUMBER OF REQUIRED EXITS	ONE
EXIT ACCESS FIRE RATINGS	
FIRE WALLS/ BARRIERS	
OCCUPANCY SEPARATION	ETR
PARTY WALLS	ETR
STAR ENCLOSURES	ETR
SHAFTS	ETR
EXIT ACCESS CORRIDORS	ETR
FIRE PROTECTION OF STRUCTURE	
COLUMNS	ETR
BEAMS, GIRDERS, TRUSSES & ARCHES	ETR
LOAD BEARING WALLS - EXTERIOR	ETR
LOAD BEARING WALLS - INTERIOR	ETR
NON-LOAD BEARING WALLS - EXTERIOR	ETR
NON-LOAD BEARING WALLS - INTERIOR	ETR
FLOOR CONSTRUCTION	ETR
ROOF CONSTRUCTION	ETR
OCCUPANT LOAD	112 People
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GENERAL NOTES	

DEMOLITION NOTES:

- ALL DASHED WALLS AS SHOWN TO BE REMOVED. G.C. TO FIELD VERIFY & REPORT ANY DISCREPANCIES OR LOAD BEARING WALLS TO THE ARCHITECT.
- ELECTRIC POWER TO THE TENANT SPACE ONLY SHALL BE DISCONNECTED PRIOR TO DEMOLITION. VERIFY WATER SHUT-OFF W/ BUILDING OWNER. EXISTING DUCT WORK TO REMAIN SHALL BE SEALED. SPRINKLER SYSTEMS, WHERE APPLICABLE, SHALL REMAIN OPERATIONAL UNLESS PERMITTED BY THE CITY BUILDING INSPECTOR. FIRE ALARM SYSTEMS TO REMAIN FULLY OPERATIONAL DURING DEMOLITION.
- DUST BARRIER PARTITIONING SHALL BE INSTALLED @ TENANT SEPARATIONS AS REQUIRED.
- ALL DEMOLITION SHALL BE REMOVED FROM THE REAR OF THE BUILDING ONLY.
- REMOVE EXISTING CEILING IN THEIR ENTIRETY AS REQUIRED PER PLAN.
- ALL FIRE PROTECTION, GYPSUM DRYWALL &/OR FIRESPRAY ON STRUCTURAL MEMBERS, INCLUDING BEARING WALLS, FIRE SEPARATION WALLS, BEAMS, COLUMNS & FIRE RATED FLOOR/ CEILING ASSEMBLIES SHALL NOT BE REMOVED.
- PROTECT ALL FINISHES, MATERIALS AND EQUIPMENT NOTED AS EXISTING TO REMAIN.
- DIMENSIONS INDICATED +/- ARE EXISTING CONDITION DIMENSIONS TO BE VERIFIED IN FIELD.
- REMOVE EXISTING PLUMBING FIXTURES IF ANY, VENTING AND ASSOCIATED EXHAUST FANS. CAP PLUMBING FLUSH WITH FLOOR.
- FIELD VERIFY ALL STRUCTURAL COMPONENTS PRIOR TO DEMOLITION. REPORT ANY DISCREPANCIES IMMEDIATELY TO ARCHITECT.


PROJECT NOTES:

- SCOPE OF WORK: THE PROJECT INCLUDES THE TENANT FIT-UP OF INTERIOR WALLS FOR "COASTAL MAINE PSYCHIATRY" (NO CHANGE OF USE).
- ELECTRICAL: ALL NEW WORK SHALL MEET THE NEC AND NFPA 70. ALL LIFE SAFETY INTEGRATION W/ THE EXISTING SHALL MEET NFPA 72 & CITY OF PORTLAND FIRE DEPARTMENT.
- ALL NEW INTERIOR FINISHES SHALL MEET: WALLS & CEILINGS: CLASS A OR B - FLOOR FINISHES: NOT LESS THAN CLASS II.
- FURNITURE, FIXTURES AND EQUIPMENT: SHALL BE FLAME RESISTANT & MEET NFPA 701, STANDARD METHODS OF FIRE TESTS FOR FLAME PROPAGATION OF TEXTILES & FILMS.
- ALL EXISTING EGRESS COMPONENTS SHALL REMAIN AS SHOWN ON DRAWINGS
- HVAC - VERIFY EXISTING HVAC SYSTEM & DUCT WORK WITH PROPOSED PLAN.



DOOR NOTES:

- EXISTING DOOR TO REMAIN
- NEW DOOR, 3'-0" x 7'-0" TO MATCH EXISTING STYLE, TYPE AND FINISH, ADA LEVER HARDWARE TO MATCH EXISTING.

WALL LEGEND

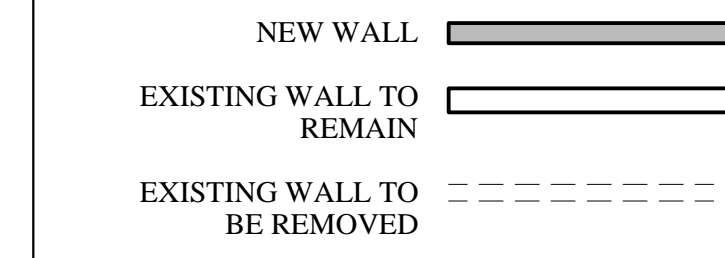


*INSTALL ALL MATERIALS PER MANUFACTURE REQUIREMENTS

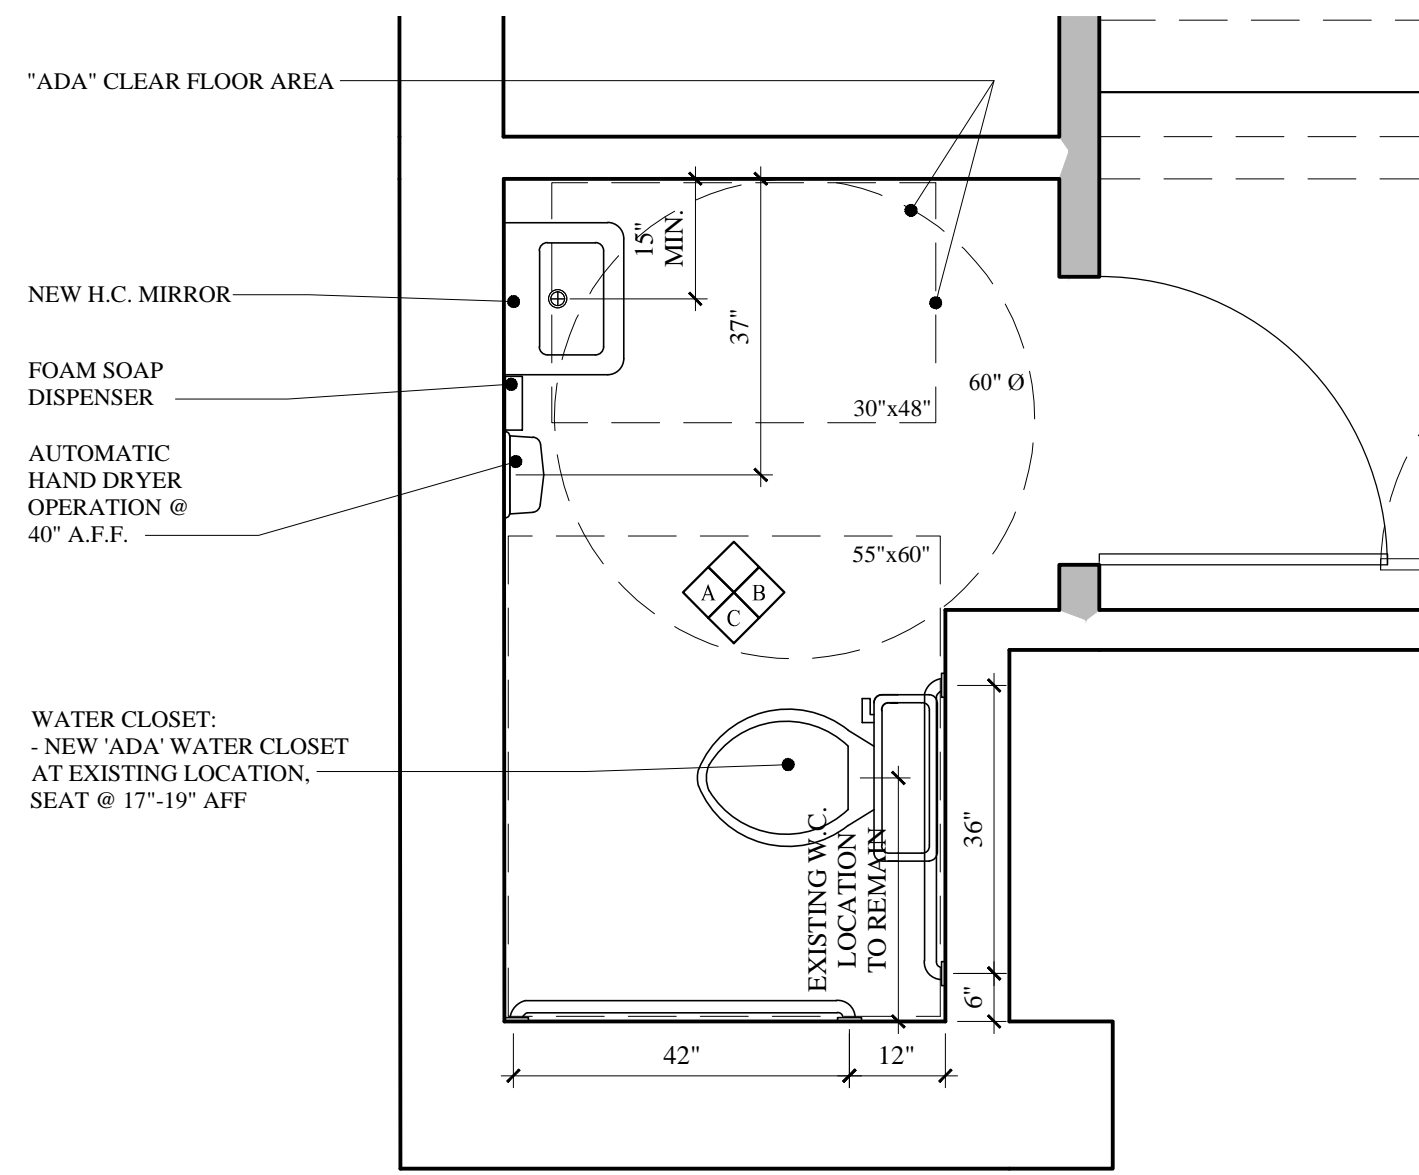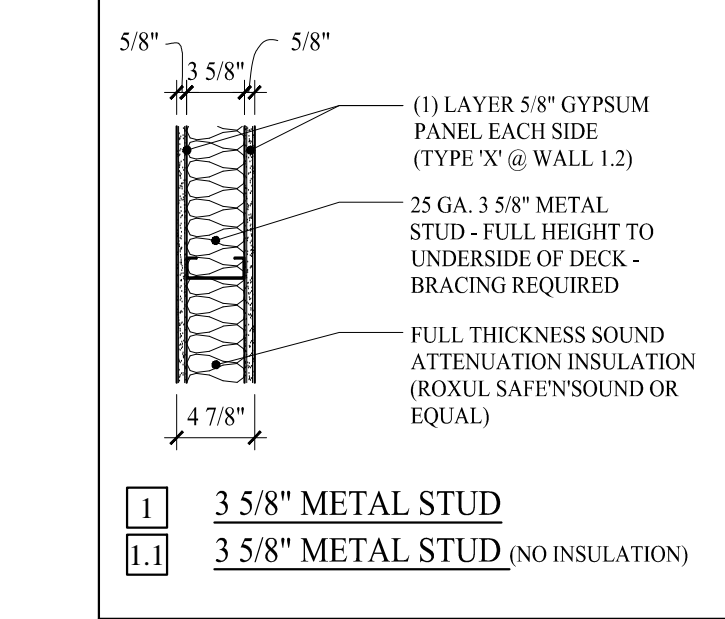


ENLARGED TOILET PLAN


SCALE: 1/2"=1'-0"

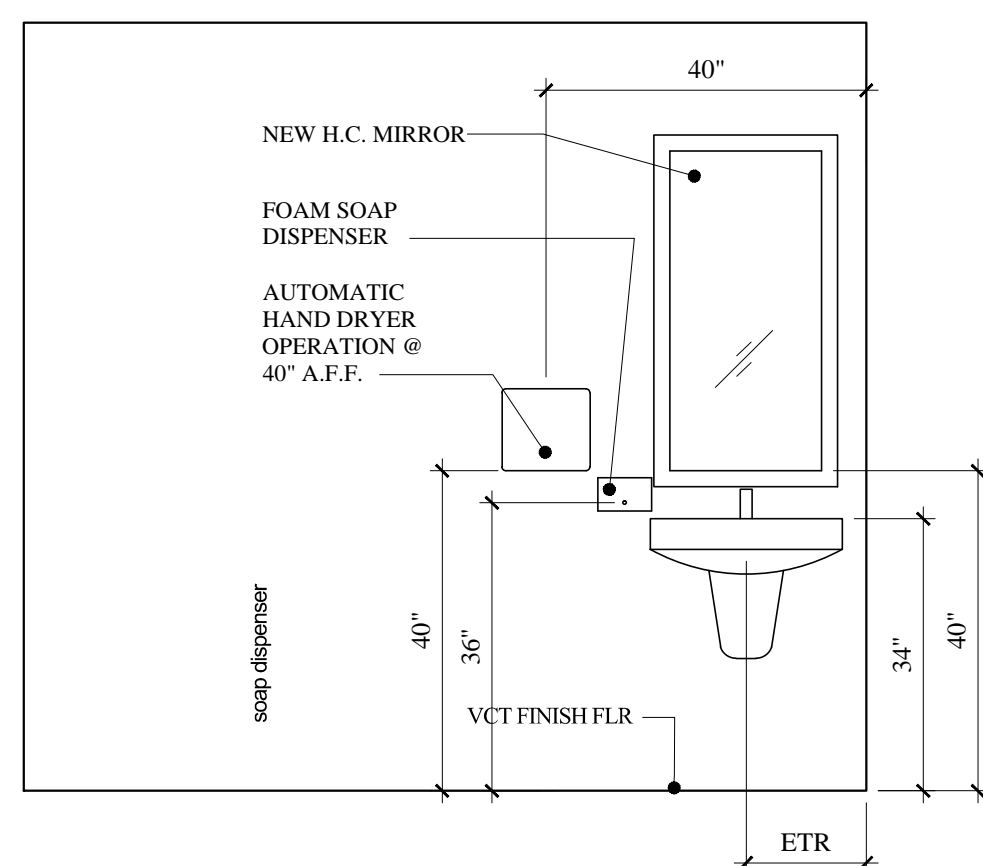


ELEVATION 'A'

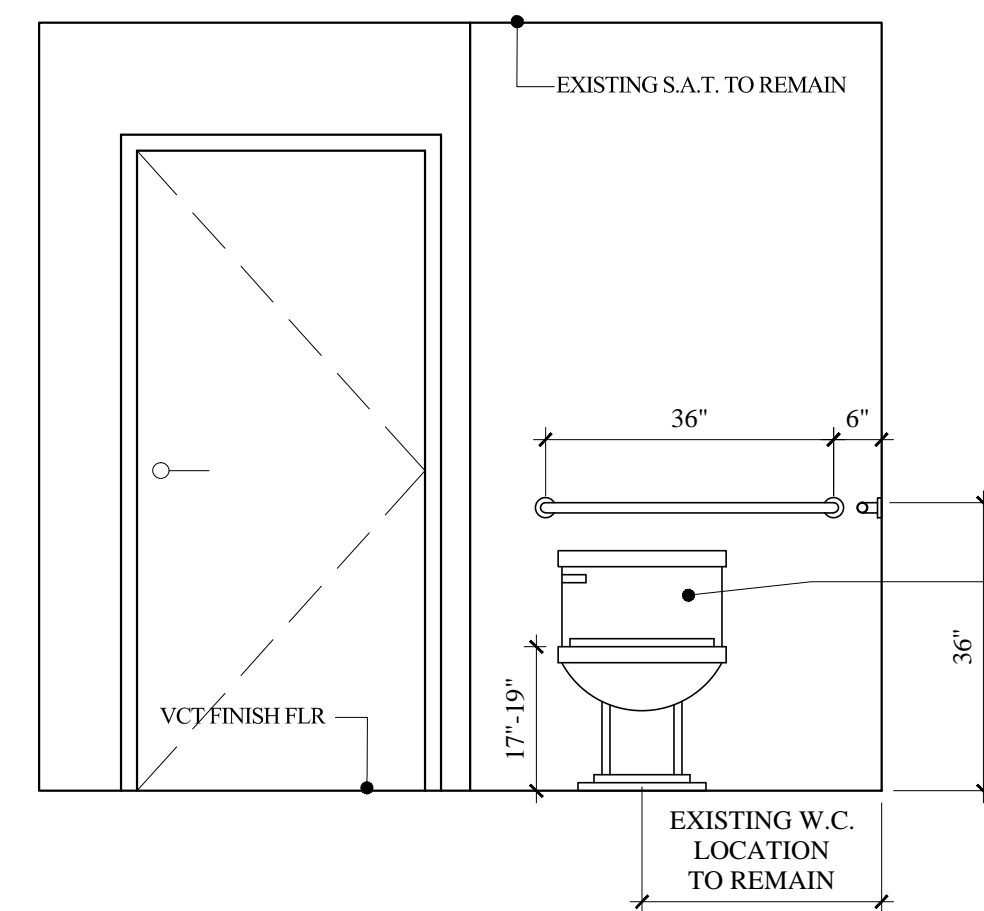

ELEVATION 'B'

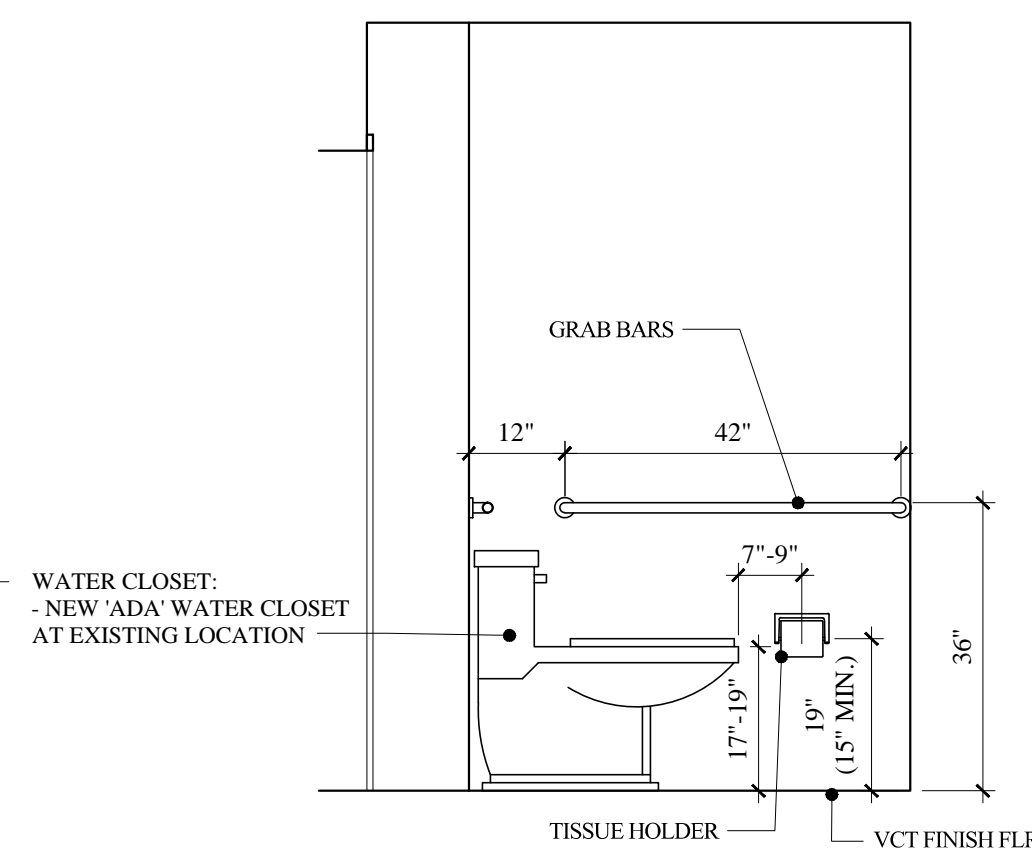


ELEVATION 'C'

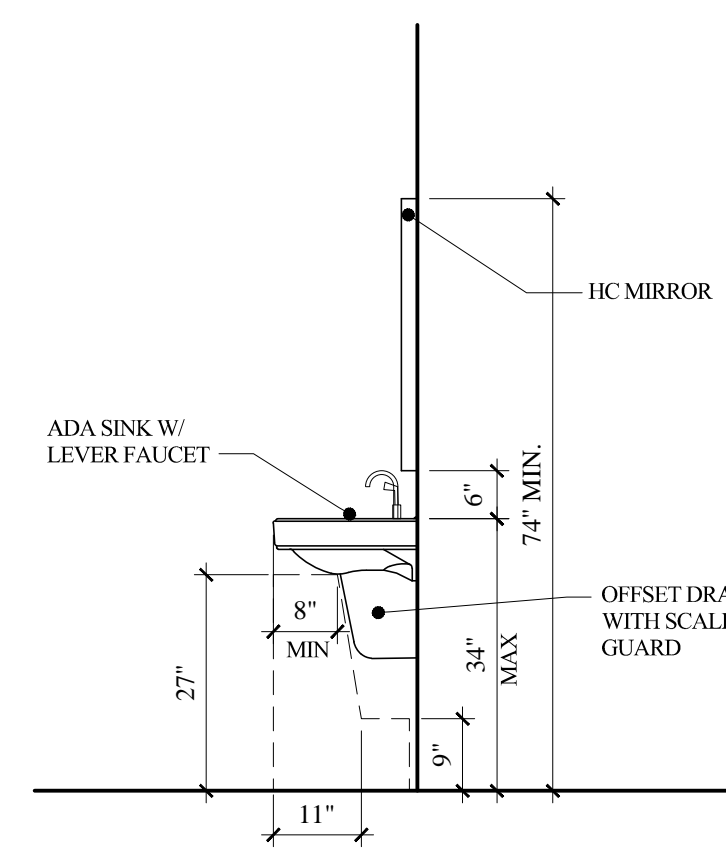

TYPICAL "ADA" SINK AND MIRROR HEIGHTS


TOILET ELEVATIONS

SCALE: 1/2"=1'-0"

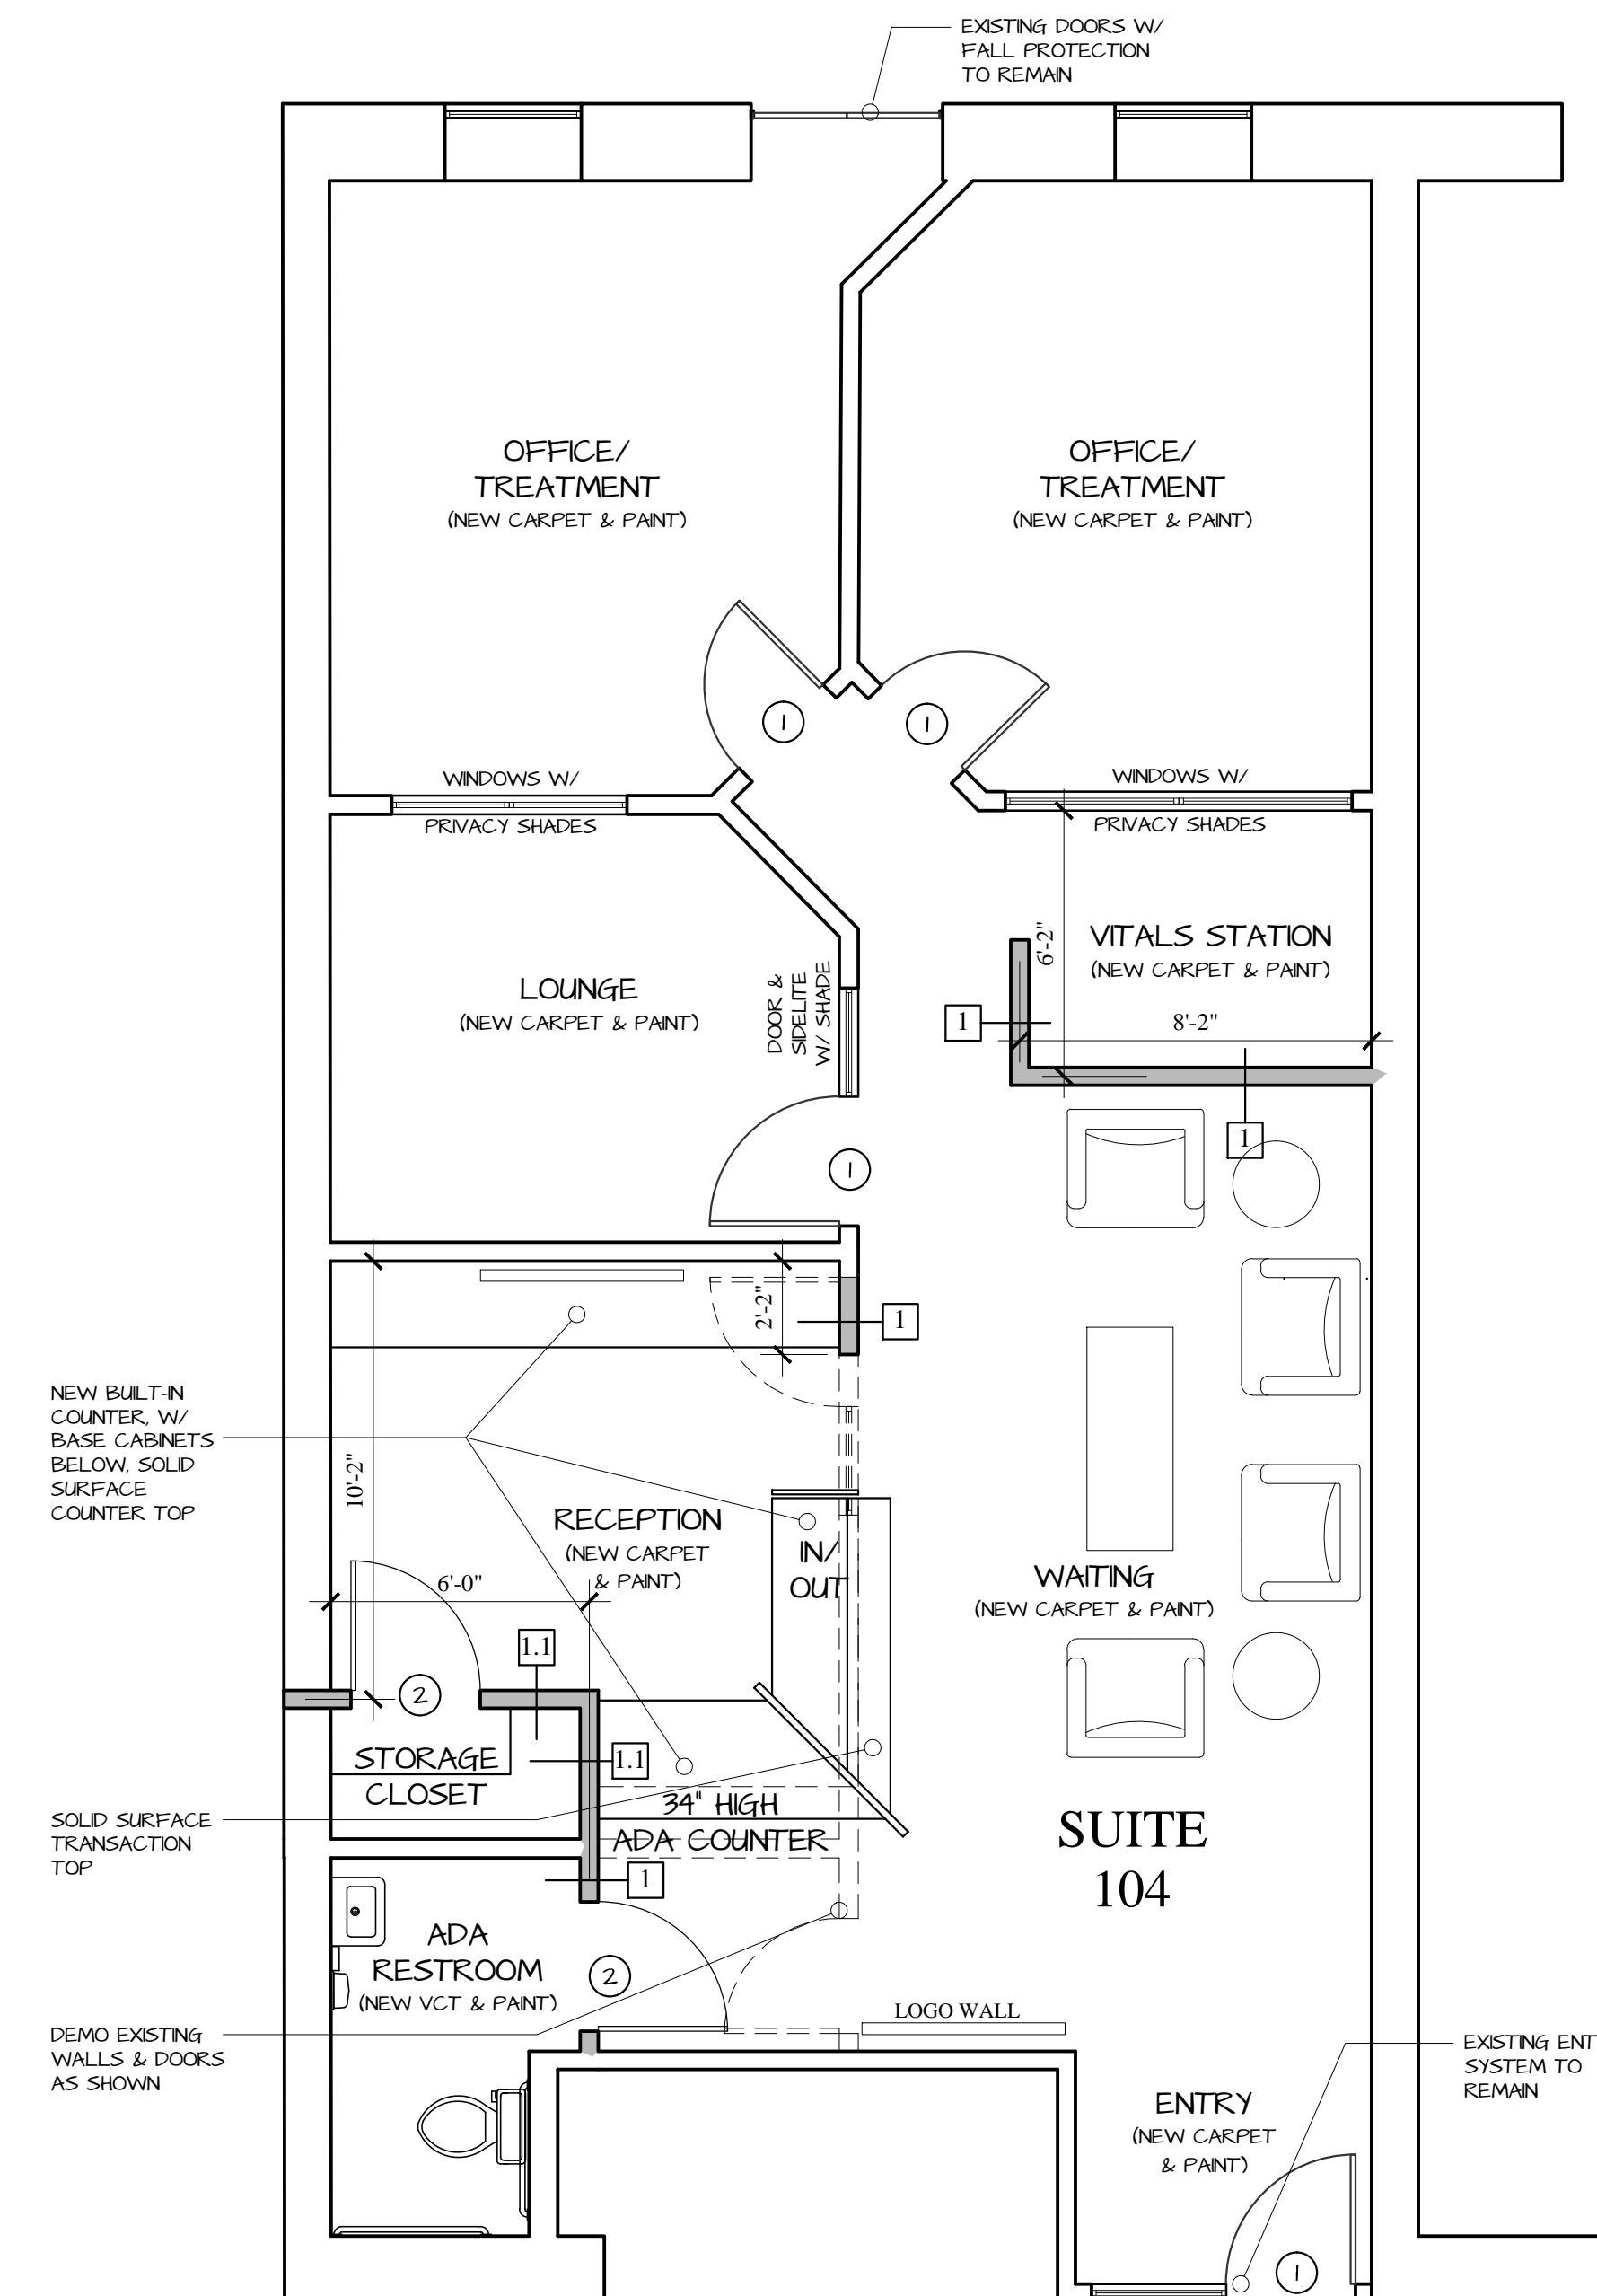

FIRST FLOOR PLAN

SCALE: 1/4"=1'-0"

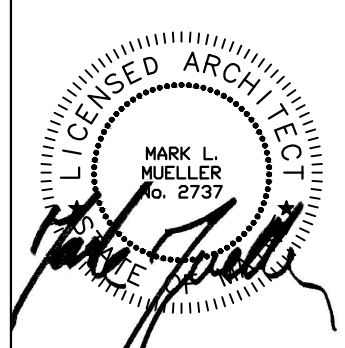

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MARK MUELLER ARCHITECTS

THOMAS BLOCK - SUITE 104
100 COMMERCIAL STREET
PORTLAND, MAINE 04101

EXISTING FIRST FLOOR PLAN - SUITE 104

DATE	04.06.2015
PROJECT	SUITE 104
DRAWN BY	MLM/TJD
CHECK BY	MLM

A-1.1

PERMIT SET: APRIL 08, 2015