
## TEST HYDRANT-

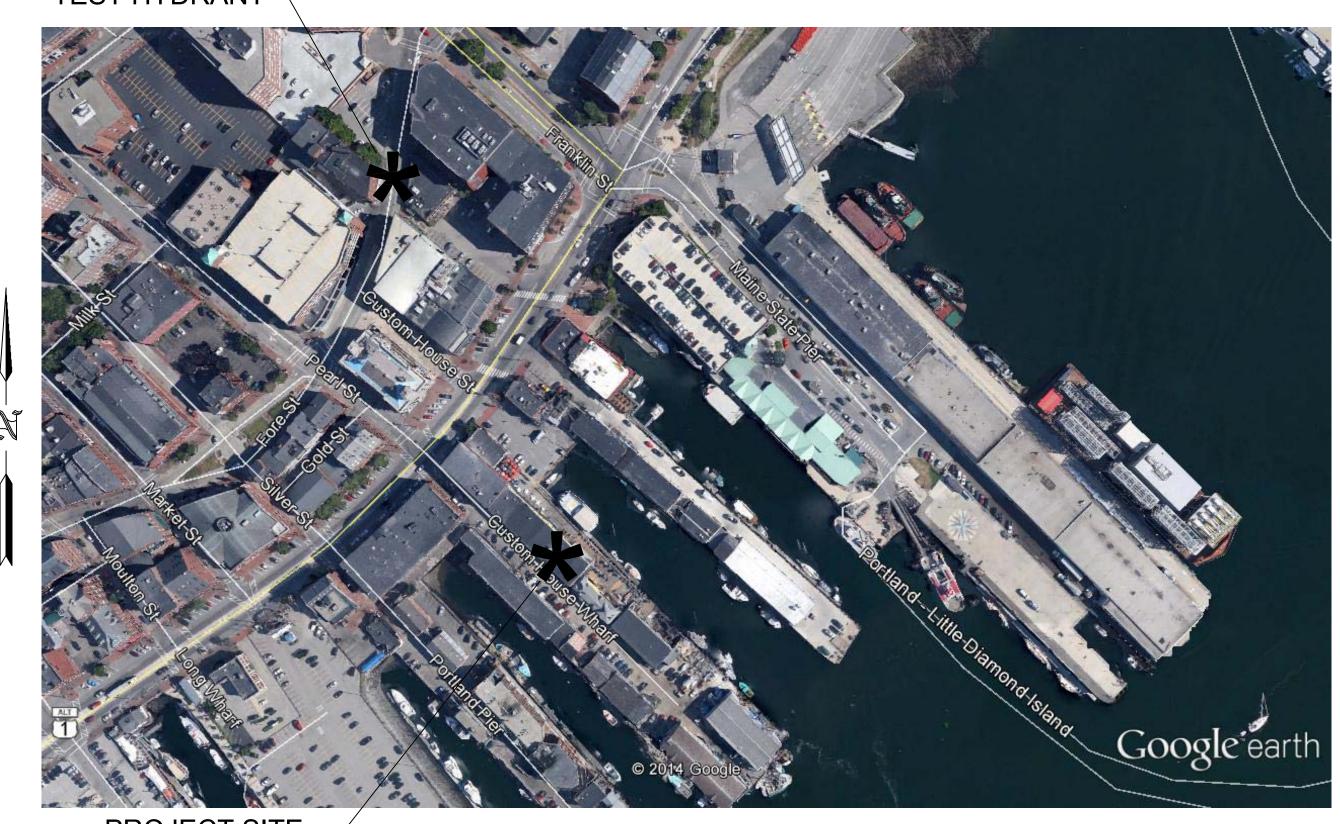

SITE PLAN

SCALE: N.T.S.

HYD. DESIGN CRITERIA

(NFPA 13 2010 ed. - WET)

LOCATION= SECOND FLOOR STORAGE (MAIN BLDG.)

AREA OF OPERATION= 1,000 SQ. FT. (34% REDUC.)

HAZARD CLASSIFICATION: LIGHT

SYSTEM DEMAND (INCLUDING HOSE) @

BASE OF RISER= 554 -GPM 59 -PSI

DENSITY= .1 GPM/SQ.FT.

HOSE DEMAND: 100 GPM


SAFETY MARGIN= 44 -PSI

NO. OF SPRINKLERS= 14


HYD. DESIGN CRITERIA (NFPA 13 2010 ed. - DRY) LOCATION= COMBUSTIBLE ATTIC SPACE HAZARD CLASSIFICATION: LIGHT DENSITY= .1 GPM/SQ.FT. AREA OF OPERATION= 2,000 SQ. FT. (ENTIRE AREA) HOSE DEMAND: 100 GPM NO. OF SPRINKLERS= 23 SYSTEM DEMAND (INCLUDING HOSE) @ BASE OF RISER= 612 -GPM 96 -PSI SAFETY MARGIN= 7 -PSI

DRY SYSTEM INSPECT

ATTIC / APARTMENT CALC STICKER

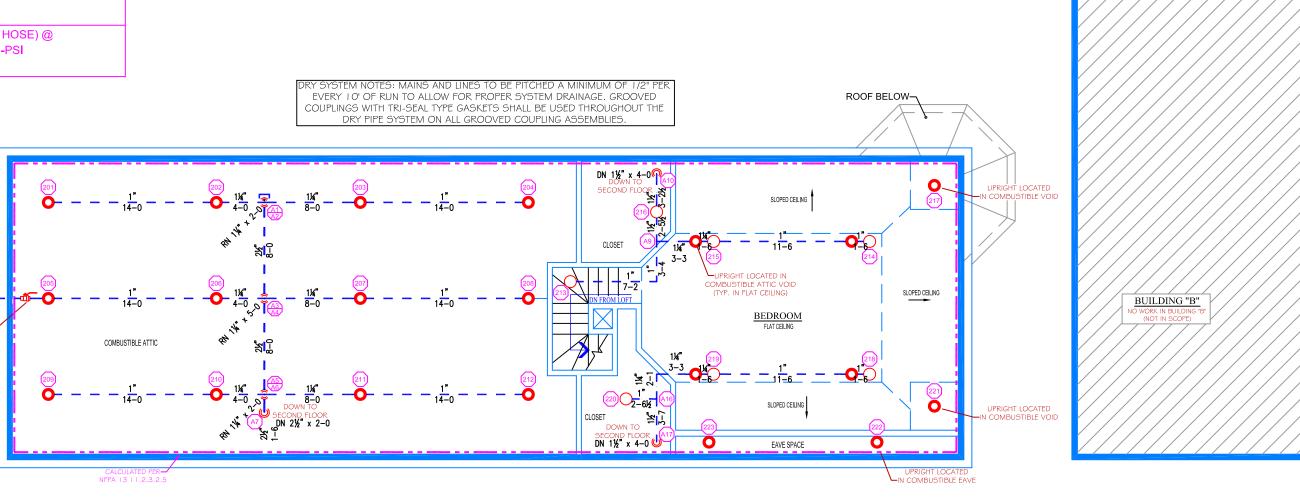

UPPER FLOOR PLAN SCALE: 1/8" = 1'-0"PROTECTED AREA: 1,925 SQ. FT.

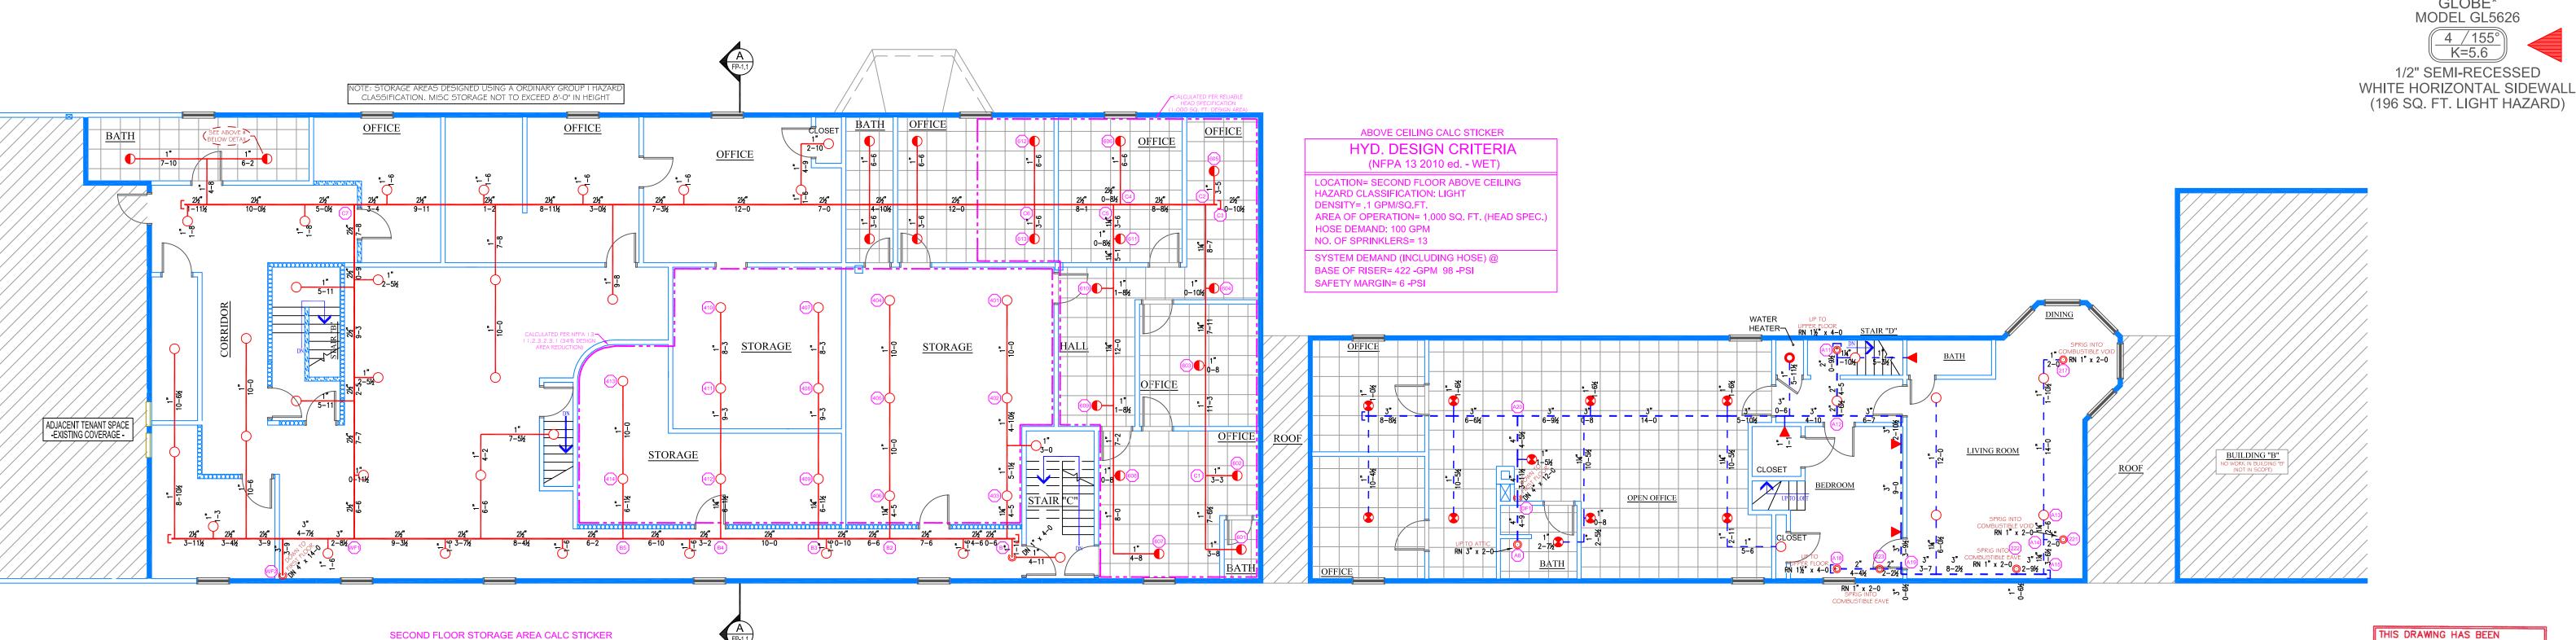

PROTECTED AREA: 7,364 SQ. FT.

SECOND FLOOR PLAN SCALE: 1/8" = 1'-0"

THIS DRAWING HAS BEEN REVIEWED FOR GENERAL
COMPLIANCE WITH THE 2010 ed.
OF NFPA 13 — STANDARD FOR
AUTOMATIC SPRINKLER SYSTEMS.
ANY DEVIATIONS FROM THIS
DOCUMENT SHALL BE MADE UNDER THE SUPERVISION OF A CERTIFIED DESIGN PROFESSIONAL REVIEW COMPLETED BY: JEREMY A. FOSS MAINE RMS #808 NICET LEVEL III CERTIFICATION #126801

MODEL GL5626

4 /155 K=5.6

HIGH TECH FIRE PROTECTION P.O. BOX 156 MINOT, ME. 04258-0258

TEL:(207) 998-2551 FAX:(207) 998-4187

MAINE LICENSE # 102

ARCHITECT:

PROJECT DESCRIPTION

BUILDING OCCUP: THE BUILDING IS OF MIXED OCCUPANCIES CONTAINING RESTAURANT

SPACES AND A TWO BEDROOM APARTMENT.

SPRINKLER DESIGN: THE SPRINKLER SYSTEM HAS BEEN DESIGNED USING A LIGHT HAZARD

WET PIPE AND DRY PIPE SPRINKLER SYSTEM.

ACCORDANCE WITH NFPA 13.

COMBUSTIBLE MATERIALS THROUGHOUT. THE MAIN FLOOR OF THE LARGER BUILDING CONTAINS THE PORTHOLE RESTAURANT. ABOVE THE RESTAURANT ARE OFFICES AND STORAGE SPACES TO BE USED BY THE

RESTAURANT OWNERS. THIS PORTION OF THE BUILDING HAS A FLAT ROOF WITH COMBUSTIBLE FRAMING EXPOSED TO THE FLOOR BELOW. THE

SEATING AND A COMMERCIAL KITCHEN AS WELL AS OFFICE, STORAGE

CLASSIFICATION THROUGHOUT WITH THE EXCEPTION OF THE KITCHEN AND LIGHT STORAGE AREAS THAT HAVE BEEN DESIGNED USING AN

THE SYSTEM HAS BEEN DESIGNED AS AN NFPA 13 2010 ed. AUTOMATIC

WITH THE RELIABLE HEAD SPECIFICATIONS. THE SECOND FLOOR STORAGE AREAS AND DRY SYSTEM HAVE BEEN CALCULATED IN

ORDINARY GROUP I HAZARD CLASSIFICATION. THE SECOND FLOOR ABOVE CEILING SPRINKLER COVERAGE HAS BEEN CALCULATED IN ACCORDANCE

SMALLER BUILDING HOUSES A SMALL STORAGE AREA ON THE MAIN LEVEL WITH VACANT OFFICE SPACES AND AN APARTMENT. THE UPPER FLOOR OF THE APARTMENT CONTAINS A BEDROOM AND COMBUSTIBLE SLOPED

BUILDING CONST: THE BUILDING IS OF EXISTING CONSTRUCTION AND BUILT WITH

ATTIC SPACE.

CONTRACTOR:

LEGEND: O RN PIPE RISER UP

O DN PIPE RISER DOWN STEEL PIPE (WET) STEEL PIPE (DRY)

DRY SYSTEM RISER

A HYDRAULIC CALC. POINT XX-X PIPE ELEVATION A.F.F.

SCHEDULE 40 STEEL WITH THREADED

DESIGN NOTES: ALL PIPING 1 1/2" AND LARGER TO BE SCHEDULE 10 STEEL W/ GROOVED FITTING. \*ALL PIPING 1 1/4" AND SMALLER TO BE

\*POSITION, LOCATION, SPACING, AND USE OF SPRINKLERS AND HANGERS SHALL BE IN ACCORDANCE WITH NFPA 13 2010 ed. \*HYDRAULIC CALCULATION PROCEDURES HAVE BEEN DONE IN ACCORDANCE WITH NFPA 13 2010 ed. (SEE PLANS FOR LOCATION OF REMOTE AREAS, HYDRAULIC REFERENCE POINTS, AND SYSTEM DEMANDS) \*ALL ELECTRICAL WORK TO BE DONE BY

DIMENSIONS AND LOCATIONS GIVEN FOR SPRINKLER HEADS AND PIPE MAY VARY TO ACCOMODATE ACTUAL FIELD CONDITIONS. \*OWNER TO PROVIDE SUFFICIENT HEAT TO PREVENT FREEZING IN WATER FILLED SPRINKLER PIPE AND EQUIPMENT. \*OTHER TRADES TO COORDINATE THEIR WORK WITH SPRINKLER CONTRACTOR. \*ALL NEWLY INSTALLED SPRINKLER HEADS ARE TO BE QUICK RESPONSE U.N.O. \*OWNER IS RESPONSIBLE FOR MAINTAINING THE SPRINKLER SYSTEM/S IN ACCORDANCE WITH THE CURRENT EDITION OF NFPA 25, "INSPECTIONS TESTING AND MAINTENANCE OF WATER BASED FIRE PROTECTION SYSTEMS" AND/OR ALL APPLICABLE FEDERAL, STATE, AND LOCAL LAWS, CODES AND

> **GLOBE\*** MODEL GL5615

1/2" BRASS UPRIGHT (196 SQ. FT. LIGHT HAZARD) (130 SQ. FT. ORD. HAZARD)



1/2" BRASS UPRIGHT (130 SQ. FT. ORD. HAZARD)

RELIABLE CCS 56 - 212° (ABOVE) GLOBE GL5601 - 155° (BELOW)

1/2" CONCEALED SPACE UPRIGHT (ABOVE) 1/2" SEMI-RECESSED WHITE PENDENT (BELOW)

RELIABLE CCS 56 - 212° (ABOVE) GLOBE GL5635 - 155° (BELOW)

(196 SQ. FT. LIGHT HAZARD)

1/2" CONCEALED SPACE UPRIGHT (ABOVE) " SEMI-RECESSED DRY BARREL WHITE PENDENT (BELOW) (196 SQ. FT. LIGHT HAZARD)

\* OR APPROVED EQUAL TOTAL HEADS ON SHEET: 142

SCALE:

SCALE 1/8"=1'-0" DATE: DECEMBER 11, 2014

DESIGNER: JEREMY A. FOSS MAINE RMS #808 NICET LEVEL III CERT. #126801 CHECKED BY: E. POULIN (RMS# 515)

NICET LEVEL IV CERT. # 108534 LOCATION: 20 CUSTOM HOUSE

WHARF

PORTLAND, ME

DRAWING TITLE: PORTHOLE RESTAURANT

(SEC. & UPPER FLOOR) FIRE PROTECTION PLAN (NFPA 13 2010 ed.)

DRAWING NO.:

FP-1.2