

Employee Toilet Room

6**'**-7"

EQ-2 P-3

_____P-1

— EQ-3

EQ-4

EQ-7

Equipment Schedule

EQ-1 Paper towel dispenser or Electric hand dryer

EQ-2 Soap dispenser

EQ-3 Mirror

EQ-4 Toilet paper holder

EQ-5 Coat hook type B-233 by Bobrick, provide one at each Toilet door and where noted

EQ-6 SS Grab bar, 36" long (1 1/4" to 1 1/2" 0.D.)

EQ-7 SS Grab bar, 42" long (1 1/4" to 1 1/2" 0.D.)

Plumbing Schedule

P-1 ADA compliant lavatory

P-2 Lavatory

ADA compliant wall—hung sink and faucet or ADA compliant countertop, sink and faucet.

P-4 Urinal

P-5 Floor Drain

Refer to typical mounting height details, sheet

Toilet Room

Provide appropriate blocking in walls for all

fixtures, partitions, and accessories

Toilet partition (if noted) height shall be 7'-0"

Install blocking behind Owner supplied equipment as well as GC supplied equipment

GC responsible for meeting ADA guidelines for handicap accessible mounting heights

Toilet partitions (if noted) shall be floor mounted and ceiling braced

Toilets shall be elongated style

and countertop

Provide ADA insulation under sinks at exposed

Provide silicone sealant at wall to backsplash

Floor/Ceiling Assemblies - Wood Framing STC - N/A IIC - N/A 1 Hour FM FC-214 FC 5512 Sound Test # N/A Base Layer 1/2"(12.7 mm) Fire-Shield C Gypsum Board applied at right angles to parallel chord wood trusses 24"o.c. with 1-1/4" Type S drywall screws 24" oc. Face layer 1/2" Fire-Shield C Gypsum Board applied at

Terminate rating by extending gyp bd to underside of deck and seal tight w/ fire rated sealant

right angles to trusses with 1-7/8" Type S drywall Screws 12"o.c. and

1-1/2" Type G screws 12"o.c. placed 3" back on either side of end joints.


Joints offset 24" from base layer joints. Trusses supporting 19/32" T&G

plywood with exterior glue applied at right angle to trusses with 6d

1 Hour Rated Floor / Ceiling Assembly

nails 6"o.c. Plywood joints staggered 48".

STANDARD HEIGHTS AND CLEARANCES / TYPICAL BARRIER FREE REQUIREMENTS **-**-Phone jack -Electrical outlet (Electrician to verify casework height exceptions) Color shall be Wall Mounted Exit Sign Fire Extinguisher Cabinet white UNO

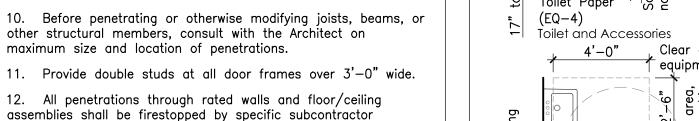

Stairways and Handrails

requiring penetration. 13. Location of every exit shall be clearly indicated by exit signs placed, if required, at an angle with the exit opening. Install directional signs to serve as guides form all portions of the corridor or floor.

1. All work included in these drawings and specifications shall

The General Contractor shall be responsible for obtaining

conform to all state, national, and other codes and ordinances.

building permits and for payment of all fees and hook-ups.

3. General contractor shall verify all dimensions and report

4. The General Contractor shall obtain approval from the

owner for staging areas and hours of allowable work times.

coolers, cubbies, fire extinguishers, lighting, and other wall

mounted equipment or appliances indicated in documents.

6. All doors shall be located a minimum of 3" (wall to frame) off adjoining stud walls, except where noted or

Do not scale drawings, work from dimensions only.

any discrepancies to the architect before proceeding with work.

5. Provide appropriate reinforcing within partitions for support of all grab bars, shelving brackets, cabinets, door frames, water

7. All handicapped toilet rooms, grab bars, and door openings

shall meet the requirements of ANSI 117.1 latest edition, and

the American Disability Act (ADA) for handicapped accessibility.

9. All gypsum wall board within 3'-0" of plumbing fixtures

11. Provide double studs at all door frames over 3'-0" wide.

8. Provide ADA insulation under sinks at exposed pipes.

other structural members, consult with the Architect on

12. All penetrations through rated walls and floor/ceiling

assemblies shall be firestopped by specific subcontractor

maximum size and location of penetrations.

APPLICABLE CODES

GENERAL NOTES

dimensioned otherwise.

shall be moisture resistant.

City of Portland Technical Manual International Building Code, 2009 NFPA 101, Life Safety Code, 2006 Uniform Plumbing Code


NFPA 13 Sprinklers ASHRAE 90.1 - 2007 Energy Standards for Buildings except Low-Rise Residential ASHRA 62.1 - 2007 Ventilation for Acceptable Indoor Air Quality 2009 International Energy Conservation Code


Plumbing, Mechanical, Electrical, and Sprinkler system shall be design/build and shall meet all applicable codes.


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Consultants

<u>Revisions</u>

Poppy's Fish

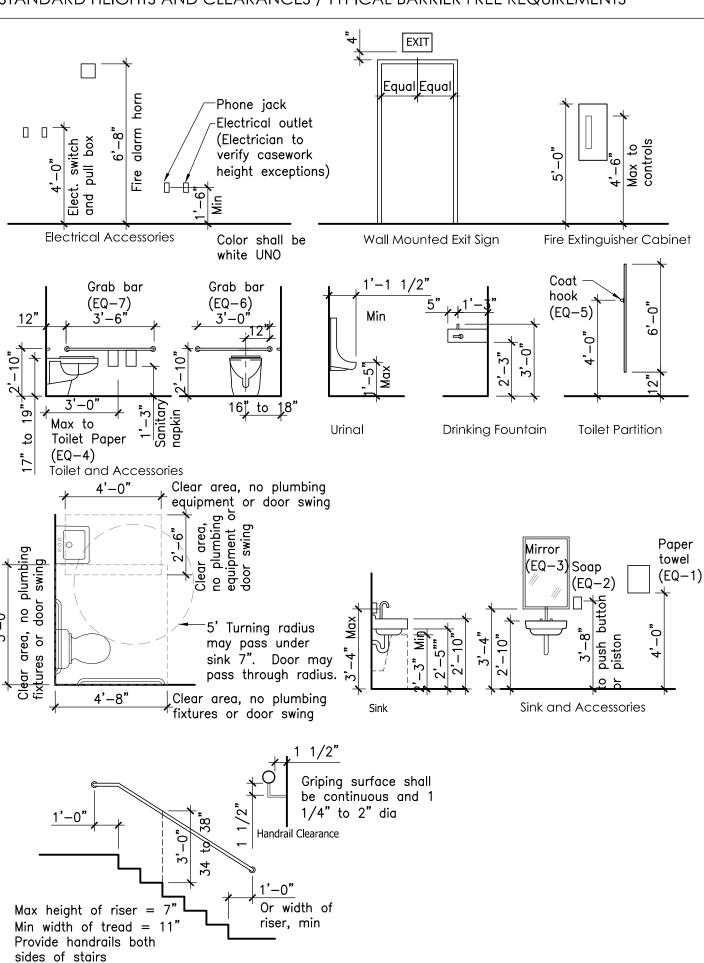Shack and

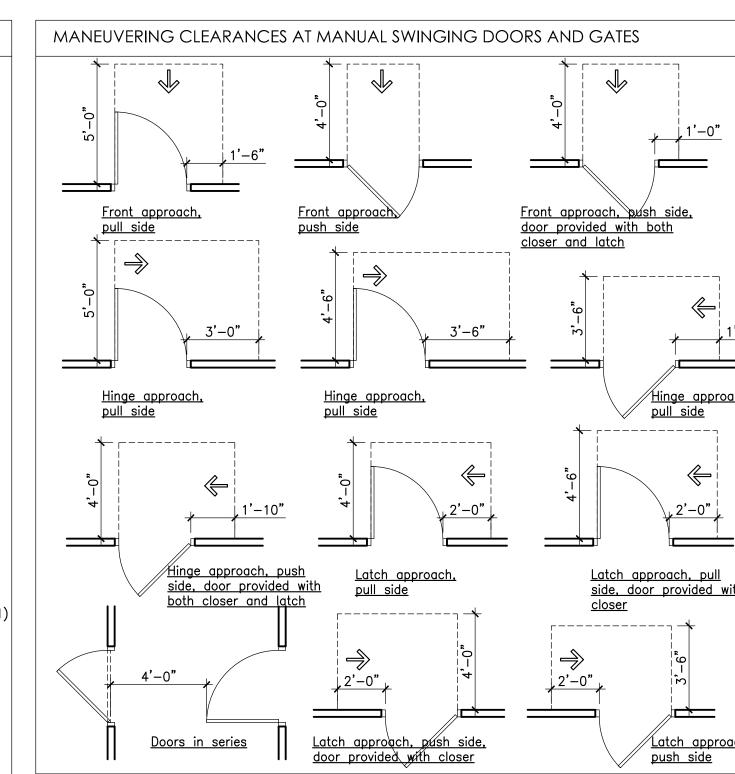Oyster Room

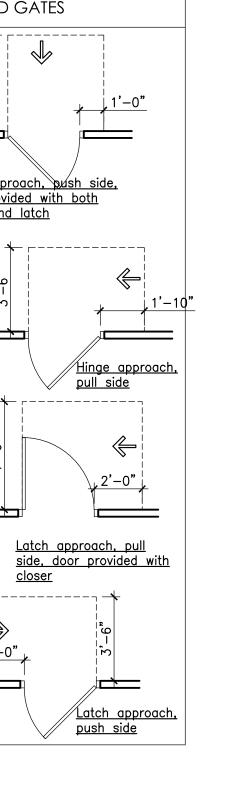6 Custom House Wharf Street

Portland, Maine


List of Drawings

R.1 General Notes, Partition Types, Details

R.2 Code Analysis

R.3 Code Review Plans

S100 Deck Foundation, Framing Plan and Details

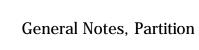

R.4 Electrical Life Safety Plans

R.5 Deck Details

Underside of decking

Clg (if noted on ceiling

— 5/8" Type X gyp bd

tight to underside of

3" Min. sound batt

Mechanical, Toilet,

Base and floor. See

─ 2 x 4 wd. plate

Design No. W301 (Wood stud)

One hour rated partition,

existing construction to

room finish schedule

and Office walls

insulation at

both sides sealed

plans), coordinate w/


─ Fire rated sealant

both sides

ceiling plan

5/8" 5/8" 5/8" finish schedule and

S000 Structural Notes

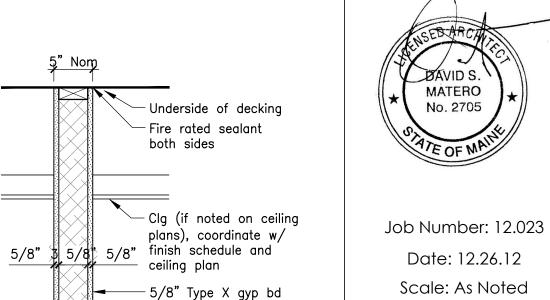

-Fire rated sealant

both sides

ceiling plan

both sides sealed

tight to underside of

-3" Min. sound batt

Mechanical, Toilet,

and Office walls

Base and floor. See

room finish schedule

∕ 2 x 4 wd. plate

Design No. W301 (Wood stud)

One hour rated partition

insulation at

Date: 12.26.12 Scale: As Noted

Drawing Title:

Gen. Notes, Partition Types and Details

Issue for

Permit

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Partition Type Notes All rated and smoke tight partitions are

continuous through ceiling and sealed tight with fire rated sealant to the underside of decking / sheathing

All stud walls under beams and decks shall have deflection joints.

Lay out steel studs to conform to 4'-0"module where required to install gypsurn board vertically to comply with tested

fire-rated wall assemblies. Penetrations through walls to be acoustically or smoke sealed shall have sealant system conforming to approved installations.

Provide metal 'J' bead at drywall to wood/plywood joints UNO.

to receive ceramic tile.

Provide Dens Armor Plus gypsum board at toilet rooms.

Patch all existing holes and to maintain 1 hour Provide tile backer board at walls scheduled fire rating integrity. Seal all penetrations with fire rated sealant. Seal to underside of decking and flooring with fire—rated sealant. Typical both sides.

Partition Types

<u>5" Nom</u>

) (—	Custom House Wharf, Portland, ME Existing 2 story wood—framed restaura	ant to be renovated and romain a
	restaurant. Ground Floor area, 4,143	sf; second floor area, 3,444 sf (total of
	sprinklered. Per the State Fire Marsh	or roof deck, 590 sf. Building will be full al, an elevator is not required.
ВС	2009 Code Review	
Chc	pter 3 Use and Occupancy Classification Section 303	
	Section 303	Assembly A-2
hc	pter 4 Special Detailed Requirements E	Based on Use and Occupancy
	Section 410 Stages and Platforms	A raised area within a building used for worship, head table for special guests,
		etc
	Section 410.4	Permanent platforms shall be constructed of materials required for the type of construction of the building. Where space beneath is used for storage (except wiring or plumbing), the floor
		assembly shall be rated 1 hour.
hc	pter 5 General Building Heights and Ar	reas
	Construction Type	VB
	, ,	
_	Table 503 — Area limitations (A—2)	6,000 sf per floor Existing 4,143 sf - OK
	Height limitations	1 Story
_		Existing 2 stories
_	Maximum Height	40'
_		Existing 35' - OK
	Section 504.2 — Automatic Sprinkler system increase	If sprinklered, increase 1 story and 20'
	System moreage	Existing 2 stories — OK
_		
_	Table 508.4 — Required Separation	Kitchen need not be separated from
		seating area
C	pter 6 Types of Construction	
	Table 601 Ratings of Structure Eleme	
	Structural frame	0 Hour / Existing to remain, 0 hr — Of
_	Exterior bearing walls	0 Hour / Existing to remain, 0 hr — Oh
	Interior bearing walls	0 Hour / Existing to remain, 0 hr — Oh
_	Nonbearing walls and partitions Floor construction	0 Hour / Existing to remain, 0 hr - 0
	Roof construction	0 Hour / Existing to remain, 0 hr — Of
	Rooi construction	0 Hour / Existing to remain, 0 hr — Oh
	Table 602 Fire Resistance Rating Requ	urements for Exterior Walls
	Less than 10'	1 Hour
	More than 10'	0 Hour
10	pter 7 Fire and Smoke Protection Fea	
_	Table 705.8 Max Area of Exterior Wall	Openings Based on Fire Separation Dist.
	0 to 3' (Unprotected, Sprinklered)	Not permitted
	3' to 5'	15%
	5' to 10'	25
	10' to 15'	45%
	15' to 20'	75%
_	More than 25'	No limit
_	Table 715.4 Fire Door and Fire Shutte	or Fire Protective Ratings
	Fire walls, 2 hour	1 1/2 Hour rating
	Shaft, 1 hour	1 Hour
	Exit enclosures, 1 hour	1 Hour
	Corridor walls, 1 hour	20 Minute
_	Table 715.4.4 Limiting Size of Wired (Glass Panels
_	1 and 1 1/2 hours	100 sq in, 33" max ht, 10" max width
_	3/4 hour	1,296 sq in, 54" max ht, 54" max width
_	20 minute	Not limited
ıc	pter 8 Interior Finishes	•••
	Sec 803.1.1 Interior wall and ceiling f	
	Class A	Flame spread index 0-25; smoke-developed index 0-450
	Class B	Flame spread index 26-75;
		smoke-developed index 0-450
	Class C	Flame spread index 76-200; smoke-developed index 0-450
	Sec 803.9 Interior Wall and Ceiling Fir	nish Requirements by Occupancy (A-2)
	Exit enclosures and passageways	Class C
	Corridors	Class B
_	Rooms and enclosed spaces	Class C
	0 004.4.1.1	
_	Sec 804.4 Interior floor finish requirer	
	Interior floor finish	Not less than Class II and comply with DOCFF-1 "pill test"
		<u> </u>
	<u> </u>	n (A)
_	Sec 806 Decorative Materials and Trim	
	Curtains, draperies, hangings and	
	Curtains, draperies, hangings and other decorative materials	criteria of NFPA 701
	Curtains, draperies, hangings and other decorative materials pter 9 Fire Protective Systems (New b	uildings)
	Curtains, draperies, hangings and other decorative materials	criteria of NFPA 701 uildings) Required if fire area exceeds 5,000 sf, fire area has an occupant load of 100
100	Curtains, draperies, hangings and other decorative materials pter 9 Fire Protective Systems (New b	uildings) Required if fire area exceeds 5,000 sf,

Table 1004.1.2 Occupant Load	
Ground Floor	130 Occupants (refer to drawings)
Second Floor	129 Occupants (refer to drawings)
	151 Occupants (refer to drawings)
Outdoor Patio Seating	100 Occupants (refer to drawings) Total occupant load = 380
Table 1005 Egress Width	Total occupant load = 380
Stairways	.30" per person
Doors, ramps, and corridors	.2" per person
	12 por porcor.
Sec 1005.2 Door encroachment	Doors and handrails shall not reduce required means of egress by more than 7". Doors in any position shall not reduce the required width by more than one—half.
Sec 1006.2 Illumination Level	Means of egress illumination level shall not be less than 1 foot—candle at the walking surface.
Sec 1006.3 Illumination Emergency Power	Power supply for means of egress illumination shall normally be provided by premises's electrical power.
Can 1007 1 Associate Magna of Fano	In power failure event, automatic illumination shall include corridors, exit enclosures, exit passageways, interior exidischarge elements for a duration of 90 minutes with battery backup or on—site generator.
Accessible spaces must be provided a Exception, accessible means of egressibility buildings	
Sec 1007.3 Stairways	
Minimum width between handrails	48" unless sprinklered - N/A
	·
Sec 1008.1.1.1 Projections into Clear Width	No projections into required clear width allowed lower than 34" above the floor. Shall not exceed 4" between 34" and 80 above the floor.
	Exceptions: Door closers and door stops shall be permitted to be 78" min above the floor.
Sec 1008.1.2 Door swing	Door shall swing in the direction of egress travel where serving an occupant
	load of 50 or more persons.
Sec 1008.1.5 Floor Elevation	There shall be a floor or landing on each side of a door and shall be at the same elevation. Exterior may slope .25 / 12 units (2%).
Sec 1008.1.6 Landings at Doors	Landings shall have a width not less that the width of the stairway. When serving an occupant load of 50 or more, doors shall not reduce the landing to less that 1/2 its required width. Landings shall not have a length less than 44" in the direction of travel.
Sec 1008.1.7 Thresholds	Thresholds shall not exceed 1/2"
	Thresholds shall het exceed 1/2
Sec 1008.1.10 Panic Hardware	Doors serving rooms or spaces with 50 or more occupants shall not be provided with a latch or lock unless its is panic hardware.
Sec 1009.1 Stairway width	
Minimum width	3'-8"
Exception serving less than 50 Min headroom	3'-0"
WIII HEUUI OOIII	6'-8"
Sec 1009.4 Stair treads and risers	
Stair riser	Max 7"
Stair riser	Min 4"
Stair tread Sec 1009.5 Stairway Landings	Min 11" There shall be a floor or landing at the top and bottom of each stairway. The
	width shall not be less than the width of the stairway. The length must be at least the same as the width but need not exceed 48" in s straight run.
Sec 1009.7 Vertical Rise	Max 12' vertical rise between landings o levels
Sec 1009.12 Handrails	Handrails shall be on both sides of stairways
Sec 1012 Handrails	Between 34" and 38" above nosing Handrail gripping surfaces shall be continuous, without interruption
	Handrails shall return to a wall, guard, or continuous.
	Handrails shall extend 12" horizontally above top riser and continue to slope for the depth of one tread beyond the bottom riser
Sec 1013.1 Guards	
When more than 30" above floor Height	Guards required 3'-6"

Sec 1014.2 Egress through intervening spaces

Shall not pass through adjoining spaces, including kitchens and storage rooms

Sec 1014.3 Common path of egre Occupancy A	Not more than 75'
Table 1015.1 Spaces with 1 exit	
Occupancy A	Max occupant load = 49
Sec 1015.2.1 Two exits	
When 2 are required	Not less than 1/3 overall diagonal when sprinklered
Exception	When exit enclosures are interconnected
Lxcoption	by a 1 hour rated corridor, separation shall be measured along the shortest direct line of travel within the corridor
Table 1016.1 Travel Distance Limita Occupancy A	ations 250' (with sprinkler system)
T.I. 4040.4.0 II. F. D. I.	
Table 1018.1 Corridor Fire—Resistan Occupancy A, corridor serving more than 30	
Sec 1018.2 Corridor Width	
Min width	3'-8"
Req occupant capacity less than 5	
red occupant capacity less than o	3 –0
Sec 1018.4 Dead Ends	
Group A	Max 20'
	Not limited when corridor is less than
	2.5 times the least width of the corridor
Table 1021.2 Stories with One Exit	(A)
First story or basement	49 Occupants and 75' travel distance
Sec 1022 Exit Enclosures	
Stairway enclosure	1 Hour rating
Sec 1027 Exit Discharge	
Exits shall discharge directly to the grade or direct access to grade.	e exterior of the building and shall be at
Sec 1027.1 Exceptions	Max of 50% occupants permitted to
See 1627.1 Exceptions	egress through areas of exit discharge
	Free and unobstructed path of travel and
	exit is readily visible
	Area of exit discharge is 1 hour separated from areas below
	Egress path is sprinklered
Exceptions	Max of 50% occupants permitted to
	egress through a vestibule
	Entire area of vestibule is 1 hour separated from areas below
	Depth from exterior of building is not
	greater than 10' and length is not
	greater than 30'
	Area is separated from remainder of exit discharge with equivalent of wired glass
	in steel frames
	Area is used only for mean of egress and exits directly to outside.
Sec 1027.3 Exit discharge location	
Exterior balconies, stairways, ramps	Located at least 10' from lot lines
Sec 1028.2 Assembly Main Exit Group A with occupant load greate than 300 shall be provided with a main exit	
pter 11 Accessibility	
Sec 1105.1 Public entrance	Min 60% entrances
	Accessible entrance not required to areas not required to be accessible
Table 1106.1 Accessible Parking Sp	paces
Table 1106.1 Accessible Parking Sp Total parking spaces 1 to 25	Required min accessible spaces, 1
	Required min accessible spaces, 1
Total parking spaces 1 to 25 26 to 50 51 to 75	Required min accessible spaces, 1 2 3
Total parking spaces 1 to 25 26 to 50 51 to 75 76 to 100	Required min accessible spaces, 1 2 3 4
Total parking spaces 1 to 25 26 to 50 51 to 75	Required min accessible spaces, 1 2 3
Total parking spaces 1 to 25 26 to 50 51 to 75 76 to 100 101 to 150	Required min accessible spaces, 1 2 3 4
Total parking spaces 1 to 25 26 to 50 51 to 75 76 to 100 101 to 150 Sec 1006.5 Van Spaces	Required min accessible spaces, 1 2 3 4 5
Total parking spaces 1 to 25 26 to 50 51 to 75 76 to 100 101 to 150	Required min accessible spaces, 1 2 3 4
Total parking spaces 1 to 25 26 to 50 51 to 75 76 to 100 101 to 150 Sec 1006.5 Van Spaces For every 6 accessible spaces	Required min accessible spaces, 1 2 3 4 5
Total parking spaces 1 to 25 26 to 50 51 to 75 76 to 100 101 to 150 Sec 1006.5 Van Spaces For every 6 accessible spaces apter 14 Exterior Walls	Required min accessible spaces, 1 2 3 4 5 At least 1 shall be van—accessible
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Total parking spaces 1 to 25 26 to 50 51 to 75 76 to 100 101 to 150 Sec 1006.5 Van Spaces For every 6 accessible spaces apter 14 Exterior Walls	Required min accessible spaces, 1 2 3 4 5 At least 1 shall be van—accessible Balconies not constructed with fire—retardant—treated wood shall be rated per table 601 or of Type IV
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Total parking spaces 1 to 25 26 to 50 51 to 75 76 to 100 101 to 150 Sec 1006.5 Van Spaces For every 6 accessible spaces apter 14 Exterior Walls Sec 1406.3 Balconies	Required min accessible spaces, 1 2 3 4 5 At least 1 shall be van—accessible Balconies not constructed with fire—retardant—treated wood shall be rated per table 601 or of Type IV construction. Aggregate length shall not exceed 50% of the buildings perimeter on each floor.
Total parking spaces 1 to 25 26 to 50 51 to 75 76 to 100 101 to 150 Sec 1006.5 Van Spaces For every 6 accessible spaces apter 14 Exterior Walls	Required min accessible spaces, 1 2 3 4 5 At least 1 shall be van—accessible Balconies not constructed with fire—retardant—treated wood shall be rated per table 601 or of Type IV construction. Aggregate length shall not exceed 50% of the buildings perimeter on each floor. Balconies on Type V buildings are permitted to be of Type V construction
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	PA 101 Life Safety Code Review Sec 3.3.168.2	Assembly Occupancy used for gatherin
	360 0.0.100.2	over 50 or more persons
Cha	anter 7 Magne of Egreco	
Cnc	Sec 7.1.3.1 Exit Access Corridor	1 Hour when occupant load exceeds
	Exception	Does not apply to existing buildings if
	·	occupancy classification does not cha
	Sec 7.1.3.2 Exits	Indicates 1 hour separation for exits or less stories
		Openings in exit enclosures shall be limited to door assemblies from norm occupied spaces and corridors An exit enclosure shall provide a
		continuous protected path of travel to exit discharge
	Sec 7.1.5.1 Means of egress	Not less than 7'-6" with projections
	headroom Sec 7.1.5.1.1 Existing building	less than 6'-8" Not less than 7'-0"
	Sec 7.1.3.1.1 Existing building	Not less than 7 -0
	Sec 7.2.1.4.3 Door Leaf Encroachment	During its swing, any door leaf in a means of egress shall not leave less than 1/2 of the required width of a corridor, and shall not project more t7" into the required width when fully opened.
	Table 7.2.2.2.1.1 New Stairs	
	Min width	36" when occupant load less than 50
		44" when occupant load less than 20
	Max riser	7"
	Min riser	4"
	Min tread depth	0'-11"
	Min head room	6'-8"
	Max height between landings	12'-0"
	Sec 7.2.2.3.4 Stair landings	Not required to exceed 48"
	Sec 7.2.2.4.1 Handrails	Stairs and ramps shall have handrails
	Sec 7.2.2.4.1.2 New stairs exceeding	both sides
	6'-3" in width	Handrails shall be provided within 30" all portions of req egress width
	Sec 7.2.2.4.5.2 Guard details	Guards shall be not less than 42" hid
		Existing guards on existing stairs shal
		permitted to not less than 30" high
	Sec 7.2.2.4.5.3 Open guards	4" Sphere must not pass though any opening to a height of 34" Triangular openings at stairs, 6" open
	Sec 7.2.2.5.2 Exposure	Mhere nonrated walls or unprotected
	Sec 7.2.2.5.3 Usable Space	openings enclose the exterior of a stairway, and the walls are exposed be other parts of the building at an angless than 180 degrees, the building enclosure walls within 10' horizontally the nonrated wall shall be 1 hour constructed Enclosed usable space shall be permit under stairs when separated with 1 herometrical construction and entrance is not from the same stair enclosure
	Table 7.3.1.2 Occupant Load	
	Ground Floor (refer to drawings)	118 Occupants
	Second Floor (refer to drawings)	154 Occupants
	Total Occupants At-grade Patio Seating	272 Occupants 100 Occupants
	Sec 7.7.2 Discharge Through Areas on Level of Exit Discharge	Not more than 50% of the required number of exits and egress capacity
		discharge through LED Discharge shall lead to a free and unobstructed way to the exterior of the building. LED shall be protected by a sprinkler system.
		System.
Cho	apter 13 Existing Assembly Occupancies	
	Table 13.1.6 Construction Type Limitat	<u> </u>
	Level of exit discharge	Any assembly if occ load under 1,000
	1 Level above exit discharge 2 Levels above exit discharge	If occupant load is less than 300 Not permitted
	2 Levels above exit discharge	Not permitted
	Sec 13.2.3.6.2 Main entrance	Shall be of width to accommodate 1/ of total occupant load
		Main entrance shall be at LED or sha
	Sec 13.2.5.1.2 Common path of travel	Shall not exceed 20' for any number
	Sec 13.2.5.1.3 Dead—end corridors	occupants and 75' for not more than Shall not exceed 20'
	Sec 13.2.5.2 Access through	Shall not pass through kitchens,
	hazardous areas	storerooms, platforms, etc.
	I Can 1706 Travel distance to suite	Shall not exceed 250' if sprinklered
	Sec 13.2.6 Travel distance to exits	
	Sec 13.3.3.2 Interior wall and ceiling	finish
		finish Class A or B
	Sec 13.3.3.2 Interior wall and ceiling	T
	Sec 13.3.3.2 Interior wall and ceiling Corridors and lobbies Enclosed stairways Assembly areas less than 300	Class A or B Class A Class A, B, or C
	Sec 13.3.3.2 Interior wall and ceiling Corridors and lobbies Enclosed stairways	Class A or B Class A

Class A or B

Projection screens

	Maine State Internal Plumbing Code (Unifo	Maine State Internal Plumbing Code (Uniform Plumbing Code 2009)				
	Total occupant load	262 Occupants / 131 men, 131 women				
	Male	2 WC required				
		1 Urinal required				
	Female	2 WC required				
		Total number of water closets of femal must meet water closets and urinals required for males. 3 Required				
	Lavatories, both	1 Lavatory each				
	Sec 413.6 Food Service Establish	With occupant load more than 100, sho be provided with separate facilities for employees and customers				
1						

David Matero Architecture


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<u>Consultants</u>

<u>Revisions</u>

Poppy's Fish Shack and Oyster Room

6 Custom House Wharf Street
Portland, Maine

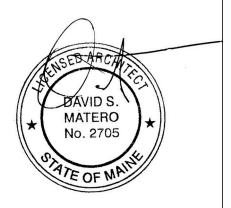

Job Number: 12.023 Date: 12.26.12

Scale: NTS

Drawing Title:


Code Analysis

R.2
Issue for

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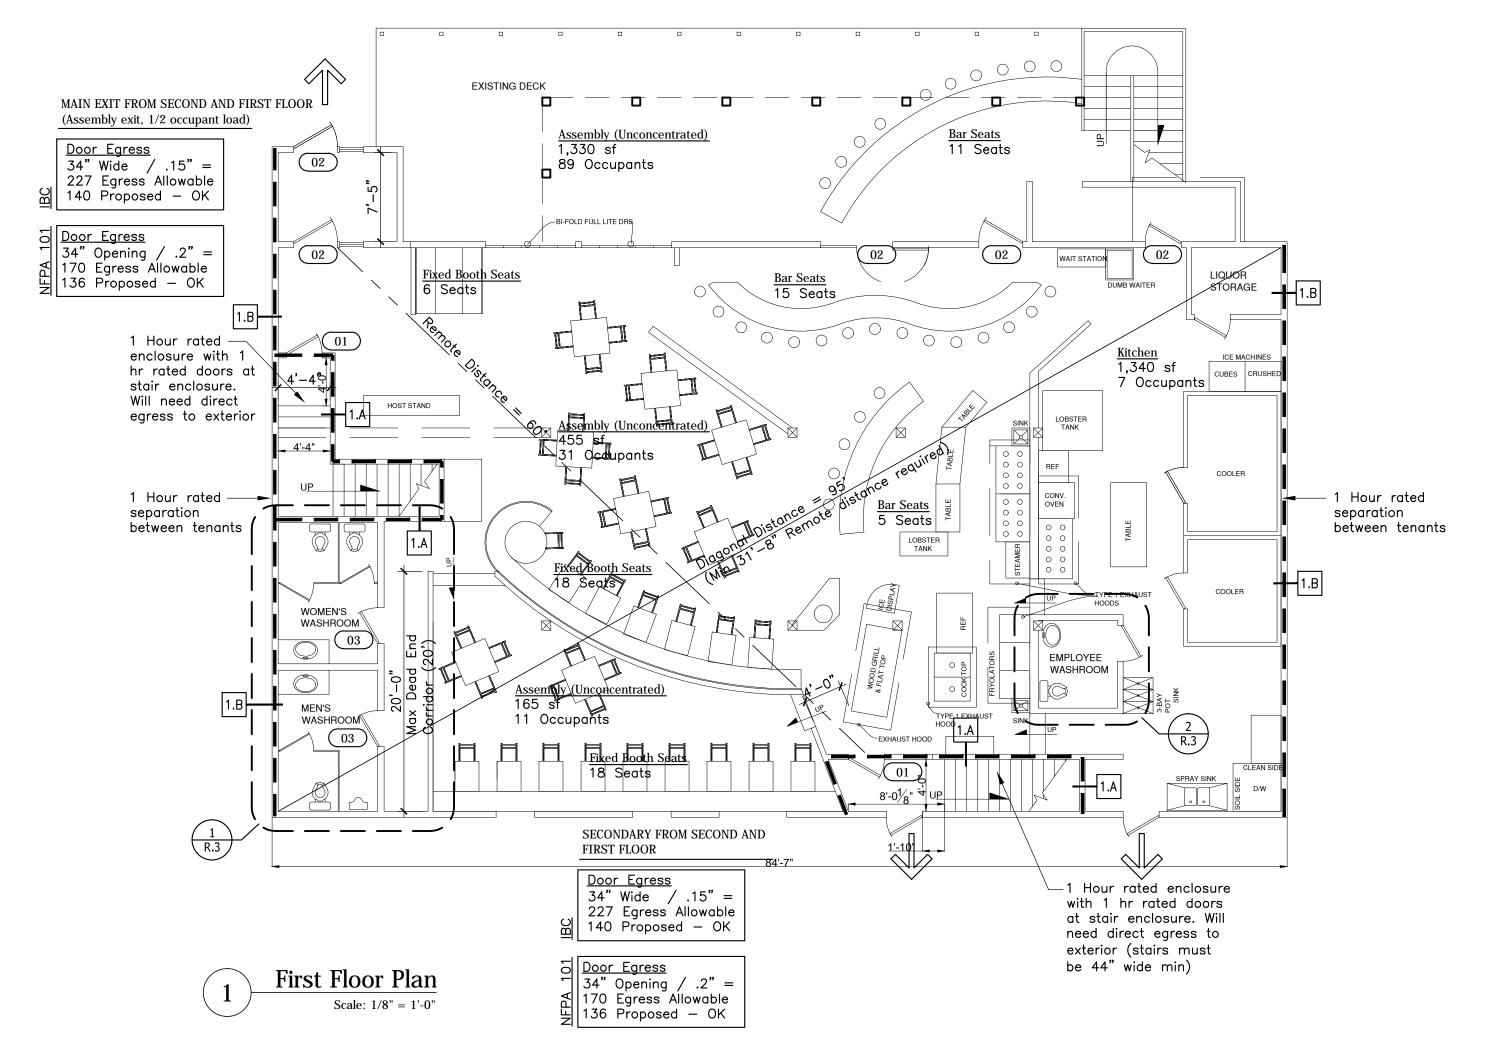
Permit


EGRESS — IBC (Table 1004.1.1)			EGRESS — Life Safety (Table 7.3.1.2)		
Ground Floor			Ground Floor		
Assembly Space (Unconcentrated)	620 sf @ 15 sf net =	42 Occupants	Assembly Space (Unconcentrated)	620 sf @ 15 sf net =	42 Occupants
Bar Seating	20 Seats =	20 Occupants	Bar Seating	20 Seats =	20 Occupants
Fixed Booth Seating	42 Seats =	42 Occupants	Fixed Booth Seating	36 Seats =	42 Occupants
Kitchen	1,340 sf @ 200 gross sf =	7 Occupants	Kitchen	1,340 sf @ 100 gross sf =	14 Occupants
Total First Floor		111 Occupants	Total First Floor		118 Occupants
Second Floor			Second Floor		
Assembly Space (Unconcentrated)	1,920 sf @ 15 sf net =	128 Occupants	Assembly Space (Unconcentrated)	1,920 sf @ 15 sf net =	128 Occupants
Bar Seating	10 Seats =	10 Occupants	Bar Seating	10 Seats =	10 Occupants
Fixed Booth Seating	10 Seats =	10 Occupants	Fixed Booth Seating	10 Seats =	10 Occupants
Kitchen	555 sf @ 200 gross sf =	3 Occupants	Kitchen	555 sf @ 200 gross sf =	6 Occupants
Total Second Floor		151 Occupants	Total Second Floor		154 Occupants
Total Occupants		262 Occupants	Total Occupants		272 Occupants
Outdoor Patio Seating			Outdoor Patio Seating		
Assembly Space (Unconcentrated)	1,330 sf @ 15 sf net =	89 Occupants	Assembly Space (Unconcentrated)	1,330 sf @ 15 sf net =	89 Occupants
Bar Seating	11 Seats	11 Occupants	Bar Seating	11 Seats	11 Occupants
Total Ground Floor Patio Occupants		100 Occupants	Total Ground Floor Patio Occupants		100 Occupants

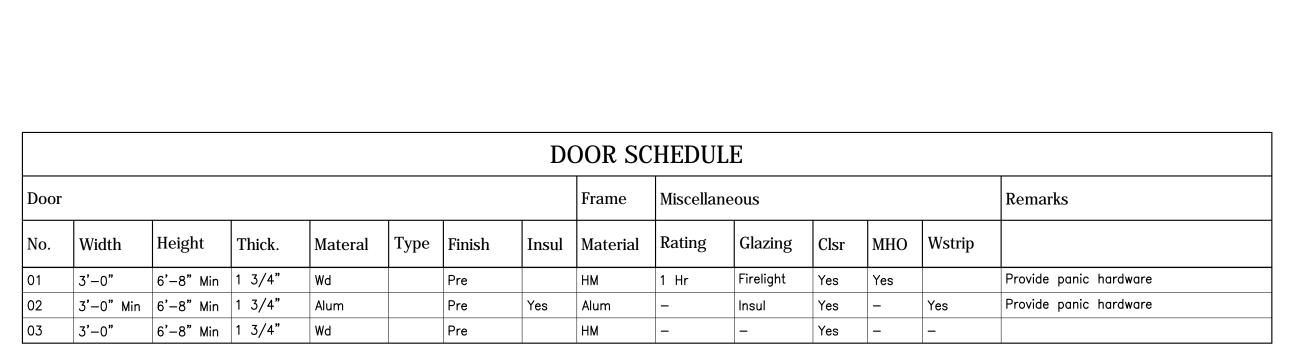

<u>Door Egress</u>

Abbreviations		Door and Frame Notes		
Al	Aluminum	1.	All doors shall be located 3" off adjacent wall	
Clsr	Closer		except where noted or dimensioned	
Ex	Existing	2.	All door thickness to be 1 3/4" unless noted otherwise	
мно	Magnetic Hold Open		other wise	
НМ	Hollow Metal	3.	Provide minimum of 20 ga. double studs (or	
Hrdware	Hardware		double wood stud) at all door jambs.	
Insul	Insulated	4.	All floor material transitions shall occur under door	
Ob	Obscure Glass, Tempered	in closed position	in closed position	
Pnt	Paint	5.	All door bardware aball most ADA Handles pulls	
Pre	Prefinished	5.	All door hardware shall meet ADA. Handles, pulls and latches shall be lever style. When sliding	
Thick	Thickness		doors are fully opened (if specified), operating	
Wstrp	Weatherstriping		hardware shall be exposed and usable from both sides.	
Wd	Wood	6.	All emergency egress doors in assembly rooms shall swing in the direction of travel and shall have panic hardware	



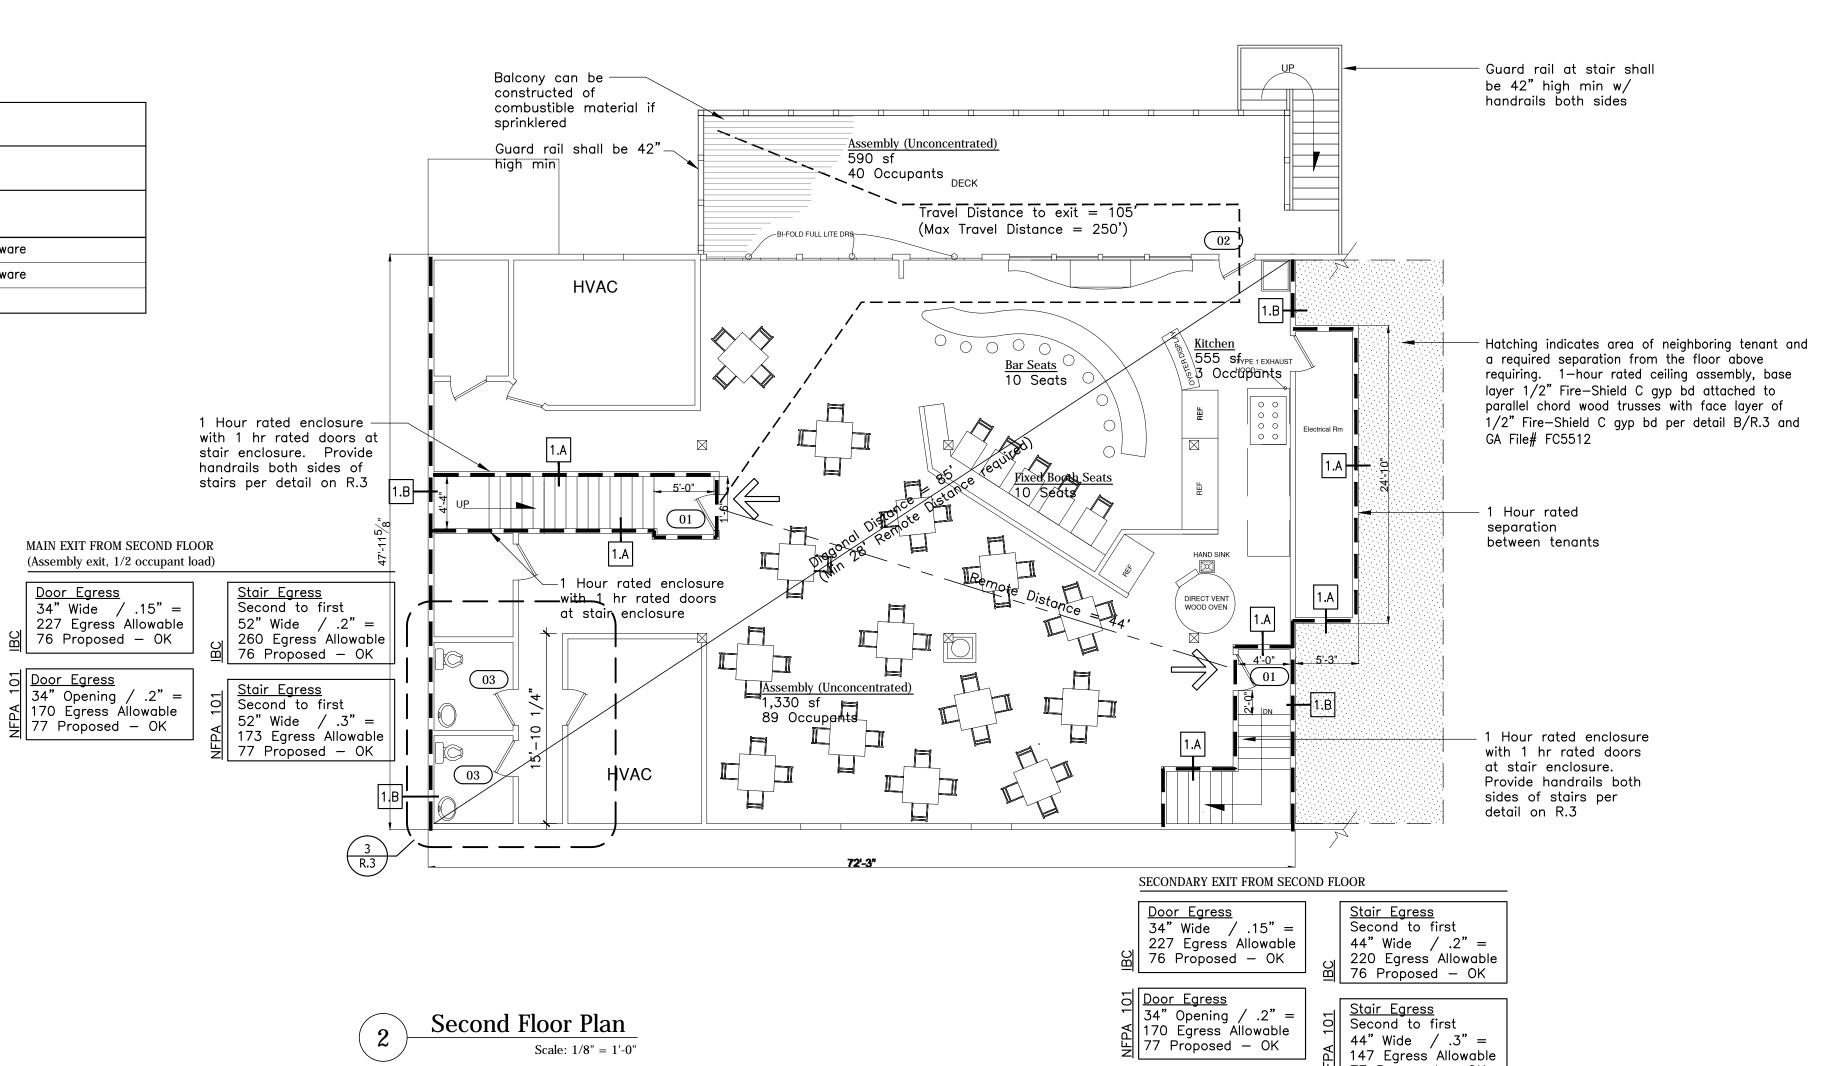

) 77 Proposed - OK

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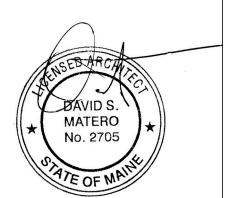
100 Front Street Suite 40 Bath, Maine 04530 207.671.6820 david@davidmatero.com

<u>Consultants</u>

Revisions

Poppy's Fish Shack and Oyster Room

6 Custom House Wharf Street Portland, Maine



Job Number: 12.023 Date: 12.26.12

Scale: 1/8" = 1'-0"

Code Review Plans

Drawing Title:

Issue for Permit

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SYMBOL LEGEND

- LED Exit Light (unswitched)
- LED Exit Light w/ Directional Arrow (unswitched)
- Self Contained, wall—mounted, Emergency Lighting Unit with 2 Heads and battery backup
- Self Contained, ceiling—mounted, Emergency Lighting Unit with 2 Heads and battery backup
- Single Head Remote Emergency Light
- Fire Alarm Audio/Visual, mount 6'-8" AFF, dB
- Fire Alarm Visual Strobe only, Flush mount 6'-8" AFF, set Candela Level in Field according to code
- System connected Smoke Detector, photoelectric type w/ Sounder base
- Fire Alarm pull station, mount 48" AFF
- Fire Alarm Control Panel Station, location to be approved by Portland Fire Department
- Knox Box (location and type to be approved by Portland Fire Department)
- Fire extinguisher cabinet and type
- ETR Existing to Remain
- Magnetic Hold Open (requires smoke MHO detectors located on each side of door
- and connected to sprinkler system)
- WP Exterior grade / waterproof

NOTES

- 1. Life safety equipment and locations shall conform to all
- applicable codes.

 2. Fully test and inspect sprinkler system.

 3. Provide smoke detectors on both sides of doors with magnetic hold opens.
- 4. Provide pull station at each assembly door egress.5. Provide duct smoke detectors at each 2,000 CFM supply
- 6. Provide duct smoke detectors at each 15,000 CFM supply and exhaust duct.
- 7. Obtain water supply flow test if available within last three years, if not available test must be conducted. 8. All sprinkler heads must be quick response type.
- 9. Integrate kitchen smoke/fire detection/suppression system with main fire panel. Provide automátic cooking fuel
- shut—off mechanism. 10. Electrical outlets shall be provided for all plug—in equipment. All other outlets shall be located per all applicable codes.
- 11. Refer to food service drawings for all equipment requiring
- direct wiring. 12. Fire alarm system notification shall be via approved voice communication, or public address system that is audible above the ambient noise level of assembly occupancy. Notification shall be by means of voice announcements, either live or prerecorded initiated by the person in the constantly attended location.
- 13. Provide laminated floor plan at each public room indicating direction to building exit.

Fire Extinguisher Cabinet


Semi—recessed Fire Extinguisher Cabinet by Larsen of approved equivalent. Include Class K hazard in Kitchen

- Portable Fire Extinguishers:


 1. Location of fire extinguishers and cabinets shall conform to NFPA 10 Standards for Fire Extinguisher Cabinets.

 2. Portable fire extinguisher rating shall be 2—A, spacing shall not exceed a maximum of 75' and 3,000 sf.

 3. Portable fire extinguisher rating in combustible cooking media exist shall be rated Class K, spacing shall not exceed a maximum travel distance of 30'

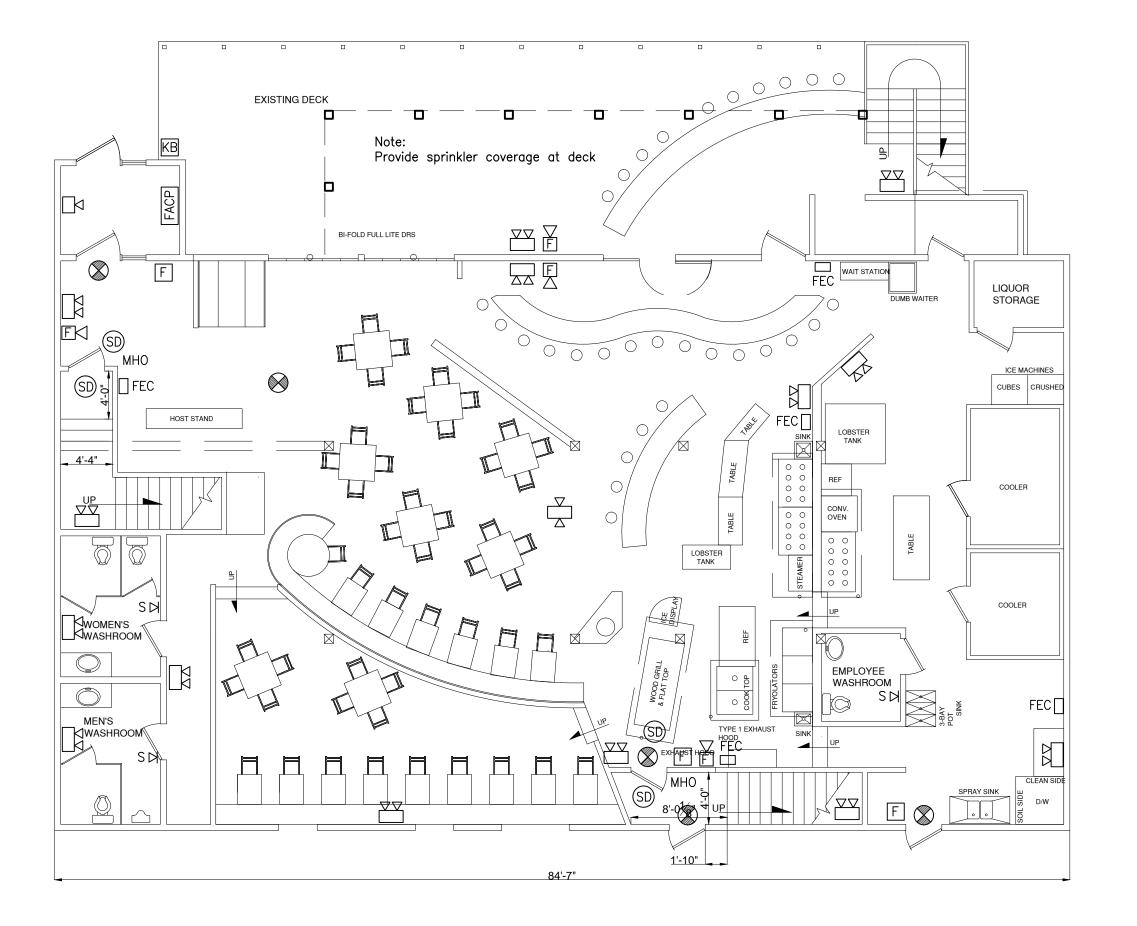

First Floor Plan Scale: 1/8" = 1'-0"

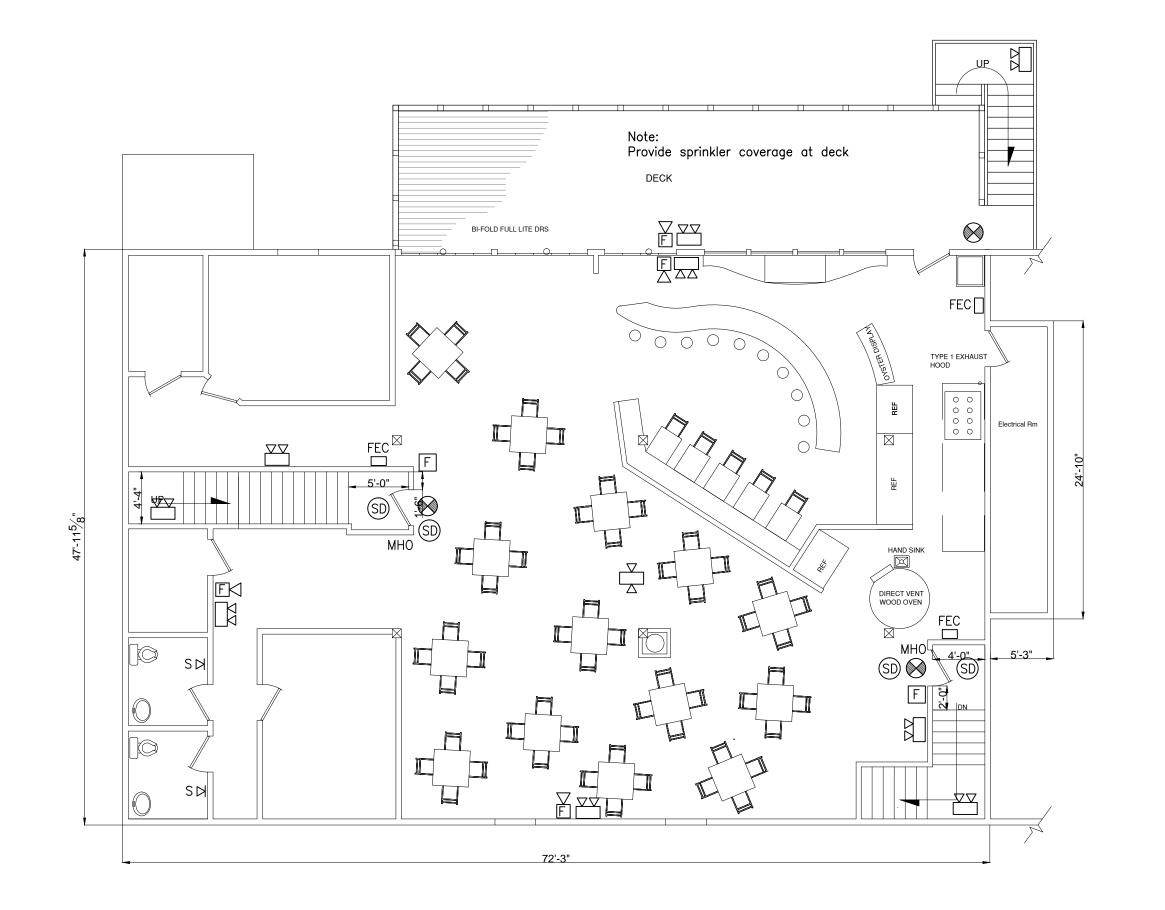



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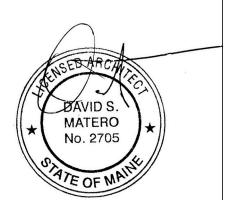
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<u>Consultants</u>

<u>Revisions</u>

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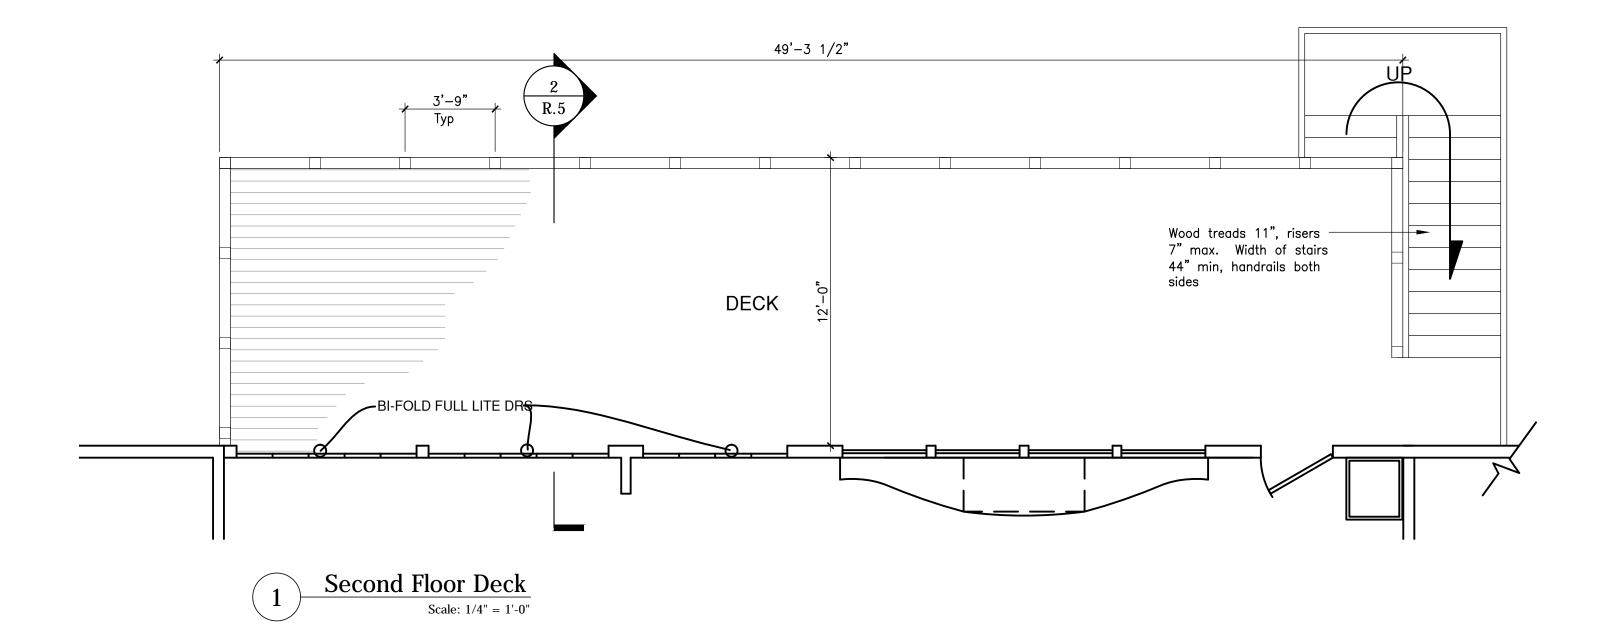
Job Number: 12.023 Date: 11.13.12

Scale: 1/8" = 1'-0"

Drawing Title: Electrical Life Safety Plan

Issue for Permit

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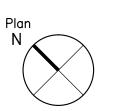


2 x 6 Hardwd cap, — continuous 4 x 4 Wd posts at -3'-8" oc max Cable rail system — (cables at 3" oc) Mahogany decking PT structural framing, see structural dwgs EPDM membrane PT tapered strapping Ext grade plywood PT Tapered strapping 1 x 6 T&G Doug Fir Posts continuous to bottom of beam and attached w/ through bolts 11'-11 1/2" 1 x 10 Fascia -5/4 x 12 Subfascia — - Reverse cut PT sleepers PT Ledger attached to -existing building — Reverse cut PT sleepers to 5 x 5 Structural post,— refer to structural dwgs PT blocking to assist in attaching sleepers attach flat clg 1 x 6 T&G Doug Fir clg — EPDM membrane on ext grade plywood, slope to drain 1/8" per foot, min Wrap post w/ 1 x Wd— on PT furring strips Existing construction — Conc footing, refer to — structural dwgs

Deck Section

David Matero Architecture

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Consultants

<u>Revisions</u>

Poppy's Fish Shack and Oyster Room

6 Custom House Wharf Street Portland, Maine

> Job Number: 12.023 Date: 12.26.12 Scale: As Noted

> > Drawing Title:

Deck Details

R.5
Issue for


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ISSUED

DR. CKD.
BY BY DATE
BY BY DATE
BY BY 12-26-12

SHEET TITLE:

STRUCTURAL NOTES

DESIGNED:SJPDRAWN:SJPDATE:12-26-12PROJECT NUMBER:12-116
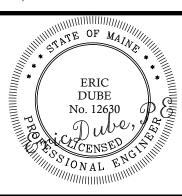
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