2. GENERAL CONTRACTOR SHALL CONSULT WITH STARBUCKS CONSTRUCTION MANAGER TO RESOLVE ANY CHANGES, OMISSIONS, OR PLAN DISCREPANCIES PRIOR TO BIDDING OR CONSTRUCTION.

3. ALL WORK SHALL BE PERFORMED IN STRICT COMPLIANCE WITH LOCAL, COUNTY, STATE, AND FEDERAL CODES AND ORDINANCES.

4. GENERAL CONTRACTOR SHALL VERIFY THE LOCATION OF ALL UTILITIES.

5. GENERAL CONTRACTOR TO VERIFY ALL DIMENSIONS, INCLUDING CLEARANCES REQUIRED BY OTHER TRADES, AND NOTIFY STARBUCKS CONSTRUCTION MANAGER OF ANY DISCREPANCIES PRIOR TO PROCEEDING WITH THE WORK. ALL DIMENSIONS ARE TO THE FACE OF THE FINISHED SURFACE UNLESS NOTED OTHERWISE. ALL DIMENSIONS TO BE TAKEN FROM DESIGNATED DATUM POINT. DO NOT SCALE DRAWINGS.

6. GENERAL CONTRACTOR SHALL PATCH AND REPAIR ALL EXISTING WALLS. FLOORS, CEILINGS, OR OTHER SURFACES IDENTIFIED TO REMAIN THAT MAY BECOME DAMAGED DURING THE COURSE OF THE WORK.

7. THE GENERAL CONTRACTOR IS RESPONSIBLE FOR OBTAINING PERMITS FOR FIRE PROTECTION, PLUMBING, MECHANICAL, AND ELECTRICAL SYSTEMS PRIOR TO INSTALLATION OF SUCH SYSTEMS.

8. GENERAL CONTRACTOR SHALL RETAIN ONE SET OF THE PLANS TO NOTE AND DOCUMENT ALL CHANGES DURING CONSTRUCTION. THIS SET SHALL BE A PART OF THE GENERAL CONTRACTOR'S "STORE CLOSE-OUT PACKAGE" AS DESCRIBED IN THE CONSTRUCTION MANAGEMENT AGREEMENT.

9. GENERAL CONTRACTOR IS RESPONSIBLE FOR COORDINATING DELIVERY OF MATERIALS FROM STARBUCKS CONTRACTED THIRD PARTY LOGISTICS DISTRIBUTION SERVICES AND VENDOR DIRECT SHIPMENTS. REFER TO CONSTRUCTION MANAGEMENT AGREEMENT FOR METHODS AND LEAD TIMES.

10. RESPONSIBILITY FOR SUPPLY AND DELIVERY OF MATERIALS AND EQUIPMENT IS IDENTIFIED IN THE DRAWING SCHEDULE SHEETS UNDER THE COLUMN LABELED "RESPONSIBILITY".

11. FOR THE PURPOSE OF THE DOCUMENTS, TO "INSTALL", SHALL MEAN TO PROVIDE ALL FASTENERS, MISCELLANEOUS HARDWARE, BLOCKING, ELECTRICAL CONNECTIONS, PLUMBING CONNECTIONS, AND OTHER ITEMS REQUIRED FOR A COMPLETE AND OPERATION INSTALLATION, UNLESS OTHERWISE NOTED.

12. ALL ITEM SUBSTITUTIONS MUST BE APPROVED BY THE STARBUCKS DESIGN MANAGER.

13. REFER TO ITEM CUTSHEETS FOR ADDITIONAL INFORMATION.

#### APPLICABLE BUILDING CODES

**BUILDING CODE** FIRE CODE PLUMBING CODE

**ENERGY CODE** 

GAS CODE

D. ZONING:

2009 IBC & 2009 IEBC NFPA 2007 FIRE SAFETY CODES & STANDARDS ADOPTED PURSUANT TO TILE 25, SECTIONS 2452 & 2465 MAINE STATE INTERNATIONAL PLUMBING CODE (UPC 2007) ELECTRICAL CODE 2001 NEC

> 2009 IECC NFPA 54, 2009 (CODE OF MAINE RULES) PROPANE & NATURAL GAS EQUIP. STANDARDS ADOPTED

PURSUANT TO TILE 32, SECTION 18123, SUBSECTION 2

CODE CLASSIFICATION A. OCCUPANCY GROUP: B. CONSTRUCTION CALSSIFICATION TYPE: C. AUTOMATIC FIRE SUPPRESSION SYSTEM INSTALLED:

**B-BUSINESS** EXISTING II-B YES - EXISTING

B-3 DOWNTOWN BUSINESS HISTORIC DISTRICT

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WALL FINISH DETAILS

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CASEWORK DETAILS

CASEWORK DETAILS

**CASEWORK DETAILS** 

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MECHANICAL SPECIFICATIONS

PLUMBING SPECIFICATIONS

PLUMBING WASTE / DRAIN PLAN

**ELECTRICAL SPECIFICATIONS** 

ELECTRICAL POWER PLAN

PLUMBING SUPPLY PLAN

PLUMBING DETAILS

LIGHTING PLAN

FIRE ALARM PLAN

SCHEDULES

SCHEDULES

ENLARGED BAR PLANS CONSTRUCTION DETAILS

#### PROJECT CONTACTS

DESIGN MANAGER: ERICA ZAKAMAREK STARBUCKS COFFEE COMPANY 7 PENN PLAZA 370 7TH AVENUE, 15TH FLOOR NEW YORK, NY 10001 (212) 615-9740 EXT. 9740 OFFICE (917) 971-1026 CELL EZAKAMAR@STARBUCKS.COM

CONSTRUCTION KATHY LISBON MANAGER: (508) 241-7850 CELL (888) 399-7814 FAX KLISBON@STARBUCKS.COM

> LANDLORD: KATIE ALLEN NAI THE DUNHAM GROUP 10 DANA STREET PORTLAND, ME 04101 (207) 773-7100 PHONE (207) 773-5480 FAX

ARCHITECT OF NORR ILLINOIS INC. RECORD: 325 N. LASALLE STREET, SUITE 700 CHICAGO, IL 60654 (312) 424-2400 PHONE (312) 424-2424 FAX

MEP CONSULTANT OF ALKEMEYER AND ASSOCIATES RECORD: 335 MARSHALL AVENUE, SUITE 100 ST. LOUIS, MO 63119 (314) 772-1782 PHONE (314) 772-0109 FAX


#### **ROOM SCHEDULE**

**AREA** ACCESS HALLWAY 76 SF BACKBAR 319 SF SALES 180 SF SEATING 800 SF WORKROOM 305 SF

Grand total

1680 SF

#### **VICINITY PLAN**

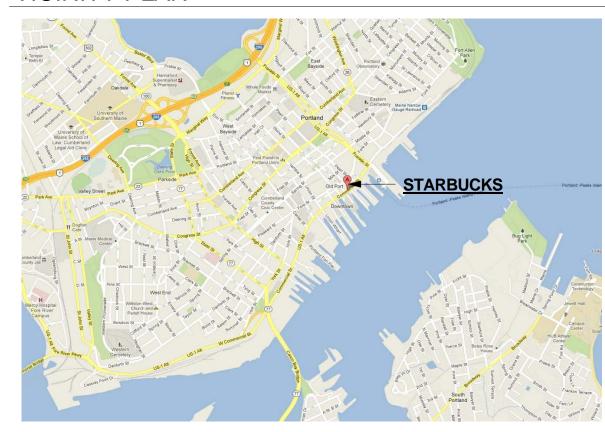

#### ARCHITECT OF RECORD

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STARBUCKS COFFEE

**COMPANY** 

2401 UTAH AVENUE SOUTH

SEATTLE, WASHINGTON 98134

(206) 318-1575

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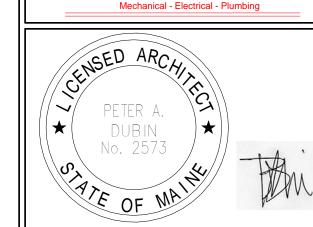
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UNTIL A WRITTEN AGREEMENT IS FULLY EXECUTED BY BOTH PARTIES

325 N. LaSalle St. |Suite 700 |Chicago, IL 60654

#### t 312.424.2400 | f 312.424.2424 | www.norr.com **ENGINEER OF RECORD** St. Louis, Missouri 63119

Phone (314) 772-1782 Fax (314) 373-3514 Engineering Consultants



Revision Schedule							
Rev	Date	Ву	Description				

## STRE R OJECT NAME: OMMERCIAL

STORE #: 19384 PROJECT #: 58862-001 CONCEPT: MCS PALETTE: HERITAGE

ISSUE DATE: JAN. 11, 2013 DESIGN MANAGER: E. ZAKAMAREK LEED® AP:

PRODUCTION DESIGNER: NORR ILLINOIS CHECKED BY:

SHEET TITLE:

SCALE:

**GENERAL INFORMATION** 

SHEET NUMBER:

G-001

As indicated

#### SITE AND OCCUPANCY

**PROJECT DESCRIPTION:** COMMERCIAL TENANT IMPROVEMENTS TO EXISTING BUILDING

**BUILDING HEIGHT:** 3 STORIES **BUILDING USE:** COMMERCIAL

**ZONING:** B-3 DOWNTOWN BUSINESS HISTORIC DISTRICT

TYPE OF USE: COFFEE SHOP TYPE OF OCCUPANCY: B - BUSINESS

**OCCUPANCY LOAD:** RETAIL:

180 SF / 30 = SEATING: 564 SF / 15 = BEVERAGE/PREP: 321 SF / 200 = WORKROOM/STORAGE: 303 SF / 300 = TOTAL OCCUPANCY = 48

**TOTAL SQUARE FOOTAGE**: 1,925 SF TOTAL INTERIOR SEATS: 48 **EXTERIOR SEASONAL** 

**SEATING**: 6 **EXIT CAPACITY:** EXIT 1: 72" WIDE

EXIT 2: 36" WIDE EXIT 3: 26" WIDE TOTAL EXIT WIDTH PROVIDED: 144in  $0.2 \times 47 = 10$ in REQUIRED

**TRAVEL DISTANCE**: 10 < 144 THEREFORE **COMPLIES** 

ALLOWED TRAVEL DISTANCE: 150'-0" ACTUAL TRAVEL DISTANCE: 76'-7"

NUMBER OF EXITS: MIN. NUMBER OF EXITS REQUIRED: 1 NUMBER OF EXITS PROVIDED: 1

3D INTERIOR PERSPECTIVE






ARCHITECTURAL SYMBOL LEGEND

NORTH ARROW PXXX-ES PAINT TAG EXTERIOR ELEVATION XXXXX DESIGN ID TAG (XXXXX) DOOR/WINDOW TAG INTERIOR ELEVATION SECTION CALLOUT X'-XX" AFF ABOVE FINISHED FLOOR HEIGHT TAG (IMPERIAL) XXXX AFF ABOVE FINISHED FLOOR DETAIL CALLOUT HEIGHT TAG (METRIC) REVISION TAG DIMENSION LINE FROM

FACE


REVISION CLOUD

FINISH FACE TO FINISH

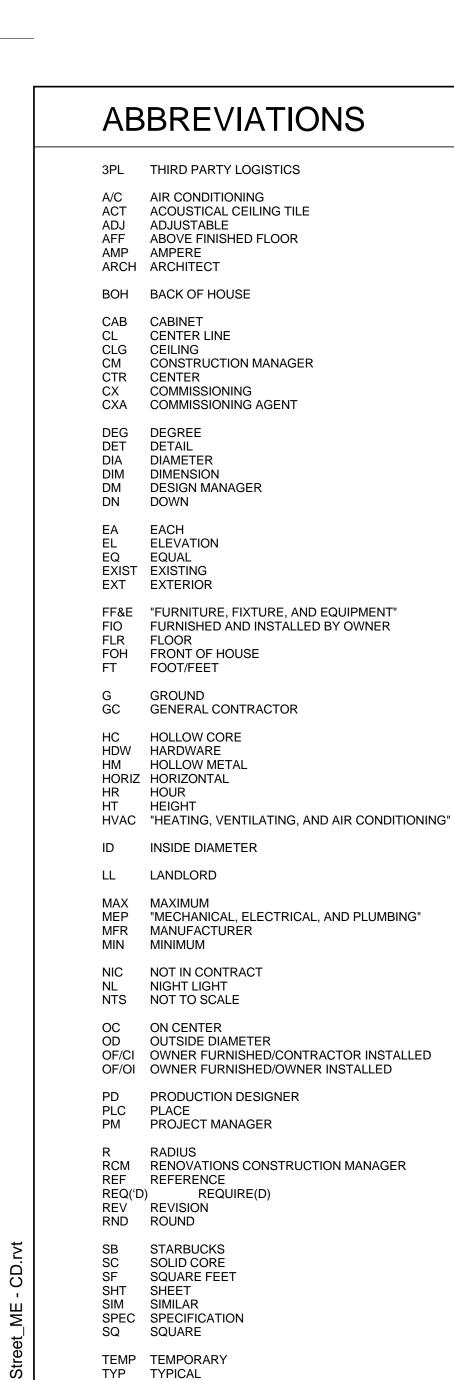

UON UNLESS OTHERWISE NOTED

VD VENDOR DIRECT VERT VERTICAL VIF VERIFY IN FIELD

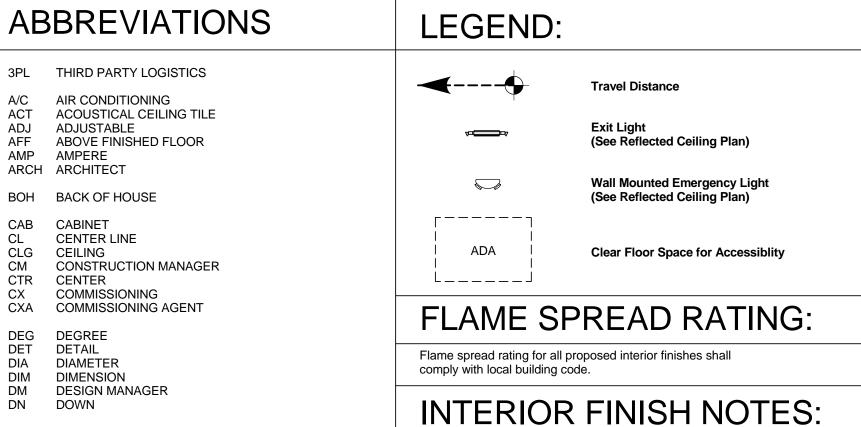

Interior wall and ceiling finish materials shall be

and smoke developed less than 450.


shall meet Class A requirements.

Class C with a flame spread rating less than 200

Floor Coverings in the exit path of all common areas

4 LIFE SAFETY PLAN

Scale: 1/4" = 1'-0"

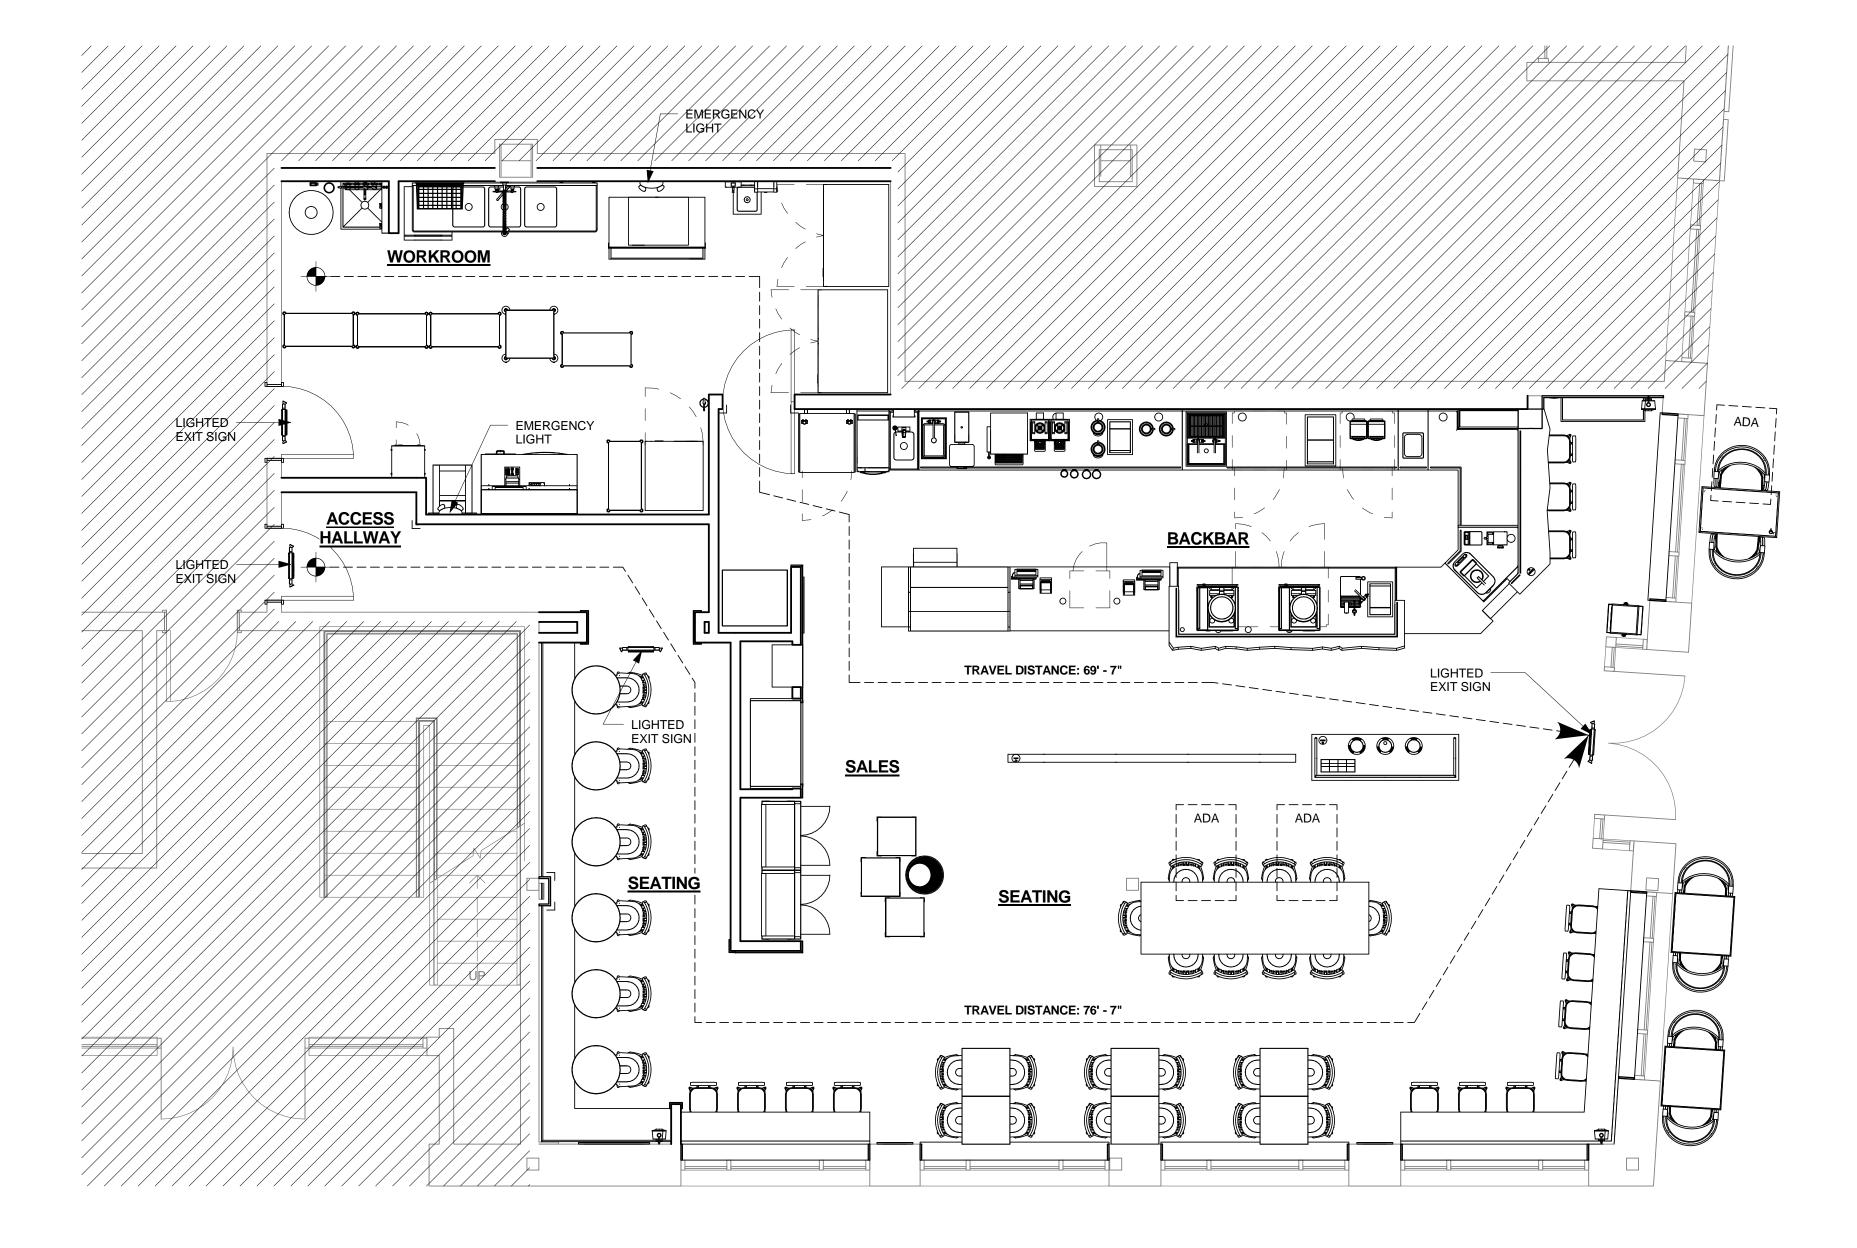



#### STARBUCKS COFFEE COMPANY 2401 UTAH AVENUE SOUTH SEATTLE, WASHINGTON 98134


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ARCHITECT OF RECORD





Engineering Consultants Mechanical - Electrical - Plumbing

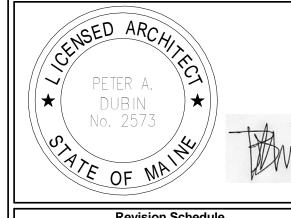

	Revision Schedule						
Rev	Date	Ву	Description				

STREE

STORE #: 19384 PROJECT #: 58862-001 MCS CONCEPT: PALETTE: HERITAGE ISSUE DATE: JAN. 11, 2013 DESIGN MANAGER: E. ZAKAMAREK

LEED $^{ extsf{R}}$ AP: PRODUCTION DESIGNER: NORR ILLINOIS

CHECKED BY:

SHEET TITLE: LIFE SAFETY PLAN

1/4" = 1'-0"

SCALE: SHEET NUMBER:

#### SCOPE OF WORK SUMMARY

1. CONSTRUCT NEW INTERIOR PARTITION WALLS AS INDICATED ON FLOOR PLAN.

2. INSTALL NEW MCS BARISTA (WITH CLOVER) AS INDICATED ON CASEWORK PLAN.

CASEWORK PLAN.

4. INSTALL NEW CONDIMENT CART AS INDICATED ON

3. INSTALL NEW CASEWORK ITEMS AS INDICATED ON

CASEWORK PLAN.

5. INSTALL NEW PLUMBING ITEMS AS INDICATED ON

6. INSTALL NEW EQUIPMENT AS INDICATED ON FF&E

7. INSTALL NEW MISCELLANEOUS ITEMS AS INDICATED ON FF&E PLAN.

FF&E PLAN.

8. INSTALL NEW FURNITURE AS INDICATED ON FF&E PLAN.

9. INSTALL NEW BANQUETTE WITH POWER AS INDICATED ON CASEWORK AND PENETRATION PLANS.

10. INSTALL NEW GRAPHICS AS INDICATED ON INTERIOR ELEVATIONS.

11. INSTALL NEW CHAIR RAIL AND WAINSCOT AS INDICATED ON WALL FINISH AND CASEWORK PLANS.12. INSTALL NEW WALL FINISHES THROUGHOUT AS

INDICATED ON INTERIOR ELEVATIONS AND WALL FINISH PLAN.

13. INSTALL NEW FLOOR FINISHES AS INDICATED ON FLOOR FINISH PLAN.

14. INSTALL NEW LIGHT FIXTURES AS INDICATED ON REFLECTED CEILING AND DIMENSIONED LIGHTING PLANS.

15. INSTALL NEW CEILING FINISHES AS INDICATED ON REFLECTED CEILING AND UPPER CASEWORK PLANS.

16. PATCH, PRIME AND PAINT WALL, CEILINGS AND/OR SOFFITS AS INDICATED ON REFLECTED CEILING PLANS AND INTERIOR ELEVATIONS.

17. INSTALL NEW ELECTRICAL OUTLETS AS INDICATED ON PENETRATION PLAN.

18. INSTALL NEW SIGNAGE AS INDICATED ON REFLECTED CEILING PLAN AND EXTERIOR ELEVATIONS.



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ARCHITECT OF RECORD






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Sociates

Engineering Consultants

Mechanical - Electrical - Plumbing

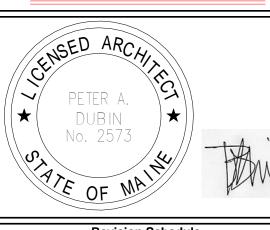

Revision Schedule					
Rev	Date	Ву	Description		

# PROJECT NAME: COMMERCIAL STREET 145 COMMERCIAL STREET PORTLAND, ME 04101 CUMBERLAND COUNTY

STORE #: 19384

PROJECT #: 58862-001

CONCEPT: MCS

PALETTE: HERITAGE

ISSUE DATE: JAN. 11, 2013

DESIGN MANAGER: E. ZAKAMAREK

LEED® AP:

PRODUCTION DESIGNER: NORR ILLINOIS

CHECKED BY:

SHEET TITLE:


SCOPE OF WORK PLAN

SCALE:

SHEET NUMBER:

1/4" = 1'-0"

4)

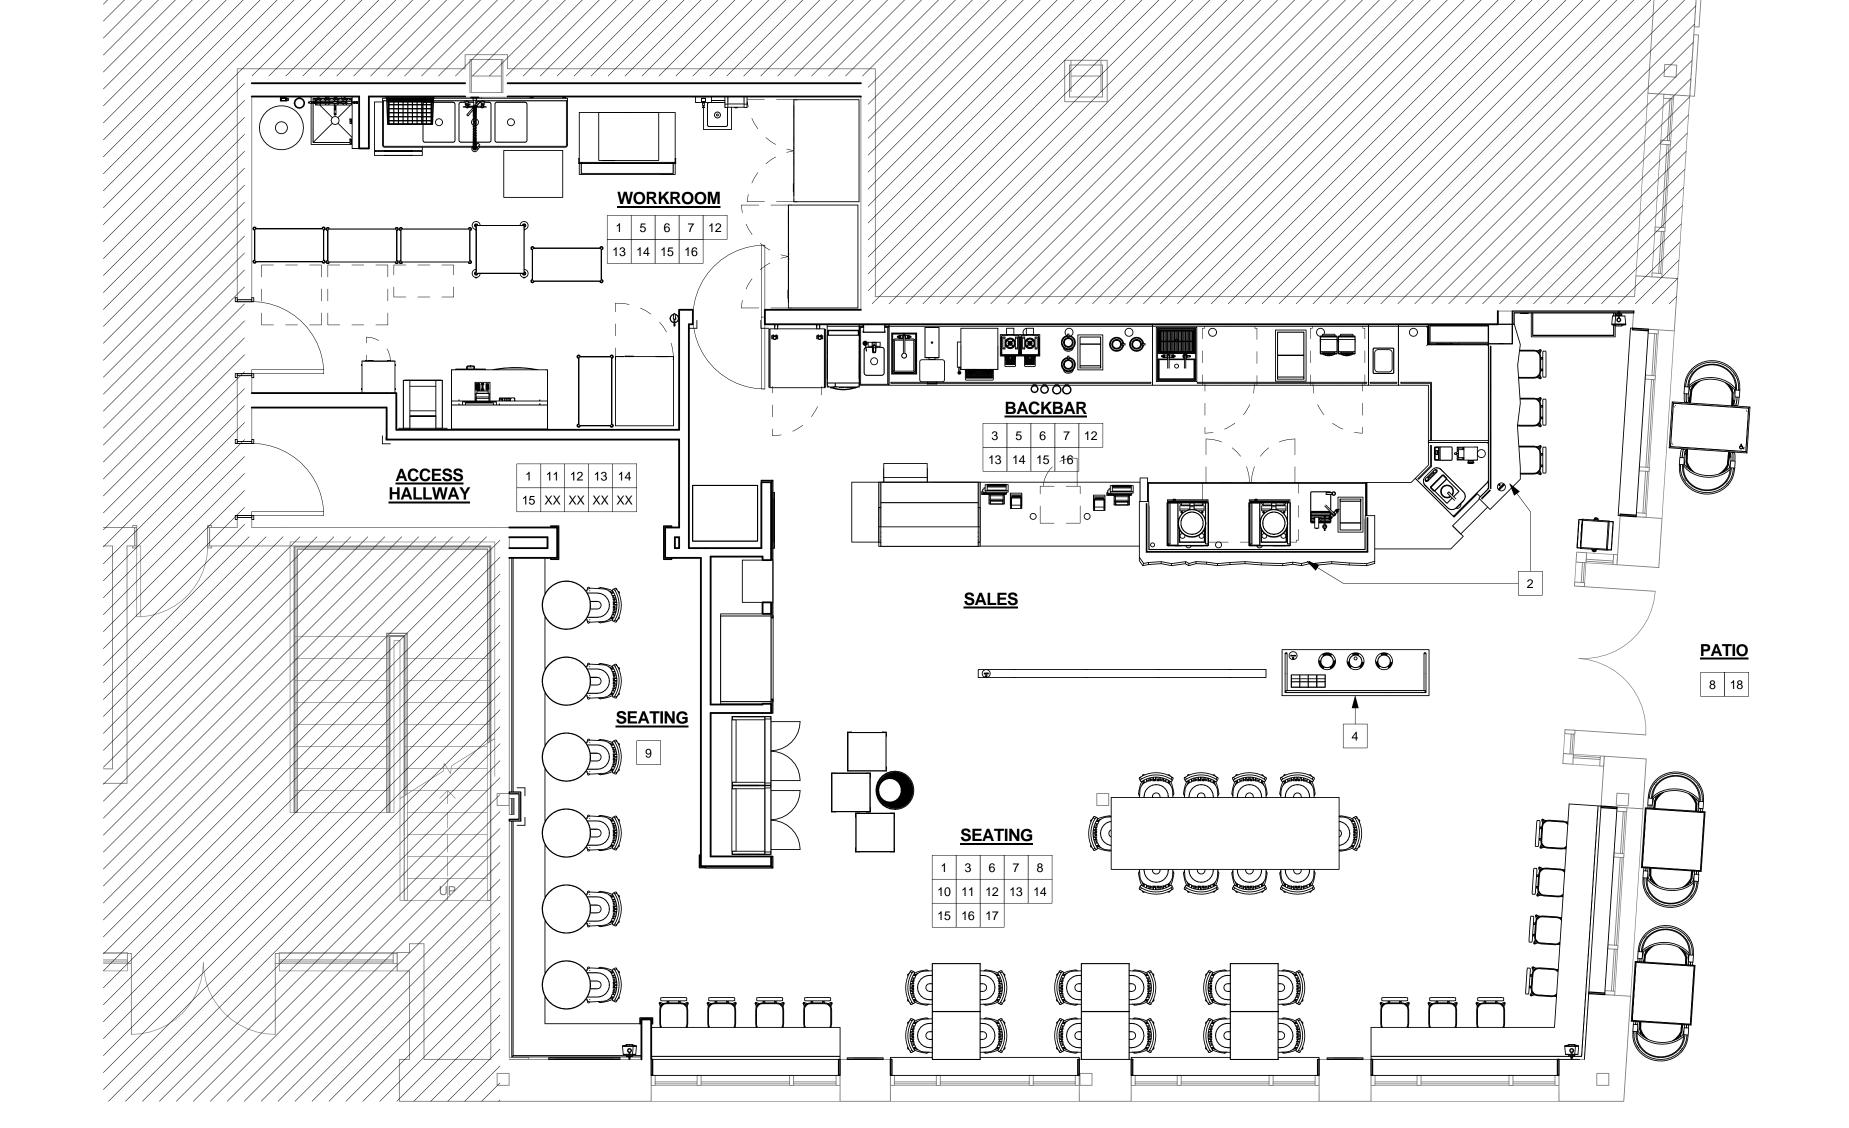

0 2' 4'
Scale: 1/4" = 1'-0"

DOCUMENTS BY REFERENCE PUBLICATION DATES: COMPLY WITH STANDARDS IN EFFECT AS OF DATE OF THE CONTRACT DOCUMENTS UNLESS OTHERWISE INDICATED. COPIES OF STANDARDS: EACH ENTITY ENGAGED IN CONSTRUCTION ON PROJECT SHOULD BE FAMILIAR WITH INDUSTRY STANDARDS APPLICABLE TO

> BOUND WITH THE CONTRACT DOCUMENTS. WHERE COPIES OF STANDARDS ARE NEEDED TO PERFORM A REQUIRED CONSTRUCTION ACTIVITY, OBTAIN COPIES DIRECTLY

ITS CONSTRUCTION ACTIVITY. COPIES OF APPLICABLE STANDARDS ARE NOT

FROM PUBLICATION SOURCE. ABBREVIATIONS AND ACRONYMS

INDUSTRY ORGANIZATIONS: WHERE ABBREVIATIONS AND ACRONYMS ARE USED IN SPECIFICATIONS OR OTHER CONTRACT DOCUMENTS, THEY SHALL MEAN THE RECOGNIZED NAME OF THE ENTITIES IN THE FOLLOWING LIST.

AMERICAN CONCRETE INSTITUTE AHA AMERICAN HARDBOARD ASSOCIATION AITC AMERICAN INSTITUTE OF TIMBER CONSTRUCTION **ANSI** AMERICAN NATIONAL STANDARDS INSTITUTE APA APA - THE ENGINEERED WOOD ASSOCIATION AMERICAN SOCIETY OF HEATING, REFRIGERATING AND **ASHRAE** 

AIR-CONDITIONING ENGINEERS ASTM ASTM INTERNATIONAL (AMERICAN SOCIETY FOR TESTING AND MATERIALS INTERNATIONAL) ARCHITECTURAL WOODWORK INSTITUTE **Δ\**//Ι

AWPA AMERICAN WOOD PROTECTION ASSOCIATION (FORMERLY: AMERICAN WOOD PRESERVERS' ASSOCIATION) CARPET AND RUG INSTITUTE (THE)

CRRC COOL ROOF RATING COUNCIL CANADIAN STANDARDS ASSOCIATION CSA CSA CSA INTERNATIONAL (FORMERLY: IAS - INTERNATIONAL APPROVAL SERVICES)

CONSTRUCTION SPECIFICATIONS INSTITUTE (THE) ETL SEMCO INTERTEK ETL SEMCO (FORMERLY: ITS - INTERTEK TESTING SERVICE NA)

FM GLOBAL FM GLOBAL (FORMERLY: FMG - FM GLOBAL) FSC FOREST STEWARDSHIP COUNCIL

HARDWOOD PLYWOOD & VENEER ASSOCIATION **HPVA** ISO INTERNATIONAL ORGANIZATION FOR STANDARDIZATION INTERTEK TESTING SERVICE NA ITS (NOW ETL SEMCO)

MFMA MAPLE FLOORING MANUFACTURERS ASSOCIATION, INC. MPI MASTER PAINTERS INSTITUTE NFPA (NATIONAL FIRE PROTECTION ASSOCIATION)

NOFMA NOFMA: THE WOOD FLOORING MANUFACTURERS ASSOCIATION (FORMERLY: NATIONAL OAK FLOORING MANUFACTURERS ASSOCIATION) OPL INTERTAK STEEL DOOR INSTITUTE

SHEET METAL AND AIR CONDITIONING CONTRACTORS' **SMACNA** NATIONAL ASSOCIATION UNDERWRITERS LABORATORIES INC.

USGBC U.S. GREEN BUILDING COUNCIL WEST COAST LUMBER INSPECTION BUREAU **WCLIB** WOODWORK INSTITUTE (FORMERLY: WIC - WOODWORK INSTITUTE OF CALIFORNIA

CODE AGENCIES: WHERE ABBREVIATIONS AND ACRONYMS ARE USED IN SPECIFICATIONS OR OTHER CONTRACT DOCUMENTS, THEY SHALL MEAN THE RECOGNIZED NAME OF THE ENTITIES IN THE FOLLOWING LIST. DEUTSCHES INSTITUT FUR NORMUNG E.V. INTERNATIONAL CODE COUNCIL ICC EVALUATION SERVICE. INC

FEDERAL GOVERNMENT AGENCIES: WHERE ABBREVIATIONS AND ACRONYMS ARE USED IN SPECIFICATIONS OR OTHER CONTRACT DOCUMENTS, THEY SHALL MEAN THE RECOGNIZED NAME OF THE ENTITIES IN THE FOLLOWING LIST. ENVIRONMENTAL PROTECTION AGENCY

STANDARDS AND REGULATIONS: WHERE ABBREVIATIONS AND ACRONYMS ARE USED IN SPECIFICATIONS OR OTHER CONTRACT DOCUMENTS, THEY SHALL MEAN THE RECOGNIZED NAME OF THE STANDARDS AND REGULATIONS IN THE FOLLOWING LIST.

AMERICANS WITH DISABILITIES ACT (ADA) ARCHITECTURAL BARRIERS ACT (ABA) ACCESSIBILITY GUIDELINES FOR BUILDINGS AND FACILITIES AVAILABLE FROM U.S. ACCESS BOARD

CODE OF FEDERAL REGULATIONS AVAILABLE FROM GOVERNMENT PRINTING OFFICE STATE GOVERNMENT AGENCIES: WHERE ABBREVIATIONS AND ACRONYMS ARE USED IN SPECIFICATIONS OR OTHER CONTRACT DOCUMENTS, THEY SHALL MEAN THE RECOGNIZED NAME OF THE ENTITIES IN THE FOLLOWING

CALIFORNIA DEPARTMENT OF HEALTH SERVICES CALIFORNIA DEPARTMENT OF PUBLIC HEALTH, INDOOR AIR QUALITY

END OF SECTION 014200

#### GENERAL CONDITIONS (CONTINUED)

SECTION 017419 - CONSTRUCTION WASTE MANAGEMENT AND DISPOSAL

JURISDICTION

1.1 SUMMARY SALVAGING NONHAZARDOUS DEMOLITION AND CONSTRUCTION WASTE RECYCLING NONHAZARDOUS DEMOLITION AND CONSTRUCTION WASTE. DISPOSING OF NONHAZARDOUS DEMOLITION AND CONSTRUCTION WASTE.

CONSTRUCTION WASTE: BUILDING AND SITE IMPROVEMENT MATERIALS AND OTHER SOLID WASTE RESULTING FROM CONSTRUCTION, REMODELING. RENOVATION, OR REPAIR OPERATIONS. CONSTRUCTION WASTE INCLUDES

DEMOLITION WASTE: BUILDING AND SITE IMPROVEMENT MATERIALS RESULTING FROM DEMOLITION OR SELECTIVE DEMOLITION OPERATIONS. DISPOSAL: REMOVAL OFF-SITE OF DEMOLITION AND CONSTRUCTION WASTE AND SUBSEQUENT SALE, RECYCLING, REUSE, OR DEPOSIT IN LANDFILL OR INCINERATOR ACCEPTABLE TO AUTHORITIES HAVING

RECYCLE: RECOVERY OF DEMOLITION OR CONSTRUCTION WASTE FOR SUBSEQUENT PROCESSING IN PREPARATION FOR REUSE. SALVAGE: RECOVERY OF DEMOLITION OR CONSTRUCTION WASTE AND SUBSEQUENT SALE OR REUSE IN ANOTHER FACILITY. SALVAGE AND REUSE: RECOVERY OF DEMOLITION OR CONSTRUCTION WASTE AND SUBSEQUENT INCORPORATION INTO THE WORK.

PERFORMANCE REQUIREMENTS END-OF-PROJECT RATES FOR SALVAGE/RECYCLING: 75 PERCENT.

ACTION SUBMITTALS WASTE MANAGEMENT PLAN: SUBMIT PLAN WITHIN 7 DAYS OF DATE ESTABLISHED FOR COMMENCEMENT OF THE WORK. TYPES AND QUANTITIES OF DEMOLITION AND CONSTRUCTION TYPE OF WASTE AND WHETHER IT WILL BE SALVAGED, RECYCLED.

OR DISPOSED OF IN LANDFILL OR INCINERATOR. NET ADDITIONAL COST OR NET SAVINGS RESULTING FROM WASTE MANAGEMENT PLAN.

1.5 INFORMATION SUBMITTALS WASTE REDUCTION PROGRESS REPORTS: CONCURRENT WITH EACH APPLICATION FOR PAYMENT, SUBMIT REPORT INDICATING TYPE OF WASTE AND WHETHER IT HAS BEEN SALVAGED. RECYCLED, OR DISPOSED OF IN

LANDFILL OR INCINERATOR. WASTE DISPOSAL RECORDS: INDICATE RECEIPT AND ACCEPTANCE OF WASTE MATERIAL BY ACCEPTING AND PROCESSING FACILITIES LICENSED TO ACCEPT THEM. INCLUDE MANIFESTS, TYPE OF MATERIAL, WEIGHT OR VOLUME TICKETS, RECEIPTS, AND INVOICES.

LEED SUBMITTAL: CWM REPORTING TEMPLATE, TABULATING TOTAL WASTE MATERIAL, QUANTITIES DIVERTED AND MEANS BY WHICH IT IS DIVERTED, AND STATEMENT THAT REQUIREMENTS FOR THE CREDIT HAVE BEEN MET RECYCLING WASTE

RECYCLING INCENTIVES: REVENUES AND OTHER INCENTIVES FOR RECYCLING WILL ACCRUE TO OWNER. **END OF SECTION 017419** 

#### GENERAL CONDITIONS (CONTINUED)

SECTION 018100 - SUSTAINABLE DESIGN REQUIREMENTS 1.1 SUMMARY

THIS SECTION INCLUDES GENERAL REQUIREMENTS AND PROCEDURES FOR COMPLIANCE WITH CERTAIN U.S. GREEN BUILDING COUNCIL'S (USGBC) LEED PREREQUISITES AND CREDITS NEEDED FOR THE PROJECT TO OBTAIN LEED CERTIFICATION BASED ON LEED 2009 FOR RETAIL: **COMMERCIAL INTERIORS.** 

OTHER LEED PREREQUISITES AND CREDITS NEEDED TO OBTAIN LEED CERTIFICATION ARE DEPENDENT ON MATERIAL SELECTIONS AND MAY NOT BE SPECIFICALLY IDENTIFIED AS LEED REQUIREMENTS. COMPLIANCE WITH REQUIREMENTS NEEDED TO OBTAIN LEED PREREQUISITES AND CREDITS MAY BE USED AS ONE CRITERION TO EVALUATE SUBSTITUTION REQUESTS.

ADDITIONAL LEED PREREQUISITES AND CREDITS NEEDED TO OBTAIN THE INDICATED LEED CERTIFICATION ARE DEPENDENT ON THE ARCHITECT'S DESIGN AND OTHER ASPECTS OF THE PROJECT THAT ARE NOT PART OF THE WORK OF THE CONTRACT.

1.2 DEFINITIONS BASE BUILDING MATERIAL: MATERIALS PERMANENTLY ATTACHED TO THE STRUCTURE. INCLUDES FINISHES AND PERMANENT CABINETS AND

> CHAIN-OF-CUSTODY CERTIFICATES: CERTIFICATES SIGNED BY MANUFACTURERS CERTIFYING THAT WOOD USED TO MAKE PRODUCTS WAS OBTAINED FROM FORESTS CERTIFIED BY AN FSC-ACCREDITED CERTIFICATION BODY TO COMPLY WITH FSC STD-01-001, "FSC PRINCIPLES AND CRITERIA FOR FOREST STEWARDSHIP." CERTIFICATES SHALL INCLUDE EVIDENCE THAT MANUFACTURER IS CERTIFIED FOR CHAIN OF CUSTODY BY AN FSC-ACCREDITED CERTIFICATION BODY

REGIONALLY MANUFACTURED MATERIALS: MATERIALS THAT ARE MANUFACTURED WITHIN A RADIUS OF 500 MILES (800 KM) FROM PROJECT SITE. MANUFACTURING REFERS TO THE FINAL ASSEMBLY OF COMPONENTS INTO THE BUILDING PRODUCT THAT IS INSTALLED AT

REGIONALLY EXTRACTED AND MANUFACTURED MATERIALS: REGIONALLY MANUFACTURED MATERIALS MADE FROM RAW MATERIALS THAT ARE EXTRACTED, HARVESTED, OR RECOVERED WITHIN A RADIUS OF 500 MILES (800 KM) FROM PROJECT SITE.

RECYCLED CONTENT: MATERIAL THAT HAS BEEN BROKEN DOWN AND RECONSTITUTED INTO NEW MATERIAL. THE RECYCLED CONTENT VALUE OF A MATERIAL ASSEMBLY SHALL BE DETERMINED BY WEIGHT. THE RECYCLED FRACTION OF THE ASSEMBLY IS THEN MULTIPLIED BY THE COST OF ASSEMBLY TO DETERMINE THE RECYCLED CONTENT VALUE. "POST-CONSUMER" MATERIAL IS DEFINED AS WASTE MATERIAL GENERATED BY HOUSEHOLDS OR BY COMMERCIAL, INDUSTRIAL AND INSTITUTIONAL FACILITIES IN THEIR ROLE AS END USERS OF THE PRODUCT, WHICH CAN NO LONGER BE USED FOR ITS

INTENDED PURPOSE. "PRE-CONSUMER" MATERIAL IS DEFINED AS MATERIAL DIVERTED FROM THE WASTE STREAM DURING THE MANUFACTURING PROCESS. EXCLUDED IS REUTILIZATION OF MATERIALS SUCH AS REWORK, REGRIND, OR SCRAP GENERATED IN A PROCESS AND CAPABLE OF BEING RECLAIMED WITHIN THE SAME PROCESS THAT

GENERATED I RESOURCE REUSE: MATERIAL THAT HAS BEEN KEPT INTACT AND REPURPOSED TO A NEW USE ON THE SAME PROJECT SITE OR FOR THE ORIGINAL OR NEW USE ON A DIFFERENT PROJECT SITE. FURNITURE MAY BE REPURPOSED FOR THE ORIGINAL USE ON THE SAME PROJECT SITE.

GENERAL: SUBMIT ADDITIONAL LEED SUBMITTALS REQUIRED BY OTHER SPECIFICATION SECTIONS. LEED DOCUMENTATION SUBMITTALS:

> CREDIT MR 2: COMPLY WITH SECTION 017419 "CONSTRUCTION WASTE MANAGEMENT AND DISPOSAL."

CREDIT MR 3: RECEIPTS FOR SALVAGED AND REFURBISHED MATERIALS USED FOR PROJECT, INDICATING SOURCES AND COSTS FOR SALVAGED AND REFURBISHED MATERIALS.

CREDIT MR 4: PRODUCT DATA AND CERTIFICATION LETTER FROM PRODUCT MANUFACTURERS INDICATING PERCENTAGES BY WEIGHT OF POST-CONSUMER AND PRE-CONSUMER RECYCLED CONTENT FOR PRODUCTS HAVING RECYCLED CONTENT. INCLUDE STATEMENT INDICATING MATERIAL COSTS FOR EACH PRODUCT HAVING RECYCLED CONTENT

CREDIT MR 5: PRODUCT DATA INDICATING LOCATION OF MATERIAL MANUFACTURER FOR REGIONALLY MANUFACTURED MATERIALS. INCLUDE STATEMENT INDICATING COST FOR EACH REGIONALLY MANUFACTURED MATERIAL AND FOR EACH IONALLY EXTRACTED AND MANUFACTURED MATERIAL. a. INCLUDE STATEMENT INDICATING DISTANCE FROM

MANUFACTURER TO PROJECT FOR EACH REGIONALLY MANUFACTURED MATERIAL. INCLUDE STATEMENT INDICATING LOCATION OF AND DISTANCE FROM PROJECT TO POINT OF EXTRACTION, HARVEST, OR RECOVERY FOR EACH RAW MATERIAL USED IN REGIONALLY EXTRACTED AND MANUFACTURED

MATERIALS CREDIT MR 7: PRODUCT DATA AND CHAIN-OF-CUSTODY CERTIFICATES FOR PRODUCTS CONTAINING CERTIFIED WOOD. INCLUDE STATEMENT INDICATING COST FOR EACH CERTIFIED

WOOD PRODUCT. CREDIT IEQ 3.1: CONSTRUCTION INDOOR-AIR-QUALITY MANAGEMENT PLAN. PRODUCT DATA FOR TEMPORARY FILTRATION MEDIA.

OCCUPANCY. CONSTRUCTION DOCUMENTATION: SIX PHOTOGRAPHS AT THREE DIFFERENT TIMES DURING THE CONSTRUCTION PERIOD, ALONG WITH A BRIEF DESCRIPTION OF THE SMACNA APPROACH EMPLOYED, DOCUMENTING IMPLEMENTATION OF THE INDOOR-AIR-QUALITY MANAGEMENT MEASURES, SUCH AS PROTECTION OF

PRODUCT DATA FOR FILTRATION MEDIA USED DURING

DUCTS AND ON-SITE STORED OR INSTALLED ABSORPTIVE

MATERIALS. CREDIT IEQ 3.2: SIGNED STATEMENT DESCRIBING THE BUILDING AIR FLUSH-OUT PROCEDURES INCLUDING THE DATES WHEN FLUSH-OUT WAS BEGUN AND COMPLETED AND STATEMENT THAT FILTRATION MEDIA WAS REPLACED AFTER FLUSH-OUT. PRODUCT DATA FOR FILTRATION MEDIA USED DURING

FLUSH-OUT AND DURING OCCUPANCY. CREDIT IEQ 4A: PRODUCT DATA FOR ADHESIVES AND SEALANTS USED INSIDE THE WEATHERPROOFING SYSTEM INDICATING VOC

CONTENT OF EACH PRODUCT USED. CREDIT IEQ 4B: PRODUCT DATA FOR PAINTS AND COATINGS USED INSIDE THE WEATHERPROOFING SYSTEM INDICATING VOC CONTENT OF EACH PRODUCT USED.

CREDIT IEQ 4D: PRODUCT DATA FOR PRODUCTS CONTAINING COMPOSITE WOOD OR AGRIFIBER PRODUCTS OR WOOD GLUES INDICATING THAT THEY DO NOT CONTAIN UREA-FORMALDEHYDE 1.4 INFORMATIONAL SUBMITTALS

LEED ACTION PLANS: PROVIDE PRELIMINARY SUBMITTALS WITHIN SEVEN DAYS OF DATE ESTABLISHED FOR COMMENCEMENT OF THE WORK INDICATING HOW THE FOLLOWING REQUIREMENTS WILL BE MET: CREDIT MR 2: WASTE MANAGEMENT PLAN COMPLYING WITH SECTION 017419 "CONSTRUCTION WASTE MANAGEMENT AND DISPOSAL."

CREDIT IEQ 3.1: CONSTRUCTION INDOOR-AIR-QUALITY MANAGEMENT PLAN.

LEED PROGRESS REPORTS: CONCURRENT WITH EACH APPLICATION FOR PAYMENT, SUBMIT REPORTS COMPARING ACTUAL CONSTRUCTION AND PURCHASING ACTIVITIES WITH LEED ACTION PLANS FOR THE FOLLOWING: CREDIT MR 2: WASTE REDUCTION PROGRESS REPORTS COMPLYING WITH SECTION 017419 "CONSTRUCTION WASTE MANAGEMENT AND

END OF SECTION 018100

#### **GENERAL CONDITIONS (CONTINUED)**

#### **SECTION 019113 - GENERAL COMMISSIONING REQUIREMENTS**

1.1 SUMMARY

COMMISSIONING TEAM: MEMBERS REPRESENTING CONTRACTOR, INCLUDING PROJECT SUPERINTENDENT AND SUBCONTRACTORS, INSTALLERS, SUPPLIERS,

MEMBERS REPRESENTING OWNER, INCLUDING COMMISSIONING AGENT (CXA), FACILITY USER AND OPERATION AND MAINTENANCE PERSONNEL, AND ARCHITECT AND ENGINEERING DESIGN PROFESSIONALS.

CONTRACTOR'S RESPONSIBILITIES: CONTRACTOR SHALL ASSIGN REPRESENTATIVES WITH EXPERTISE AND AUTHORITY TO ACT ON ITS BEHALF AND SHALL SCHEDULE THEM TO PARTICIPATE IN AND PERFORM COMMISSIONING PROCESS ACTIVITIES INCLUDING, BUT NOT LIMITED TO, THE FOLLOWING:

INTEGRATE AND COORDINATE COMMISSIONING PROCESS ACTIVITIES WITH CONSTRUCTION SCHEDULE.

REVIEW AND ACCEPT COMMISSIONING CHECKLISTS AND PROCESS TEST PROCEDURES PROVIDED BY THE COMMISSIONING AGENT (CXA). SUPPORT COMMISSIONING INSTALLATION REVIEW AND PROCESS TEST PROCEDURES. **EVALUATE INSTALLATION AND PERFORMANCE DEFICIENCIES** 

IDENTIFIED IN REPORTS AND, IN COLLABORATION WITH ENTITY RESPONSIBLE FOR SYSTEM AND EQUIPMENT INSTALLATION. RECOMMEND CORRECTIVE ACTION.

COOPERATE WITH THE COMMISSIONING TEAM FOR RESOLUTION OF ISSUES RECORDED IN THE ISSUES LOG.

COMMISSIONING AGENT'S (CXA'S) RESPONSIBILITIES: ORGANIZE AND LEAD COMMISSIONING TEAM.

PROVIDE AND MANAGE COMMISSIONING PLAN. PROVIDE PROJECT-SPECIFIC CHECKLISTS AND TEST PROCEDURES. WITNESS. PREPARE AND MAINTAIN COMPLETED INSTALLATION VERIFICATION CHECKLISTS.

WITNESS SYSTEMS, ASSEMBLIES, EQUIPMENT, AND COMPONENT STARTUP

WITNESS, PREPARE, AND MAINTAIN COMPLETED FUNCTIONAL

TESTING CHECKLISTS. PREPARE AND MAINTAIN THE ISSUES LOG.

COMPILE COMMISSIONING DOCUMENTS, RESULTS, AND DEFICIENCIES; INCLUDE THEM IN THE SYSTEMS MANUAL AND COMMISSIONING SUMMARY REPORT

REVIEW COMMISSIONING REPORT WITH COMMISSIONING TEAM AND IMPLEMENT PLAN TO RESOLVE DEFICIENCIES.

**END OF SECTION 019113** 

#### **EXISTING CONDITIONS**

#### **SECTION 024119 - SELECTIVE DEMOLITION**

SUMMARY DEMOLITION AND REMOVAL OF **SELECTED SITE ELEMENTS**. HISTORIC ITEMS REMOVED AND SALVAGED FOR OWNER.

SUBMITTALS 1.2 SCHEDULE OF SELECTIVE DEMOLITION ACTIVITIES: INDICATE THE FOLLOWING:

DETAILED SEQUENCE OF SELECTIVE DEMOLITION AND REMOVAL WORK, WITH STARTING AND ENDING DATES FOR EACH ACTIVITY. ENSURE OWNER'S **BUILDING MANAGER'S AND OTHER TENANTS'** ON-SITE OPERATIONS ARE UNINTERRUPTED. INTERRUPTION OF UTILITY SERVICES. INDICATE HOW LONG UTILITY

SERVICES WILL BE INTERRUPTED. COORDINATION FOR SHUTOFF, CAPPING, AND CONTINUATION OF UTILITY SERVICES.

USE OF ELEVATOR AND STAIRS. COORDINATION OF OWNER'S CONTINUING OCCUPANCY OF PORTIONS OF EXISTING BUILDING AND OF OWNER'S PARTIAL OCCUPANCY OF COMPLETED WORK

PROJECT CONDITIONS OWNER WILL OCCUPY PORTIONS OF BUILDING IMMEDIATELY

ADJACENT TO SELECTIVE DEMOLITION AREA. HAZARDOUS MATERIALS: UNKNOWN WHETHER HAZARDOUS MATERIALS WILL BE ENCOUNTERED. IF ENCOUNTERED, OWNER WILL REMOVE HAZARDOUS MATERIALS UNDER A SEPARATE CONTRACT.

EXISTING WARRANTIES: TO BE CONFIRMED BY STARBUCKS CONSTRUCTION

MANAGER.

1.5 UTILITY SERVICES AND MECHANICAL/ELECTRICAL SYSTEMS: MAINTAINED TO OCCUPIED FACILITIES.

SHUT OFF: BY **OWNER/BUILDING MANAGER**. SITE ACCESS AND TEMPORARY CONTROLS: MINIMUM INTERFERENCE WITH ROADS, STREETS, WALKS, WALKWAYS, AND OTHER ADJACENT OCCUPIED

AND USED FACILITIES TEMPORARY FACILITIES: PROVIDE TEMPORARY BARRICADES AND OTHER PROTECTION REQUIRED TO PREVENT INJURY TO PEOPLE AND DAMAGE TO ADJACENT BUILDINGS AND FACILITIES TO REMAIN.

TEMPORARY SHORING: PROVIDE AND MAINTAIN SHORING, BRACING, AND STRUCTURAL SUPPORTS AS REQUIRED TO PRESERVE STABILITY AND PREVENT MOVEMENT, SETTLEMENT, OR COLLAPSE OF CONSTRUCTION AND FINISHES TO REMAIN, AND TO PREVENT UNEXPECTED OR UNCONTROLLED

MOVEMENT OR COLLAPSE OF CONSTRUCTION BEING DEMOLISHED. REMOVED AND SALVAGED ITEMS: CLEANED, CRATED, STORED, AND TRANSPORTED TO OWNER'S **ON/OFF**-SITE STORAGE AREA. REMOVED AND REINSTALLED ITEMS: CLEANED, REPAIRED, CRATED,

STORED, AND REINSTALLED. EXISTING ITEMS TO REMAIN: EXISTING CONSTRUCTION PROTECTED AGAINST DAMAGE.

DISPOSAL OF DEMOLISHED ITEMS: BURNING: NOT PERMITTED.

DISPOSAL: COMPLY WITH REQUIREMENTS SECTION 017419 "CONSTRUCTION WASTE MANAGEMENT AND DISPOSAL".

**END OF SECTION 024119** 



#### STARBUCKS COFFEE **COMPANY** 2401 UTAH AVENUE SOUTH SEATTLE, WASHINGTON 98134


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ARCHITECT OF RECORD







**Revision Schedule** Rev Date Bv Description

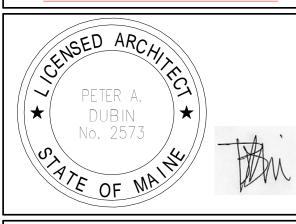H R Ш CIAL PROJECT ADDRES: 145 COMMEF PORTLAND, I CUMBERLAN

STORE #: 19384 PROJECT #: 58862-001 MCS CONCEPT: PALETTE: HERITAGE ISSUE DATE: JAN. 11, 2013 DESIGN MANAGER: E. ZAKAMAREK LEED<sup>(R)</sup> AP: PRODUCTION DESIGNER: NORR ILLINOIS CHECKED BY:

SHEET TITLE:

DESIGN **SPECIFICATIONS** 

SCALE: SHEET NUMBER:

#### **METALS SECTION 055000 - METAL FABRICATIONS** 1.1 SUMMARY STEEL FRAMING AND SUPPORTS FOR MECHANICAL AND ELECTRICAL STEEL FRAMING AND SUPPORTS FOR APPLICATIONS WHERE FRAMING AND SUPPORTS ARE NOT SPECIFIED IN OTHER SECTIONS. SHELF ANGLES. METAL BOLLARDS. 1.2 SUBMITTALS PRODUCT DATA: FOR THE FOLLOWING: PAINT PRODUCTS. ALL PREFABRICATED PRODUCTS. SHOP DRAWINGS: SHOW FABRICATION AND INSTALLATION DETAILS FOR METAL FABRICATIONS. INCLUDE PLANS, ELEVATIONS, SECTIONS, AND DETAILS OF METAL FABRICATIONS AND THEIR CONNECTIONS. SHOW ANCHORAGE AND ACCESSORY ITEMS PROVIDE TEMPLATES FOR ANCHORS AND BOLTS SPECIFIED FOR INSTALLATION UNDER OTHER SECTIONS. WELDING CERTIFICATES. 1.3 PRODUCTS MATERIALS: STEEL PLATES, SHAPES, AND BARS, STEEL PIPE, SLOTTED CHANNEL FRAMING. LOW-EMITTING PRIMER: METAL PRIMER SHALL HAVE A VOC CONTENT OF 200 G/L OR LESS WHEN CALCULATED ACCORDING TO 40 CFR 59. SUBPART D (EPA METHOD 24). MISCELLANEOUS FRAMING AND SUPPORTS: STEEL FRAMING AND SUPPORTS FOR MECHANICAL AND ELECTRICAL EQUIPMENT, APPLICATIONS WHERE FRAMING AND SUPPORTS ARE NOT SPECIFIED IN OTHER SECTIONS. GALVANIZE WHERE INDICATED. PRIME WITH ZINC-RICH PRIMER WHERE INDICATED. ZINC-RICH PRIMER SHALL HAVE A VOC CONTENT OF 340 G/L OR LESS WHEN CALCULATED ACCORDING TO 40 CFR 59, SUBPART D (EPA METHOD 24). LOOSE STEEL LINTELS, GALVANIZED AT EXTÉRIOR WALLS. SHELF ANGLES, GALVANIZED. STEEL WELD PLATES AND ANGLES NOT SPECIFIED IN OTHER SECTIONS, FOR CASTING INTO CONCRETE. METAL BOLLARDS: SCHEDULE 40 STEEL PIPE. **END OF SECTION 055000**

#### WOOD AND PLASTICS

1.2 INSTALLATION

**END OF SECTION 061053** 

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SECTION 061053 - MISCELLANEOUS ROUGH CARPENTRY
1.1 MATERIALS
           WOOD PRODUCTS, GENERAL:
                   MAXIMUM MOISTURE CONTENT OF LUMBER: 15 PERCENT.
             WOOD-PRESERVATIVE-TREATED MATERIALS:
                   PRESERVATIVE TREATMENT: AWPA U1; USE CATEGORY UC2.
                         PRESERVATIVE CHEMICALS: CONTAINING NO ARSENIC OR
                          CHROMIUM. DO NOT USE INORGANIC BORON (SBX) FOR SILL
                          PLATES.
                  APPLICATION: ITEMS INDICATED AND THE FOLLOWING:
                          ITEMS IN CONTACT WITH ROOFING OR WATERPROOFING.
                          ITEMS IN CONTACT WITH CONCRETE OR MASONRY.
                          FRAMING LESS THAN 18 INCHES (460 MM) ABOVE GROUND IN
                          CRAWLSPACES.
                         FLOOR PLATES INSTALLED OVER CONCRETE SLABS-ON-GRADE.
             FIRE-RETARDANT-TREATED MATERIALS:
                   EXTERIOR TYPE FOR EXTERIOR LOCATIONS AND WHERE INDICATED.
                    INTERIOR TYPE A UNLESS OTHERWISE INDICATED.
                    APPLICATION: ITEMS INDICATED AND THE FOLLOWING:
                          FRAMING FOR RAISED PLATFORMS.
                          CONCEALED BLOCKING.
                          ROOF FRAMING AND BLOCKING.
                         ITEMS IN CONTACT WITH ROOFING.
                          PLYWOOD BACKING PANELS.
             FRAMING:
                   NON-LOAD-BEARING INTERIOR PARTITIONS: CONSTRUCTION OR NO. 2
                   GRADE
             MISCELLANEOUS LUMBER:
                   DIMENSION LUMBER: CONSTRUCTION OR NO. 2 GRADE.
                    UTILITY SHELVING: 19 PERCENT MAXIMUM MOISTURE CONTENT.
                   CONCEALED BOARDS: 19 PERCENT MAXIMUM MOISTURE CONTENT.
             PLYWOOD BACKING PANELS: EXPOSURE 1, C-D PLUGGED, FIRE-RETARDANT
            FASTENERS: HOT-DIP GALVANIZED STEEL WHERE EXPOSED TO WEATHER, IN
             GROUND CONTACT. IN CONTACT WITH TREATED WOOD, OR IN AREA OF HIGH
             RELATIVE HUMIDITY.
             METAL FRAMING ANCHORS
                   METAL: GALVANIZED STEEL; HOT-DIP HEAVY GALVANIZED STEEL FOR
                    WOOD-PRESERVATIVE-TREATED LUMBER AND WHERE INDICATED.
```

ADHESIVES: ADHESIVES SHALL HAVE A VOC CONTENT OF 70 G/L OR LESS

FURRING TO RECEIVE PLYWOOD OR HARDBOARD PANELING: 1-BY-3-INCH

NOMINAL-SIZE (19-BY-63-MM ACTUAL-SIZE) FURRING AT **24 INCHES** O.C.

MM ACTUAL-SIZE) FURRING AT 16 INCHES O.C.

WHEN CALCULATED ACCORDING TO 40 CFR 59, SUBPART D (EPA METHOD 24).

FURRING TO RECEIVE GYPSUM BOARD: 1-BY-2-INCH NOMINAL-SIZE (19-BY-38-

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WOOD AND PLASTICS (CONTINUED)
SECTION 064000 - INTERIOR ARCHITECTURAL WOODWORK
1.1 SUMMARY
            INTERIOR STANDING AND RUNNING TRIM.
             FLUSH WOOD PANELING AND WAINSCOTS.
             MELAMINE CABINETS.
             SOLID-SURFACING-MATERIAL COUNTERTOPS.
            CLOSET AND UTILITY SHELVING.
1.2 QUALITY ASSURANCE
            QUALITY STANDARD: AWI.
     MATERIALS
            WOOD PRODUCTS: COMPLY WITH THE FOLLOWING:
                   HARDBOARD: AHA A135.4, MADE WITH BINDER CONTAINING NO
                    UREA FORMALDEHYDE.
                   MEDIUM-DENSITY FIBERBOARD: ANSI A208.2, GRADE 130, MADE
                    WITH BINDER CONTAINING NO UREA FORMALDEHYDE.
                   MOISTURE RESISTANT MEDIUM-DENSITY FIBERBOARD:
                    ANSI A208.2, GRADE MD, MR50, MADE WITH BINDER CONTAINING
                    NO UREA FORMALDEHYDE.
                   STRAW-BASED PARTICLEBOARD: ANSI A208.1, GRADE M-2,
                    EXCEPT FOR DENSITY, MADE WITH ADHESIVE CONTAINING NO
                    UREA FORMALDEHYDE.
                   SOFTWOOD PLYWOOD: DOC PS 1
                   VENEER-FACED PANEL PRODUCTS (HARDWOOD PLYWOOD):
                    HPVA HP-1, MADE WITH ADHESIVE CONTAINING NO UREA
                   FORMALDEHYDE.
            ADHESIVES, GENERAL: DO NOT USE ADHESIVES THAT CONTAIN
             UREA FORMALDEHYDE.
             VOC LIMITS FOR INSTALLATION ADHESIVES AND GLUES: USE
             INSTALLATION ADHESIVES THAT COMPLY WITH THE FOLLOWING LIMITS
             FOR VOC CONTENT WHEN CALCULATED ACCORDING TO 40 CFR 59,
             SUBPART D (EPA METHOD 24):
                   WOOD GLUES: 30 G/L
                   PANEL ADHESIVE: 50 G/L
                   MULTIPURPOSE CONSTRUCTION ADHESIVE: 70 G/L
                  CONTACT ADHESIVE: 80 G/L.
                         SPECIAL PURPOSE: 250 G/L
            CLOSET AND UTILITY SHELVING:
                  GRADE: ECONOMY.
                   SHELF MATERIAL: 3/4 INCH (19 MM) THERMOSET DECORATIVE
                    PANEL WITH PVC OR POLYESTER ÉDGE BANDING.
                  CLEATS: 3/4 INCH (19 MM) PANEL PRODUCT.
            SHOP FINISHING
                   GRADE: SAME GRADE AS WOODWORK.
                  EXTENT: ALL WOODWORK SHOP FINISHED.
1.4 INSTALLATION
             SCRIBE AND CUT MILLWORK TO FIT ADJOINING WORK, REFINISH CUT
             SURFACES, AND REPAIR DAMAGED FINISH AT CUTS.
             ANCHOR MILLWORK TO ANCHORS OR BLOCKING BUILT IN OR DIRECTLY
             ATTACHED TO SUBSTRATES. SECURE WITH COUNTERSUNK,
             CONCEALED FASTENERS AND BLIND NAILING AS REQUIRED FOR
             COMPLETE INSTALLATION. USE FINE FINISHING NAILS OR FINISHING
             SCREWS FOR EXPOSED FASTENING. COUNTERSUNK AND FILLED FLUSH
             WITH MILLWORK AND MATCHING FINAL FINISH IF TRANSPARENT FINISH
             IS INDICATED.
            CABINETS: INSTALL WITHOUT DISTORTION SO DOORS AND DRAWERS FIT
             OPENINGS PROPERLY AND ARE ACCURATELY ALIGNED. ADJUST
             HARDWARE TO CENTER DOORS AND DRAWERS IN OPENINGS AND TO
             PROVIDE UNENCUMBERED OPERATION. COMPLETE INSTALLATION OF
             HARDWARE AND ACCESSORY ITEMS AS INDICATED.
                   INSTALL CABINETS WITH NO MORE THAN 1/8 INCH IN 96 INCH
                    (3 MM IN 2400 MM) SAG, BOW, OR OTHER VARIATION FROM A
                    STRAIGHT LINE.
            COUNTERTOPS: ANCHOR SECURELY BY SCREWING THROUGH CORNER
             BLOCKS OF BASE CABINETS OR OTHER SUPPORTS INTO UNDERSIDE OF
                  ALIGN ADJACENT SOLID-SURFACING-MATERIAL COUNTERTOPS
                    AND FORM SEAMS TO COMPLY WITH MANUFACTURER'S WRITTEN
                    RECOMMENDATIONS USING ADHESIVE IN COLOR TO MATCH
                   COUNTERTOP. CAREFULLY DRESS JOINTS SMOOTH, REMOVE
                   SURFACE SCRATCHES, AND CLEAN ENTIRE SURFACE.
                   INSTALL COUNTERTOPS WITH NO MORE THAN 1/8 INCH IN 96 INCH
                    3 MM IN 2400 MM) SAG, BOW, OR OTHER VARIATION FROM A
                    STRAIGHT LINE.
                   SECURE COVED BACKSPLASHES TO TOPS PER MANUFACTURES
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#### SPECIFIED IN DIVISION 7 SECTION "JOINT SEALANTS." **END OF SECTION 064000**

**SECTION 064400 - PLASTIC PANELING** PART 1 - GENERAL 1.1 SUMMARY

SECTION INCLUDES THE FOLLOWING: GLASS-FIBER REINFORCED PLASTIC (FRP) WALL PANELING. MOLDING, ADHESIVES, AND JOINT SEALANTS. 1.2 PLASTIC SHEET PANELING GLASS-FIBER-REINFORCED PLASTIC PANELING: GELCOAT-FINISHED, GLASS-FIBER REINFORCED PLASTIC PANELS COMPLYING WITH ASTM D 5319. LOW-EMITTING MATERIALS: PANELING SHALL COMPLY WITH THE TESTING AND PRODUCT REQUIREMENTS OF THE CALIFORNIA DEPARTMENT OF HEALTH SERVICES' "STANDARD PRACTICE FOR THE FESTING OF VOLATILE ORGANIC EMISSIONS FROM VARIOUS SOURCES USING SMALL-SCALE ENVIRONMENTAL CHAMBERS." NOMINAL THICKNESS: NOT LESS THAN 0.09 INCHES. COLOR: WHITE.

FABRICATION MANUAL AND TO WALLS WITH ADHESIVE.

CALK SPACE BETWEEN BACKSPLASH AND WALL WITH SEALANT

MOLDING COLOR: WHITE. SURFACE FINISH: MOLDED PEBBLE TEXTURE. UNREINFORCED POLYPROPYLENE PANELING: SOLID POLYPROPYLENE

PANELS MADE FROM NO LESS THAN 80 PERCENT RECYCLED MATERIAL. LOW-EMITTING MATERIALS: PANELING SHALL COMPLY WITH THE TESTING AND PRODUCT REQUIREMENTS OF THE CALIFORNIA DEPARTMENT OF PUBLIC HEALTH'S (FORMERLY, THE CALIFORNIA DEPARTMENT OF HEALTH SERVICES') "STANDARD METHOD FOR THE TESTING AND EVALUATION OF VOLATILE ORGANIC CHEMICAL EMISSIONS FROM INDOOR SOURCES USING ENVIRONMENTAL CHAMBERS. NOMINAL THICKNESS: NOT LESS THAN 0.09 INCHES.

COLOR: WHITE.

MOLDING COLOR: WHITE. SURFACE FINISH: MOLDED PEBBLE TEXTURE. ADHESIVES

AS RECOMMENDED BY PLASTIC PANELING MANUFACTURER.

VOC LIMIT: 50 G/L ACCESSORIES

TRIM ACCESSORIES: MANUFACTURER'S STANDARD ONE-PIECE VINYL EXTRUSIONS DESIGNED TO RETAIN AND COVER EDGES OF PANELS. PROVIDE DIVISION BARS, INSIDE CORNERS, OUTSIDE CORNERS, AND CAPS AS NEEDED TO CONCEAL EDGES.

1. COLOR: WHITE. **END OF SECTION 064400** 

<b>SECT</b> 1.1		1 - THROUGH-PENETRATION FIRESTOP SYSTEMS ITTALS
1.1	A.	PRODUCT DATA: FOR EACH TYPE OF PRODUCT INDICATED.
1.2		TY ASSURANCE
	A.	INSTALLER QUALIFICATIONS: AN FM GLOBAL-APPROVED FIRESTOP CONTRACTOR OR A UL-QUALIFIED FIRESTOP CONTRACTOR.
	B.	FIRE-TEST-RESPONSE CHARACTERISTICS: TESTED PER ASTM E 814 BY QUALIFIED TESTING AND INSPECTING AGENCY.
1.3	PENET	TRATION FIRESTOPPING
	A.	PENETRATIONS IN FIRE-RESISTANCE-RATED WALLS: F-RATINGS PER ASTM E 814 OR UL 1479.
	B.	PENETRATIONS IN HORIZONTAL ASSEMBLIES: F- AND T-RATINGS PER ASTM E 814 OR UL 1479:
	C.	PENETRATIONS IN SMOKE BARRIERS: L-RATINGS PER UL 1479.
	D.	W-RATINGS: PER UL 1479.
	E.	VOC CONTENT OF INTERIOR SEALANTS: PROVIDE INTERIOR SEALANTS AND SEALANT PRIMERS THAT COMPLY WITH THE FOLLOWING LIMITS FOR VOC CONTENT WHEN CALCULATED ACCORDING TO 40 CFR 59, SUBPART D (EPA METHOD 24):
		1. SEALANTS: 250 G/L.
		<ol> <li>SEALANT PRIMERS FOR NONPOROUS SUBSTRATES: 250 G/L.</li> <li>SEALANT PRIMERS FOR POROUS SUBSTRATES: 775 G/L.</li> </ol>
1.4	INSTAI	LLATION
	A.	IDENTIFICATION: PREPRINTED METAL OR PLASTIC LABELS, PERMANENTLY ATTACHED.
1.5		QUALITY CONTROL
	A.	INSPECTION OF INSTALLED FIRESTOP SYSTEMS: BY OWNER-ENGAGED AGENCY ACCORDING TO ASTM E 2174 REQUIREMENTS.
END (	OF SECTION	ON 07841
SECT	ION 07844 SUMM	46 - FIRE-RESISTIVE JOINT SYSTEMS
1.1	A.	FIRE-RESISTIVE JOINT SYSTEMS FOR THE FOLLOWING:
	σ.	
	7	1. JOINTS IN OR BETWEEN FIRE-RESISTANCE-RATED CONSTRUCTIONS
		<ol> <li>JOINTS IN OR BETWEEN FIRE-RESISTANCE-RATED CONSTRUCTIONS</li> <li>JOINTS AT EXTERIOR CURTAIN-WALL/FLOOR INTERSECTIONS.</li> </ol>
1.2		1. JOINTS IN OR BETWEEN FIRE-RESISTANCE-RATED CONSTRUCTIONS
1.2		<ol> <li>JOINTS IN OR BETWEEN FIRE-RESISTANCE-RATED CONSTRUCTIONS</li> <li>JOINTS AT EXTERIOR CURTAIN-WALL/FLOOR INTERSECTIONS.</li> <li>JOINTS IN SMOKE BARRIERS.</li> </ol>
1.2	PERFO	1. JOINTS IN OR BETWEEN FIRE-RESISTANCE-RATED CONSTRUCTIONS 2. JOINTS AT EXTERIOR CURTAIN-WALL/FLOOR INTERSECTIONS. 3. JOINTS IN SMOKE BARRIERS.  DRMANCE REQUIREMENTS FIRE-RESISTANCE RATINGS OF JOINT SYSTEMS IN AND BETWEEN FIRE-RESISTANCE-RATED CONSTRUCTIONS: EQUALING OR EXCEEDING THE FIRE-RESISTANCE RATINGS OF CONSTRUCTION THAT THEY JOIN, AND WITH
	PERFO A.	1. JOINTS IN OR BETWEEN FIRE-RESISTANCE-RATED CONSTRUCTIONS 2. JOINTS AT EXTERIOR CURTAIN-WALL/FLOOR INTERSECTIONS. 3. JOINTS IN SMOKE BARRIERS.  DRMANCE REQUIREMENTS FIRE-RESISTANCE RATINGS OF JOINT SYSTEMS IN AND BETWEEN FIRE-RESISTANCE-RATED CONSTRUCTIONS: EQUALING OR EXCEEDING THE FIRE-RESISTANCE RATINGS OF CONSTRUCTION THAT THEY JOIN, AND WITH MOVEMENT CAPABILITIES INDICATED AS DETERMINED BY UL 2079.
1.2 1.3	PERFO A. SUBMI	1. JOINTS IN OR BETWEEN FIRE-RESISTANCE-RATED CONSTRUCTIONS 2. JOINTS AT EXTERIOR CURTAIN-WALL/FLOOR INTERSECTIONS. 3. JOINTS IN SMOKE BARRIERS.  DRMANCE REQUIREMENTS FIRE-RESISTANCE RATINGS OF JOINT SYSTEMS IN AND BETWEEN FIRE-RESISTANCE-RATED CONSTRUCTIONS: EQUALING OR EXCEEDING THE FIRE-RESISTANCE RATINGS OF CONSTRUCTION THAT THEY JOIN, AND WITH MOVEMENT CAPABILITIES INDICATED AS DETERMINED BY UL 2079.  ITTALS
1.3	PERFO A. SUBMI A.	1. JOINTS IN OR BETWEEN FIRE-RESISTANCE-RATED CONSTRUCTIONS 2. JOINTS AT EXTERIOR CURTAIN-WALL/FLOOR INTERSECTIONS. 3. JOINTS IN SMOKE BARRIERS.  DRMANCE REQUIREMENTS FIRE-RESISTANCE RATINGS OF JOINT SYSTEMS IN AND BETWEEN FIRE-RESISTANCE-RATED CONSTRUCTIONS: EQUALING OR EXCEEDING THE FIRE-RESISTANCE RATINGS OF CONSTRUCTION THAT THEY JOIN, AND WITH MOVEMENT CAPABILITIES INDICATED AS DETERMINED BY UL 2079.  ITTALS PRODUCT DATA: FOR EACH TYPE OF PRODUCT INDICATED.
	PERFO A. SUBMI A.	1. JOINTS IN OR BETWEEN FIRE-RESISTANCE-RATED CONSTRUCTIONS 2. JOINTS AT EXTERIOR CURTAIN-WALL/FLOOR INTERSECTIONS. 3. JOINTS IN SMOKE BARRIERS.  DRMANCE REQUIREMENTS FIRE-RESISTANCE RATINGS OF JOINT SYSTEMS IN AND BETWEEN FIRE-RESISTANCE-RATED CONSTRUCTIONS: EQUALING OR EXCEEDING THE FIRE-RESISTANCE RATINGS OF CONSTRUCTION THAT THEY JOIN, AND WITH MOVEMENT CAPABILITIES INDICATED AS DETERMINED BY UL 2079.  ITTALS PRODUCT DATA: FOR EACH TYPE OF PRODUCT INDICATED.  TY ASSURANCE FIRE-TEST-RESPONSE CHARACTERISTICS: TESTED BY QUALIFIED TESTING
1.3	PERFO A. SUBMI A. QUALI' A.	1. JOINTS IN OR BETWEEN FIRE-RESISTANCE-RATED CONSTRUCTIONS 2. JOINTS AT EXTERIOR CURTAIN-WALL/FLOOR INTERSECTIONS. 3. JOINTS IN SMOKE BARRIERS.  DRMANCE REQUIREMENTS FIRE-RESISTANCE RATINGS OF JOINT SYSTEMS IN AND BETWEEN FIRE-RESISTANCE-RATED CONSTRUCTIONS: EQUALING OR EXCEEDING THE FIRE-RESISTANCE RATINGS OF CONSTRUCTION THAT THEY JOIN, AND WITH MOVEMENT CAPABILITIES INDICATED AS DETERMINED BY UL 2079.  ITTALS PRODUCT DATA: FOR EACH TYPE OF PRODUCT INDICATED.  TY ASSURANCE

#### RESPECTIVELY, AS DETERMINED PER ASTM E 84. VOC CONTENT: FIRE-RESISTIVE JOINT SYSTEM SEALANTS SHALL COMPLY WITH THE FOLLOWING LIMITS FOR VOC CONTENT WHEN CALCULATED ACCORDING TO 40 CFR 59, SUBPART D (EPA METHOD 24):

JOINTS IN SMOKE BARRIERS:

**END OF SECTION 078446** 

**TEMPERATURES** 

ARCHITECTURAL SEALANTS: 250 G/L. SEALANT PRIMERS FOR NONPOROUS SUBSTRATES: 250 G/L. SEALANT PRIMERS FOR POROUS SUBSTRATES: 775 G/L. ACCESSORIES: FORMING MATERIALS AND OTHER COMPONENTS NEEDED

TO INSTALL FILL MATERIALS AND MAINTAIN RATINGS REQUIRED.

DESIGNATION SYSTEM FOR JOINTS IN OR BETWEEN FIRE-RESISTANCE-RATED

JOINTS IN OR BETWEEN FIRE-RESISTANCE-RATED CONSTRUCTION: EQUAL TO

OR EXCEEDING THE FIRE-RESISTANCE RATING OF CONSTRUCTION THEY WILL

L-RATING: NOT EXCEEDING 5.0 CFM/FT (0.00775 CU. M/S X M) OF JOINT

JOINTS AT EXTERIOR CURTAIN-WALL/FLOOR INTERSECTIONS: EQUAL TO OR

AT 0.30 INCH WG (74.7 PA) AT BOTH AMBIENT AND ELEVATED

FLAME-SPREAD AND SMOKE-DEVELOPED INDEXES OF LESS THAN 25 AND 450.

EXCEEDING THE FIRE-RESISTANCE RATING OF THE FLOOR ASSEMBLY.

EXPOSED FIRE-RESISTIVE JOINT SYSTEMS: PROVIDE PRODUCTS WITH

CONSTRUCTIONS: ALPHANUMERIC SYSTEMS LISTED IN UL'S "FIRE

RESISTANCE DIRECTORY" UNDER PRODUCT CATEGORY XHBN.

#### THERMAL AND MOISTURE PROTECTION (CONT)

SECTION 079200 - JOINT SEALANTS

1.1 MATERIALS VOC CONTENT OF INTERIOR SEALANTS: PROVIDE INTERIOR SEALANTS AND SEALANT PRIMERS THAT COMPLY WITH THE FOLLOWING LIMITS FOR VOC CONTENT WHEN CALCULATED ACCORDING TO 40 CFR 59, SUBPART D (EPA METHOD 24): SEALANTS: 250 G/L

SEALANT PRIMERS FOR NONPOROUS SUBSTRATES: 250 G/L. SEALANT PRIMERS FOR POROUS SUBSTRATES: 775 G/L. SUITABILITY FOR CONTACT WITH FOOD: WHERE SEALANTS ARE INDICATED FOR JOINTS THAT WILL COME IN REPEATED CONTACT WITH FOOD, PROVIDE PRODUCTS THAT COMPLY WITH 21 CFR 177.2600.

ELASTOMERIC JOINT SEALANTS: LIQUID APPLIED, CHEMICALLY CURING; ASTM C 920. MULTICOMPONENT NONSAG NEUTRAL-CURING SILICONE SEALANT

SINGLE-COMPONENT MILDEW-RESISTANT NEUTRAL-CURING

SINGLE-COMPONENT MILDEW-RESISTANT ACID-CURING SILICONE SEALANT ES-3. SINGLE-COMPONENT MILDEW-RESISTANT ACID-CURING RTV

SILICONE SEALANT ES-4. MULTICOMPONENT NONSAG POLYUREA SEALANT ES-5.

SILICONE SEALANT ES-2.

MULTICOMPONENT NONSAG POLYUREA FILLER ES-6. LATEX SEALANT LS-1: COMPLY WITH ASTM C 834, TYPE P, GRADE NF. JOINT-SEALANT BACKING:

1.2 JOINT-SEALANT SCHEDULE JOINT-SEALANT APPLICATION JS-1: EXTERIOR HORIZONTAL NONTRAFFIC AND TRAFFIC ISOLATION AND CONTRACTION JOINTS IN CAST-IN-PLACE

CONCRETE SLABS. JOINT SEALANT: ES-5. JOINT-SEALANT APPLICATION JS-2: EXTERIOR PERIMETER JOINTS BETWEEN WALL AND FRAMES OF DOORS AND WINDOWS.

JOINT SEALANT: ES-1. JOINT-SEALANT APPLICATION JS-3: EXTERIOR CONTROL AND EXPANSION JOINTS IN HORIZONTAL TRAFFIC SURFACES OF BRICK PAVERS, CERAMIC TILE. STONE PAVING UNITS. CONCRETE TILE.

JOINT SEALANT: MULTICOMPONENT POURABLE POLYSULFIDE JOINT-SEALANT COLOR: AS SELECTED BY ARCHITECT FROM

MANUFACTURER'S FULL RANGE. JOINT-SEALANT APPLICATION JS-4: INTERIOR PERIMETER JOINTS OF EXTERIOR OPENINGS.

JOINT SEALANT: ES-3. JOINT-SEALANT APPLICATION JS-5: INTERIOR CERAMIC TILE EXPANSION, CONTROL, CONTRACTION, AND ISOLATION JOINTS IN HORIZONTAL TRAFFIC SURFACES.

JOINT SEALANT: ES-3. JOINT-SEALANT COLOR: AS NOTED. JOINT-SEALANT APPLICATION JS-6: INTERIOR JOINTS BETWEEN PLUMBING FIXTURES AND ADJOINING WALLS, FLOORS, AND COUNTERS.

JOINT SEALANT: ES-3. JOINT-SEALANT COLOR: TRANSLUCENT. JOINT-SEALANT APPLICATION JS-7: VERTICAL JOINTS ON EXPOSED SURFACES OF INTERIOR PARTITIONS.

JOINT SEALANT: ES-3. JOINT-SEALANT APPLICATION JS-8: PERIMETER JOINTS BETWEEN INTERIOR WALL SURFACES AND FRAMES OF INTERIOR DOORS, WINDOWS.

JOINT SEALANT: ES-3. JOINT-SEALANT APPLICATION JS-9: HVAC JOINTS.

JOINT SEALANT: ES-2. JOINT-SEALANT COLOR: ALUMINUM. JOINT-SEALANT APPLICATION JS-10: NON-POROUS MATERIAL TO NON-POROUS MATERIAL. JOINT SEALANT: ES-4.

JOINT-SEALANT COLOR: CLEAR. **END OF SECTION 079200** 

#### **DOORS AND WINDOWS**

SECTION 081416 - FLUSH WOOD DOORS

1.1 SUBMITTALS PRODUCT DATA: FOR EACH TYPE OF DOOR INDICATED. INCLUDE DETAILS OF CORE AND EDGE CONSTRUCTION AND TRIM FOR OPENINGS. SHOP DRAWINGS: INDICATE LOCATION, SIZE, AND HAND OF EACH DOOR: ELEVATION OF EACH KIND OF DOOR; CONSTRUCTION DETAILS NOT COVERED IN PRODUCT DATA; LOCATION AND EXTENT OF HARDWARE

BLOCKING; AND OTHER PERTINENT DATA. INDICATE DIMENSIONS AND LOCATIONS OF MORTISES AND HOLES FOR HARDWARE. INDICATE DIMENSIONS AND LOCATIONS OF CUTOUTS.

INDICATE REQUIREMENTS FOR VENEER MATCHING. INDICATE DOORS TO BE FACTORY FINISHED AND FINISH REQUIREMENTS. INDICATE FIRE-PROTECTION RATINGS FOR FIRE-RATED DOORS.

WARRANTY: SAMPLE OF SPECIAL WARRANTY. 1.2 QUALITY ASSURANCE QUALITY STANDARD: AWI. AWI QUALITY CERTIFICATION LABELS OR AN AWI LETTER OF

LICENSING FOR DOORS. WI-CERTIFIED COMPLIANCE CERTIFICATE FOR DOORS AND INSTALLATION.

FIRE-RATED WOOD DOORS: POSITIVE PRESSURE TESTING. DOOR CONSTRUCTION, GENERAL LOW-EMITTING MATERIALS: MADE WITH ADHESIVES AND COMPOSITE WOOD PRODUCTS THAT DO HAVE NO ADDED UREA FORMALDEHYDE.

WDMA I.S.1-A PERFORMANCE GRADE: HEAVY DUTY UNLESS OTHERWISE VENEERED-FACED DOORS FOR TRANSPARENT FINISH **INTERIOR SOLID-CORE DOORS:** 

CORE: PARTICLEBOARD. CONSTRUCTION: FIVE OR SEVEN PLIES, BONDED. 1.5 PRIMING/FINISHING

SHOP PRIMING DOORS FOR OPAQUE FINISH: ONE COAT OF WOOD PRIMER. DOORS FOR TRANSPARENT FINISH: STAIN AND FIRST COAT OF

B. FACTORY FINISHING: ALL DOORS. **END OF SECTION 081416** 

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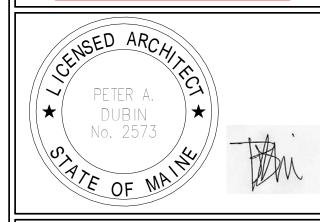
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	Revision Schedule					
Rev	Date	Ву	Description			

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SHEET TITLE:

SCALE:

DESIGN **SPECIFICATIONS** 

SHEET NUMBER:

1.2 SUBMITTALS PRODUCT DATA: FOR EACH TYPE OF PRODUCT INDICATED. INCLUDE CONSTRUCTION DETAILS, MATERIAL DESCRIPTIONS, CORE DESCRIPTIONS, FIRE-RESISTANCE RATING, TEMPERATURE-RISE RATINGS, AND FINISHES.

SHOP DRAWINGS: INCLUDE THE FOLLOWING:

ELEVATIONS OF EACH DOOR DESIGN. DETAILS OF DOORS, INCLUDING VERTICAL AND HORIZONTAL EDGE DETAILS AND METAL THICKNESSES.

FRAME DETAILS FOR EACH FRAME TYPE, INCLUDING DIMENSIONED PROFILES AND METAL THICKNESSES.

LOCATIONS OF REINFORCEMENT AND PREPARATIONS FOR

DETAILS OF ACCESSORIES.

DETAILS OF MOLDINGS, REMOVABLE STOPS, AND GLAZING. STANDARD DOUBLE ACTING SWING DOORS GENERAL: PROVIDE DOORS OF DESIGN INDICATED, NOT LESS THAN

THICKNESS INDICATED: FABRICATED WITH SMOOTH SURFACES. WITHOUT VISIBLE JOINTS OR SEAMS ON EXPOSED FACES UNLESS OTHERWISE INDICATED. COMPLY WITH ANSI/SDI A250.8. DESIGN: AS INDICATED.

CORE CONSTRUCTION: 3/4 INCH (19 MM) EXTERIOR GRADE SOLID WOOD CORE MADE WITH ADHESIVES AND COMPOSITE WOOD PRODUCTS THAT DO NOT CONTAIN UREA FORMALDEHYDE. VERTICAL EDGES FOR DOUBLE-ACTING DOORS: ROUND

VERTICAL EDGES WITH 2-1/8 INCH (54 MM) RADIUS. TOP AND BOTTOM EDGES: CLOSED WITH FLUSH OR INVERTED 0.042 INCH (1.0 MM) THICK, END CLOSURES OR CHANNELS OF SAME MATERIAL AS FACE SHEETS.

TOLERANCES: COMPLY WITH SDI 117. "MANUFACTURING TOLERANCES FOR STANDARD STEEL DOORS AND FRAMES." INTERIOR DOORS: FACE SHEETS FABRICATED FROM DECORATIVE HIGH PRESSURE LAMINATE. PROVIDE DOORS COMPLYING WITH REQUIREMENTS INDICATED BELOW BY REFERENCING ANSI/SDI A250.8 FOR LEVEL AND MODEL AND ANSI/SDI A250.4 FOR PHYSICAL

PERFORMANCE LEVEL: LEVEL 1 AND PHYSICAL PERFORMANCE LEVEL C (STANDARD DUTY). a. WIDTH: AS INDICATED ON DRAWINGS.

HARDWARE REINFORCEMENT: FABRICATE ACCORDING TO ANSI/SDI A250.6 WITH REINFORCING PLATES OF 18 GAUGE STAINLESS

FABRICATE CONCEALED STIFFENERS AND HARDWARE REINFORCEMENT FROM EITHER COLD- OR HOT-ROLLED STEEL SHEET.

STOPS AND MOLDINGS MOLDINGS FOR GLAZED LITES IN DOORS

MINIMUM 0.032 INCH (0.8 MM) THICK. LOOSE STOPS FOR GLAZED LITES IN FRAMES:

MINIMUM 0.032 INCH (0.8 MM) THICK, FABRICATED FROM SAME MATERIAL AS FRAMES IN WHICH THEY ARE INSTALLED.

1.5 STEEL FINISHES PRIME FINISH: APPLY MANUFACTURER'S STANDARD PRIMER IMMEDIATELY AFTER CLEANING AND PRETREATING.

SHOP PRIMER: MANUFACTURER'S STANDARD, FAST-CURING LEAD- AND CHROMATE-FREE PRIMER COMPLYING WITH ANSI/SDI A250.10 ACCEPTANCE CRITERIA; RECOMMENDED BY PRIMER MANUFACTURER FOR SUBSTRATE: COMPATIBLE WITH SUBSTRATE AND FIELD-APPLIED COATINGS DESPITE PROLONGED EXPOSURE.

FACTORY-APPLIED PAINT FINISH: MANUFACTURER'S STANDARD, COMPLYING WITH ANSI/SDI A250.3 FOR PERFORMANCE AND ACCEPTANCE CRITERIA.

1.6 COLOR AND GLOSS: AS INDICATED BY MANUFACTURER'S DESIGNATIONS. **END OF SECTION 08345** 

#### **FINISHES**

#### SECTION 09216 - NON-LOAD-BEARING STEEL FRAMING

NON-LOAD-BEARING STEEL FRAMING MEMBERS FOR INTERIOR FRAMING SYSTEMS. 1.2 MATERIALS

STEEL FRAMING FOR FRAMED ASSEMBLIES:

FRAMING MEMBERS, GENERAL: COMPLY WITH ASTM C 754 FOR CONDITIONS INDICATED. STEEL SHEET COMPONENTS: COMPLY WITH ASTM C 645 REQUIREMENTS FOR METAL. UNLESS OTHERWISE INDICATED.

PROTECTIVE COATING: COATING WITH EQUIVALENT CORROSION

RESISTANCE OF ASTM A 653/A 653M, G40 (Z120), HOT-DIP GALVANIZED, UNLESS OTHERWISE INDICATED. 1.3 STEEL FRAMING FOR FRAMED ASSEMBLIES SALVAGED MATERIAL: USE SALVAGED FRAMING MATERIALS WHENEVER

AVAILABLE. STEEL STUDS AND RUNNERS: ASTM C 645. MINIMUM BASE-METAL THICKNESS: 0.033 INCH (0.84 MM) UNLESS OTHERWISE INDICATED ON DRAWINGS.

DEPTH: AS INDICATED ON DRAWINGS. DIMPLED STEEL STUDS AND RUNNERS: MINIMUM BASE-METAL THICKNESS: 0.025 INCH (0.64 MM).

DEPTH: AS INDICATED ON DRAWINGS. SLIP-TYPE HEAD JOINTS: WHERE INDICATED, PROVIDE ONE OF THE FOLLOWING:

SINGLE LONG-LEG RUNNER SYSTEM: ASTM C 645 TOP RUNNER WITH 2 INCH (50.8 MM) DEEP FLANGES IN THICKNESS NOT LESS THAN INDICATED FOR STUDS, INSTALLED WITH STUDS FRICTION FIT INTO TOP RUNNER AND WITH CONTINUOUS BRIDGING LOCATED WITHIN 12 INCHES (305 MM) OF THE TOP OF STUDS TO PROVIDE

LATERAL BRACING. DOUBLE-RUNNER SYSTEM: ASTM C 645 TOP RUNNERS, INSIDE RUNNER WITH 2 INCH (50.8 MM) DEEP FLANGES IN THICKNESS NOT LESS THAN INDICATED FOR STUDS AND FASTENED TO STUDS, AND

OUTER RUNNER SIZED TO FRICTION FIT INSIDE RUNNER. DEFLECTION TRACK: STEEL SHEET TOP RUNNER MANUFACTURED TO PREVENT CRACKING OF FINISHES APPLIED TO INTERIOR PARTITION FRAMING RESULTING FROM DEFLECTION OF STRUCTURE ABOVE; IN THICKNESS NOT LESS THAN INDICATED FOR STUDS AND

IN WIDTH TO ACCOMMODATE DEPTH OF STUDS. COLD-ROLLED CHANNEL BRIDGING: 0.0538 INCH (1.37 MM) BARE-STEEL THICKNESS, WITH MINIMUM 1/2 INCH (12.7 MM) WIDE FLANGES.

DEPTH: 1-1/2 INCHES (38.1 MM). CLIP ANGLE: NOT LESS THAN 1-1/2 BY 1-1/2 INCHES (38.1 BY 38.1 MM), 0.068 INCH (1.73 MM) THICK, GALVANIZED STEEL.

HAT-SHAPED, RIGID FURRING CHANNELS: ASTM C 645. MINIMUM BASE METAL THICKNESS: AS INDICATED ON DRAWINGS. DEPTH: AS INDICATED ON DRAWINGS.

COLD-ROLLED FURRING CHANNELS: 0.0538 INCH (1.37 MM) BARE-STEEL THICKNESS, WITH MINIMUM 1/2 INCH (12.7 MM) WIDE FLANGES. DEPTH: AS INDICATED ON DRAWINGS. FURRING BRACKETS: ADJUSTABLE, CORRUGATED-EDGE TYPE OF

STEEL SHEET WITH MINIMUM BARE-STEEL THICKNESS OF 0.0312 INCH (0.79 MM).

TIE WIRE: ASTM A 641/A 641M, CLASS 1 ZINC COATING, SOFT TEMPER, 0.0625 INCH (1.59 MM) DIAMETER WIRE, OR DOUBLE

STRAND OF 0.0475 INCH (1.21 MM) DIAMETER WIRE. Z-SHAPED FURRING: WITH SLOTTED OR NONSLOTTED WEB, FACE FLANGE OF 1-1/4 INCHES (31.8 MM), WALL ATTACHMENT FLANGE OF 7/8 INCH (22.2 MM), MINIMUM BARE-METAL THICKNESS OF 0.0179 INCH (0.45 MM), AND DEPTH REQUIRED TO FIT INSULATION THICKNESS INDICATED.

LAMINATE FACES.

FINISHES (CONTINUED)

**SECTION 092900 - GYPSUM BOARD** 1.1 SUMMARY INTERIOR GYPSUM BOARD.

TILE BACKING PANELS. 1.2 SUBMITTALS PRODUCT DATA: FOR EACH TYPE OF PRODUCT INDICATED.

SAMPLES: FOR THE FOLLOWING PRODUCTS: TEXTURED FINISHES: MANUFACTURER'S STANDARD SIZE FOR EACH TEXTURED FINISH INDICATED AND ON SAME BACKING INDICATED

1.3 MATERIALS

INTERIOR GYPSUM BOARD: GENERAL: COMPLYING WITH ASTM C 36/C 36M OR ASTM C 1396/C 1396M, AS APPLICABLE TO TYPE OF GYPSUM BOARD INDICATED AND WHICHEVER IS MORE STRINGENT. MUST BE CERTIFIED AS LOW EMITTING. CERTIFICATION

> MUST BE BASED UPON THE CALIFORNIA DEPARTMENT OF HEALTH SERVICES' "STANDARD PRACTICE FOR THE TESTING OF VOLATILE ORGANIC EMISSIONS FROM VARIOUS SOURCES USING SMALL-SCALE ENVIRONMENTAL CHAMBERS", INCLUDING 2004 ADDENDA OR A JURISDICTIONALLY RECOGNIZED STANDARD USING

VALENT TESTING METHODOLOGIES AND VOC THRESHOLDS TYPE X: THICKNESS: 5/8 INCH (15.9 MM).

LONG EDGES: TAPERED. MOISTURE- AND MOLD-RESISTANT TYPE: WITH MOISTURE- AND MOLD-RESISTANT CORE AND SURFACES. CORE: 5/8 INCH (15.9 MM), TYPE X.

LONG EDGES: TAPERED. MOLD RESISTANCE: ASTM D 3273, SCORE OF 10 AS RATED ACCORDING TO ASTM D 3274.

TILE-BACKING PANELS:

GLASS-MAT, WATER-RESISTANT BACKING BOARD: ASTM C 1178/C 1178M, WITH MANUFACTURER'S STANDARD EDGES MUST BE CERTIFIED AS LOW EMITTING. CERTIFICATION MUST BE BASED UPON THE CALIFORNIA DEPARTMENT OF HEALTH SERVICES' "STANDARD PRACTICE FOR THE TESTING OF VOLATILE ORGANIC EMISSIONS FROM VARIOUS SOURCES USING SMALL-SCALE ENVIRONMENTAL CHAMBERS", INCLUDING 2004 ADDENDA OR A JURISDICTIONALLY RECOGNIZED STANDARD USING EQUIVALENT TESTING METHODOLOGIES AND VOC THRESHOLDS.

CORE: 5/8 INCH (15.9 MM), TYPE X. MOLD RESISTANCE: ASTM D 3273, SCORE OF 10 AS RATED

ACCORDING TO ASTM D 3274. CEMENTITIOUS BACKER UNITS: ANSI A118.9 AND ASTM C 1288 OR 1325, WITH MANUFACTURER'S STANDARD EDGES.

THICKNESS: 1/4 INCH. MOLD RESISTANCE: ASTM D 3273, SCORE OF 10 AS RATED ACCORDING TO ASTM D 3274.

TRIM ACCESSORIES: INTERIOR: CORNERBEAD. END OF SECTION 092900

#### **SECTION 093000 - CERAMIC TILE**

**END OF SECTION 093000** 

1.1 SUMMARY PAVER, GLAZED, AND WALL TILE.

WATERPROOF MEMBRANE FOR THIN-SET TILE INSTALLATIONS. METAL EDGE STRIPS INSTALLED AS PART OF TILE INSTALLATIONS. 1.2 QUALITY ASSURANCE

MOCKUPS FOR EACH FORM OF CONSTRUCTION. MATERIALS

MORTAR: LATEX-PORTLAND CEMENT

GLAZED WALL TILE TRIM SHAPES: COVED BASE, BULLNOSE CAP. THRESHOLDS: SATIN ANODIZED ALUMINUM THRESHOLDS AND TRANSITION

BEVEL EDGES AT 1:2 SLOPE, WITH LOWER EDGE OF BEVEL ALIGNED WITH OR UP TO 1/16 INCH (1.5 MM) ABOVE ADJACENT FLOOR SURFACE - FINISH BEVEL TO MATCH TOP SURFACE OF THRESHOLD LIMIT HEIGHT OF THRESHOLD TO 1/2 INCH (12.7 MM) OR LESS ABOVE ADJACENT FLOOR SURFACE.

ELASTOMERIC SEALANTS: ONE-PART, MILDEW-RESISTANT SILICONE. SEALANTS SHALL HAVE A VOC CONTENT OF 250 G/L OR LESS WHEN CALCULATED ACCORDING TO 40 CFR 59,

SUBPART D (EPA METHOD 24). 1.4 FLOOR TILE INSTALLATION SCHEDULE INTERIOR FLOORS ON CONCRETE: THIN-SET MORTAR.

TILE TYPE: UNGLAZED PAVER TILE. MORTAR: LATEX- PORTLAND CEMENT MORTAR BOND COAT

GROUT: POLYMER-MODIFIED UNSANDED 100% SOLIDS EPOXY NON-SAGGING GROUT. INTERIOR FLOORS ON WATERPROOF MEMBRANE

OVER CONCRETE AND WOOD: THIN-SET MORTAR. TILE TYPE: UNGLAZED PAVER TILE.

MORTAR: LATEX- PORTLAND CEMENT MORTAR BOND COAT. GROUT: POLYMER-MODIFIED UNSANDED 100% SOLIDS EPOXY NON-SAGGING GROUT.

1.5 WALL TILE INSTALLATION SCHEDULE INTERIOR WALLS OVER GLASS-MAT WATER-RESISTANT BACKER BOARD OR CEMENTITIOUS BACKER UNITS: THIN-SET MORTAR. TILE TYPE: **GLAZED WALL** TILE.

MORTAR: LATEX- PORTLAND CEMENT MORTAR. GROUT: POLYMER-MODIFIED UNSANDED GROUT.

#### FINISHES (CONTINUED)

**SECTION 095113 - ACOUSTICAL PANEL CEILINGS** 

1.1 SUMMARY ACOUSTICAL PANELS AND EXPOSED SUSPENSION SYSTEMS.

SUBMITTALS PRODUCT DATA: FOR EACH TYPE OF PRODUCT INDICATED. COORDINATION DRAWINGS: REFLECTED CEILING PLANS, DRAWN TO SCALE, ON WHICH THE FOLLOWING ITEMS ARE SHOWN AND COORDINATED WITH EACH OTHER, BASED ON INPUT FROM INSTALLERS OF THE ITEMS

INVOLVED: CEILING SUSPENSION SYSTEM MEMBERS. METHOD OF ATTACHING HANGERS TO BUILDING STRUCTURE. CEILING-MOUNTED ITEMS INCLUDING LIGHTING FIXTURES. DIFFUSERS, GRILLES, SPEAKERS, SPRINKLERS, ACCESS PANELS,

AND SPECIAL MOLDINGS. SAMPLES FOR VERIFICATION: FOR EACH COMPONENT INDICATED AND FOR EACH EXPOSED FINISH REQUIRED, PREPARED ON SAMPLES OF SIZE INDICATED BELOW.

ACOUSTICAL PANEL: SET OF FULL-SIZE SAMPLES OF EACH TYPE, COLOR, PATTERN, AND TEXTURE. EXPOSED SUSPENSION SYSTEM MEMBERS, MOLDINGS, AND TRIM: SET OF 12 INCH (300 MM) LONG SAMPLES OF EACH TYPE, FINISH, AND COLOR.

QUALIFICATION DATA: FOR TESTING AGENCY FIELD QUALITY-CONTROL TEST REPORTS. PRODUCT TEST REPORTS: BASED ON EVALUATION OF COMPREHENSIVE TESTS PERFORMED BY A QUALIFIED TESTING AGENCY, FOR EACH

ACOUSTICAL PANEL CEILING. MAINTENANCE DATA: FOR FINISHES TO INCLUDE IN MAINTENANCE MANUALS.

QUALITY ASSURANCE ACOUSTICAL PANEL QUALITY STANDARD: ASTM E 1264. METAL SUSPENSION SYSTEM QUALITY STANDARD: ASTM C 635.

> ACOUSTICAL CEILING PANELS GENERAL: MUST BE CERTIFIED AS LOW EMITTING. CERTIFICATION MUST BE BASED UPON THE CALIFORNIA DEPARTMENT OF HEALTH SERVICES' "STANDARD PRACTICE FOR THE TESTING OF VOLATILE ORGANIC EMISSIONS FROM VARIOUS SOURCES USING SMALL-SCALE ENVIRONMENTAL CHAMBERS", INCLUDING 2004 ADDENDA OR A JURISDICTIONALLY RECOGNIZED STANDARD USING EQUIVALENT TESTING METHODOLOGIES AND VOC THRESHOLDS

ACOUSTICAL CEILING PANELS WASHABLE CLASSIFICATION: TYPE IV, MINERAL BASE WITH MEMBRANE-FACED OVERLAY; FORM 2, WATER FELTED; WITH VINYL OVERLAY ON FACE; PATTERN G (SMOOTH)

**COLOR: AS INDICATED ON DRAWINGS** 

THICKNESS: 5/8 INCH (15 MM). MODULAR SIZE: 24 BY 48 INCHES (610 BY 1220 MM) BROAD SPECTRUM ANTIMICROBIAL FUNGICIDE AND BACTERICIDE TREATMENT: PROVIDE ACOUSTICAL TILES TREATED WITH MANUFACTURER'S STANDARD ANTIMICROBIAL FORMULATION THAT INHIBITS FUNGUS, MOLD, MILDEW, AND GRAM-POSITIVE AND GRAM-NEGATIVE BACTERIA AND SHOWING NO MOLD, MILDEW, OR BACTERIAL GROWTH WHEN TESTED ACCORDING TO ASTM D 3273

AND EVALUATED ACCORDING TO ASTM D 3274 OR ASTM G 21. ACOUSTICAL CEILING PANELS TEXTURED: CLASSIFICATION: TYPE III, MINERAL BASE WITH PAINTED FINISH; FORM 2, WATER FELTED; PATTERN E (LIGHTLY TEXTURED).

COLOR: AS INDICATED ON DRAWINGS. THICKNESS: 5/8 INCH (15 MM). MODULAR SIZE: 24 BY 48 INCHES (610 BY 1220 MM) BROAD SPECTRUM ANTIMICROBIAL FUNGICIDE AND BACTERICIDE TREATMENT: PROVIDE ACOUSTICAL TILES TREATED WITH MANUFACTURER'S STANDARD ANTIMICROBIAL FORMULATION THAT INHIBITS FUNGUS, MOLD, MILDEW, AND GRAM-POSITIVE AND

GRAM-NEGATIVE BACTERIA AND SHOWING NO MOLD, MILDEW, OR

BACTERIAL GROWTH WHEN TESTED ACCORDING TO ASTM D 3273 AND EVALUATED ACCORDING TO ASTM D 3274 OR ASTM G 21. ACOUSTICAL CEILING PANELS PERFORATED: CLASSIFICATION: TYPE III. MINERAL BASE WITH PAINTED FINISH:

FORM 2, WATER FELTED; PATTERN CE (PERFORATED, SMALL HOLES AND LIGHTLY TEXTURED). COLOR: AS INDICATED ON DRAWING

THICKNESS: 3/4 INCH (15 MM). MODULAR SIZE: 24 BY 48 INCHES (610 BY 1220 MM).

BROAD SPECTRUM ANTIMICROBIAL FUNGICIDE AND BACTERICIDE TREATMENT: PROVIDE ACOUSTICAL TILES TREATED WITH MANUFACTURER'S STANDARD ANTIMICROBIAL FORMULATION THAT INHIBITS FUNGUS, MOLD, MILDEW, AND GRAM-POSITIVE AND GRAM-NEGATIVE BACTERIA AND SHOWING NO MOLD, MILDEW, OR BACTERIAL GROWTH WHEN TESTED ACCORDING TO ASTM D 3273 AND EVALUATED ACCORDING TO ASTM D 3274 OR ASTM G 21.

METAL SUSPENSION SYSTEMS WIDE-FACE, CAPPED, DOUBLE-WEB STEEL: INTERMEDIATE DUTY. METAL EDGE MOLDINGS AND TRIM: ROLL-FORMED SHEET METAL.

INSTALLATION INSTALLATION: **ASTM C 636**. FIELD QUALITY CONTROL

> TESTING: BY CONTRACTOR-ENGAGED AGENCY TO TEST ACOUSTICAL PANEL CEILING HANGER FASTENERS.

END OF SECTION 095113

#### **SECTION 096516 - RESILIENT SHEET FLOORING** 1.1 PRODUCTS

FLOORING SYSTEM: FLOORSCORE COMPLIANCE. VINYL SHEET FLOORING:

BACKING: NONE, UNBACKED NONFOAMED PLASTIC/FOAMED PLASTIC PER MANUFACTURER'S SPECIFICATIONS. SEAMLESS-INSTALLATION METHOD: HEAT WELDED. **RUBBER SHEET FLOORING:** 

BACKING: NONE, UNBACKED. SEAMLESS-INSTALLATION METHOD: HEAT WELDED.

**INSTALLATION MATERIALS:** TROWELABLE LEVELING AND PATCHING COMPOUNDS: LATEX-MODIFIED. PORTLAND CEMENT BASED OR BLENDED HYDRAULIC-CEMENT-BASED FORMULATION PROVIDED OR APPROVED BY RESILIENT SHEET FLOORING

MANUFACTURER FOR APPLICATIONS INDICATED. ADHESIVES: WATER-RESISTANT TYPE RECOMMENDED BY FLOORING AND ADHESIVE MANUFACTURERS TO SUIT RESILIENT SHEET FLOORING AND SUBSTRATE CONDITIONS INDICATED. VINYL SHEET ADHESIVES SHALL HAVE A VOC CONTENT OF 50 G/L

RUBBER SHEET ADHESIVES SHALL HAVE A VOC CONTENT OF 60 G/L OR LESS.

INTEGRAL-FLASH-COVE-BASE ACCESSORIES: COVE STRIP: 1 INCH (25 MM) RADIUS PROVIDED OR APPROVED BY

RESILIENT SHEET FLOORING MANUFACTURER. CAP STRIP: **SQUARE METAL, VINYL, OR RUBBER CAP** PROVIDED OR APPROVED BY RESILIENT SHEET FLOORING MANUFACTURER. FLOOR POLISH: PROVIDE PROTECTIVE, LIQUID FLOOR-POLISH

PRODUCTS RECOMMENDED BY RESILIENT SHEET FLOORING MANUFACTURER. **END OF SECTION 096516** 

#### FINISHES (CONTINUED)

**SECTION 097200 - WALL COVERINGS** 

1.1 SUMMARY A. VINYL AND WOVEN GLASS-FIBER WALL COVERING.

MATERIALS ADHESIVE: MILDEW-RESISTANT, NONSTAINING, STRIPPABLE ADHESIVE, FOR USE WITH SPECIFIC WALL COVERING AND SUBSTRATE APPLICATION. AS RECOMMENDED IN WRITING BY WALL-COVERING MANUFACTURER, AND WITH A VOC CONTENT OF 50 G/L OR LESS WHEN CALCULATED ACCORDING TO 40 CFR 59, SUBPART D (EPA METHOD 24).

1.3 INSTALLATION A. INSTALL STRIPS IN SAME ORDER AS CUT FROM ROLL **END OF SECTION 097200** 

#### **SECTION 099123 - INTERIOR PAINTING**

SUMMAR' SURFACE PREPARATION AND THE APPLICATION OF PAINT SYSTEMS ON

INTERIOR SUBSTRATES. 1.2

SAMPLES FOR VERIFICATION: FOR EACH NON-STANDARD LATEX TOPCOAT COLOR AND GLOSS

FOR EACH TYPE OF NON-STANDARD PAINT SYSTEM AND IN EACH COLOR AND GLOSS OF TOPCOAT INDICATED. 1.3 QUALITY ASSURANCE

QUALITY STANDARDS: "MPI APPROVED PRODUCTS LIST" AND "MPI ARCHITECTURAL PAINTING SPECIFICATION MANUAL." MOCKUPS FOR EACH COLOR AND FINISH.

GENERAL VOC CONTENT: PRODUCTS SHALL COMPLY WITH VOC LIMITS OF AUTHORITIES HAVING JURISDICTION [AND. FOR INTERIOR PAINTS AND COATINGS APPLIED AT PROJECT SITE, THE FOLLOWING VOC LIMITS, EXCLUSIVE OF COLORANTS ADDED TO A TINT BASE, WHEN CALCULATED ACCORDING TO 40 CFR 59. SUBPART D (EPA METHOD 24)1.

FLAT PAINTS AND COATINGS: 50 G/L. NONFLAT PAINTS AND COATINGS: 150 G/L. DRY-FOG COATINGS: 400 G/L. PRIMERS. SEALERS. AND UNDERCOATERS: 200 G/L.

ANTICORROSIVE AND ANTIRUST PAINTS APPLIED TO FERROUS METALS: 250 G/L. ZINC-RICH INDUSTRIAL MAINTENANCE PRIMERS: 340 G/L. PRETREATMENT WASH PRIMERS: 420 G/L.

FLOOR COATINGS: 100 G/L SHELLACS, CLEAR: 730 G/L SHELLACS, PIGMENTED: 550 G/L.

1.5 INTERIOR PAINTING SCHEDULE

WOOD SUBSTRATES:

PLASTER SUBSTRATES:

STEEL SUBSTRATES: INSTITUTIONAL LOW-ODOR/VOC LATEX SYSTEM: PRIME COAT: PRIMER, RUST-INHIBITIVE, WATER BASED. TOPCOAT: INSTITUTIONAL LOW-ODOR/VOC INTERIOR LATEX (GLOSS LEVEL AS INDICATED IN PAINT SCHEDULE).

GALVANIZED-METAL SUBSTRATES: INSTITUTIONAL LOW-ODOR/VOC LATEX SYSTEM: PRIME COAT: PRIMER, GALVANIZED, WATER BASED. TOPCOAT: LATEX, INTERIOR, INSTITUTIONAL LOW ODOR/VOC, (GLOSS LEVEL AS INDICATED IN PAINT

SCHEDULE).

INSTITUTIONAL LOW-ODOR/VOC LATEX SYSTEM: PRIME COAT: INTERIOR LATEX PRIMER/SEALER. TOPCOAT: INSTITUTIONAL LOW-ODOR/VOC INTERIOR LATEX (GLOSS LEVEL AS INDICATED IN PAINT SCHEDULE).

GYPSUM BOARD SUBSTRATES: INSTITUTIONAL LOW-ODOR/VOC LATEX SYSTEM: PRIME COAT: INTERIOR LATEX PRIMER/SEALER.

TOPCOAT: INSTITUTIONAL LOW-ODOR/VOC INTERIOR LATEX (GLOSS LEVEL AS INDICATED IN PAINT SCHEDULE). HIGH-IMPACT GYPSUM BOARD SUBSTRATES: HIGH-PERFORMANCE ARCHITECTURAL LATEX SYSTEM:

PRIME COAT: INTERIOR LATEX PRIMER/SEALER TOPCOAT: INSTITUTIONAL LOW-ODOR/VOC INTERIOR LATEX (GLOSS LEVEL AS INDICATED IN PAINT SCHEDULE).

INSTITUTIONAL LOW-ODOR/VOC LATEX SYSTEM: PRIME COAT: INTERIOR LATEX PRIMER/SEALER. TOPCOAT: INSTITUTIONAL LOW-ODOR/VOC INTERIOR LATEX (GLOSS LEVEL AS INDICATED IN PAINT SCHEDULE).

ACOUSTICAL CEILING TILE: INSTITUTIONAL LOW-ODOR/VOC LATEX SYSTEM: PRIME COAT: INTERIOR LATEX PRIMER/SEALER. TOPCOAT: INSTITUTIONAL LOW-ODOR/VOC INTERIOR

LATEX (GLOSS LEVEL AS INDICATED IN PAINT SCHEDULE).

**END OF SECTION 099123** 

#### SECTION 09930 - WOOD STAINS AND TRANSPARENT FINISHES

SURFACE PREPARATION AND APPLICATION OF WOOD FINISHES ON

**INTERIOR** SUBSTRATES. SUBMITTALS SAMPLES FOR VERIFICATION: FOR EACH TYPE OF FINISH SYSTEM AND IN

EACH COLOR AND GLOSS OF FINISH INDICATED. QUALITY ASSURANCE 1.3 QUALITY STANDARDS: "MPI APPROVED PRODUCTS LIST" AND "MPI ARCHITECTURAL PAINTING SPECIFICATION MANUAL."

CHEMICAL COMPONENTS OF FIELD-APPLIED INTERIOR PAINTS AND COATINGS: VOC LIMITS:

CLEAR WOOD FINISHES, VARNISHES: VOC NOT MORE THAN SHELLACS, CLEAR: VOC NOT MORE THAN 730 G/L STAINS: VOC NOT MORE THAN 250 G/L. PRIMERS, SEALERS, AND UNDERCOATERS: 200 G/L

FIRE RETARDANT COATINGS, CLEAR: 650 G/L.

FIRE RETARDANT COATINGS, PIGMENTED: 350 G/L. EXTERIOR WOOD-FINISH-SYSTEM SCHEDULE SOLID-COLOR LATEX STAIN SYSTEM: MPI EXT 6.3K. PRIME COAT: PRIMER, LATEX FOR EXTERIOR WOOD. INTERMEDIATE COAT: STAIN, EXTERIOR, WATER BASED, SOLID HIDE,

MATCHING TOPCOAT.

ASTM E 84.

TOPCOAT: STAIN, EXTERIOR, WATER BASED, SOLID HIDE. SEMITRANSPARENT STAIN SYSTEM: MPI EXT 6.3D. 1. TWO STAIN COATS: EXTERIOR SEMITRANSPARENT LATEX STAIN

1.6 INTERIOR WOOD-FINISH-SYSTEM SCHEDULE SEMITRANSPARENT STAIN SYSTEM: PRIME COAT: STAIN, SEMI-TRANSPARENT, MATCHING TOPCOAT. TOPCOAT: STAIN, SEMI-TRANSPARENT, FOR INTERIOR WOOD.

WATER-BASED VARNISH SYSTEM: PRIME COAT: WATER-BASED VARNISH MATCHING TOPCOAT. INTERMEDIATE COAT: WATER-BASED VARNISH MATCHING TOPCOAT. TOPCOAT: VARNISH, WATER BASED, CLEAR.

WATER-BASED FIRE RETARDANT SYSTEM: TOPCOAT: FIRE RETARDANT COATING, CLEAR. CLASS A FLAME SPREAD AND SMOKE-DEVELOPED INDEX PER

**END OF SECTION 09930** 

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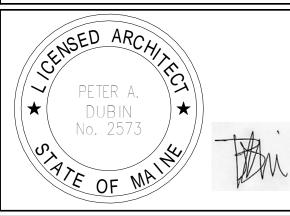
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ENGINEER OF RECORD . Louis, Missouri 63119 Phone (314) 772-1782 Fax (314) 373-3514 **Engineering Consultants** Mechanical - Electrical - Plumbing



**Revision Schedule** Rev Date Bv Description

TR Ш CIAL MME AND, ERLAN COJECT AI 45 CON ORTLA

STORE #: 19384 PROJECT #: 58862-001 CONCEPT: MCS PALETTE: HERITAGE ISSUE DATE: JAN. 11, 2013 **DESIGN MANAGER:** E. ZAKAMAREK LEED<sup>(R)</sup> AP: PRODUCTION DESIGNER: NORR ILLINOIS CHECKED BY:

SHEET TITLE:

SCALE:

DESIGN **SPECIFICATIONS** 

1/4" = 1'-0'

SHEET NUMBER:

G-012

**END OF SECTION 09216** 



#### ARCHITECTURAL SITE PLAN NOTES

A. REFER TO EXTERIOR ELEVATIONS FOR BUILDING SIGNAGE LOCATION AND DESIGN ID. REFER TO ELECTRICAL PLANS FOR ELECTRICAL REQUIREMENTS.

B. LANDSCAPING TO BE PROVIDED PER ZONING CODE AND LEED REQUIREMENTS.

C. DRIVE-THRU EQUIPMENT INCLUDING VEHICLE DETECTION LOOP, WIRELESS COMMUNICATION, AND MONITORS COORDINATED BY STARBUCKS CONSTRUCTION MANAGER. REFER TO ELECTRICAL SPECIFICATIONS FOR ELECTRICAL REQUIREMENTS.

D. LANDLORD IS RESPONSIBLE FOR PROVIDING SITE WORK, INCLUDING NEW BOLLARDS, FOOTING AND CONDUIT FOR DRIVE-THRU SIGNAGE. COORDINATE WITH STARBUCKS CONSTRUCTION MANAGER.

E. ALL PARKING AND DRIVE-THRU STRIPING TO BE PROVIDED

F. TRASH ENCLOSURE TO BE LOCKABLE USING STEEL GATES OR CHAIN TO BE PROVIDED BY LANDLORD.

G. LANDLORD TO PROVIDE 6" (150MM) THICK CONCRETE PAVING THE LENGTH OF THE DRIVE-THRU LANE, EXTENT TO INCLUDE DRIVE-THRU WINDOW STANDING PAD.

H. GENERAL CONTRACTOR TO APPLY CONCRETE SEALER TO ALL EXTERIOR CONCRETE PATIO AND WALKWAY SURFACES.

#### **SHEET NOTES**

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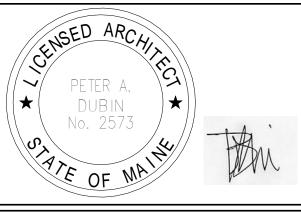
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Revision Schedule							
Rev	Date	Ву	Description				

STORE #: 19384 PROJECT #: 58862-001 CONCEPT: MCS HERITAGE ISSUE DATE: JAN. 11, 2013 DESIGN MANAGER: E. ZAKAMAREK LEED® AP:

PRODUCTION DESIGNER: NORR ILLINOIS

SHEET TITLE:

SCALE:

ARCHITECTURAL SITE PLAN

As indicated

SHEET NUMBER:

A-101

#### ALLOWED SIGNAGE RQMTS:

COMMERCIAL STREET FACADE: ALLOWED SIGNAGE: 66 SF PROPOSED SIGNAGE: 49 SF

MAX AREA BUILDING SIGNAGE ALLOWED: 2 SQFT PER TENANT BUILDING FRONTAGE \*NOTE: HISTORIC OVERRULES ZONING

#### PROPOSED SIGNAGE:

Starbucks Wordmark - ID: 11453 (Qty: 1)
Area: 45.33 SF (Back Illuminated Inline)
Height: 16in (Wordmark); 24in (Backer Panel)
\*Note: Area includes Backer Panel
Exterior Logo Disk - ID: X0068 (Qty: 1)
Area: 3.14 SF (Externally Iluminated)

Height: 24in
Interior Logo Disk - ID: 13157 (Qty: 2)
Area: 3.14 SF (Internally Illuminated)
Height: 24in

Proposed Signage Total Area: 48.47 SF (Excludes Interior Logo Disks; Including Interior Logo Disks: 54.75 SF)

#### **EXTERIOR ELEVATION NOTES**

A. GENERAL CONTRACTOR TO COORDINATE AND SCHEDULE SIGNAGE INSTALLATION WITH THE SIGNAGE CONTRACTOR PROVIDING A MINIMUM SCHEDULING NOTICE OF 4 WEEKS AND 1 WEEK PRIOR TO SCHEDULED DATE OF INSTALLATION. STARBUCKS CONSTRUCTION MANAGER TO PROVIDE GENERAL CONTRACTOR WITH SIGNAGE CONTRACTOR CONTACT INFORMATION.

B. GENERAL CONTRACTOR SHALL COORDINATE WITH ELECTRICAL CONTRACTOR TO FURNISH AND INSTALL ELECTRICAL CIRCUITS INCLUDING ALL CONDUIT, WIRE, CONNECTIONS, AND BREAKER AT PANEL BOARD NECESSARY TO SERVE SIGNAGE.

C. GENERAL CONTRACTOR TO PROVIDE FIRE TREATED WOOD STUD BLOCKING, OR EQUIVALENT TO SUPPORT SIGNAGE.

D. SIGNAGE CONTRACTOR SHALL VERIFY SIZE AND LOCATION OF ANY AND ALL ALLOWABLE MONUMENT OR POLE SIGNAGE WITH LANDLORD AND PROVIDE SHOP DRAWING(S) PRIOR TO FABRICATION TO STARBUCKS DESIGNER FOR APPROVAL.

E. SIGNAGE CONTRACTOR TO INSTALL SIGNAGE IN COMPLIANCE WITH LOCAL CODES AND OBTAIN PERMIT AND LANDLORD

F. SIGNAGE CONTRACTOR TO SUPPLY SHOP DRAWINGS TO STARBUCKS CONSTRUCTION MANAGER AND TO THE GENERAL CONTRACTOR AS NEEDED. GENERAL CONTRACTOR TO NOTIFY STARBUCKS CONSTRUCTION MANAGER IMMEDIATELY IF SHOP DRAWINGS OR INSTALLATION IS IN DISCREPANCY WITH STARBUCKS ARCHITECTURAL DRAWINGS.

G. GENERAL CONTRACTOR TO CLEAN, PATCH AND REPAIR EXISTING EXTERIOR AS REQUIRED.

H. SEE SCHEDULE SHEETS FOR SIGNAGE SCHEDULE.

#### **SHEET NOTES**

1. PROVIDE 3" (75MM) HIGH BLACK ACRYLIC STORE ADDRESS ON GLAZING.

2. INSTALL NEW HALO-LIT, 16IN WORDMARK ON BACKER PANEL AS INDICATED. CENTER NEW WORKMARK AND PANEL ABOVE ENTRANCE DOORS (HORIZ) AND WITHIN EXISTING FACADE BANDING (VERT) - GC TO VERIFY DIMENSIONS OF SIGNAGE MOUNTING.

3. INSTALL NEW EXTERNALLY ILLUMINATED, 24IN BLADE DISK AS INDICATED. CENTER DISK WITHIN EXISTING FACADE BANDING - GC TO VERIFY DIMENSIONS OF SIGNAGE MOUNTING.

4. INSTALL NEW ILLUMINATED, INTERIOR 24IN SUSPENDED LOGO DISK AS INDICATED. SEE INTERIOR ELEVATIONS FOR MOUNTING HEIGHT.



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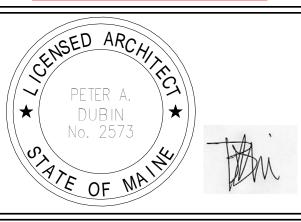
Associates

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	Revision Schedule						
Rev	Date	Ву	Description				

# PROJECT NAME: COMMERCIAL STREET PROJECT ADDRESS: 145 COMMERCIAL STREET PORTLAND, ME 04101 CUMBERLAND COUNTY

STORE #: 19384

PROJECT #: 58862-001

CONCEPT: MCS

PALETTE: HERITAGE

ISSUE DATE: JAN. 11, 2013

DESIGN MANAGER: E. ZAKAMAREK

LEED® AP:

PRODUCTION DESIGNER: NORR ILLINOIS

SHEET TITLE:
EXTERIOR ELEVATIONS


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SHEET NUMBER:


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1/4" = 1'-0"

A-301





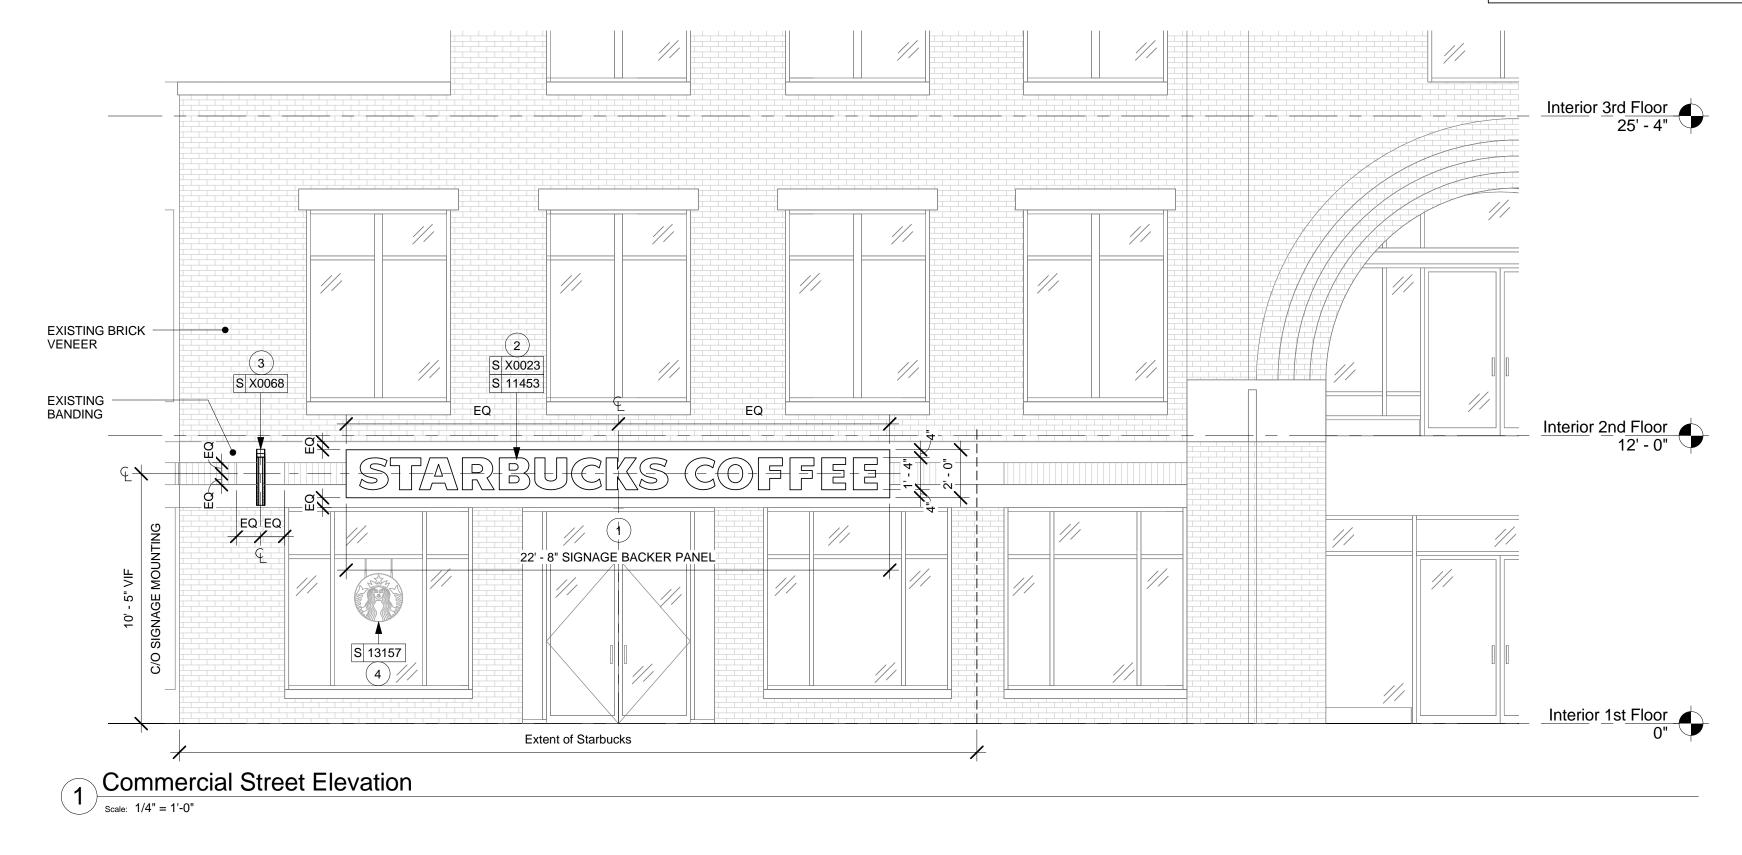
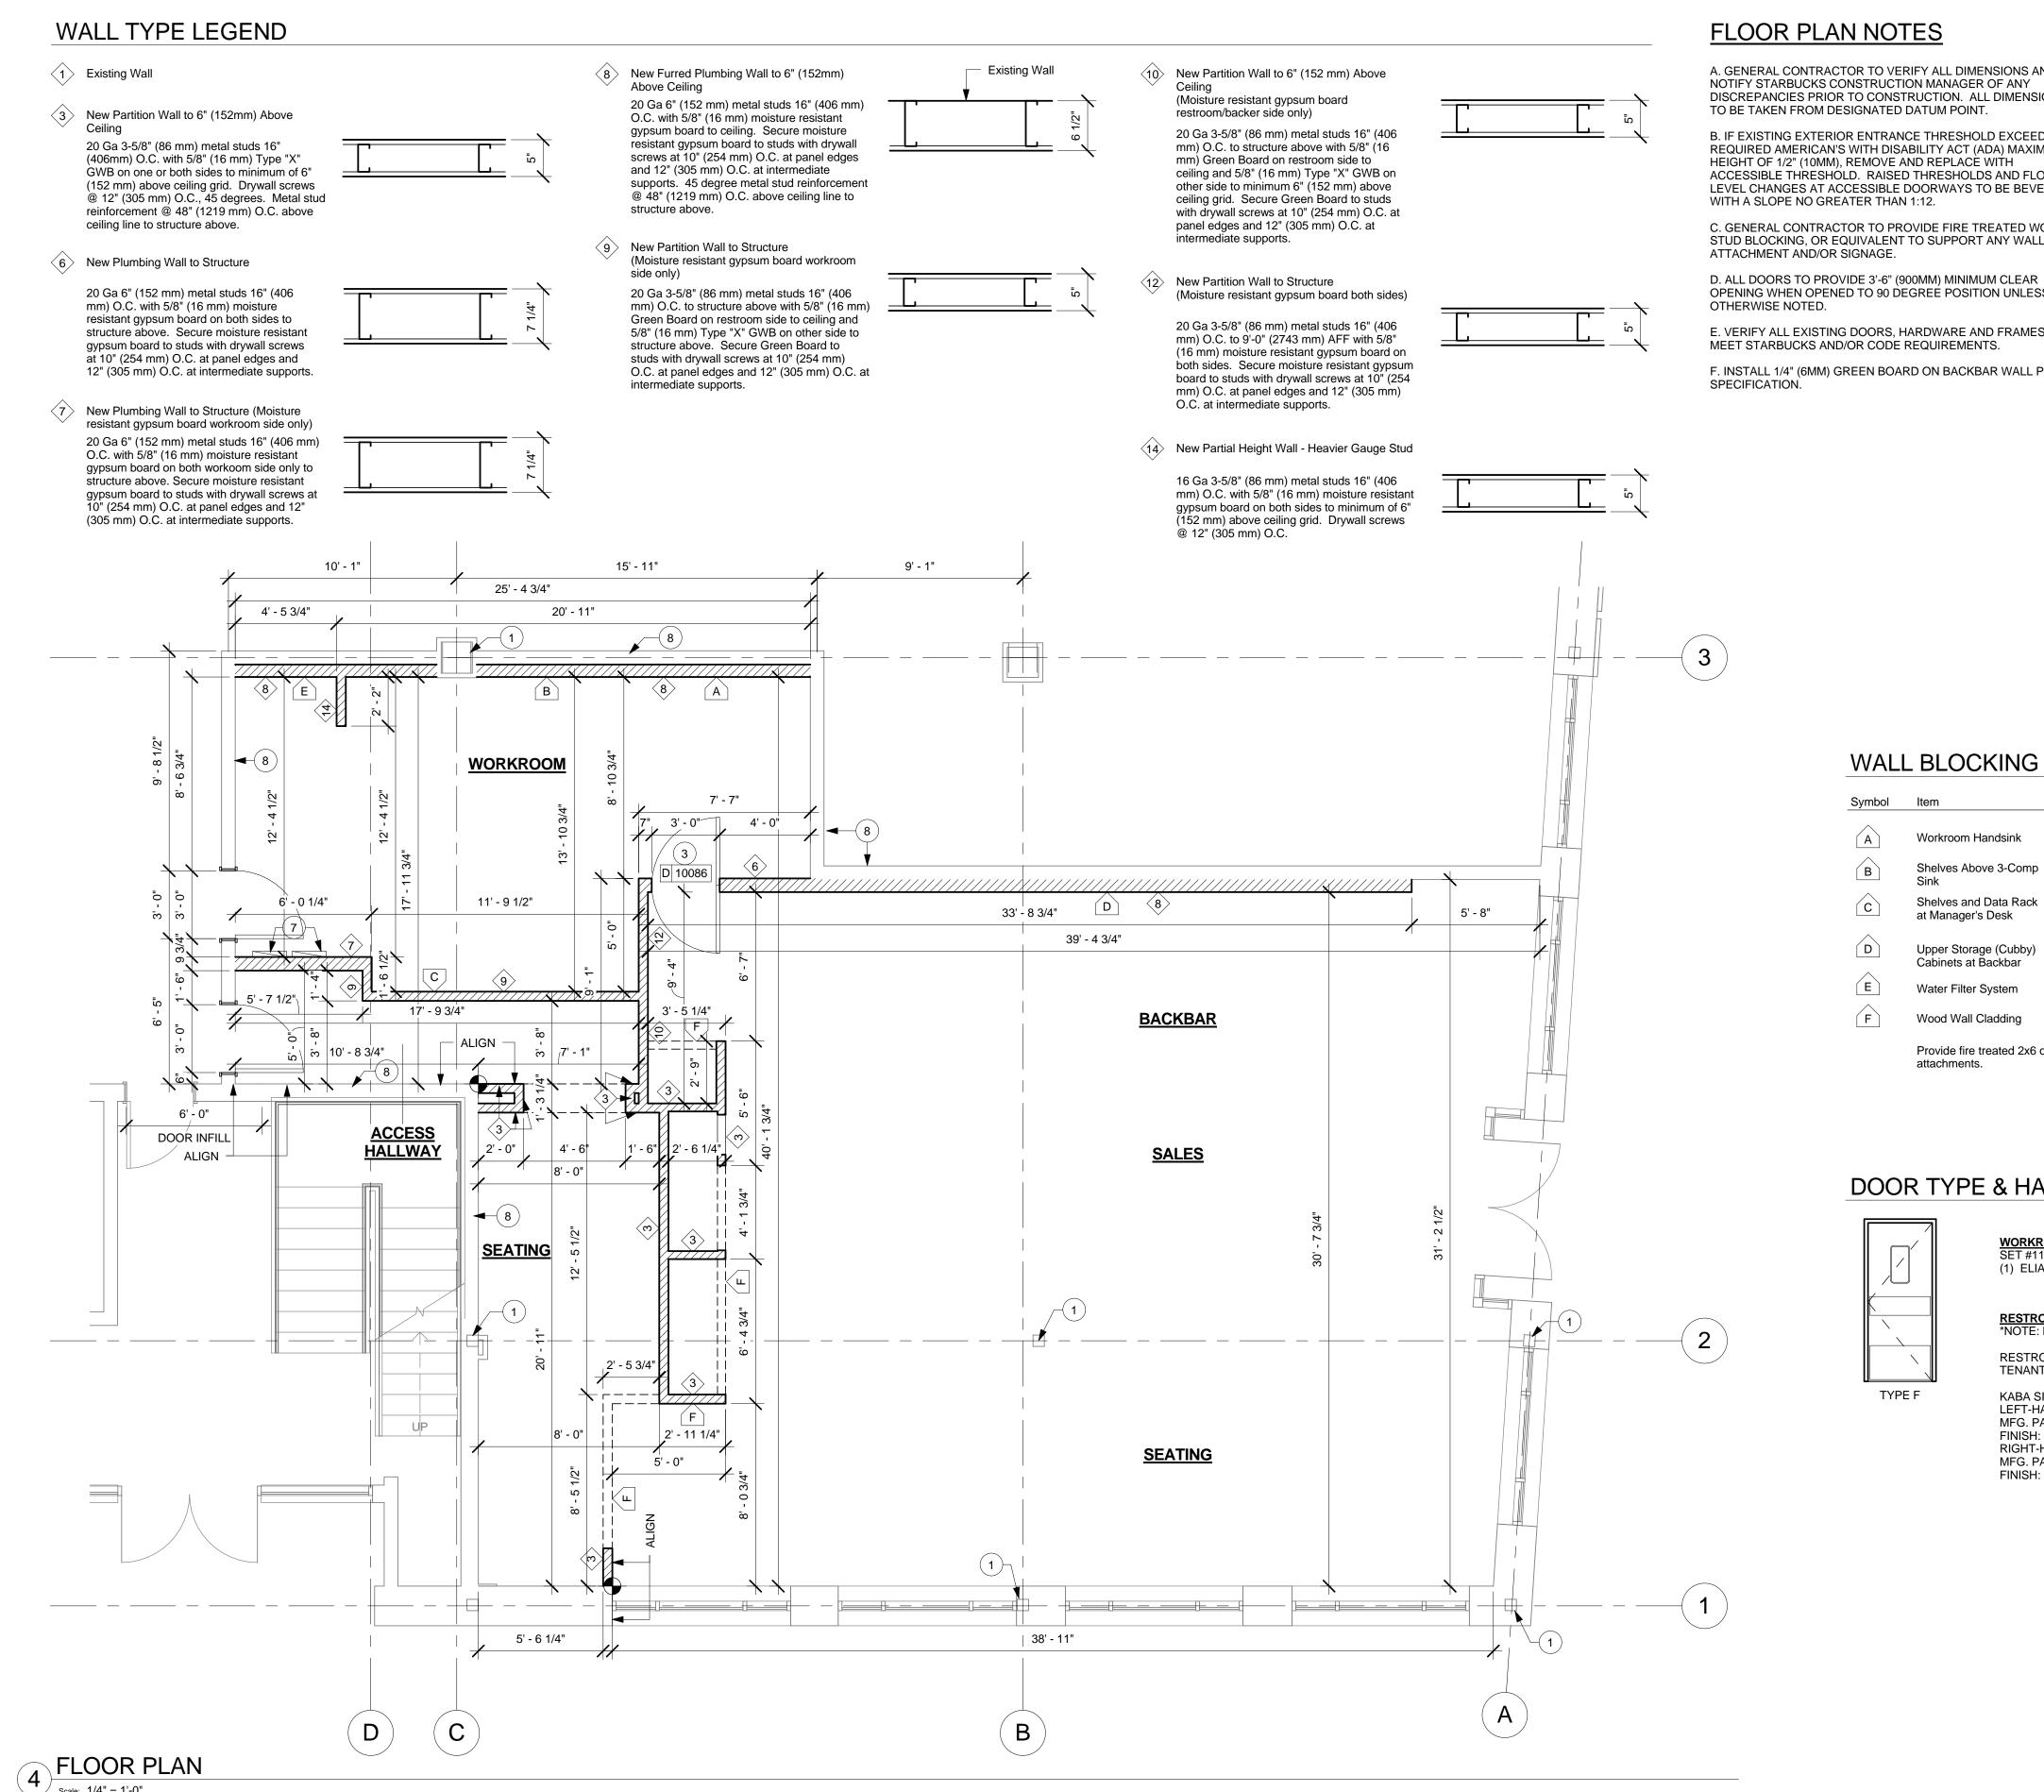
#### **FLOOR PLAN NOTES**

A. GENERAL CONTRACTOR TO VERIFY ALL DIMENSIONS AND NOTIFY STARBUCKS CONSTRUCTION MANAGER OF ANY DISCREPANCIES PRIOR TO CONSTRUCTION. ALL DIMENSIONS TO BE TAKEN FROM DESIGNATED DATUM POINT.

B. IF EXISTING EXTERIOR ENTRANCE THRESHOLD EXCEEDS REQUIRED AMERICAN'S WITH DISABILITY ACT (ADA) MAXIMUM HEIGHT OF 1/2" (10MM), REMOVE AND REPLACE WITH ACCESSIBLE THRESHOLD. RAISED THRESHOLDS AND FLOOR LEVEL CHANGES AT ACCESSIBLE DOORWAYS TO BE BEVELED WITH A SLOPE NO GREATER THAN 1:12.

C. GENERAL CONTRACTOR TO PROVIDE FIRE TREATED WOOD STUD BLOCKING, OR EQUIVALENT TO SUPPORT ANY WALL ATTACHMENT AND/OR SIGNAGE.

OPENING WHEN OPENED TO 90 DEGREE POSITION UNLESS OTHERWISE NOTED.

E. VERIFY ALL EXISTING DOORS, HARDWARE AND FRAMES MEET STARBUCKS AND/OR CODE REQUIREMENTS.

F. INSTALL 1/4" (6MM) GREEN BOARD ON BACKBAR WALL PER SPECIFICATION.

#### **SHEET NOTES**

1. EXISTING COLUMN.

2. REFER TO SHEETS I-502 THROUGH I-503 FOR DETAILS.

3. INSTALL INTERIOR DOORS AS INDICATED. REFER TO SHEET I-602 FOR DOOR SCHEDULE.

4. PROVIDE FIRE-TREATED WOOD BLOCKING AS REQUIRED TO SUPPORT ANY WALL ATTACHMENTS.

5. INSTALL 5/8" TILE BACKER BOARD ON BACKBAR/WORKROOM WETSIDE WALLS.

6. CONSTRUCT FULL-HEIGHT WALLS AS INDICATED.

7. ELECTRICAL PANEL LOCATIONS AS INDICATED. MAINTAIN MINIMUM CLEARANCES AS REQUIRED.

8. GC TO MAINTAIN ALL REQUIRED FIRE-RATING AT DEMISING WALLS.


9. GC TO VERIFY OVERALL DIMENSIONS ARE ACCURATE PRIOR TO LAYING OUT WALLS. CONTACT ARCHITECT OF RECORD IMMEDIATELY IF DISCREPANCIES OCCUR.

#### WALL BLOCKING KEY

Symbol	Item	Weight	Height	Approximate Width
A	Workroom Handsink	125LBS	3'-0" to 3'-4"	2'-6" Behind Sink
В	Shelves Above 3-Comp Sink	200LBS	5'-8" to 6'-0"	6'-0" Centered Above 3-Comp Sink
Ĉ	Shelves and Data Rack at Manager's Desk	300LBS	1/2" ACX Plywood	7'-0" Centered Above Manager's Desk and Data Rack
D	Upper Storage (Cubby) Cabinets at Backbar	300LBS	6'-1" to 7'-10"	Extent of Backbar Uppe Casework
E	Water Filter System	200LBS	4'-0" to 7'-6"	See Plan
F	Wood Wall Cladding	300LBS	0'-6" to 9'-0"	See Plan

Provide fire treated 2x6 or 2x8 wood stud blocking as required to support any wall attachments.

#### DOOR TYPE & HARDWARE LEGEND

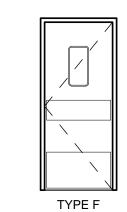

WORKROOM DOOR (TYPE F) SET #11

(1) ELIASON DOOR PACKAGED WITH HARDWARE. (VD)

RESTROOM DOOR (PROVIDED BY LL)
\*NOTE: NOT SHOWN ON PLANS

RESTROOM HARDWARE PROVIDED BY LL; TENANT-PREFERRED PUSHBUTTON LEVER LOCK SPEC:


KABA SIMPLEX, L1021S 26D LEFT-HAND -

MFG. PART NO.: LL-1021S-36D-41; SCHLAGE CORE COMPATIBLE FINISH: 26D: SATIN CHROME

RIGHT-HAND -MFG. PART NO.: LR-1021S-36D-41; SCHLAGE CORE COMPATIBLE FINISH: 26D: SATIN CHROME

WALL LEGEND - FLOOR PLAN

✓ NEW FULL HEIGHT WALL EXISTING WALL EXISTING COLUMN

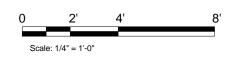





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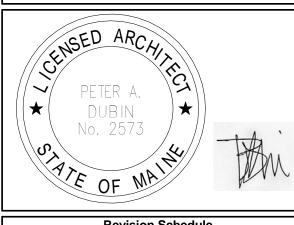
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Revision Schedule								
Rev	Date	Ву	Description					

STREE PROJECT NAME:
COMMERCIAL

STORE #: 19384 PROJECT #: 58862-001 CONCEPT: MCS PALETTE: HERITAGE ISSUE DATE: JAN. 11, 2013 DESIGN MANAGER: E. ZAKAMAREK LEED® AP: PRODUCTION DESIGNER: NORR ILLINOIS CHECKED BY:


SHEET TITLE: FLOOR PLAN

SCALE:

SHEET NUMBER:

I-112

As indicated

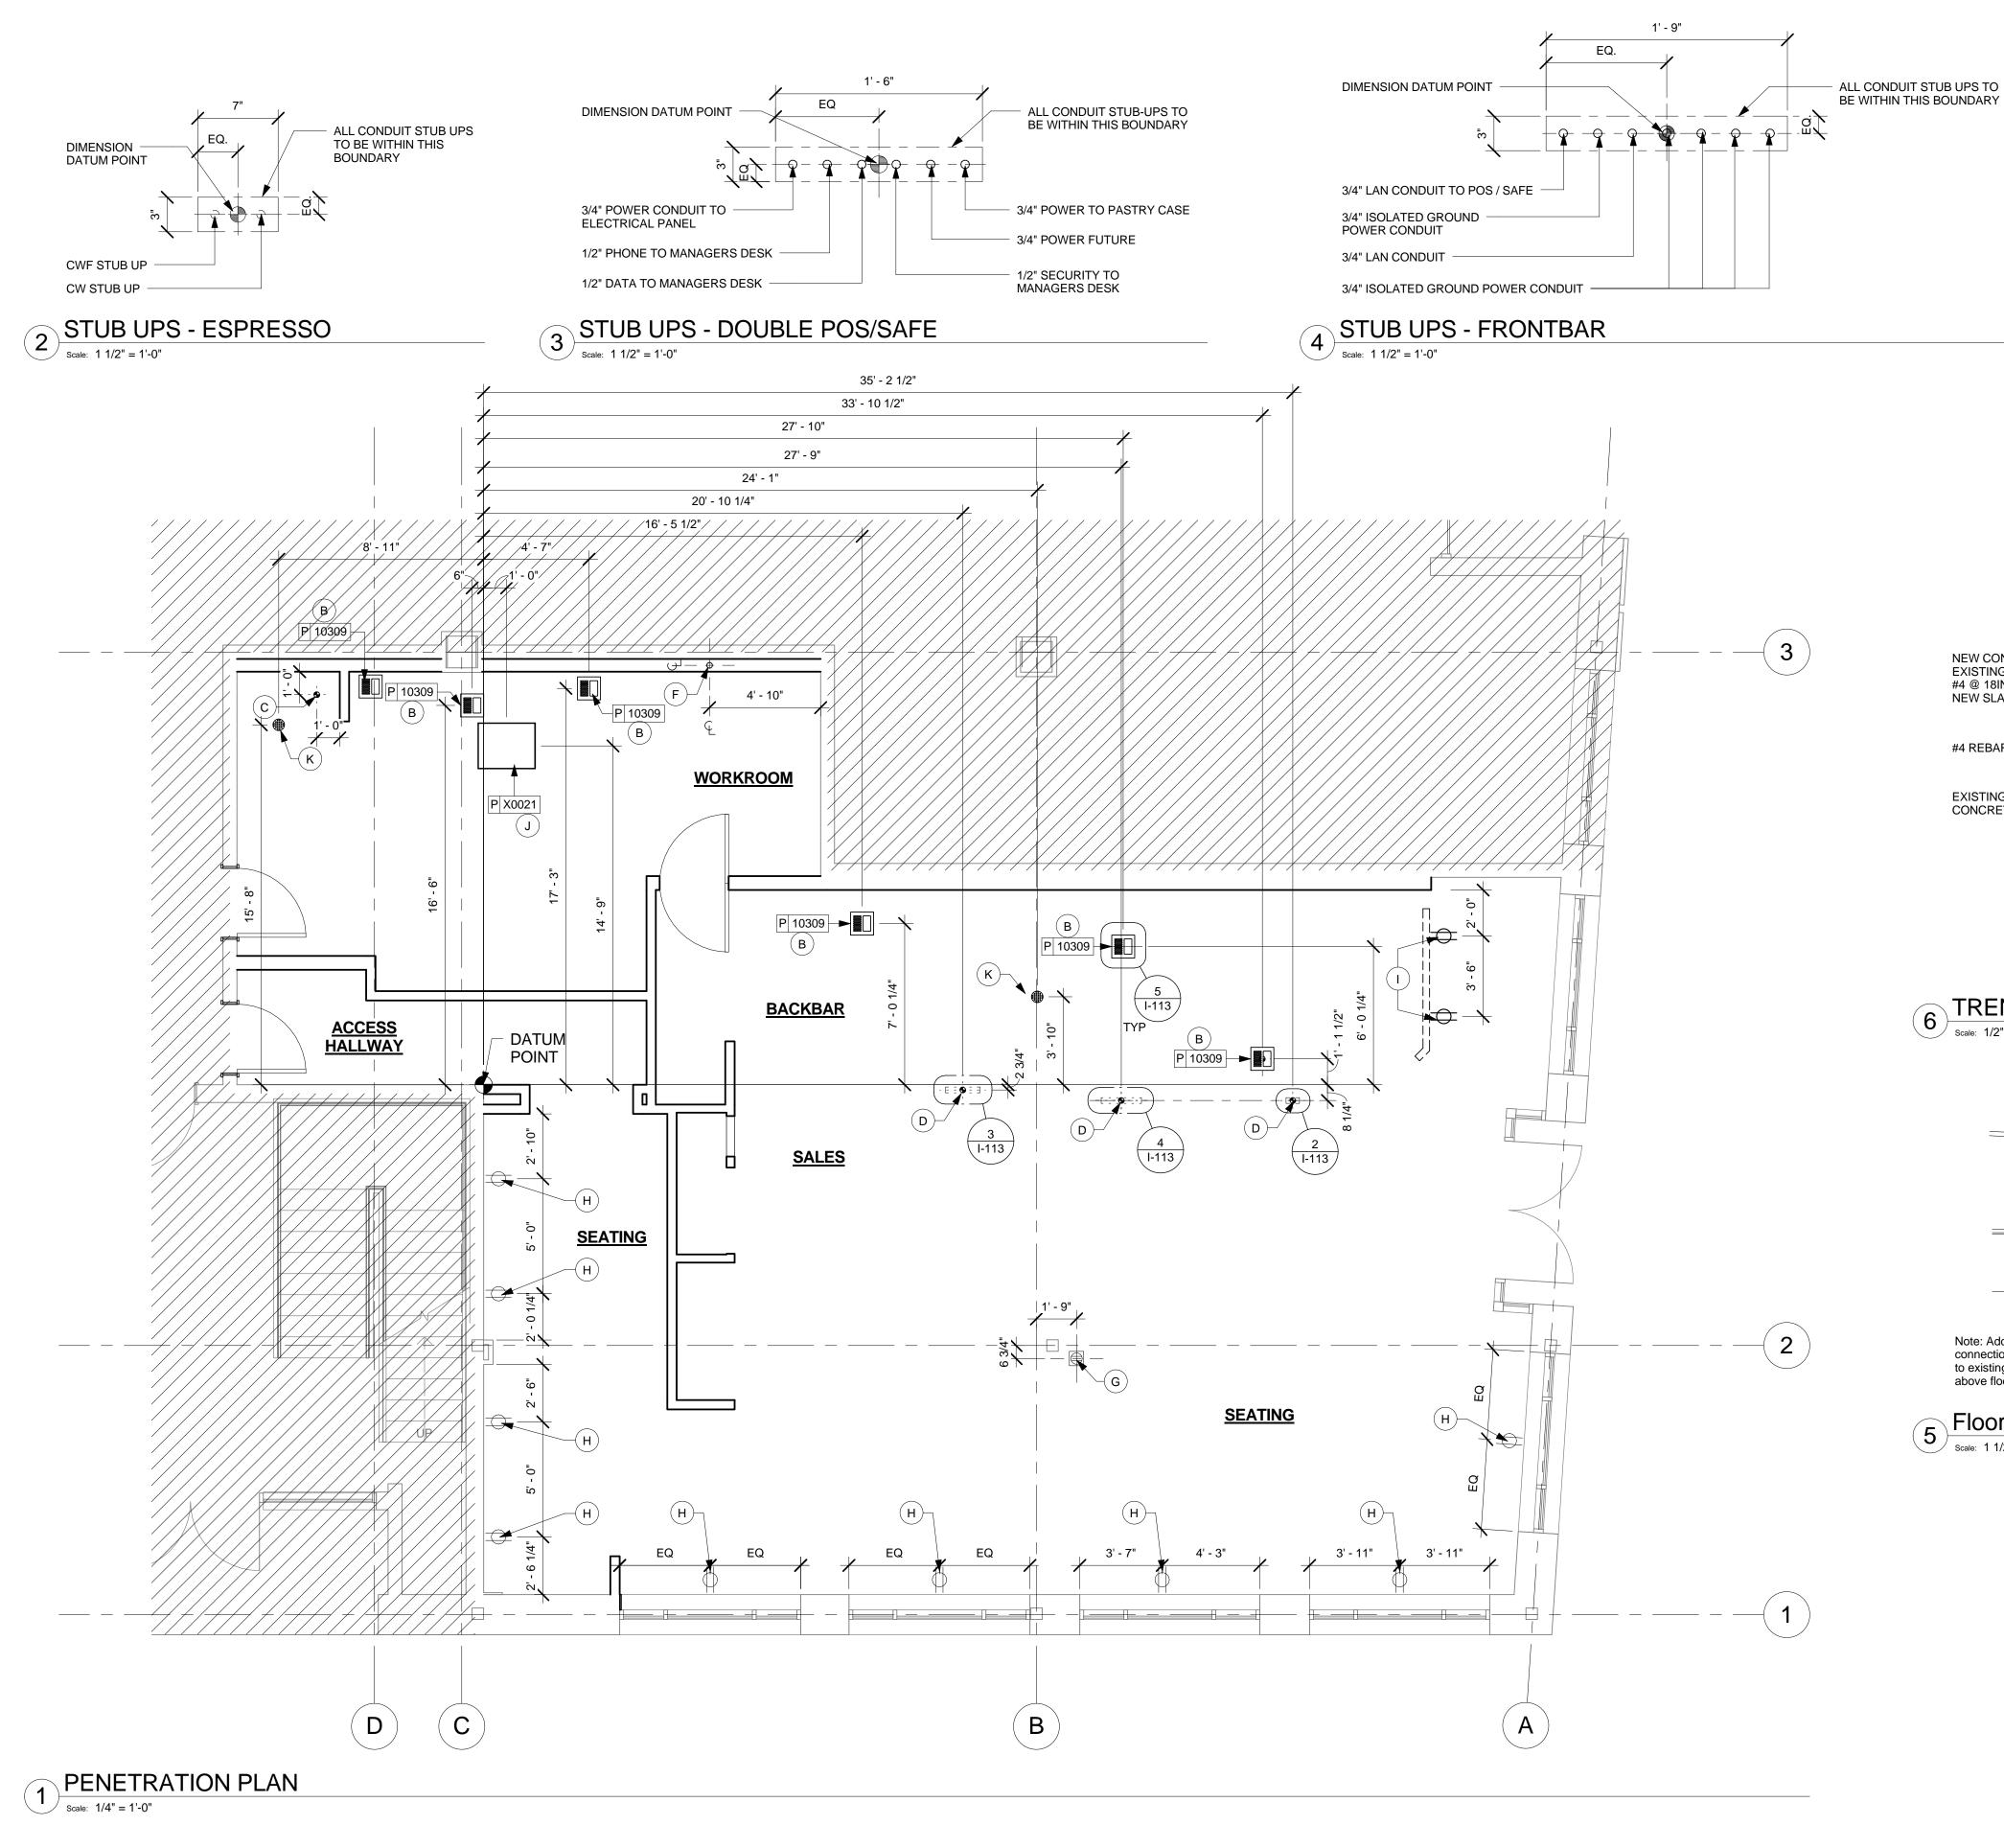

#### PENETRATION PLAN NOTES

A. ALL STUB-UP DIMENSIONS ARE RELATIVE TO FINISHED WALL LOCATIONS (SHOWN AS OUTLINES ON THIS PLAN). REFER TO FLOOR PLAN FOR WALL PLACEMENT.

B. FLOOR SINK: REFER TO CUT SHEETS FOR COMPONENT SPECIFICATIONS AND CUTOUT REQUIREMENTS.

C. WASTE LINE PENETRATIONS: REFER TO PLUMBING PLANS FOR INDIVIDUAL LINE SPECIFICATIONS.

D. STUB-UP PENETRATIONS: REFER TO PLUMBING PLANS FOR INDIVIDUAL STUB-UP SPECIFICATIONS.

E. CLEAN OUT PENETRATIONS: SEE PLUMBING SHEETS FOR INDIVIDUAL LINE SPECIFICATIONS. LOCATE AS REQUIRED PER CONDITION.

F. PENETRATION TO BE LOCATED ON CENTERLINE OF WALL OR AS REQUIRED PER CONDITIONS.


G. LOCATION OF POWER CONDUIT STUB-UP FOR COMMUNITY TABLE: REFER TO ELECTRICAL DRAWINGS FOR MORE INFORMATION.

H. LOCATION OF WALL OUTLET AT 15IN AFF. COORDINATE LOCATIONS WITH STARBUCKS CONSTRUCTION MANAGER. REFER TO ELECTRICAL DRAWINGS FOR MORE INFORMATION.

I. LOCATION OF OUTLET AT CASEWORK DIE WALL AT 34IN AFF. COORDINATE LOCATIONS WITH STARBUCKS CONSTRUCTINO MANAGER. REFER TO ELECTRICAL DRAWINGS FOR MORE INFORMATION.


J. GREASE TRAP PENETRATION: REFER TO PLUMBING SHEETS FOR MORE INFORMATION. LOCATE AS REQUIRED PER CONDITION.

K. FLOOR DRAIN: REFER TO PLUMBING PLANS FOR INDIVIDUAL LINE SPECIFICATIONS.

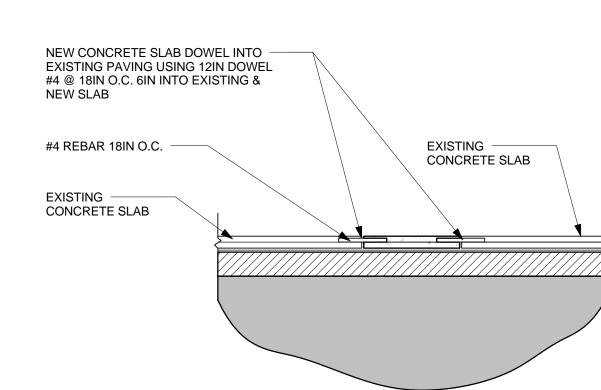

6 TRENCHING REPAIR DETAIL

Scale: 1/2" = 1'-0"

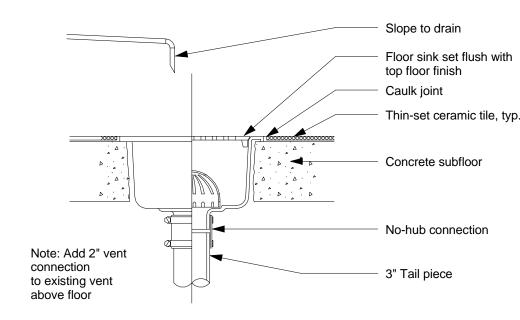

Floor Drain Section

#### PENETRATION PLAN LEGEND

FLOOR SINK

FLOOR PENETRATION

PLUMBING PENETRATION AREA

**ELECTRICAL PENETRATION AREA** 





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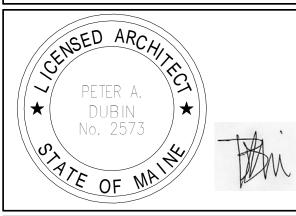
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Engineering Consultants Mechanical - Electrical - Plumbing

Fax (314) 373-3514



Revision Schedule						
Rev	Date	Ву	Description			

STREE PROJECT NAME:

COMMERCIAL

STORE #: 19384 PROJECT #: 58862-001 CONCEPT: MCS PALETTE: HERITAGE ISSUE DATE: JAN. 11, 2013 DESIGN MANAGER: E. ZAKAMAREK LEED® AP: PRODUCTION DESIGNER: NORR ILLINOIS CHECKED BY:

SHEET TITLE:

PENETRATION PLAN

As indicated

SCALE: SHEET NUMBER:

I-113

E 10947

#### FF AND E PLAN NOTES

A. GENERAL CONTRACTOR TO SCHEDULE WITH LOCAL REFRIGERATION CONTRACTOR TO CONDUCT INITIAL FOOD CASE START-UP AND TESTING. FOR APPROVED CONTRACTOR, CONTACT VENDOR.

B. THE SPACE IS SERVED BY THE MUNICIPAL WATER AND SEWER SYSTEM UNLESS OTHERWISE NOTED.

C. ALL EQUIPMENT AND INSTALLATION WILL MEET NATIONAL SANITATION FOUNDATION STANDARDS OR EQUIVALENT.

D. EQUIPMENT UNITS SHALL CONTAIN NO EXPOSED THREADS, EMBELLISHMENTS OR OVERHANGING EDGES THAT SERVE AS PLACES FOR ACCUMULATION OF DUST, DIRT AND

E. WARMING OVEN(S) SHOWN FOR PERMITTING PURPOSES. INSTALLATION AT STORE OPENING TO BE VERIFIED BY STARBUCKS CONSTRUCTION REPRESENTATIVE.

F. EACH HAND WASHING SINK WILL HAVE A SINGLE SERVICE TOWEL AND SOAP DISPENSER, AND ALL HAND SINKS TO HAVE A COMBINATION FAUCET OR PREMIXING FAUCET.

G. FOR PLUMBING FIXTURES, REFER TO THE PLUMBING DESIGN PLAN. FOR DATA DEVICE SCHEDULE, REFER TO THE ELECTRICAL DESIGN PLAN

H. SEE SHEET I-601 FOR SCHEDULES.

#### **SHEET NOTES**

1. GENERAL CONTRACTOR TO REVERSE DOOR HINGE ON UNDER COUNTER REFRIGERATOR TO LEFT-HAND SWING, AS SHOWN.

2. SECURE LOCKERS TO WALL.

3. PLACE FIRE EXTINGUISHER IN WORKROOM PER FIRE INSPECTOR.

4. LOCATION OF ALL SWITCHING.

5. SEE ELEVATIONS FOR DISTRIBUTION OF CUP DISPENSERS.

6. GENERAL CONTRACTOR TO COORDINATE NEWSPAPER FIXTURE ORDERING. CONTACT TRIAD MANUFACTURING BY EMAIL (starbuckscs@triadmfg.com) OR BY PHONE (314-381-5280 X1111) TO ARRANGE SHIPMENT OF THE FIXTURE. ALLOW (5) DAY LEAD-TIME.

7. VENDOR TO INSTALL WATER SYSTEM PER MANUFACTURER'S INSTRUCTIONS. GC TO PROVIDE PLUMBING AND ELECTRICAL REQUIREMENTS.

8. DO NOT CAULK TRASH RINGS TO COUNTERTOPS.

9. INSTALL NEW MERCH BAYS AND CUBES AS INDICATED.

10. RECYCLING EDUCATION DISK. MOUNT ON CONDIMENT CART AS REQUIRED. SEE CASEWORK DETAIL FOR EXACT LOCATION.

11. ENERGY EDUCATION DISK. MOUNT ON DRINK RAIL AS REQUIRED. SEE CASEWORK DETAIL FOR EXACT

12. RESPONSIBLE MATERIALS EDUCATION DISK. SEE INTERIOR ELEVATIONS FOR MOUNTING HEIGHT AND LOCATION.

13. ALTERNATIVE TRANSPORTATION EDUCATION (BUS) DISK. MOUNT ON LIVE EDGE CUSTOMER COUNTERTOP AS REQUIRED. SEE CASEWORK DETAIL FOR EXACT

14. WASTE DIVERSION CONSTRUCTION MATERIALS EDUCATION DISK. SEE INTERIOR ELEVATIONS FOR MOUNTING HEIGHT AND LOCATION.



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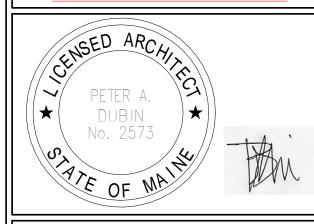
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	Revision Schedule						
Rev	Date	Ву	Description				

STREE PROJECT NAME:

COMMERCIAL

STORE #: 19384 PROJECT #: 58862-001 CONCEPT: MCS PALETTE: HERITAGE ISSUE DATE: JAN. 11, 2013 DESIGN MANAGER: E. ZAKAMAREK

LEED® AP:

PRODUCTION DESIGNER: NORR ILLINOIS CHECKED BY:

SHEET TITLE:

FF AND E PLAN

SCALE: SHEET NUMBER:

I-115



SWING, AS SHOWN. 2. SECURE LOCKERS 3. PLACE FIRE EXTIN INSPECTOR.

> 4. LOCATION OF ALL 5. SPEAKERS TO BE I PER CUTSHEET. 6. SEE ELEVATIONS F

DISPENSERS.

1. GENERAL CONTRA

ON UNDER COUNTER

7. GENERAL CONTRA NEWSPAPER FIXTUR MANUFACTURING BY OR BY PHONE (314-3 SHIPMENT OF THE FI

> 1. GENERAL CONT ON UNDER COUNT SWING, AS SHOW! 3. PLACE FIRE EXT

INSPECTOR.

4. LOCATION OF A 5. SEE ELEVATION DISPENSERS. 6. GENERAL CONT NEWSPAPER FIXT

MANUFACTURING

OR BY PHONE (314 SHIPMENT OF THE 7. REFER TO ENLA **ELEVATIONS FOR** MOUNTING HEIGH 8. INSTALL CUSTO INTEGRATED POW

**RUN UP TO TABLE** PENETRATION PLA DESIGN DETAILS F 9. VENDOR TO INS MANUFACTURER'S

PLUMBING AND EL

10. RECYCLING ED CONDIMENT CART DETAIL FOR EXAC 11. ENERGY EDUC FRONTBAR TOP C BAR PLAN ON CAS

LOCATION. 12. ALTERNATIVE DISK. SEE INTERIO HEIGHT AND LOCA

13. ALTERNATIVE DISK. SEE INTERIO HEIGHT AND LOCA 14. RESPONSIBLE

ON COMMUNITY T CASEWORK DETAI 15. REFER TO SHE

16. INSTALL EXTER REFER TO SHEET DETAILS. 17. DO NOT CAULK

18. INSTALL NEW N

1/4" = 1'-0"

#### **CASEWORK PLAN NOTES**

A. GENERAL CONTRACTOR TO NOTIFY STARBUCKS CONSTRUCTION MANAGER IMMEDIATELY IF A DISCREPANCY EXISTS BETWEEN CASEWORK SHOP DRAWINGS, SITE DIMENSIONS, CASEWORK PLAN OR ACTUAL CASEWORK FIXTURES. ALL DIMENSIONS TO BE TAKEN FROM DESIGNATED DATUM POINT.

B. STARBUCKS CONSTRUCTION MANAGER TO COORDINATE AND SCHEDULE CASEWORK DELIVERY DATE. GENERAL CONTRACTOR TO CONFIRM CASEWORK DELIVERY DATE WITH CASEWORK MANUFACTURER 4 WEEKS AND 1 WEEK PRIOR TO SCHEDULED DATE OF DELIVERY.

C. STARBUCKS CONTRACTS DIRECTLY WITH CASEWORK VENDOR TO SUPPLY CASEWORK LISTED IN CASEWORK SCHEDULE, UNLESS OTHERWISE NOTED.

D. REFER TO CASEWORK INSTALLATION MANUAL PROVIDED BY CASEWORK VENDOR FOR COMPLETE INSTALLATION INSTRUCTIONS.

E. ALL CASEWORK BASE UNITS SHALL BE SET ON 1/4" (6MM) NON-ABSORBENT PLASTIC SHIMS PROVIDED BY CASÉWORK VENDOR.

F. SEE WALL FINISH PLAN FOR LOCATION, TAGGING, AND FINISH SCHEDULES OF APPLIED WALL TREATMENTS.

G. INSTALL OVEN STAINLESS STEEL COUNTERTOP AND BASE CABINET WITH 1/2" (10MM) GAP BETWEEN ADJACENT COUNTERTOPS.

H. SEE REFLECTED CEILING PLAN FOR CASEWORK SOFFIT LOCATIONS.

J. SEE SCHEDULE SHEETS FOR SCHEDULES.

#### **SHEET NOTES**

1. REFER TO CASEWORK DETAIL SHEETS FOR ADDITIONAL INFORMATION.

2. INSTALL CHAIR RAIL AS INDICATED. REFER TO INTERIOR ELEVATIONS FOR CLARIFICATION.

3. INSTALL CUSTOM FRONTLINE CASEWORK AS INDICATED.

4. INSTALL CUSTOM CONDIMENT CART WITH TOE KICK

AS INDICATED.

5. INSTALL CUSTOM CUSTOMER COUNTERTOP / TOP CAP AS INDICATED. SEE DETAIL SHEETS FOR MORE INFORMATION.

6. INSTALL CUSTOM DRINK RAIL AS INDICATED.

7. INSTALL CUSTOM SIT-HERE COUNTERTOPS ON STANDARD BASES (REFER TO SHEET I-115 FOR MORE INFORMATION) AS INDICATED.

8. INSTALL WOOD WINDOW SILLS AS INDICATED.

9. INSTALL CUSTOM FIXED COMMUNITY TABLE WITH INTEGRATED POWER AS INDICATED. ELECTRICAL TO RUN UP TO TABLE TOP THROUGH LEG OF BASE. SEE PENETRATION PLAN FOR TRENCHING LOCATION AND DESIGN DETAILS FOR CLARIFICATION.

10. INSTALL FOOT RAILS AS INDICATED.

11. INSTALL CUSTOM MANAGERS DESK & SHELVING AS INDICATED. SEE INTERIOR ELEVATIONS FOR CLARIFICATION.

12. INSTALL WOOD TRIM AT CASED OPENINGS AS

13. INSTALL FULL-HEIGHT WOOD CLADDING PANELS AS INDICATED. SEE INTERIOR ELEVATIONS FOR CLARIFICATION.

14. INSTALL WOOD PANELING AT WINDOW OPENING SIDES AS INDICATED. SEE INTERIOR ELEVATIONS FOR CLARIFICATION.


15. INSTALL METAL CORNER GUARDS THROUGHOUT AS INDICATED. SEE INTERIOR ELEVATIONS FOR CLARIFICATION.

16. INSTALL CUSTOM BANQUETTE WITH INTERNAL STORAGE AS INDICATED. SEE INTERIOR ELEVATIONS FOR CLARIFICATION.

#### CASEWORK PLAN LEGEND

--- INDICATES CHAIR RAIL —— - - - — INDICATES WOOD CLADDING



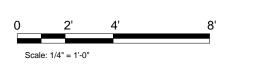





#### STARBUCKS COFFEE COMPANY


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Revision Schedule					
Rev	Date	Ву	Description		

STREE STREF 1101 UNTY PROJECT ADDRESS:
145 COMMERCIAL S
PORTLAND, ME 041
CUMBERLAND COU PROJECT NAME:

COMMERCIAL

STORE #: 19384 PROJECT #: 58862-001 CONCEPT: MCS PALETTE: HERITAGE ISSUE DATE: JAN. 11, 2013 DESIGN MANAGER: E. ZAKAMAREK LEED® AP: PRODUCTION DESIGNER: NORR ILLINOIS CHECKED BY:

SHEET TITLE:

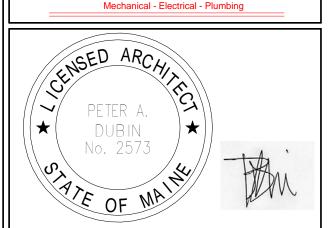**CASEWORK PLAN** 

1/4" = 1'-0"

SCALE: SHEET NUMBER:

I-116

Scale: 1/4" = 1'-0"

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### 1 UPPER CASEWORK PLAN Scale: 1/4" = 1'-0"

#### **UPPER CASEWORK PLAN NOTES**

A. GENERAL CONTRACTOR TO NOTIFY STARBUCKS CONSTRUCTION MANAGER IMMEDIATELY IF A DISCREPANCY EXISTS BETWEEN CASEWORK SHOP DRAWINGS. SITE DIMENSIONS, CASEWORK PLAN OR ACTUAL CASEWORK FIXTURES. ALL DIMENSIONS TO BE TAKEN FROM DESIGNATED DATUM POINT.

B. STARBUCKS CONSTRUCTION MANAGER TO COORDINATE AND SCHEDULE CASEWORK DELIVERY DATE. GENERAL CONTRACTOR TO CONFIRM CASEWORK DELIVERY DATE WITH CASEWORK MANUFACTURER 4 WEEKS AND 1 WEEK PRIOR TO SCHEDULED DATE OF DELIVERY.

C. STARBUCKS CONTRACTS DIRECTLY WITH CASEWORK VENDOR TO SUPPLY CASEWORK LISTED IN CASEWORK SCHEDULE, UNLESS OTHERWISE NOTED.

D. REFER TO CASEWORK INSTALLATION MANUAL PROVIDED BY CASEWORK VENDOR FOR COMPLETE INSTALLATION INSTRUCTIONS.

E. SEE WALL FINISH PLAN FOR LOCATION, TAGGING, AND FINISH SCHEDULES OF APPLIED WALL TREATMENTS.

F. SEE REFLECTED CEILING PLAN FOR CASEWORK SOFFIT LOCATIONS.

G. SEE SCHEDULE SHEETS FOR SCHEDULES.

#### **SHEET NOTES**

1. REFER TO CASEWORK AND CEILING DETAILS FOR ADDITIONAL INFORMATION.

2. INSTALL UPPER CUBBIES WITH FRENCH CLEAT AND LIGHT VALANCE AS INDICATED. RETURN LIGHT VALANCE TO WALL AT OPEN CUBBY ENDS.

3. INSTALL WOOD TRIM AT BACKBAR WALL TILE AS INDICATED. SEE INTERIOR ELEVATIONS FOR CLARIFICATION.

4. INSTALL CROWN MOULDING AT CEILING EDGE AS INDICATED. CAP OPEN ENDS AS REQUIRED.

5. INSTALL WOOD TRIM AT ACT CEILING TILE EDGE AS INDICATED.

6. INSTALL WOOD TRIM AT CASED OPENINGS AS INDICATED. GC TO ENSURE REQUIRED HEAD CLEARANCE IS MAINTAINED.

7. INSTALL WOOD TRIM AT SOFFIT AS INDICATED.

8. INSTALL RESERVE SHELVES AND BRACKETS AS INDICATED. SEE INTERIOR ELEVATIONS FOR MOUNTING



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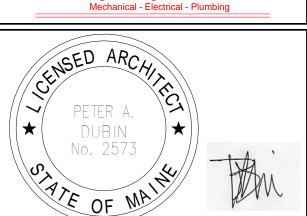
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Revision Schedule					
Rev	Date	Ву	Description		

## STREE

STORE #: 19384 PROJECT #: 58862-001 CONCEPT: MCS PALETTE: HERITAGE ISSUE DATE: JAN. 11, 2013 E. ZAKAMAREK DESIGN MANAGER: LEED® AP: PRODUCTION DESIGNER: NORR ILLINOIS

SHEET TITLE:

CHECKED BY:

**UPPER CASEWORK** PLAN

1/4" = 1'-0"


SCALE: SHEET NUMBER:

**UPPER CASEWORK LEGEND** 

- - - - CROWN MOULDING

— - - - — WOOD CEILING TRIM

— - - — 2IN WOOD TRIM AT BACKBAR TILE

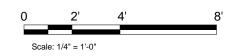



I-116.1

REFLECTED CEILING PLAN

Scale: 1/4" = 1'-0"

### REFLECTED CEILING PLAN NOTES

A. IF REQUIRED BY LOCAL CODE, GENERAL CONTRACTOR TO PROVIDE SEMI-RECESSED SPRINKLER HEADS WITH POLISHED CHROME ESCUTCHEONS CENTERED IN ACOUSTICAL CEILING TILE. IF PENDANT HEADS ARE REQUIRED IN GYPSUM SOFFIT OVER FRONTBAR, CONCEAL SUPPLY PIPING WITHIN SOFFIT. GENERAL CONTRACTOR TO SUBMIT SPRINKLER LAYOUT TO STARBUCKS' CONSTRUCTION MANAGER FOR APPROVAL PRIOR TO INSTALLATION.

B. GENERAL CONTRACTOR TO PROVIDE AND LOCATE SPRINKLERS PER LOCAL CODES. CONTACT STARBUCKS CONSTRUCTION MANAGER IF DESIGN INTENT IS AFFECTED.

C. WHERE ACOUSTICAL CEILING MEETS WALL, PROVIDE ANGLE WALL MOLDING FOR REVEAL. MATCH CEILING GRID COLOR WHEN APPLICABLE.

D. LEAVE (10) ADDITIONAL RETAIL CEILING TILES, TO MATCH RETAIL CEILING PAINT COLOR, ABOVE THE WORKROOM CEILING AT MANAGER'S DESK FOR FUTURE USE.

E. PROVIDE GROMMET AT ALL CEILING PENETRATIONS FOR FIXTURES OR SUPPORTS.

F. HEATING, VENTILATING, AND AIR CONDITIONING (HVAC) SHOWN FOR DESIGN INTENT ONLY. CONTACT PROJECT MANAGER IF CHANGED.

G. DIFFUSERS AND RETURNS AT BACKBAR IN ACOUSTICAL CEILING TILE TO BE CENTERED IN TILE, PAINTED TO MATCH ADJACENT FINISHES, TYPICAL.

H. PAINT ALL HVAC DUCTS, HVAC DIFFUSERS, RECESSED SPEAKERS AND LIGHT TRIM RINGS THE SAME COLOR AS CEILING OR SOFFIT. TYPICAL THROUGHOUT RETAIL PORTION OF STORE.

J. PAINT SUBSTITUTIONS ARE NOT ALLOWED. USE STARBUCKS' NATIONAL ACCOUNT "COLOR CODE" WHEN ORDERING PAINTS. SEE SCHEDULE SHEETS FOR SCHEDULES

K. SEE LIGHTING DESIGN PLAN FOR FIXTURE TYPES AND LOCATION DIMENSIONS.

#### **SHEET NOTES**

1. REFER TO SHEET I-117.1 FOR SOFFIT/CEILING DIMENSIONS.

2. REFER TO SHEET I-117.2 FOR LIGHTING DIMENSIONS.

3. REFER TO INTERIOR ELEVATIONS FOR PENDANT MOUNTING HEIGHTS AND EXTERIOR ELEVATIONS FOR SIGNAGE MOUNTING HEIGHTS.

4. REFER TO INTERIOR ELEVATIONS FOR MENU BOARD SPACING.

5. LOCATIONS OF ALL EGRESS LIGHTING FOR REFERENCE ONLY. GC TO VERIFY WITH LOCAL FIRE MARSHALL PRIOR TO INSTALLATION.

6. LOCATIONS OF ALL HVAC DUCTWORK AND GRILLES FOR REFERENCE ONLY. REFER TO MECHANICAL PLANS FOR SPECIFICATIONS.

7. GC TO COORDINATE SECURITY CAMERA QUANTITIES AND LOCATIONS WITH STARBUCKS CONSTRUCTION MANAGER.

8. EXTERIOR SIGNAGE BY SIGNAGE VENDOR TO BE PERMITTED SEPARATELY. NOT INCLUDED IN BUILDING CONTRACT.

9. GC TO PAINT ALL HVAC SUPPLY AND RETURN DIFFUSERS TO MATCH SURROUNDING CEILING COLOR.

10. SURFACE MOUNTED TRACK LIGHTING. ALIGN TRACK HEADS ABOVE MENU BOARDS / ARTWORK / MERCHANDISE BAYS.

11. INSTALL NEW SURFACE MOUNTED SPEAKERS AT MAXIMUM HEIGHT ALLOWABLE PER SPEC SHEETS.

12. PAINT GYPSUM BOARD CEILINGS AS INDICATED.

13. PAINT RECESSED LIGHTING TRIM TO MATCH CEILING AS CLOSELY AS POSSIBLE.

14. CENTER RECESSED CAN LIGHTS ON ACT TILES (WHEN APPLICABLE).

15. LOCATION OF ALL SWITCHING.

16. LINE OF BULKHEAD ABOVE.

17. INSTALL NEW CHANDELIER PENDANT ABOVE COMMUNITY TABLE AS INDICATED. SEE INTERIOR ELEVATIONS FOR MOUNTING HEIGHT.



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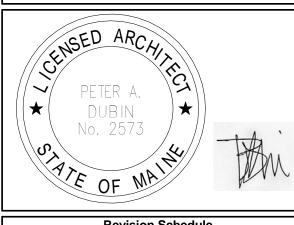


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Revision Schedule						
Rev	Date	Ву	Description			

PROJECT NAME:

COMMERCIAL STREET

145 COMMERCIAL STREET

PORTLAND, ME 04101

CUMBERLAND COUNTY

STORE #: 19384

PROJECT #: 58862-001

CONCEPT: MCS

PALETTE: HERITAGE

ISSUE DATE: JAN. 11, 2013

DESIGN MANAGER: E. ZAKAMAREK

LEED® AP:

PRODUCTION DESIGNER: NORR ILLINOIS

SHEET TITLE:

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REFLECTED CEILING PLAN

As indicated


SCALE:
SHEET NUMBER:

I-117

Y:\ME - 145 Commercial Street\_Portland\drawings\arch\Commercial St

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Scale: 1/4" = 1'-0"



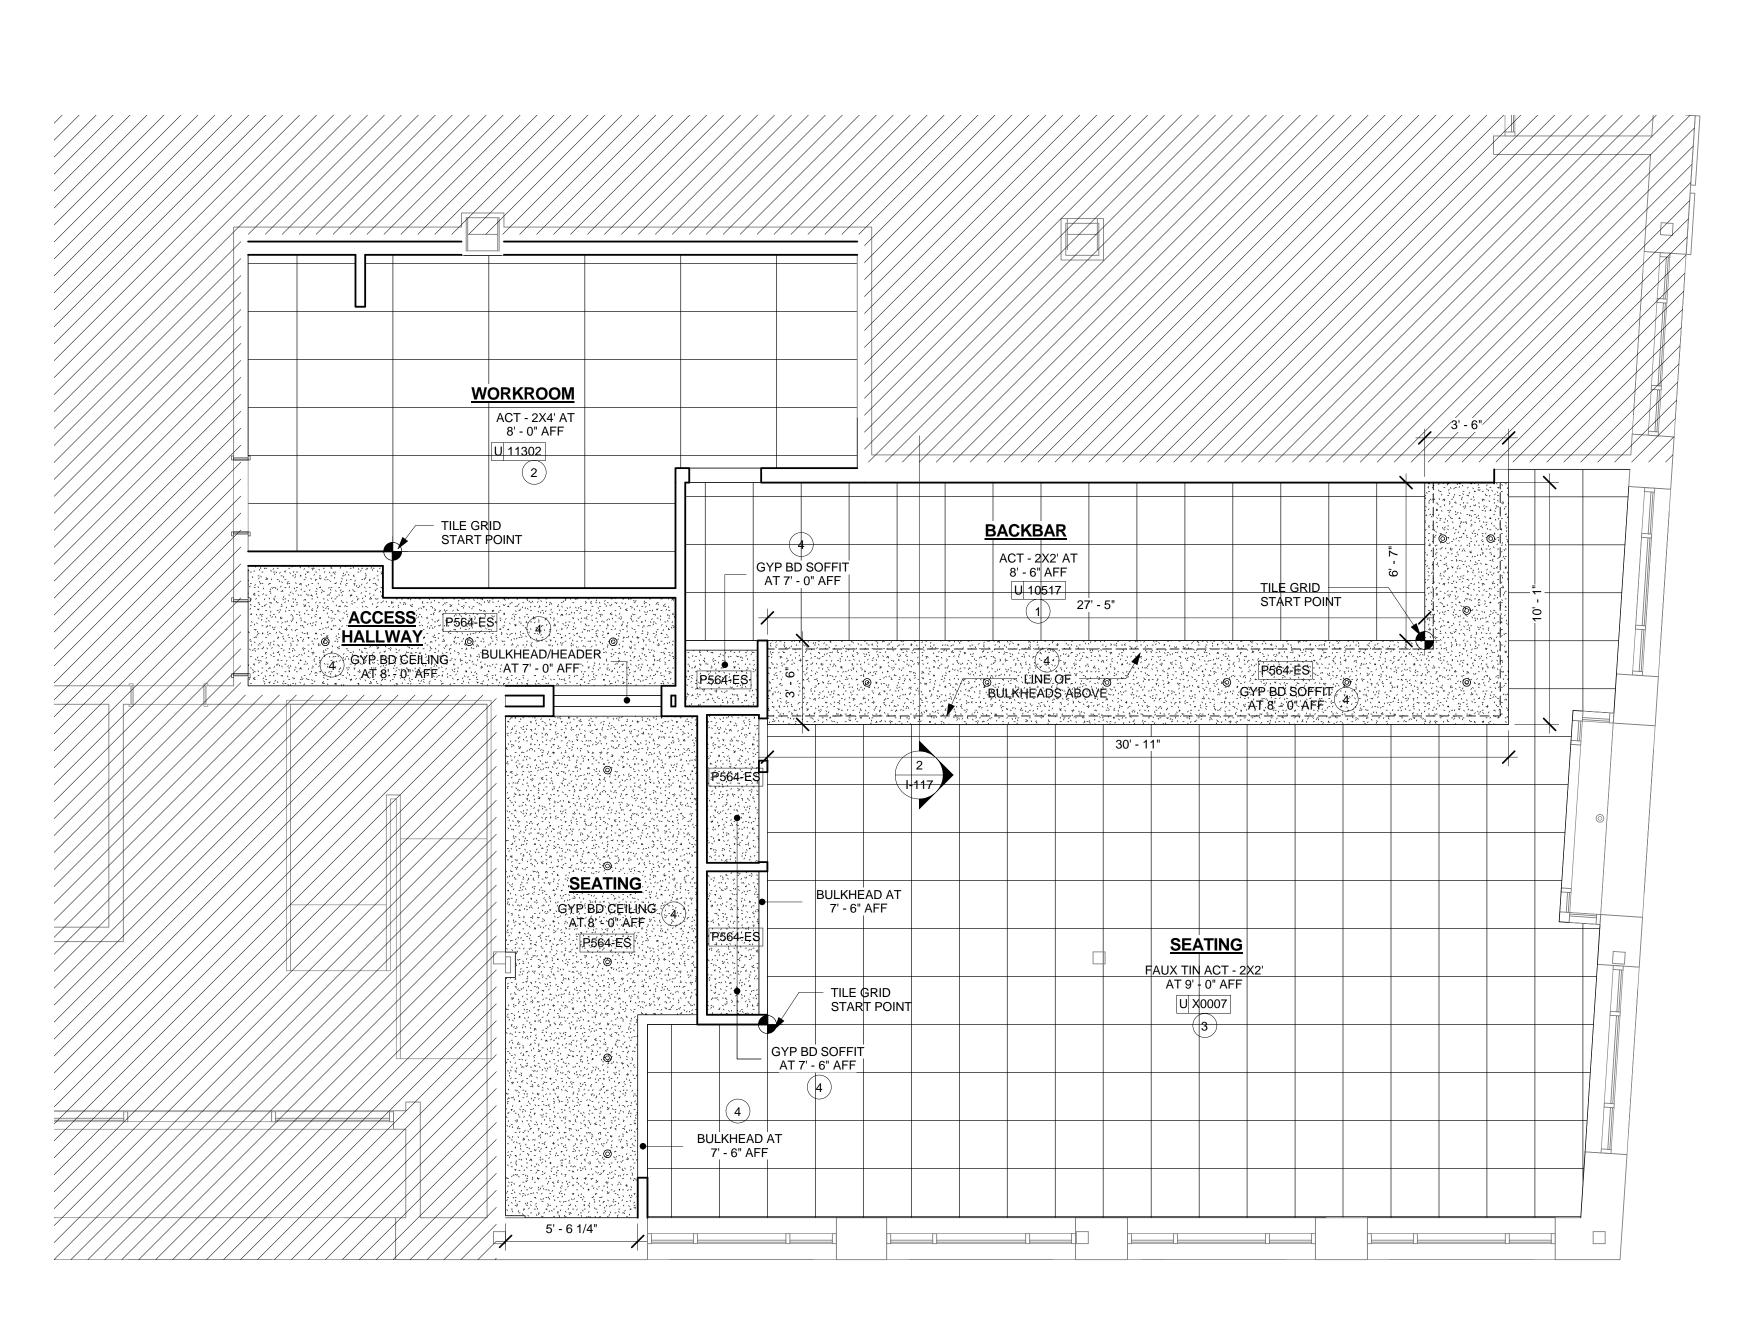

### <u>DIMENSIONED CEILING</u> <u>PLAN NOTES</u>

A. WHERE ACOUSTICAL CEILING MEETS WALL, PROVIDE ANGLE WALL MOULDING FOR REVEAL. MATCH CEILING GRID COLOR WHEN APPLICABLE.

B. PAINT SUBSTITUTIONS ARE NOT ALLOWED. USE STARBUCKS' NATIONAL ACCOUNT "COLOR CODE" WHEN ORDERING PAINTS. SEE SHEET I-602 FOR PAINT SCHEDULES.

#### SHEET NOTES

1. INSTALL 2X2' VINYL ACT CEILING AT BACKBAR AS

2. INSTALL 2X4' VINYL ACT CEILING AT WORKROOM AS INDICATED.

3. INSTALL 2X2' FAUX TIN ACT CEILING AT SEATING AS

4. CONSTRUCT BULKHEADS AND GYP BOARD SOFFITS AS INDICATED.



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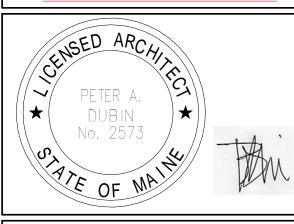
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Rev	Date	Ву	Description				
		-					

STREET PROJECT NAME:

COMMERCIAL STREE

PROJECT ADDRESS:

145 COMMERCIAL STREET
PORTLAND, ME 04101
CUMBERLAND COUNTY

STORE #: 19384 PROJECT #: 58862-001 CONCEPT: MCS PALETTE: HERITAGE ISSUE DATE: JAN. 11, 2013 DESIGN MANAGER: E. ZAKAMAREK LEED® AP: PRODUCTION DESIGNER: NORR ILLINOIS

SHEET TITLE:

CHECKED BY:

DIMENSIONED CEILING PLAN

1/4" = 1'-0"

SCALE: SHEET NUMBER:

I-117.1



#### **DIMENSIONED LIGHTING** PLAN NOTES

A. ALL FIXTURES IN FOOD PREPARATION AREA SHALL HAVE SHATTERPROOF LAMPS IF THE FIXTURE IS NOT

B. PROVIDE GROMMET AT ALL CEILING PENETRATIONS FOR FIXTURES/SUPPORTS.

C. ADJUST FOCUS OF ALL TRACK AND RECESSED DIRECTIONAL LIGHTING TO FULLY ILLUMINATE ALL ARTWORK, MENU BOARDS, AND MERCHANDISE BAYS.

D. IF PENDANT SUSPENDED LENGTH EXCEEDS 48" (1220MM) FROM CEILING, REPLACE WITH SURFACE-MOUNTED PENDANT AND SUSPEND WITH GC-SUPPLIED CONDUIT AND J-BIX TO DIMENSIONED HEIGHT.

E. CENTER EMERGENCY/EXIT LIGHTS ABOVE DOORS,

#### **SHEET NOTES**

1. SURFACE-MOUNT TRACK DIRECTLY TO ACT/GYP

2. SUSPEND WINDOW PENDANT WITH BOTTOM OF FIXTURE AT 5'-6" AFF. CENTER WITHIN WINDOW BAY. 3. CENTER RECESSED CAN LIGHTS ON ACT TILES (WHEN APPLICABLE).

4. SUSPEND LOGO DISK WITH CENTER OF FIXTURE AT 5'-3" AFF. CENTER DISKS WITHIN WINDOW BAY.

5. SEE EXTERIOR ELEVATIONS FOR EXTERIOR SIGNAGE MOUNTING HEIGHTS AND LOCATIONS.



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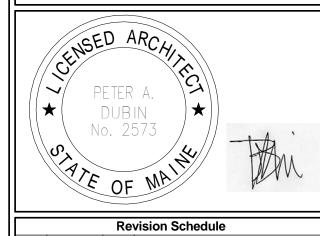
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ARCHITECT OF RECORD





Mechanical - Electrical - Plumbing



Revision Schedule					
Rev	Date	Ву	Description		

STORE #: 19384 PROJECT #: 58862-001 CONCEPT: MCS PALETTE: HERITAGE ISSUE DATE: JAN. 11, 2013 DESIGN MANAGER: E. ZAKAMAREK

PRODUCTION DESIGNER: NORR ILLINOIS

LEED® AP:

DIMENSIONED LIGHTING PLAN

1/4" = 1'-0"

SCALE: SHEET NUMBER:

I-117.2

shatterproof lamps of Record to verify B. Provide gromme fixtures/supports. C. Center emerger ©2011 STARBUCKS COFFEE COMPANY

otherwise noted. D. Adjust focus of lighting to fully illur merchandise bays

A. All fixtures in foo

E. Indicates existing F. If pendant cylind 48" (1220mm) from mounted cylinder of Contractor supplie

 Surface-mount tra 2. Suspend track with 3. Suspend bottom of

AFF unless otherwise


4. Suspend bottom of unless otherwise not 5. Suspend bottom of AFF unless otherwise 6. Suspend bottom of

See interior elevation side tables as indicat 7. GC to relocate exi wall of chill as indicate 8. Suspend bottom of

AFF unless otherwise

heights (5'-6" AFF, 7

9. Landlord to install

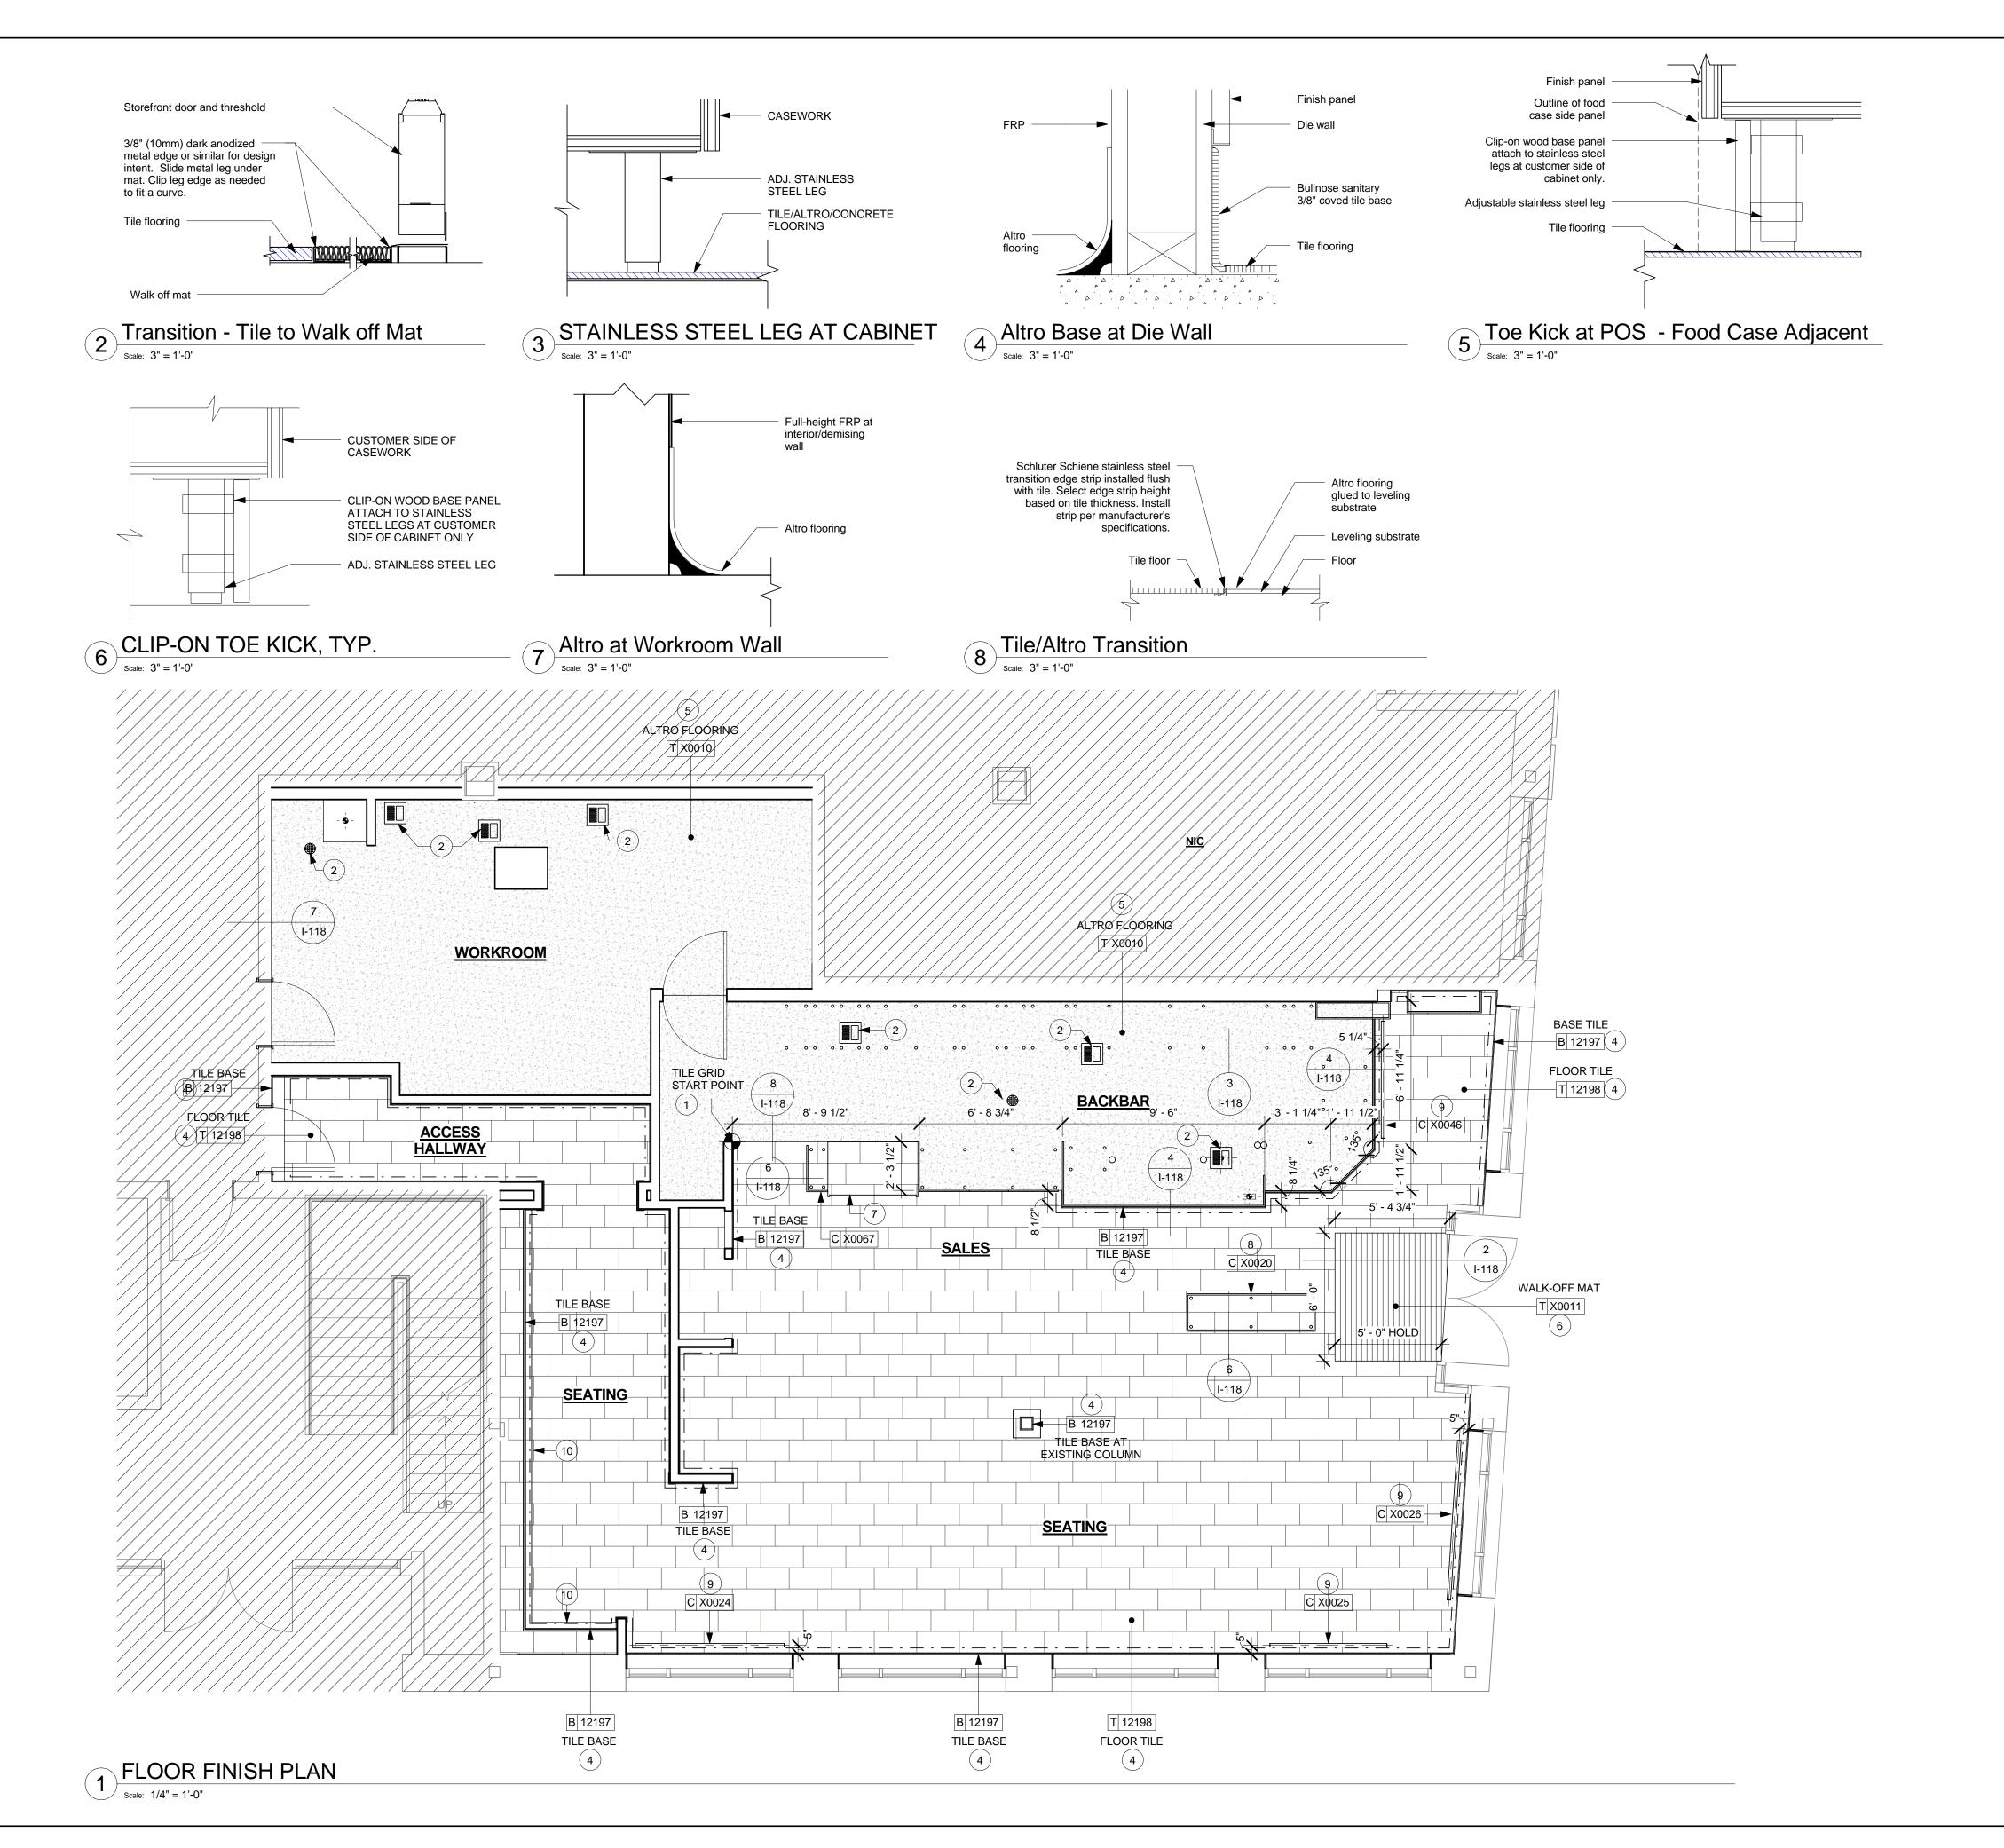

#### FLOOR FINISH PLAN NOTES

A. STARBUCKS TO SUPPLY RETAIL FLOOR TILE AND TILE BASE. GENERAL CONTRACTOR TO INSTALL. GENERAL CONTRACTOR TO SUPPLY WORKROOM TILE AND BASE AND INSTALL. GENERAL CONTRACTOR TO SUPPLY AND INSTALL MORTAR, ADHESIVE, AND GROUT. GENERAL CONTRACTOR TO INSPECT ALL TILES AND REJECT DAMAGED OR SUBSTANDARD TILES PRIOR TO INSTALLATION.

B. ALL TILE AND SLATE TO BE INSTALLED PER TILE COUNCIL OF AMERICA STANDARDS.

C. ALL FLOORING AND BASE MATERIAL TO BE INSTALLED ACCORDING TO STARBUCKS SPECIFICATIONS.

D. CABINET BASES TO BE SET AFTER TILE INSTALLATION.

E. ALIGN TILE TRANSITIONS ON WHOLE TILES AS SHOWN.

#### SHEET NOTES

HALLWAY AS INDICATED.

1. TILE START POINTS WHERE INDICATED.

2. FLOOR SINK/FLOOR DRAIN LOCATION.

3. ALIGN TILE TRANSITION WITH FACE OF WALL/SURFACE.4. INSTALL FLOOR TILE AND BASE AT SEATING AND ACCESS

5. INSTALL ALTRO FLOORING AT BACKBAR AND WORKROOM AS INDICATED.

6. INSTALL WALK OFF MAT AT ENTRY AS INDICATED. HOLD 6IN MIN CLEARANCE BETWEEN WALK OFF MAT AND WALL/GLAZING AS INDICATED. INSTALL FLUSH WITH TILE

7. PASTRY CASE FOOTPRINT.

8. INSTALL TOE KICK AT CUSTOM CONDIMENT CART AS INDICATED.

9. INSTALL FOOT RAILS AS INDICATED.

PER MANUFACTURER'S SPECIFICATIONS.

10. BANQUETTE FOOTPRINT.

FLOOR FINISH LEGEND

ALTRO FLOORING ID: X0010

WALK-OFF MAT ID: X0011

- - - - TILE BASE - RUST BROWN - 6X12IN ID: 12197

TILE - RUST BROWN - 12X24IN ID: 12198

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ARCHITECT OF RECORD

1. TILE ST

2. FLOOR

3. ALIGN T

WALL/SUR

4. INSTALL

INDICATE

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IN BACKBA

5. INSTALL

AND PATIO

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INDICATE

CLEARAN

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TO ALLOW

MANUFAC

6. INSTALL

RR VESTIE

AS INDICA

8. PASTRY

9. INSTALL TOE KICK

10. INSTAL AT ENTRY

ARCHITECTS PLANNERS
325 N. LaSalle St. |Suite 700 | Chicago, IL 60654
t 312.424.2400 | f 312.424.2424 | www.norr.com



PETER A.

DUBIN
No. 2573

OF MAIN

	Revision Schedule					
Rev	Date	Ву	Description			

PROJECT NAME:

COMMERCIAL STREET
145 COMMERCIAL STREET
PORTLAND, ME 04101
CUMBERLAND COUNTY

F O F 4 G	O		
STORE #:	19384		
PROJECT #:	58862-001		
CONCEPT:	MCS		
PALETTE:	HERITAGE		
ISSUE DATE:	JAN. 11, 2013		
DESIGN MANAGER:	E. ZAKAMAREK		
LEED® AP:			
PRODUCTION DESIGNER:	NORR ILLINOIS		
CHECKED BY:			

SHEET TITLI

FLOOR FINISH PLAN

As indicated

SCALE:
SHEET NUMBER:

I-118

V-IME 115 Commorcial Stroot Bortland/drawings/arch/Commorcial Stroot ME On

4

#### WALL FINISH PLAN NOTES

A. WORKROOM TO BE FINISHED PER LOCAL CODE REQUIREMENTS.

B. INSTALL CLEAR CORNER GUARDS AS INDICATED. MOUNT AT 6" (150MM) AFF. BACK-PAINT WITH CORRESPONDING WALL COLOR. ADHERE WITH CLEAR SILICONE ADHESIVE AND #6 STAINLESS STEEL OVAL HEAD SCREWS 3" (75MM) FROM ENDS, 12" (305MM) ON CENTER. OFFSET SCREWS ON EITHER SIDE BY 1/2" (10MM) VERTICALLY. CUT CORNER GUARDS TO FIT BELOW CHAIR RAIL AT APPLICABLE LOCATIONS. DO NOT INSTALL CORNER GUARDS ABOVE CHAIR RAIL.

C. INSTALL METAL CORNER GUARDS AS INDICATED. MOUNT AT 6" (150MM) AFF. AFFIX WITH #6 STAINLESS STEEL OVAL HEAD SCREWS 3" (75MM) FROM ENDS, 12" (305MM) ON CENTER OFFSET SCREWS ON EITHER SIDE BY 1/2" (10MM) VERTICALLY. TO BE INSTALLED IN BACK OF HOUSE ONLY.

D. CHANGE OF PAINT COLOR ALLOWED AT INSIDE CORNERS

E. REFER TO INTERIOR ELEVATIONS FOR GRAPHICS LOCATIONS.

F. REFER TO CASEWORK FINISH SCHEDULE FOR ADDITIONAL INFORMATION

G. GENERAL CONTRACTOR TO PROVIDE AND INSTALL WORKROOM WALL FINISHES.

#### **SHEET NOTES**

1. INSTALL VINYL WAINSCOT AS INDICATED. SEE INTERIOR ELEVATIONS FOR INSTALLATION HEIGHT.

2. INSTALL FULL HEIGHT FRP AT WORKROOM WALLS AS INDICATED.

3. GC TO INSTALL BACKBAR WALL TILE AS INDICATED ON INTERIOR ELEVATIONS. BACKBAR TILE TO RUN BEHIND WARMING OVEN TO TOP OF BASE TILE.

4. INSTALL 2IN WOOD TRIM AT HORIZONTAL WALL TILE TERMINATIONS AS INDICATED ON INTERIOR ELEVATIONS. REFER TO SHEET I-116.1 FOR LOCATIONS.

5. INSTALL FRP AT WALLS BELOW BACKBAR COUNTERTOPS AS INDICATED.

6. INSTALL HOT-ROLLED STEEL CORNER GUARDS AS INDICATED. SEE INTERIOR ELEVATIONS FOR LENGTHS

7. INSTALL WOOD PANELING AT WINDOW OPENING SIDES AS INDICATED. SEE INTERIOR ELEVATIONS FOR CLARIFICATION.

8. INSTALL FULL-HEIGHT WOOD CLADDING PANELS AS INDICATED. SEE INTERIOR ELEVATIONS FOR CLARIFICATION.

9. REFER TO SHEETS I-506 & I-507 FOR WALL FINISH DETAILS.

10. PROVIDE FIRE TREATED WOOD BLOCKING AS REQUIRED TO SUPPORT ANY WALL ATTACHMENTS

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1. INSTALL FIBER

AS INDICATED. S INSTALLATION HI

2. INSTALL CUST **BELOW CUSTOM** 

INDICATED. SEE

CLARIFICATION.

3. INSTALL FULL

AS INDICATED.

4. GC TO INSTALI ON INTERIOR ELI

**BEHIND WARMIN** 

5. INSTALL 2IN W

TERMINATIONS A

ELEVATIONS. RE

6. PROVIDE FIRE

REQUIRED TO SU

7. INSTALL HOT-F

CORNERS OF FIE

8. INSTALL FULL-

9. HORIZONTAL N

RETURN TO WINI WINDOWS (TYP).


10. BACKBAR WA TO MULLIONS WI

AS INDICATED.

11. REFER TO SH DETAILS.

INDICATED.

Engineering Consultants Mechanical - Electrical - Plumbing

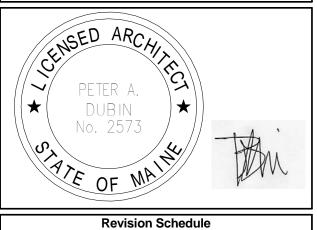

Rev	Date	Ву	Description				

STREE PROJECT NAME:

COMMERCIAL

STORE #: 19384 PROJECT #: 58862-001 CONCEPT: MCS PALETTE: HERITAGE ISSUE DATE: JAN. 11, 2013 DESIGN MANAGER: E. ZAKAMAREK LEED® AP: PRODUCTION DESIGNER: NORR ILLINOIS CHECKED BY:

SHEET TITLE:

WALL FINISH PLAN

SCALE:

SHEET NUMBER:


I-119

WALL TREATMENT LEGEND

— - — - — INDICATES FRP PANELING — - - - — - - - — INDICATES BACKBAR WALL TILE —— - - — - - — INDICATES 2IN WOOD TRIM —— – – — INDICATES WOOD WALL CLADDING

---- INDICATES WAINSCOT

INDICATES WAINSCOT VERTICAL TRIM AND/OR CORNER GUARD

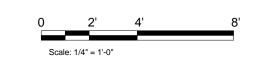




WALL FINISH PLAN

Scale: 1/4" = 1'-0"

1/4" = 1'-0"

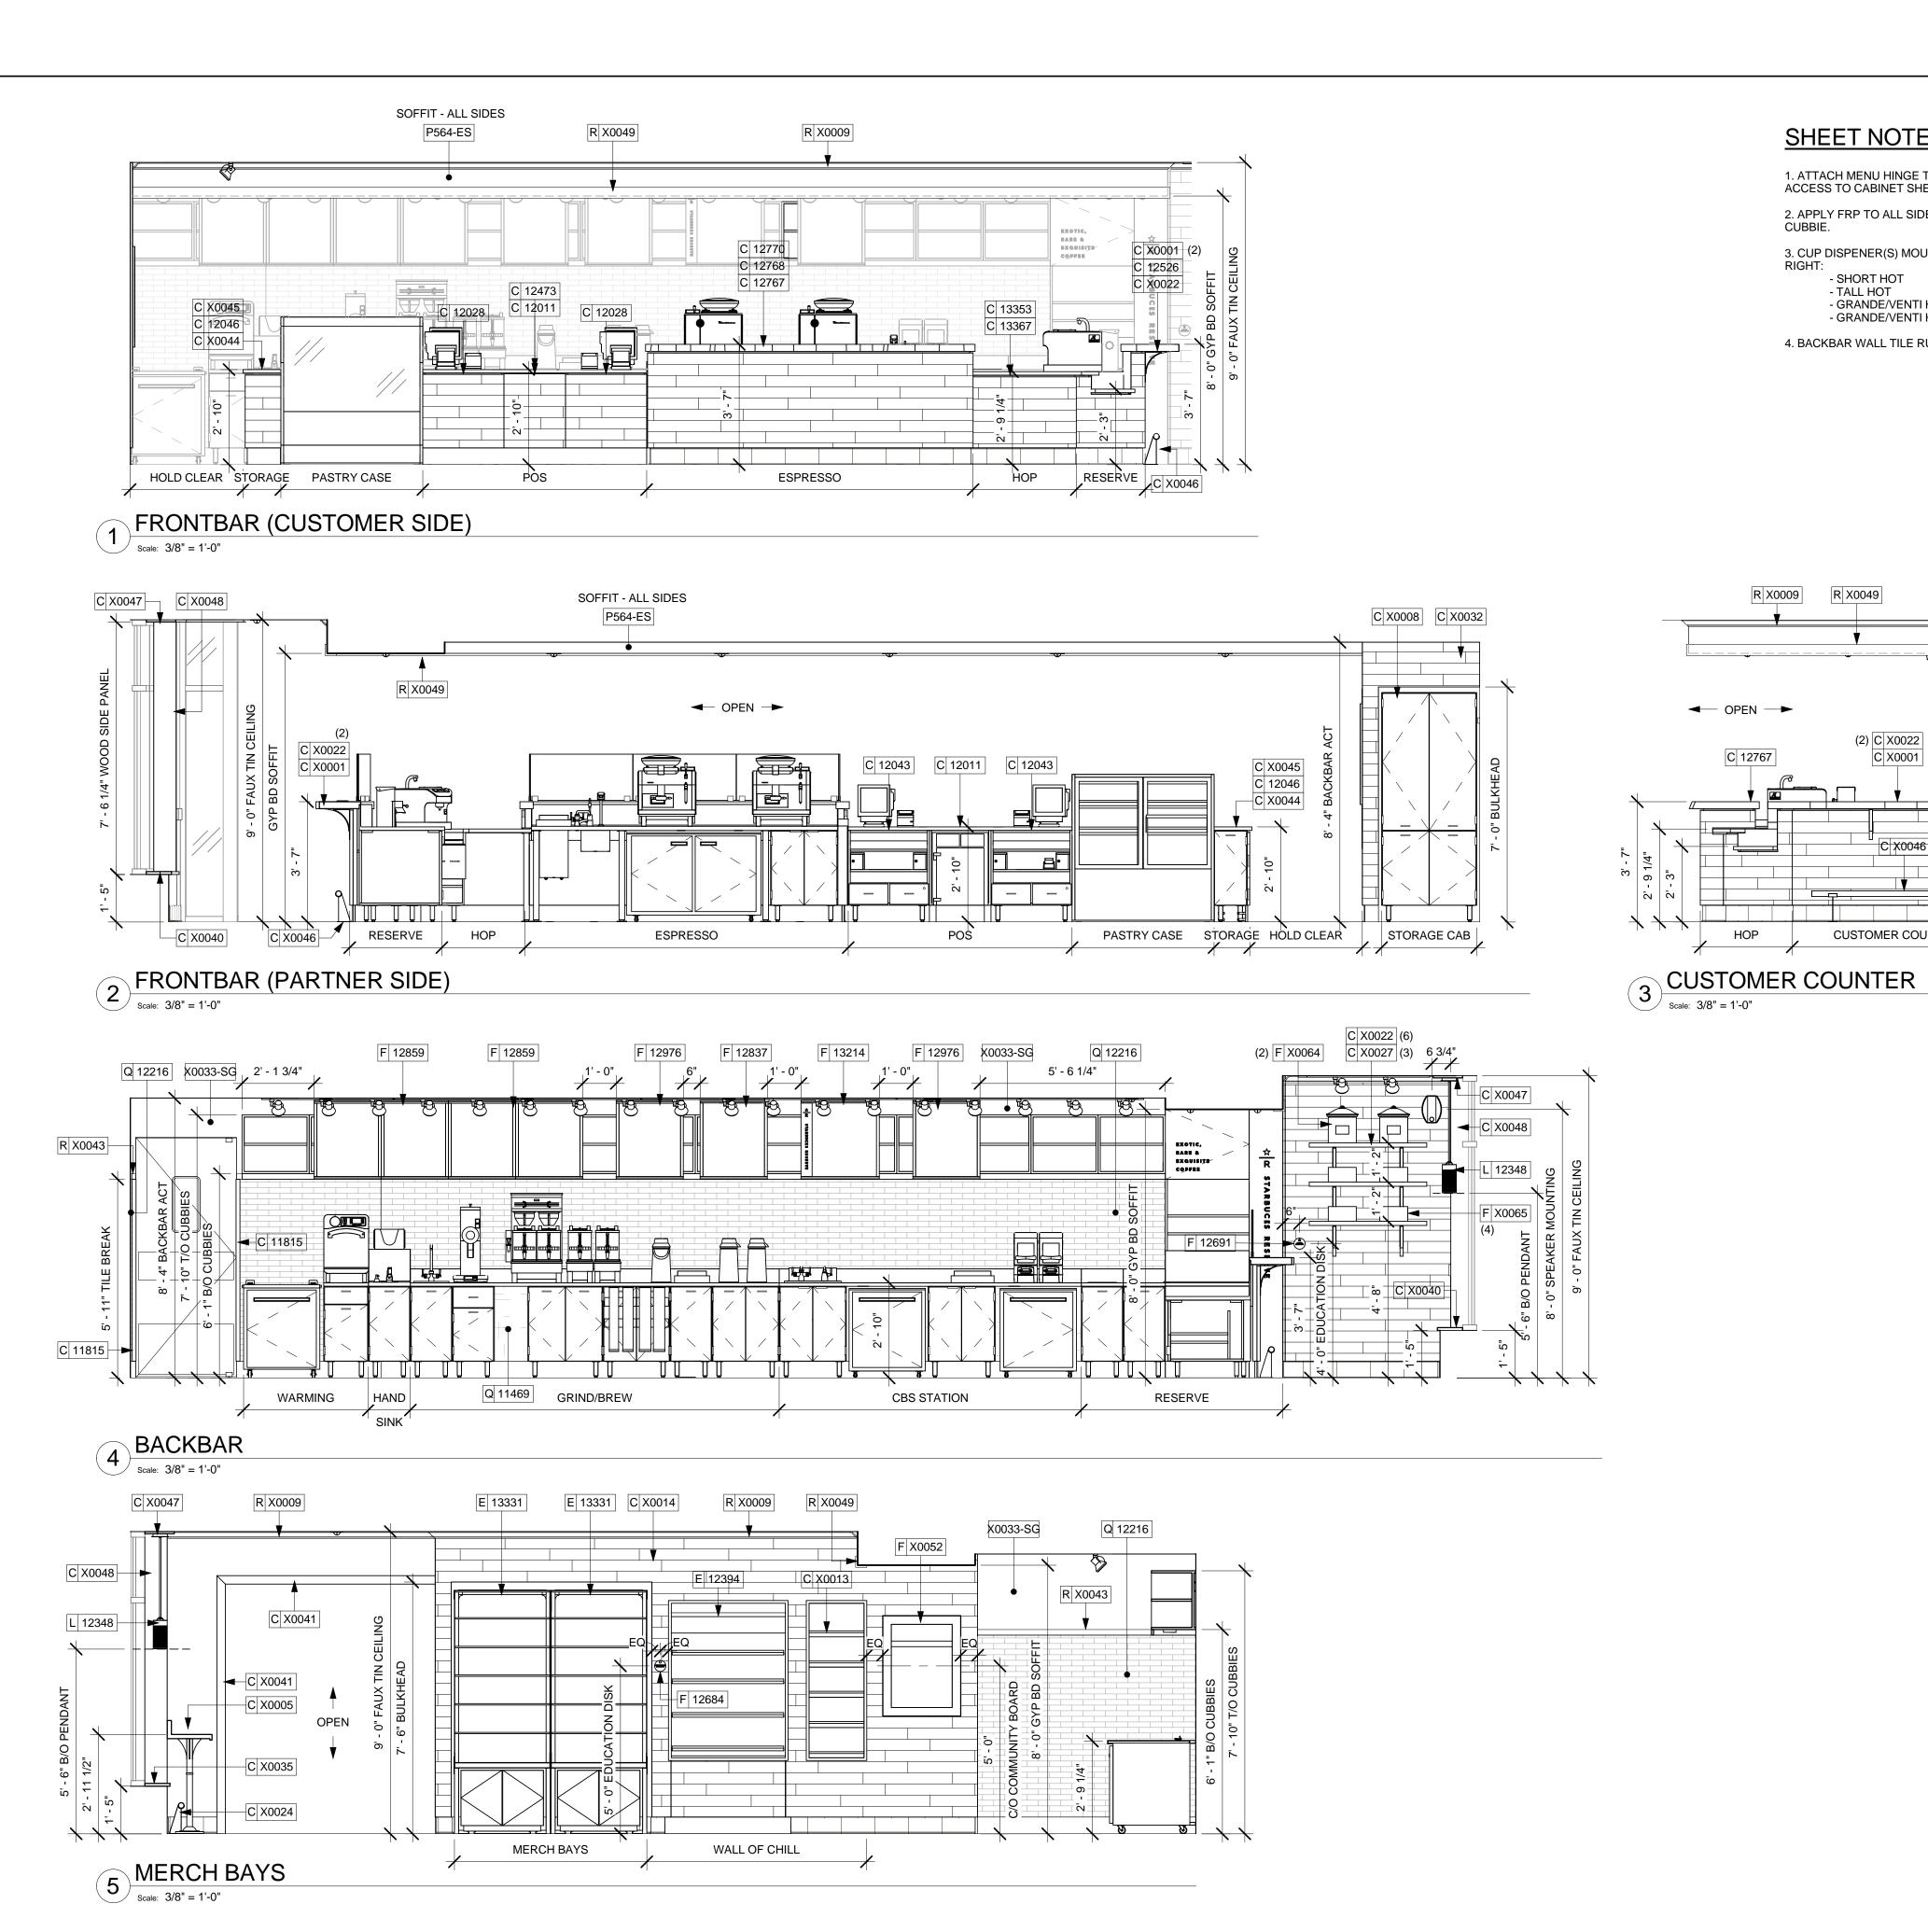

#### **SHEET NOTES**

1. ATTACH MENU HINGE TO TOP OF CABINET TO ALLOW ACCESS TO CABINET SHELVES BEHIND, TYPICAL. 2. APPLY FRP TO ALL SIDES OF CHASE INTERIOR BEHIND

3. CUP DISPENER(S) MOUNTING ORDER FROM LEFT TO

- SHORT HOT - TALL HOT - GRANDE/VENTI HOT

R X0049

(2) C X0022

C X0001

CUSTOMER COUNTER

R X0009

- GRANDE/VENTI HOT

4. BACKBAR WALL TILE RUNS BEHIND WARMING STATION.

#### **INTERIOR ELEVATION NOTES**

A. REFER TO MANUFACTURERS' INSTRUCTIONS SHIPPED WITH ARTWORK FOR INSTALLATION INSTRUCTIONS AND SPACING.

B. INSTALL WALL CABINETS BEFORE BACKBAR WALL TILE. RUN BACKBAR WALL TILE TO UNDERSIDE OF WALL CABINETS, NOT BEHIND CABINETS.

C. PAINT SUBSTITUTIONS ARE NOT ALLOWED. USE STARBUCKS' NATIONAL ACCOUNT "COLOR CODE" WHEN ORDERING PAINTS.

D. PAINT FINISHES SHALL BE APPLIED AS FOLLOWS, UNLESS OTHERWISE NOTED;

- ALL WOOD AND METAL SURFACES SHALL BE PAINTED SEMIGLOSS, OR EQUAL. - ALL ACCENT AND TRIM PAINT TO BE SEMIGLOSS,

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E. FOR PAINT, WALL TREATMENT, AND GRAPHICS SCHEDULES, REFER TO SCHEDULE SHEETS.



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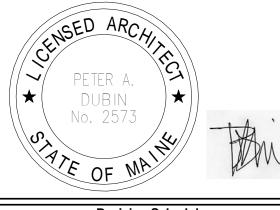
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Engineering Consultants Mechanical - Electrical - Plumbing



Revision Schedule					
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STREE<sup>-</sup> PROJECT ADDRESS:
145 COMMERCIAL STREET
PORTLAND, ME 04101
CUMBERLAND COUNTY PROJECT NAME:

COMMERCIAL

STORE #: 19384 PROJECT #: 58862-001 MCS CONCEPT: PALETTE: HERITAGE ISSUE DATE: JAN. 11, 2013 E. ZAKAMAREK DESIGN MANAGER: LEED $^{ extsf{R}}$ AP: PRODUCTION DESIGNER: NORR ILLINOIS

SHEET TITLE:

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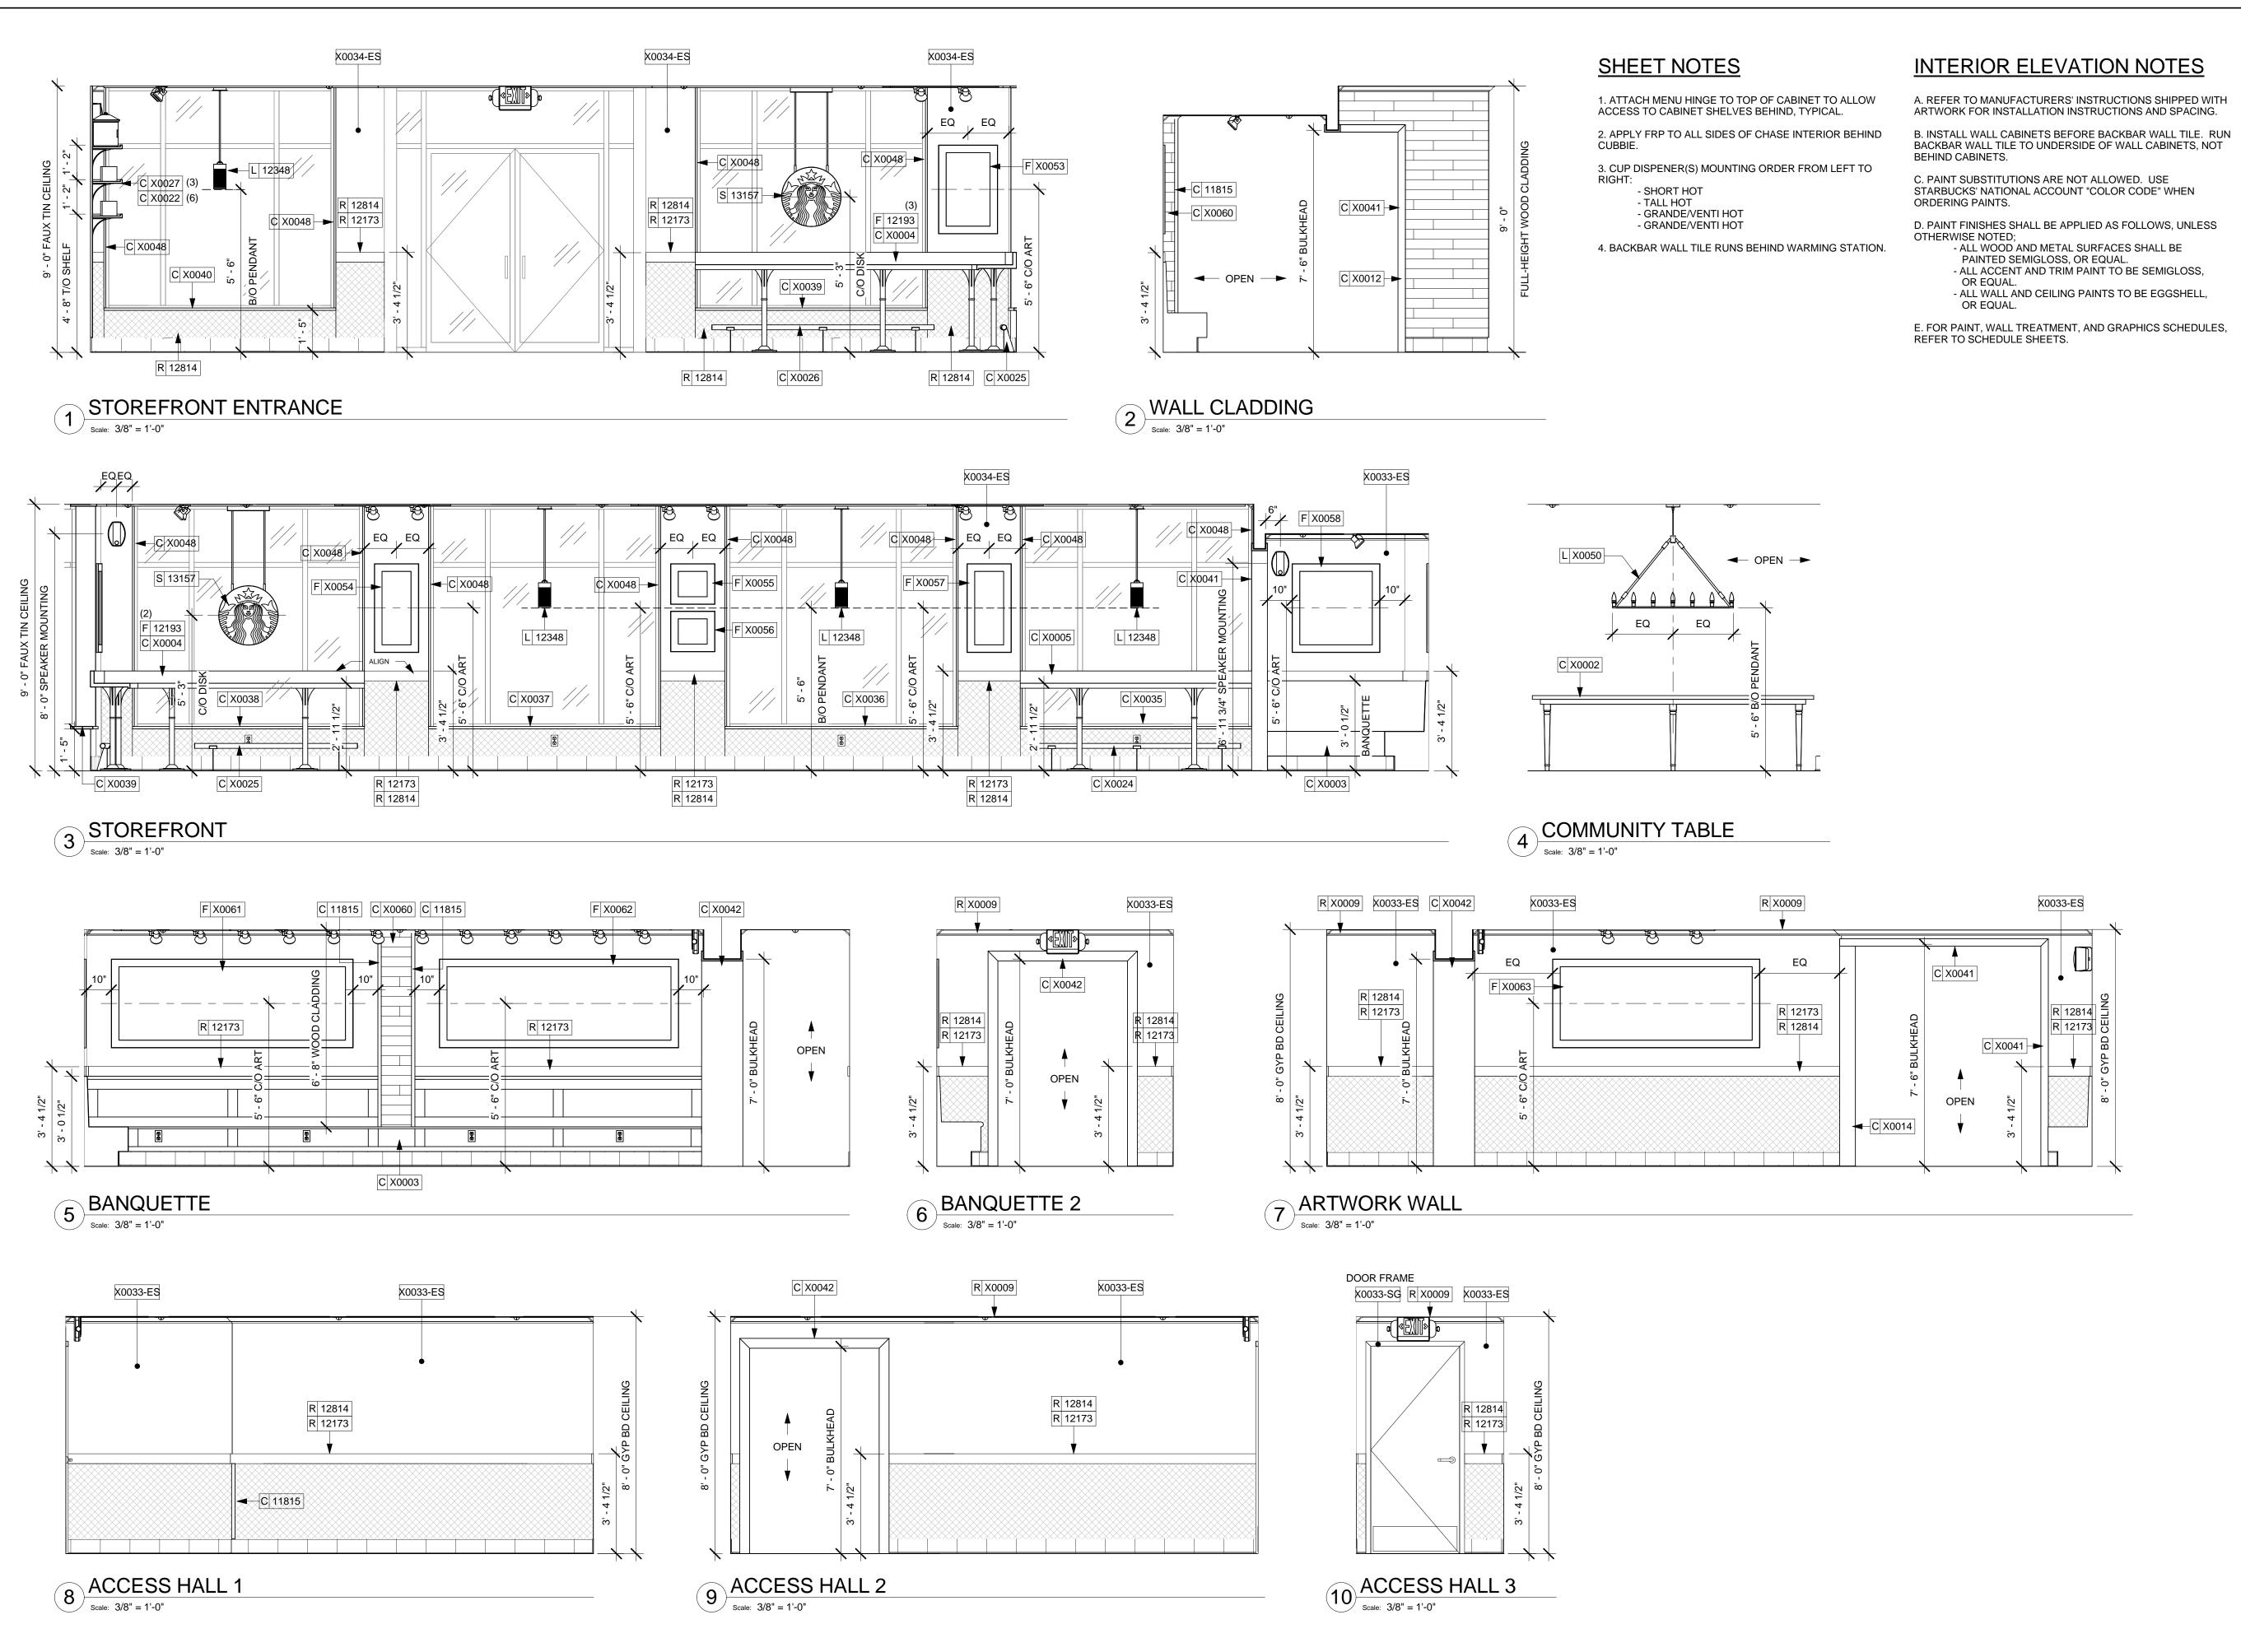
SCALE:

**INTERIOR ELEVATIONS** 

As indicated

SHEET NUMBER:

I-201





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SEATTLE, WASHINGTON 98134

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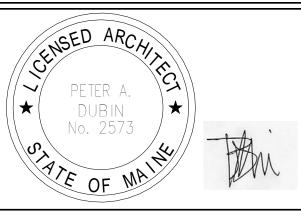
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PRODUCTION DESIGNER: NORR ILLINOIS

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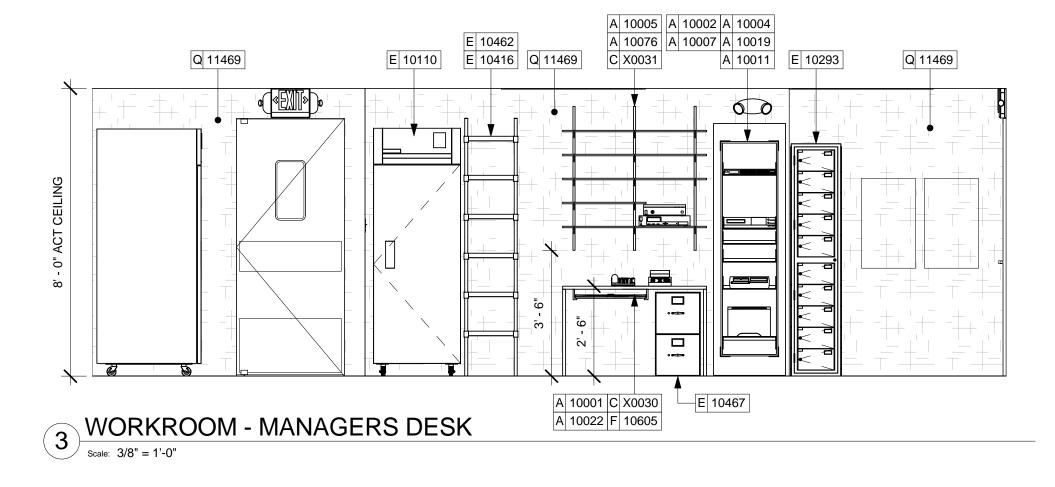
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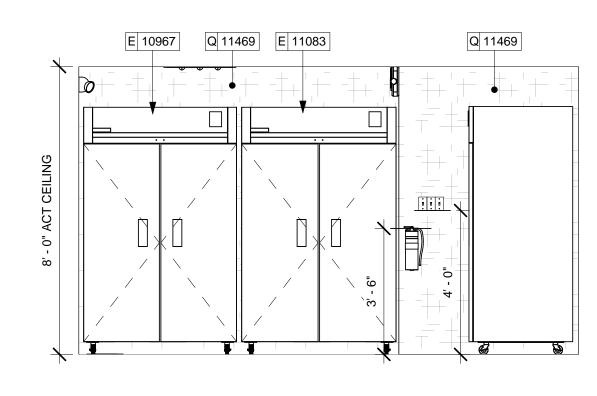
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SHEET NUMBER:

I-202


As indicated





WORKROOM - SWITCHING

| Scale: 3/8" = 1'-0"

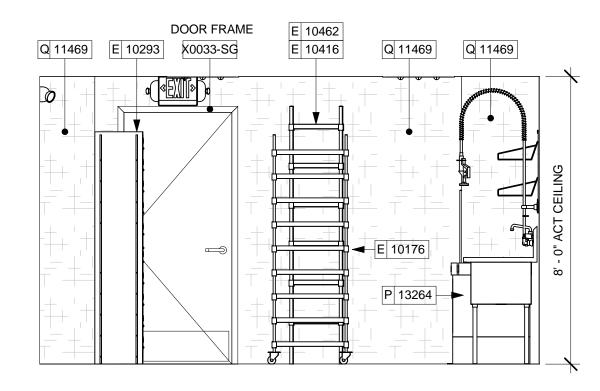

WORKROOM - ACCESS DOOR

| Scale: 3/8" = 1'-0"

#### **SHEET NOTES**

- 1. ATTACH MENU HINGE TO TOP OF CABINET TO ALLOW ACCESS TO CABINET SHELVES BEHIND, TYPICAL.
- 2. APPLY FRP TO ALL SIDES OF CHASE INTERIOR BEHIND CUBBIE.
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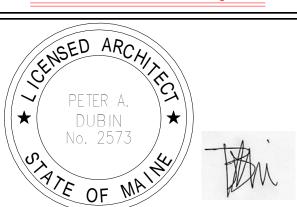
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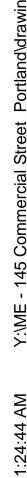
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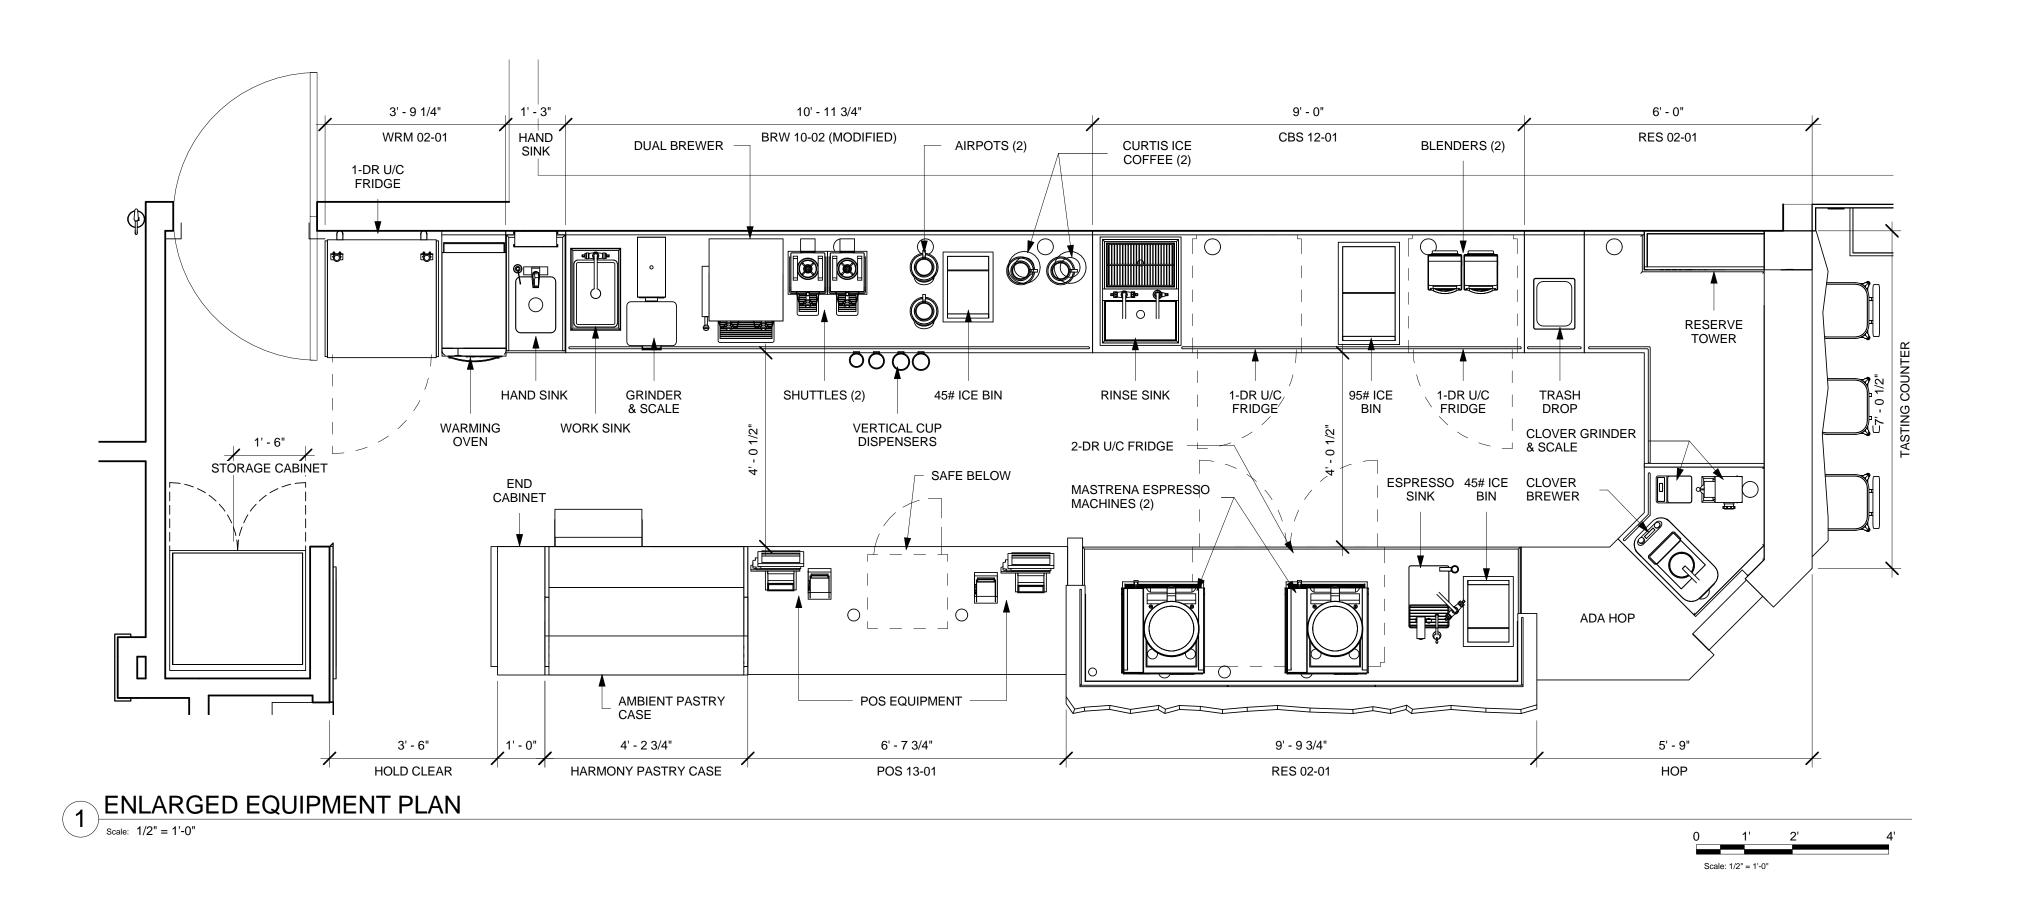
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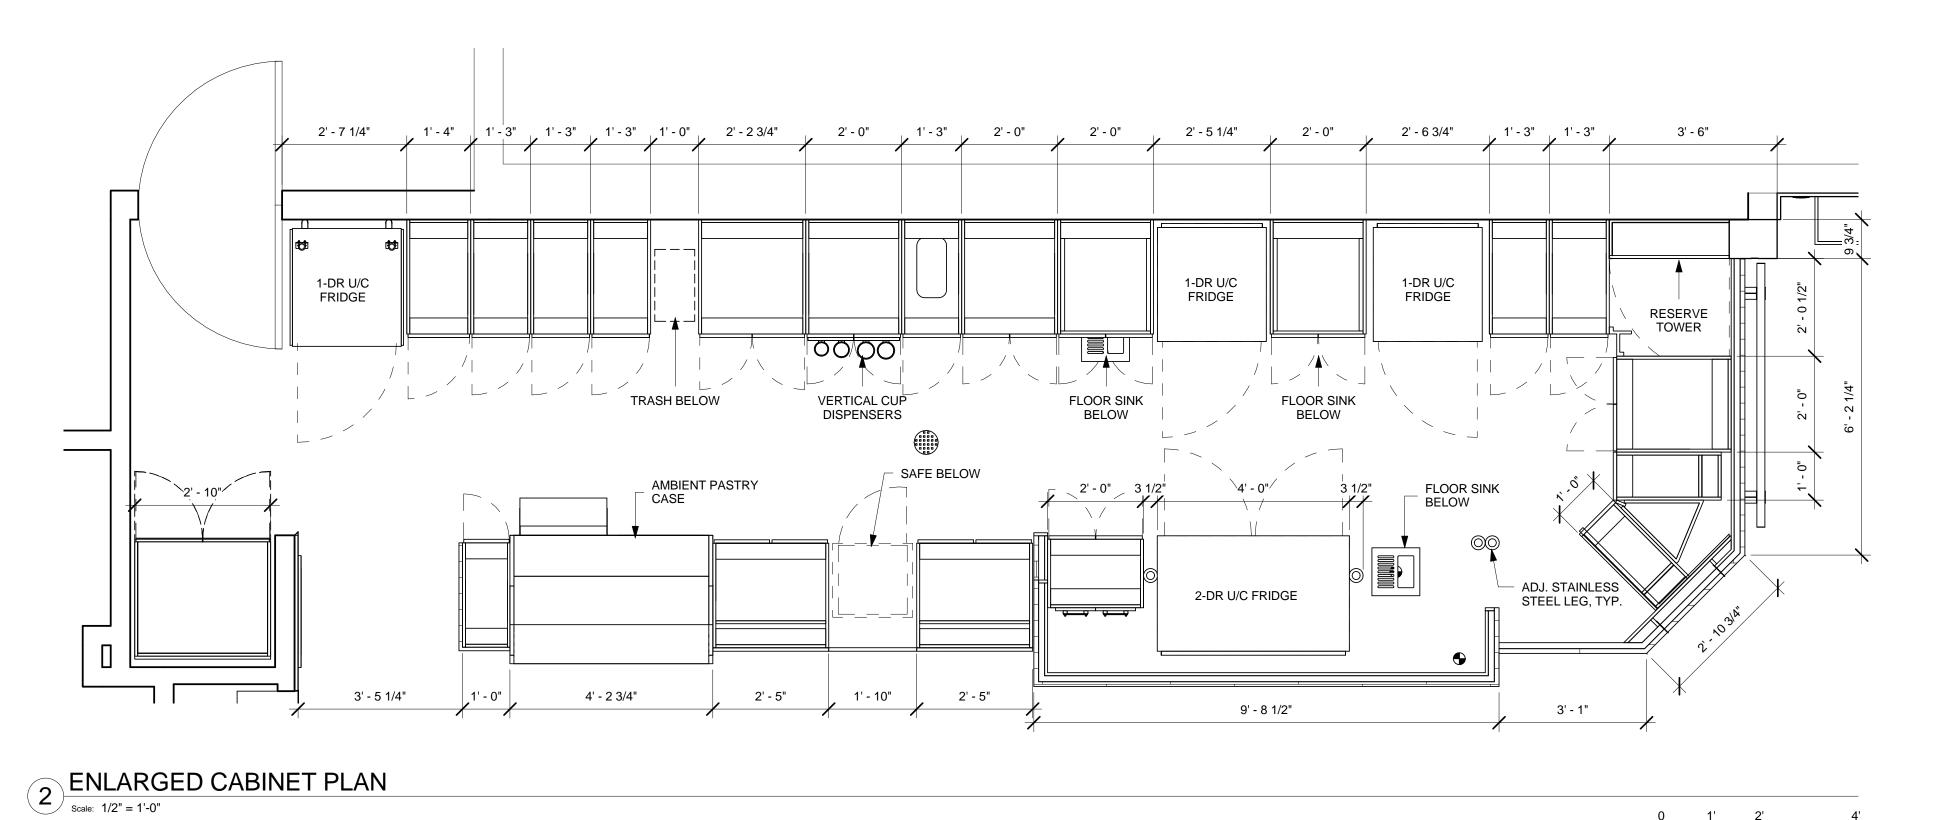
I-203


INTERIOR ELEVATIONS

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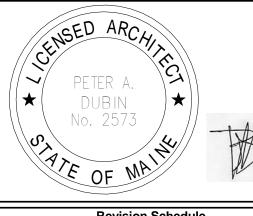
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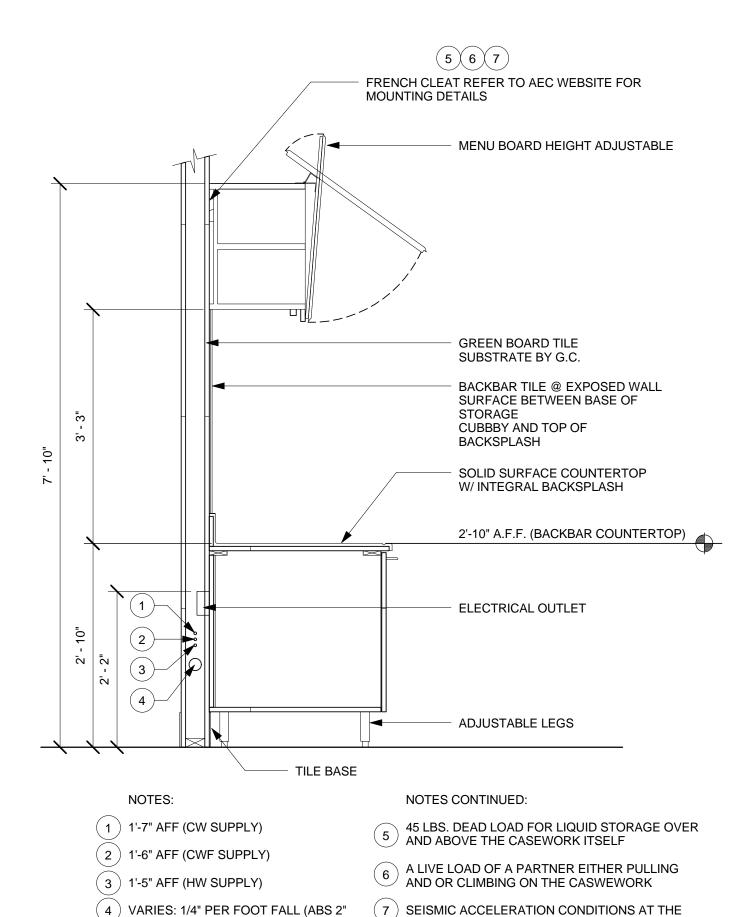
SHEET TITLE:

**ENLARGED BAR PLANS** 

SCALE: SHEET NUMBER:

I-401

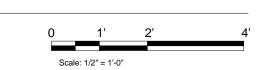1/2" = 1'-0"




3' - 7" AFF 1" x 2" Cont. Galc. Stl. Angle Stainless Steel Barista Countertop Casework Panels Attached to Die wall with Cleat System 2'-10" AFF (Countertop) All Plumbing Lines to be Mounted 1" (Nominal) From Wall For Cleaning 2'-2" AFF (Elec. J-Boxes) 1'-7" AFF (CW Supply) Front Bar Die Wall @ Barista 1'-6" AFF (CWF Supply) 1'-5" AFF (HW Supply) varies; 1/4" per ft. Fall (ABS 2" Waste Line) Continuous Metal Angle Removable Cabinet Back Panel Mounted to Plywood Wall, Under Finish Panels FRP Interior Surface Tile Base 6" Adjustable Metal Legs

Seal Stainless Steel Sidesplash to Top Cap


Wall Section at Diewall


| Scale: 1" = 1'-0"

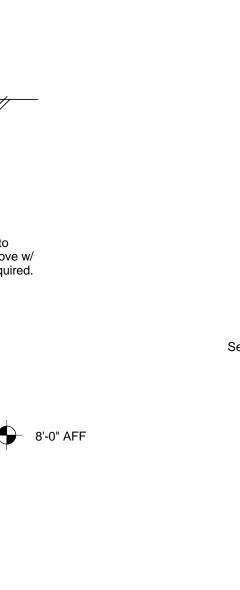


Header Detail

Scale: Not to Scale

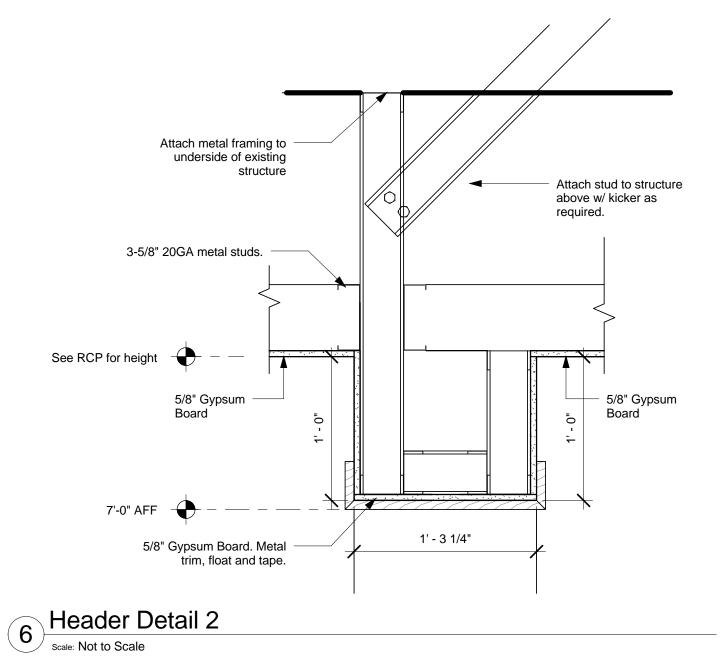

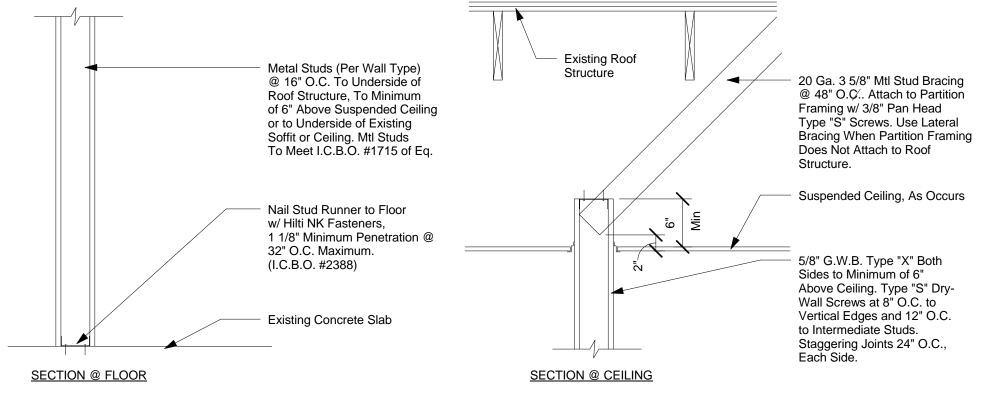

New Partition Wall 6" Above Ceiling

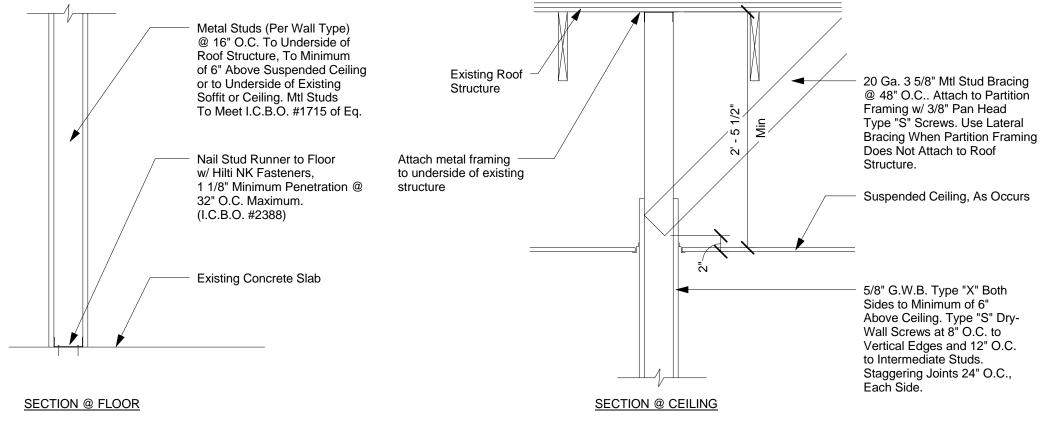

New Partition Wall to Structure

| Scale: 1" = 1'-0"



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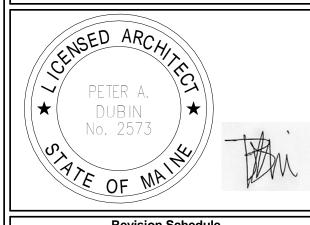
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Revision Schedule				
Rev	Date	Ву	Description	

STREET PROJECT NAME:

COMMERCIAL

STORE #: 19384 PROJECT #: 58862-001 CONCEPT: MCS PALETTE: HERITAGE ISSUE DATE: JAN. 11, 2013 DESIGN MANAGER: E. ZAKAMAREK LEED® AP: PRODUCTION DESIGNER: NORR ILLINOIS

SHEET TITLE:

CHECKED BY:

CONSTRUCTION **DETAILS** As indicated

SCALE: SHEET NUMBER:


I-501


WASTE LINE)

1 WALL SECTION AT BACKBAR


Scale: 3/4" = 1'-0"


Wood Top Cap

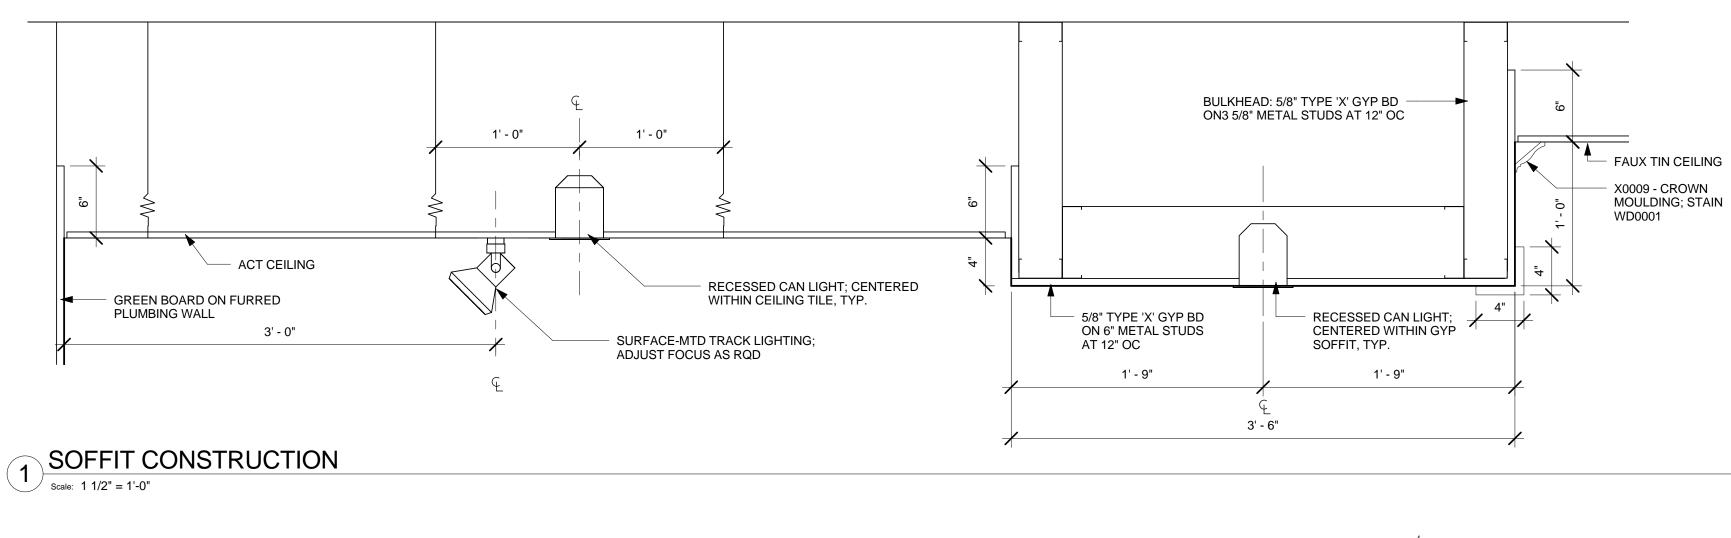


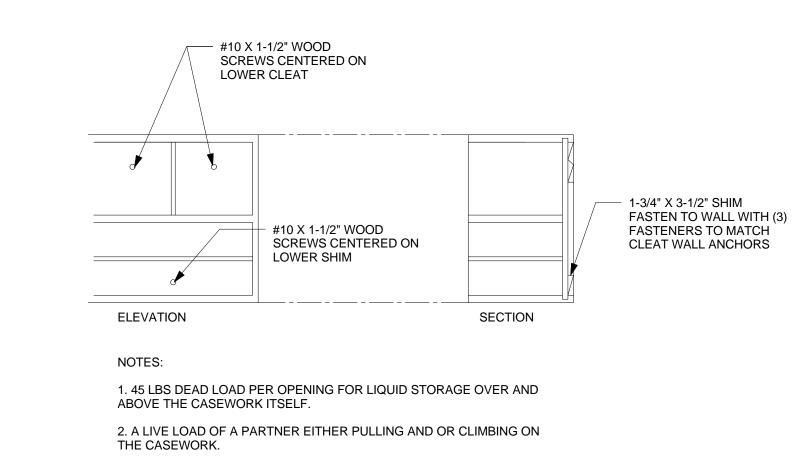

BLOCKING TO CASEWORK

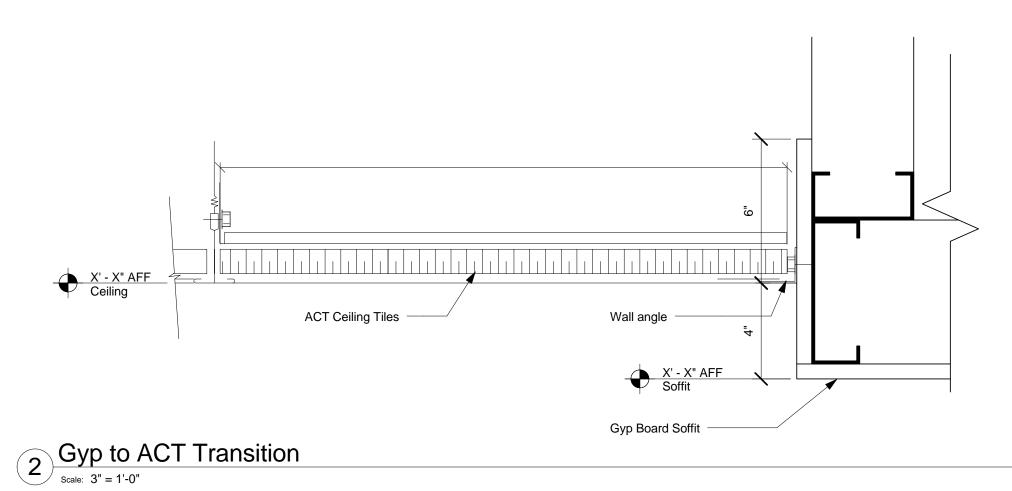


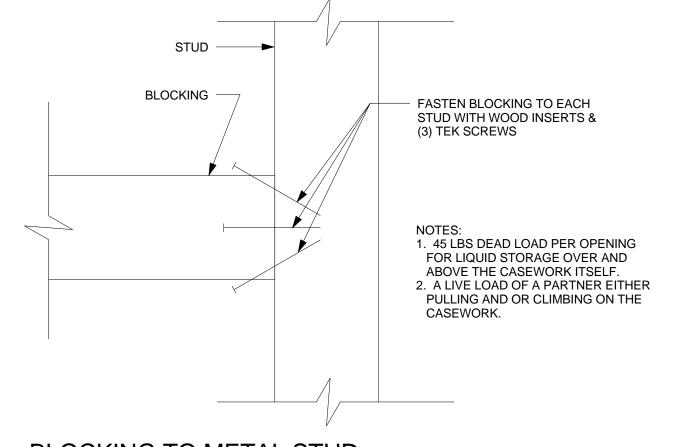


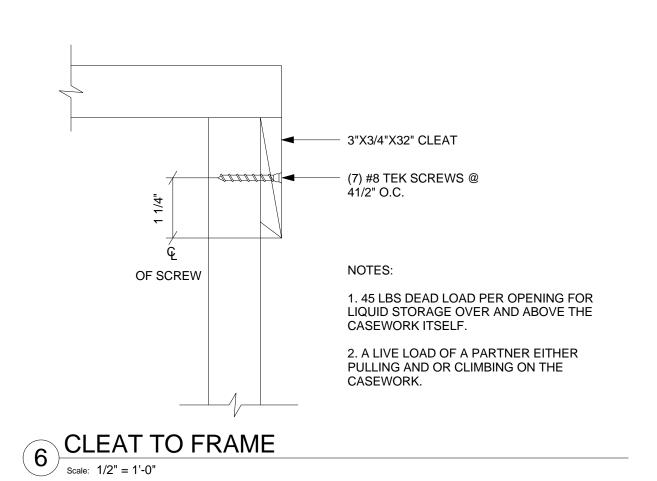

5 BLOCKING TO METAL STUD

| Scale: 1/2" = 1'-0"

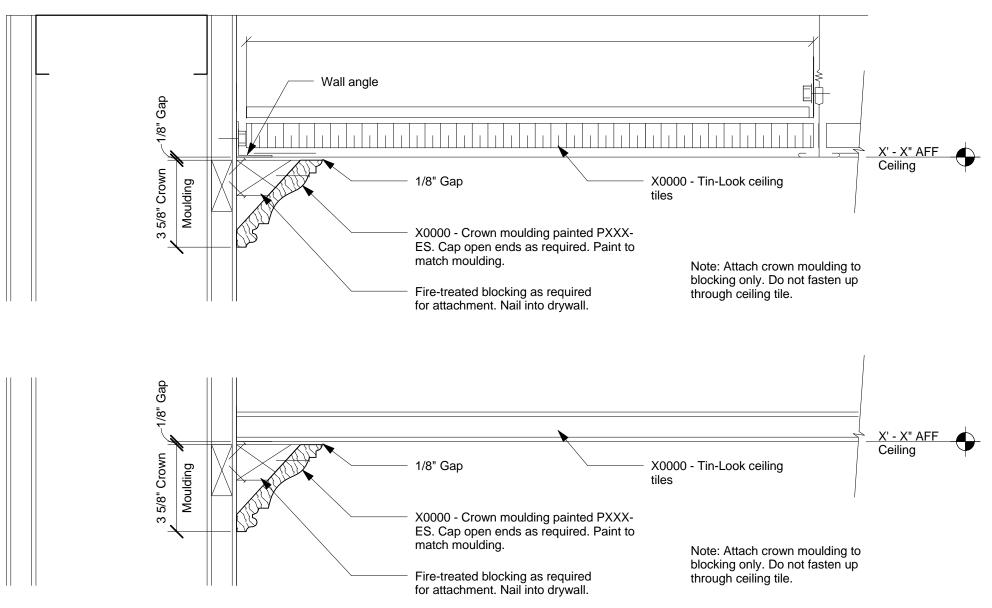

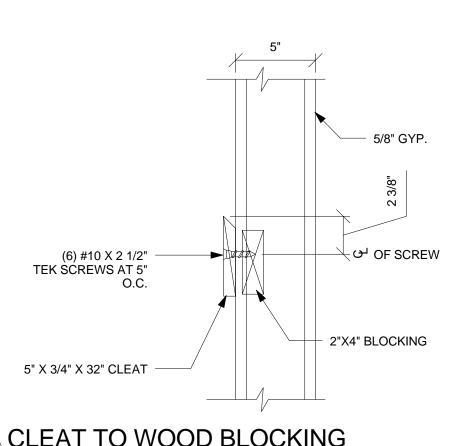

7 CLEAT TO WOOD BLOCKING

Scale: 1/2" = 1'-0"




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	Revision Schedule					
Rev	Date	Ву	Description			

STREET PROJECT ADDRESS:
145 COMMERCIAL STREET
PORTLAND, ME 04101
CUMBERLAND COUNTY PROJECT NAME:
COMMERCIAL

STORE #: 19384 PROJECT #: 58862-001 CONCEPT: MCS PALETTE: HERITAGE ISSUE DATE: JAN. 11, 2013 DESIGN MANAGER: E. ZAKAMAREK LEED® AP: PRODUCTION DESIGNER: NORR ILLINOIS CHECKED BY:


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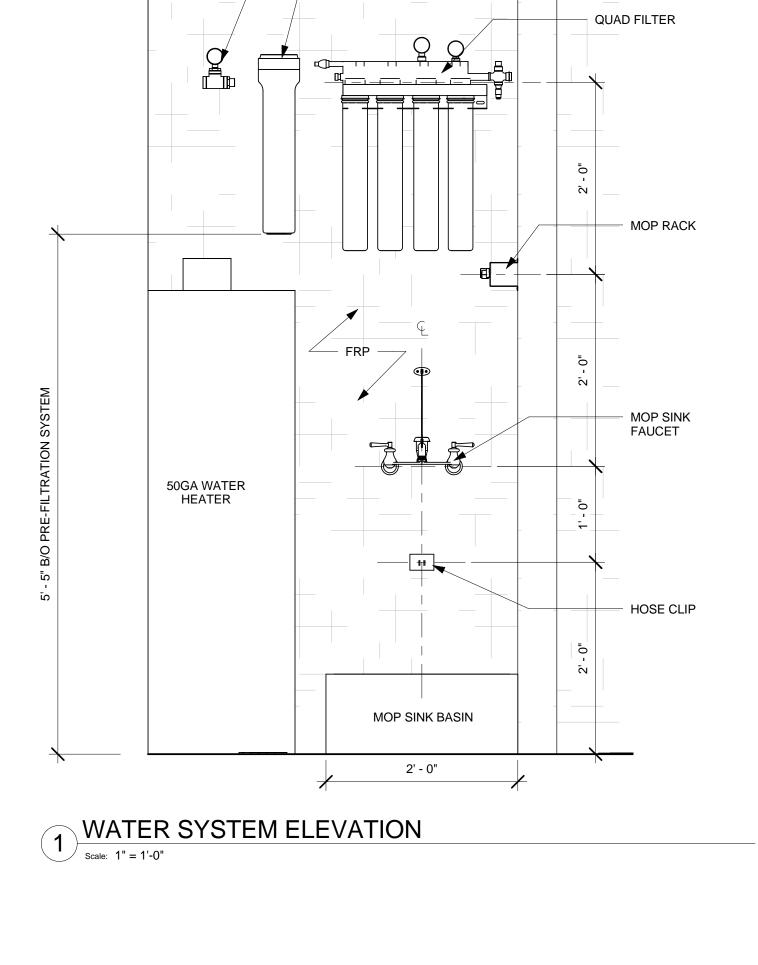
CONSTRUCTION **DETAILS** SCALE: As indicated

SHEET NUMBER:

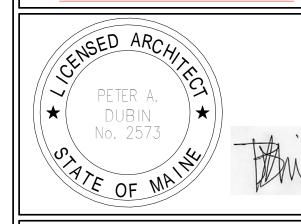I-502

3 Crown Moulding Detail
Scale: 3" = 1'-0"




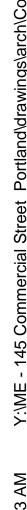

PRESSURE GAUGE


PRE-FILTRATION

SYSTEM

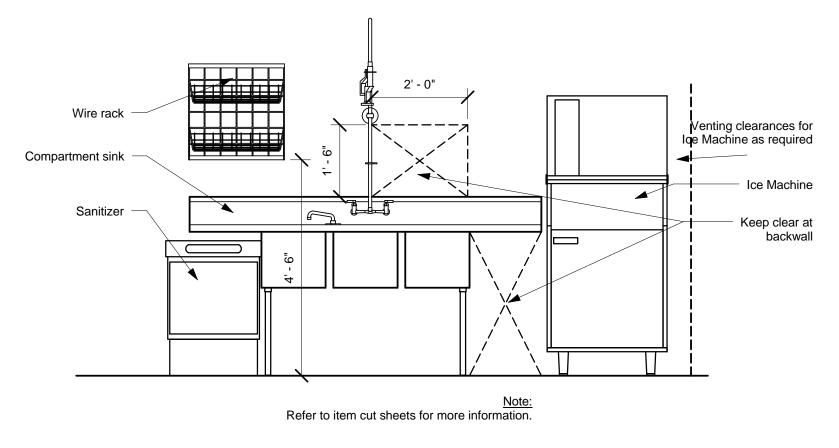


2 3-Comp Elevation (Sanitizer Below)

| Scale: 1/2" = 1'-0"

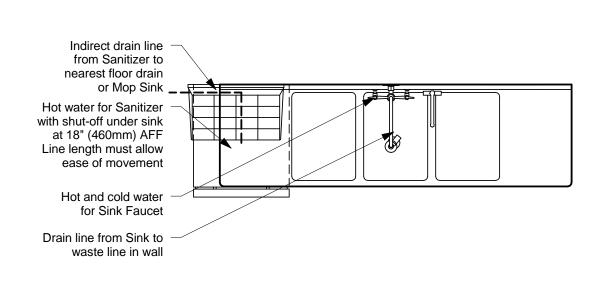

3-Comp Plan - Sanitizer (Under)

Scale: 1/2" = 1'-0"

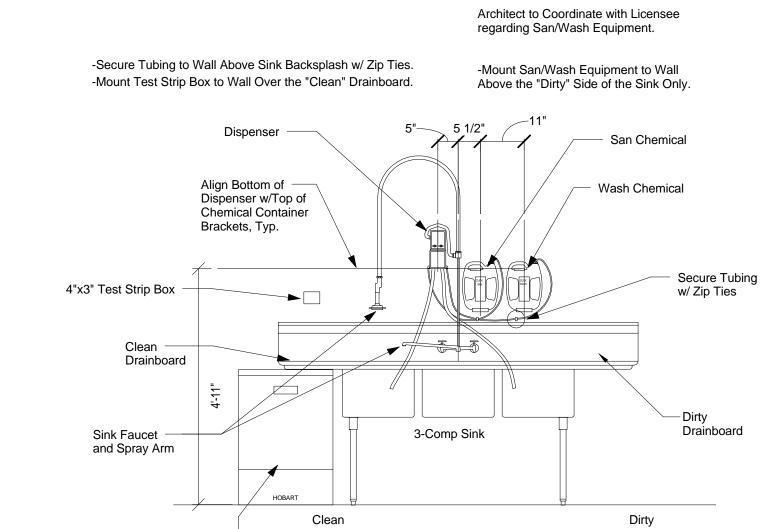



Click San/Wash Install (Sanitizer Below)

Scale: 1/2" = 1'-0"


Sanitizer

on LH "Clean" Side

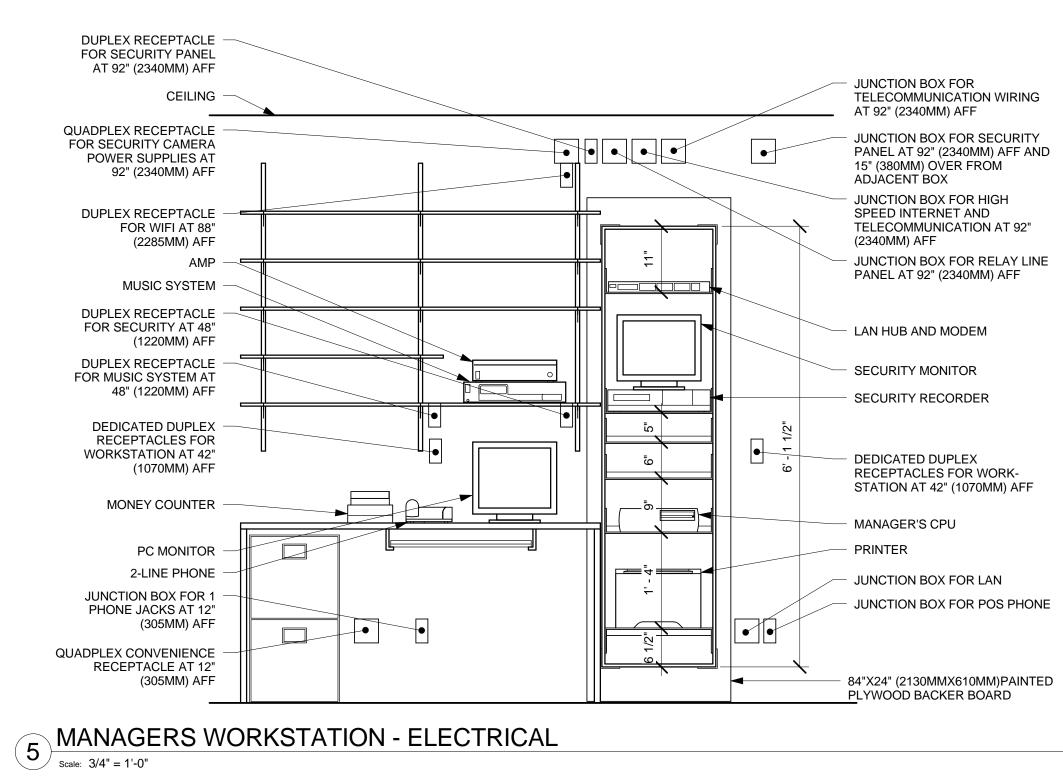


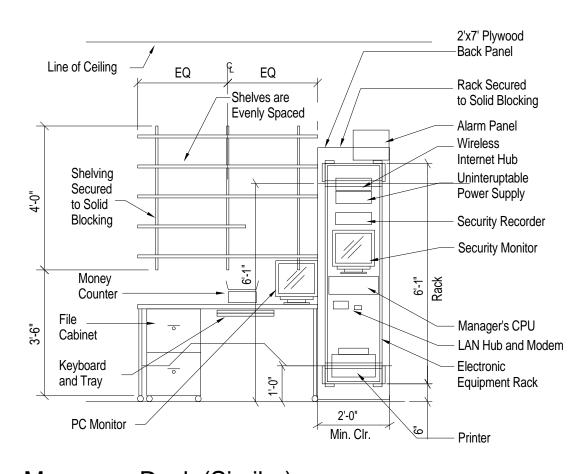

Managers Desk (Similar)

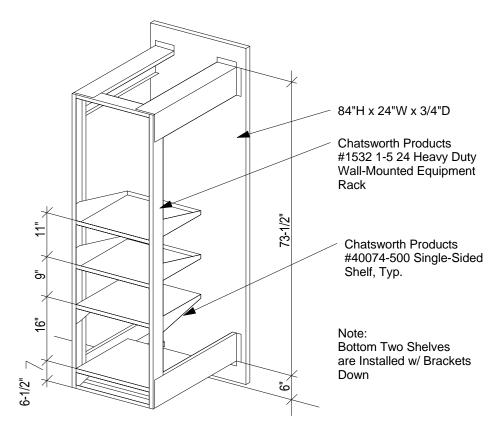

Equipment Rack Scale: 3/8" = 1'-0"

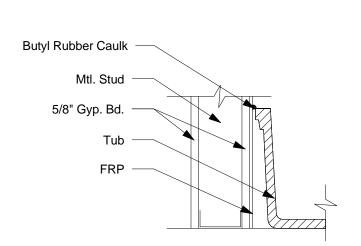



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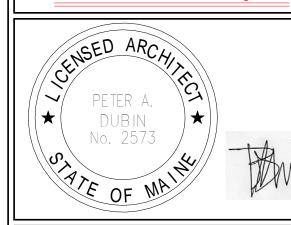
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		Rev	ision Schedule
Rev	Date	Ву	Description

STREE PROJECT ADDRESS:
145 COMMERCIAL STREET
PORTLAND, ME 04101
CUMBERLAND COUNTY PROJECT NAME:

COMMERCIAL

STORE #: 19384 PROJECT #: 58862-001 CONCEPT: MCS PALETTE: HERITAGE ISSUE DATE: JAN. 11, 2013 DESIGN MANAGER: E. ZAKAMAREK LEED $^{ extsf{R}}$ AP: PRODUCTION DESIGNER: NORR ILLINOIS CHECKED BY:


SHEET TITLE:

**WORKROOM DETAILS** 

As indicated

SCALE: SHEET NUMBER:

I-503

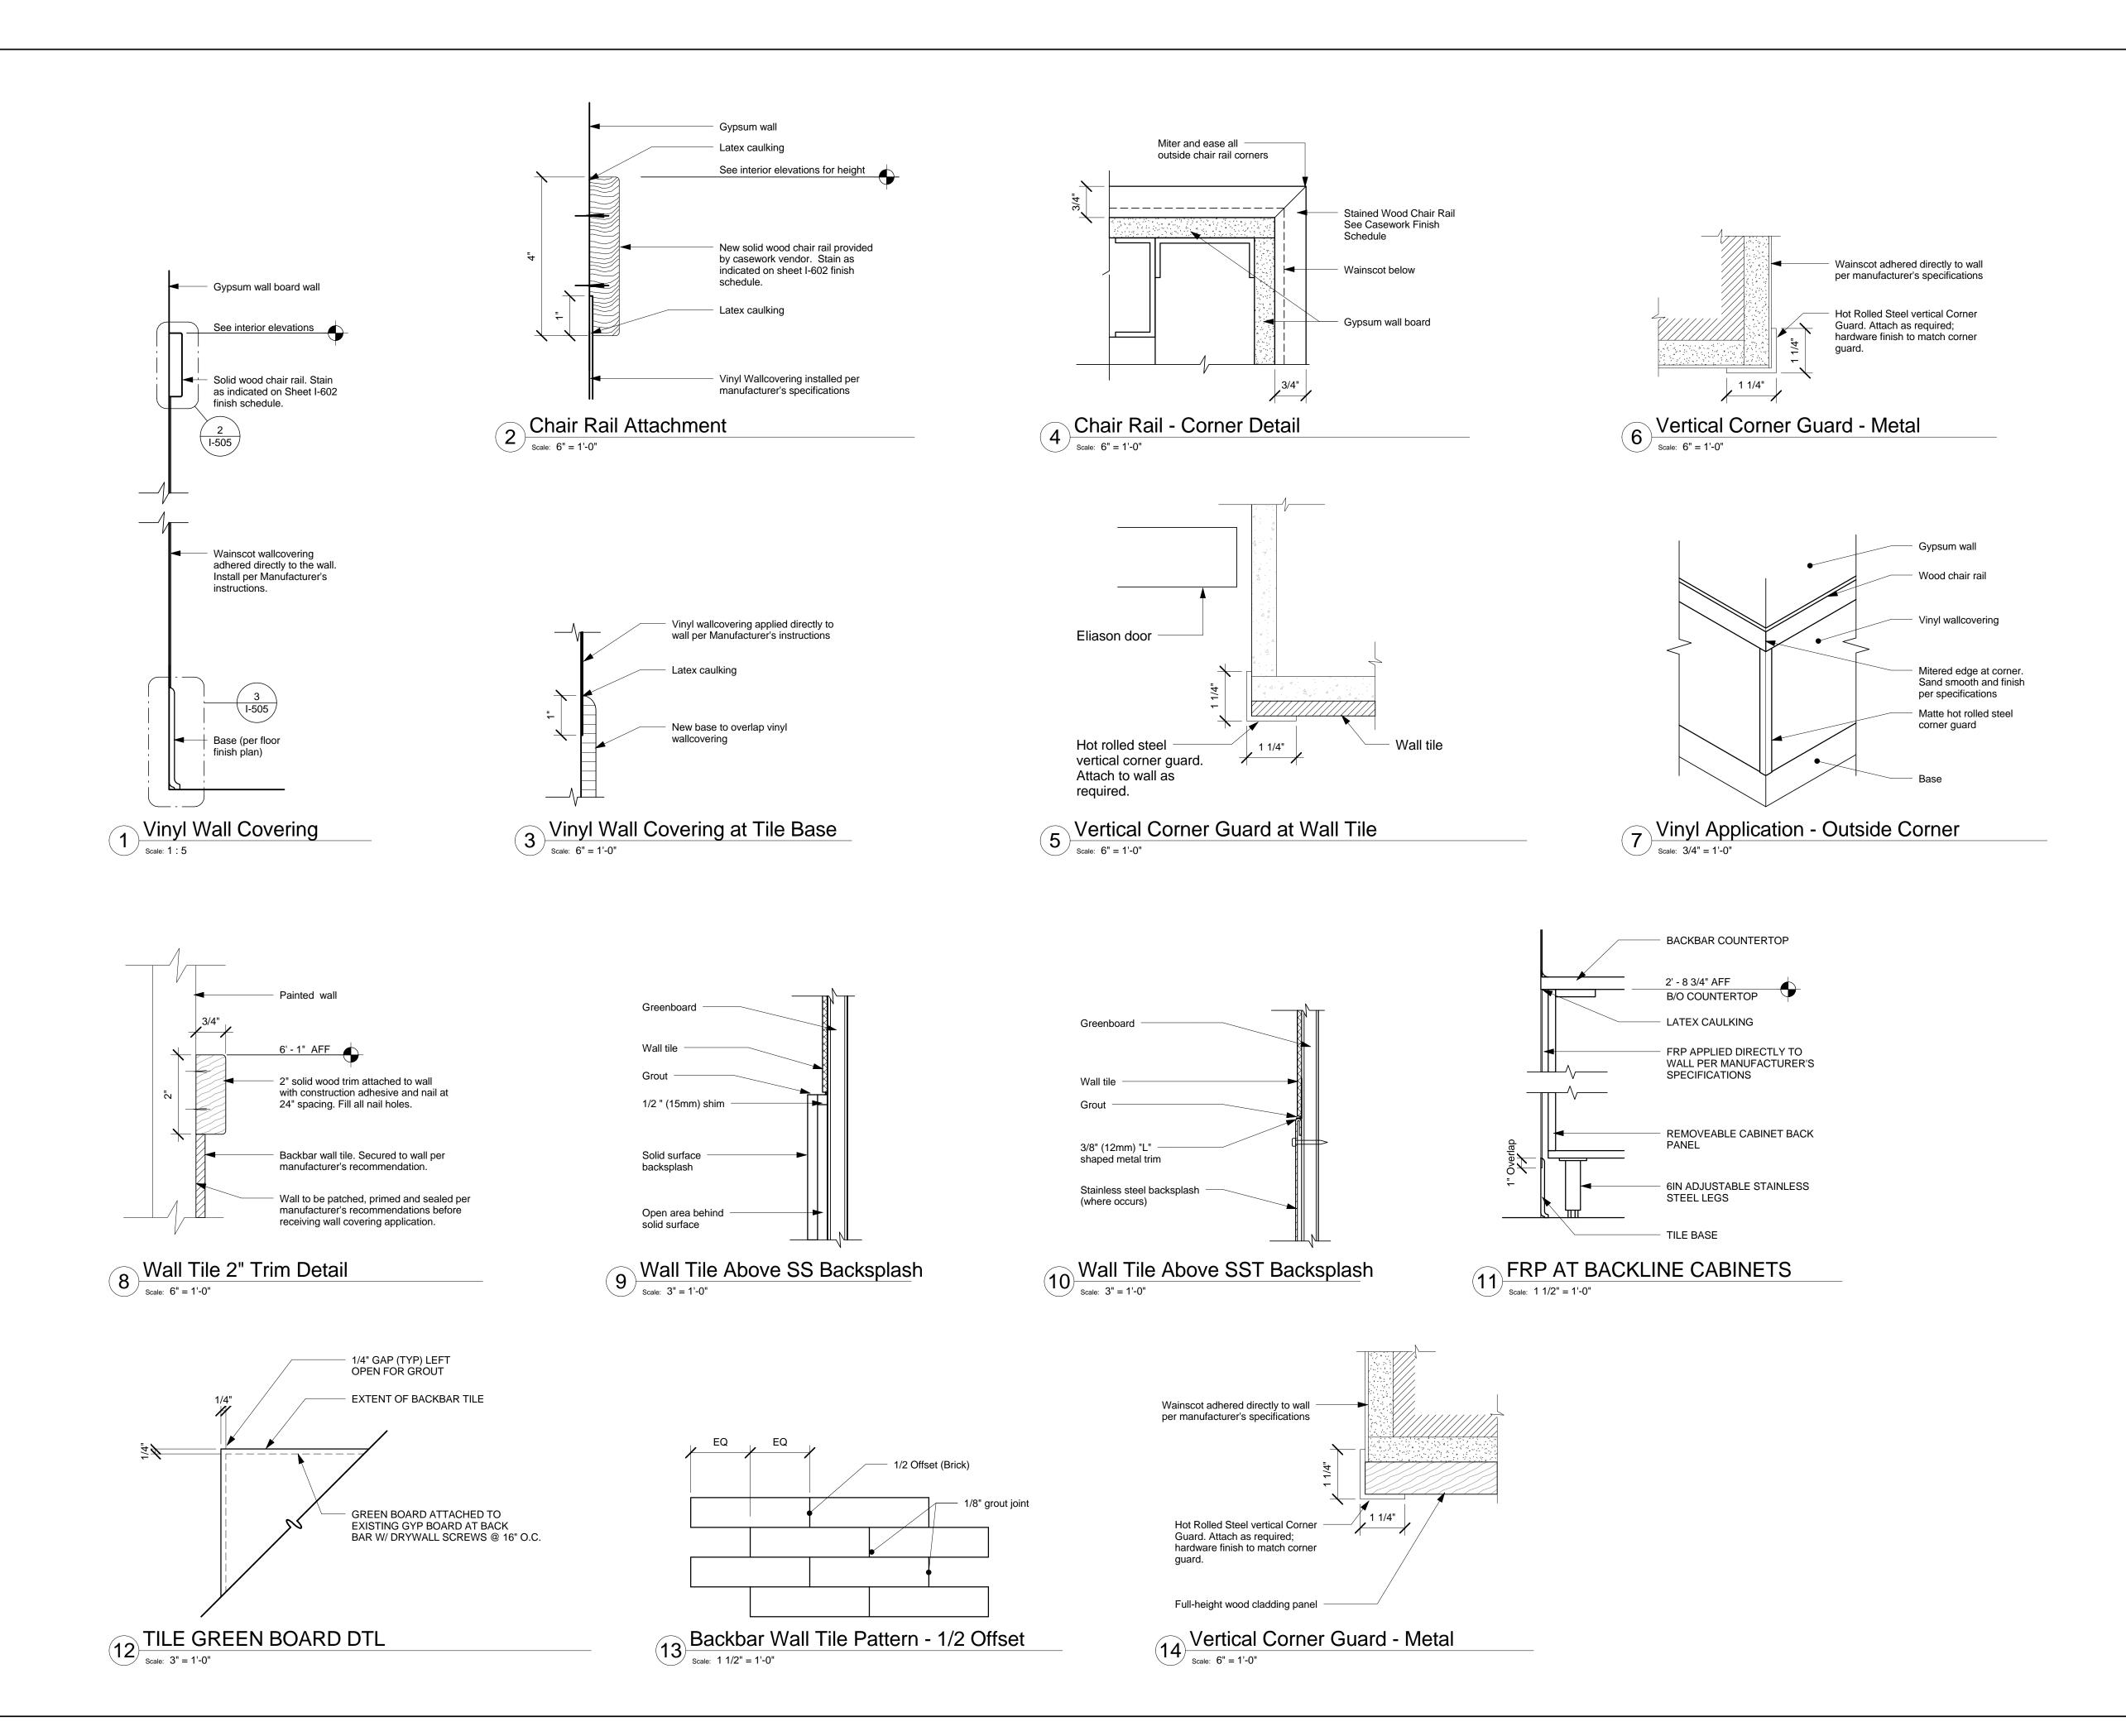



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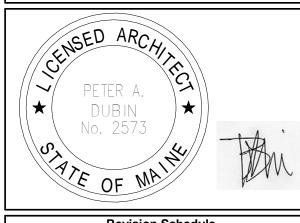
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	ision Schedule		
Rev	Date	Ву	Description

STREE PROJECT ADDRESS:
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PORTLAND, ME 04101
CUMBERLAND COUNTY PROJECT NAME:

COMMERCIAL

STORE #: 19384 PROJECT #: 58862-001 CONCEPT: MCS PALETTE: HERITAGE ISSUE DATE: JAN. 11, 2013 DESIGN MANAGER: E. ZAKAMAREK LEED $^{ extsf{R}}$ AP: PRODUCTION DESIGNER: NORR ILLINOIS

SHEET TITLE:


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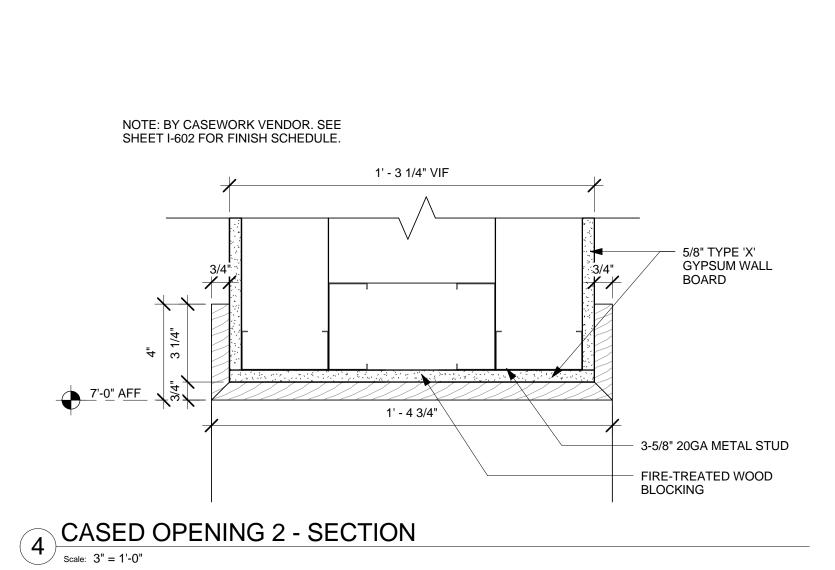
WALL FINISH DETAILS


SCALE: As indicated

SHEET NUMBER:


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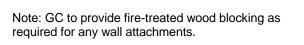





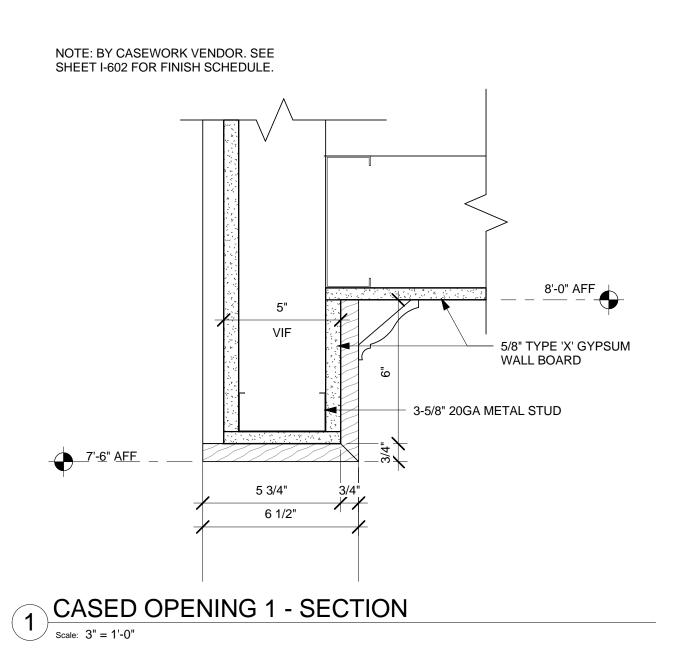

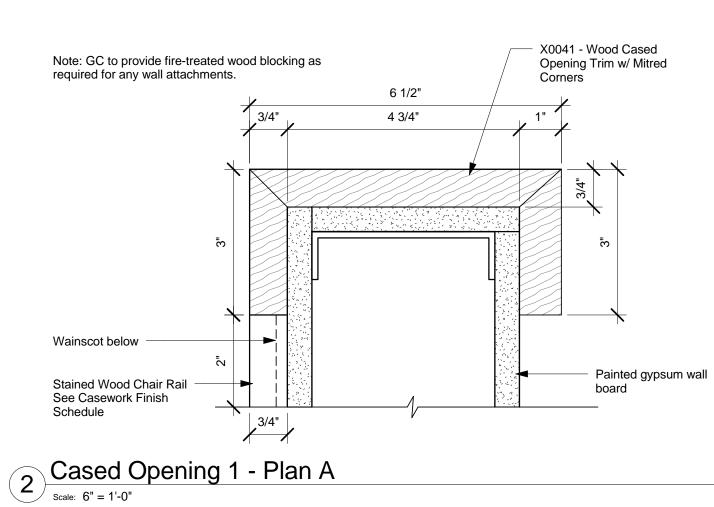



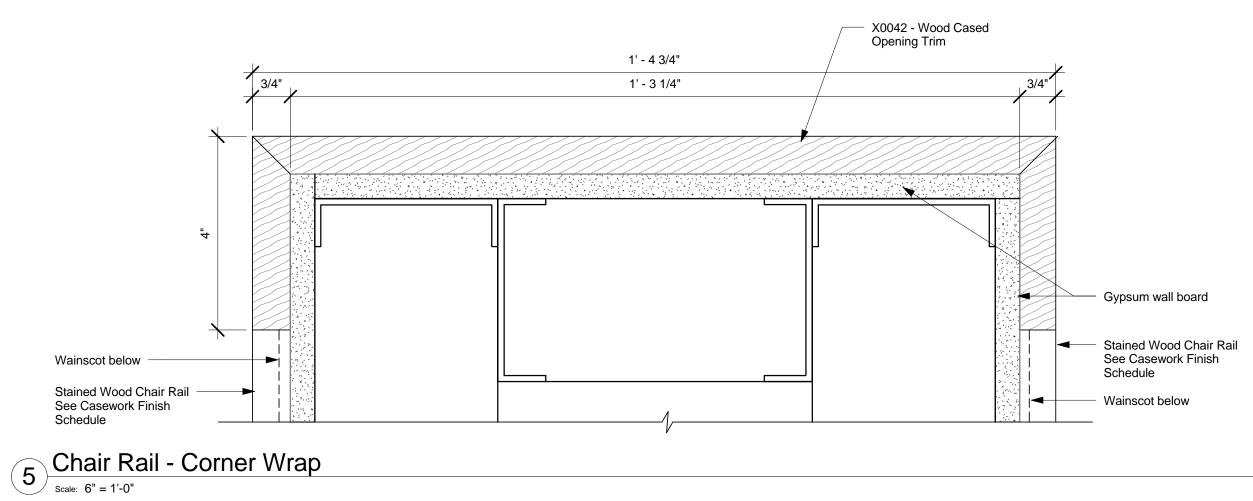

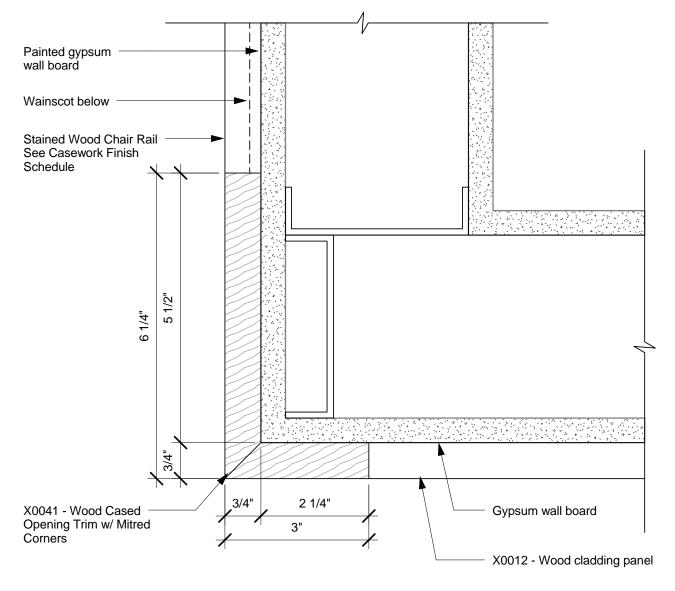





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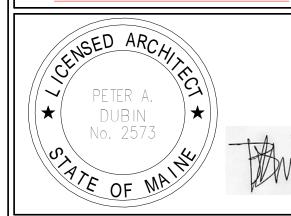
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Revision Schedule							
Rev Date By Description							

STREET PROJECT ADDRESS:
145 COMMERCIAL STREET
PORTLAND, ME 04101
CUMBERLAND COUNTY PROJECT NAME:
COMMERCIAL

STORE #: 19384 PROJECT #: 58862-001 MCS HERITAGE JAN. 11, 2013 E. ZAKAMAREK PRODUCTION DESIGNER: NORR ILLINOIS

SHEET TITLE:

WALL FINISH DETAILS

As indicated

SCALE:


I-506


PALETTE: ISSUE DATE: DESIGN MANAGER: LEED® AP:


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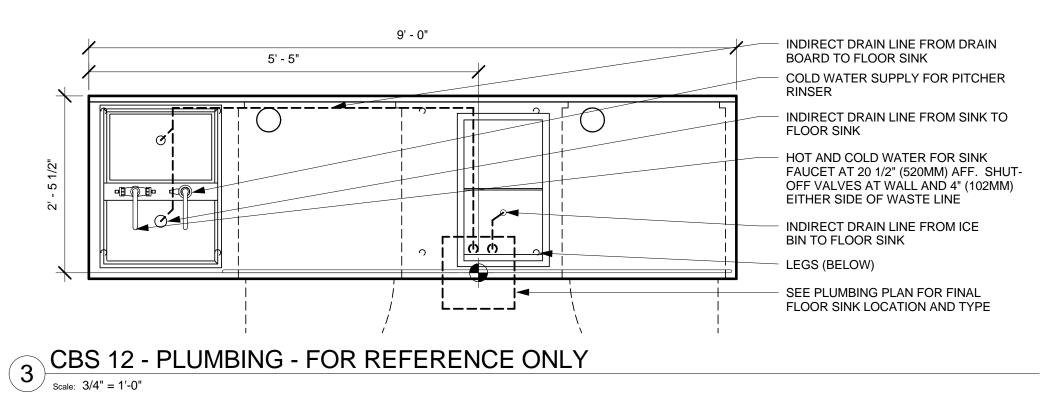
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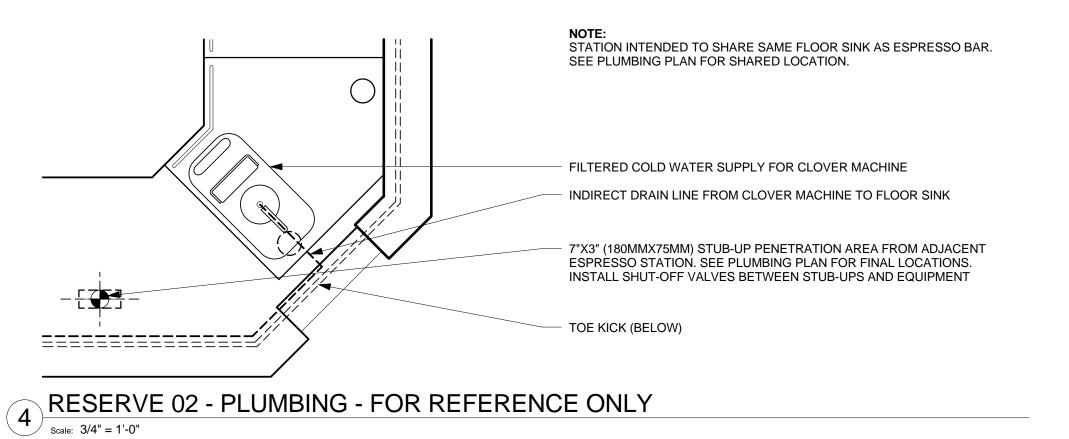
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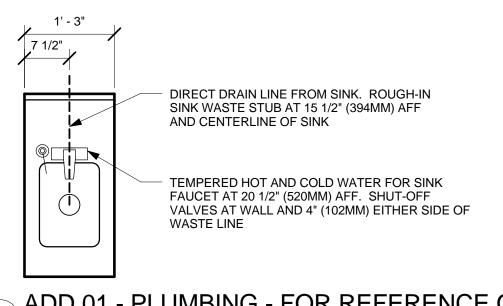






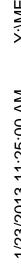

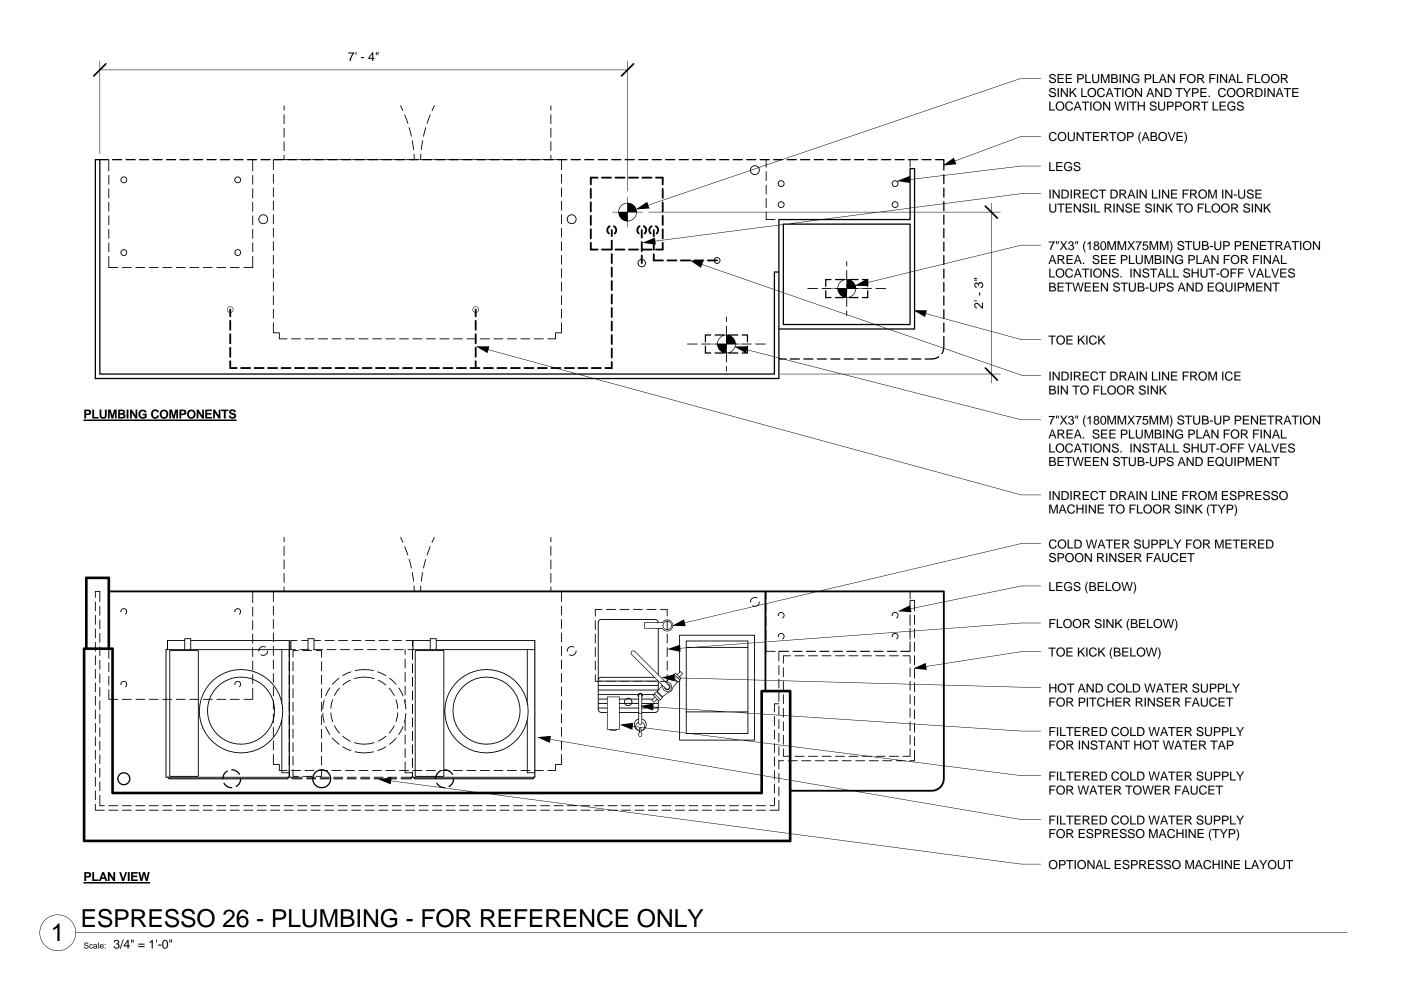

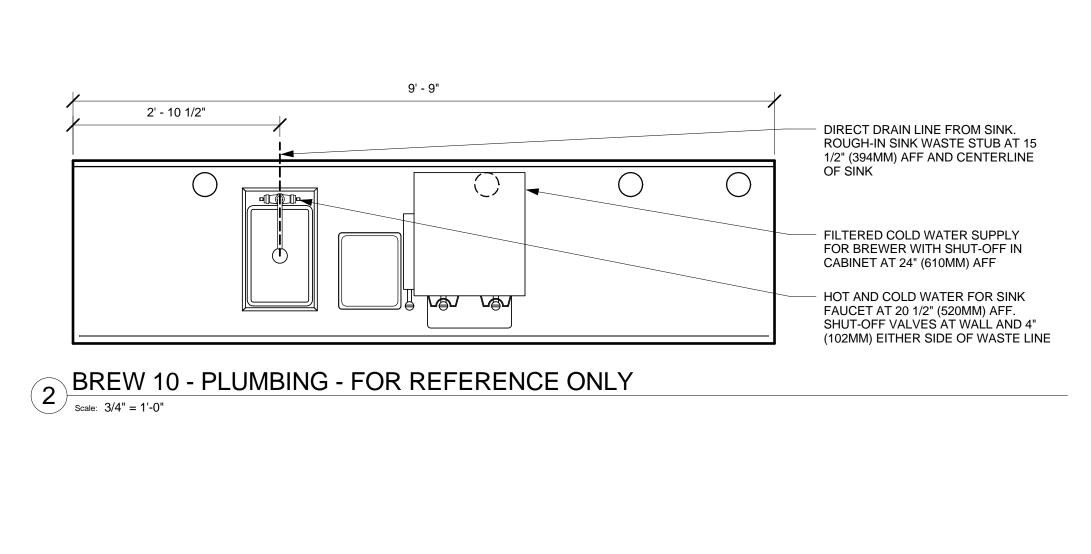

5 ADD 01 - PLUMBING - FOR REFERENCE ONLY

Scale: 3/4" = 1'-0"



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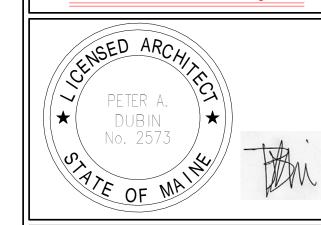
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Revision Schedule					
Rev	Date	Ву	Description		

PROJECT NAME:

COMMERCIAL STREET
PROJECT ADDRESS:
145 COMMERCIAL STREET
PORTLAND, ME 04101
CUMBERLAND COUNTY


STORE #:	19384
PROJECT #:	58862-001
CONCEPT:	MCS
PALETTE:	HERITAGE
ISSUE DATE:	JAN. 11, 2013
DESIGN MANAGER:	E. ZAKAMAREK
LEED® AP:	
PRODUCTION DESIGNER:	NORR ILLINOIS
CHECKED BY:	


CASEWORK DETAILS

SCALE: 3/4" = 1'-0"


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I-507



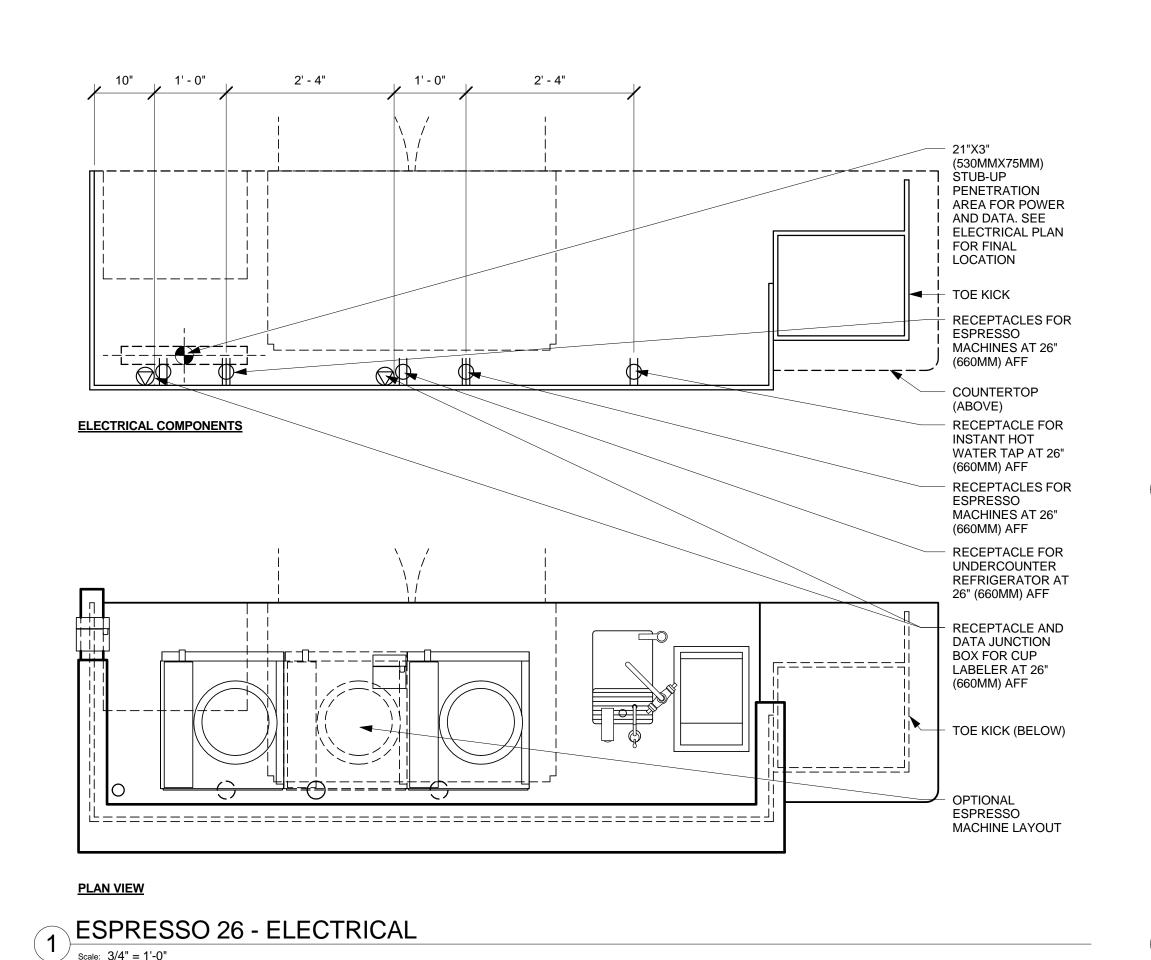


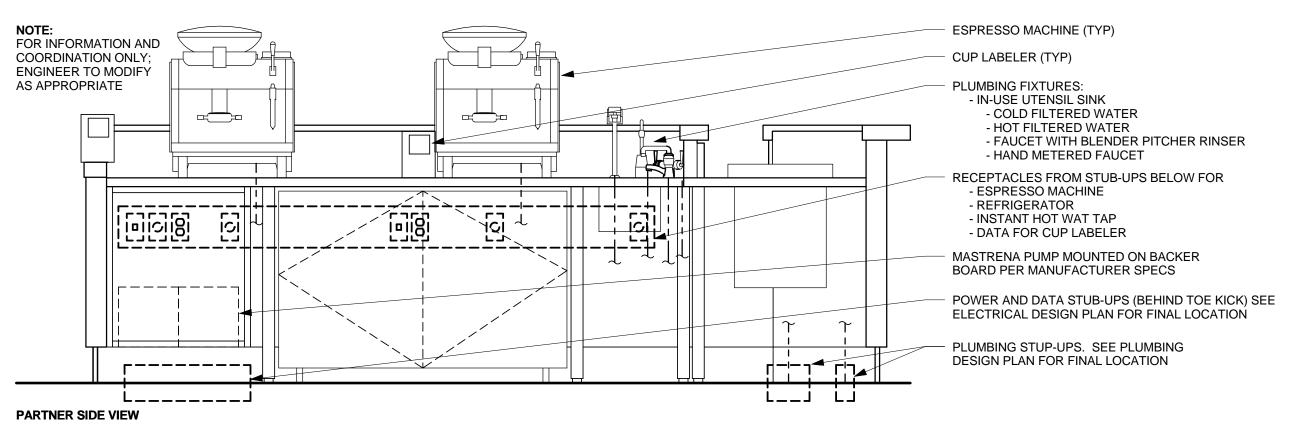
GENERIC DOUBLE ESP MEP DIAGRAM

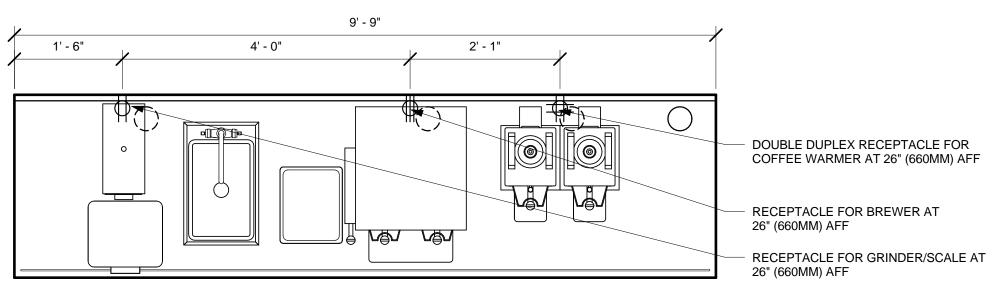



BREW 10 - ELECTRICAL

Scale: 3/4" = 1'-0"

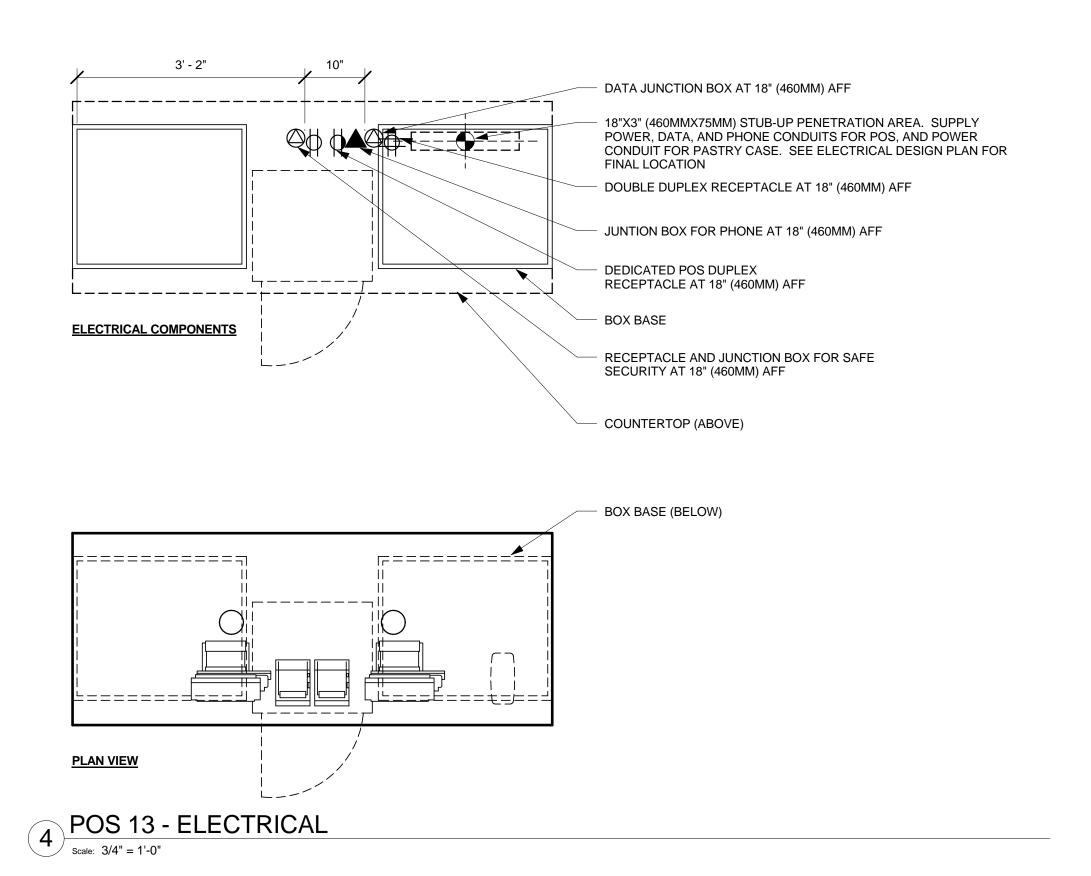

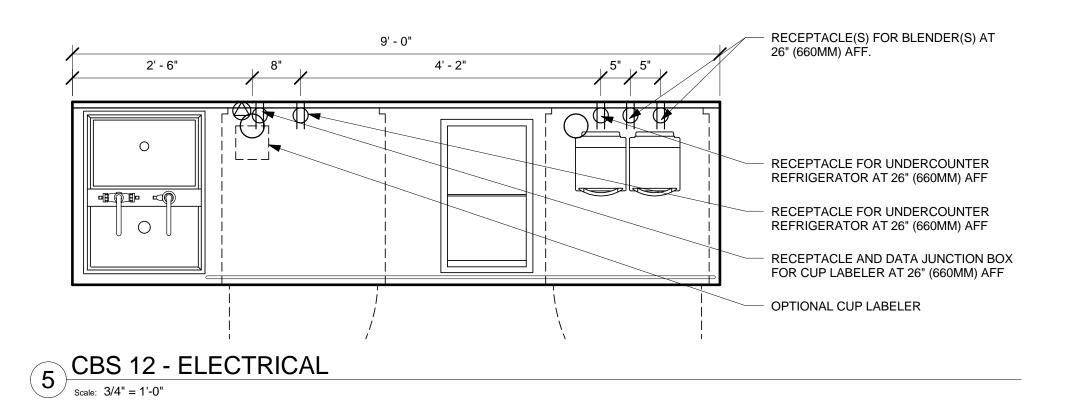

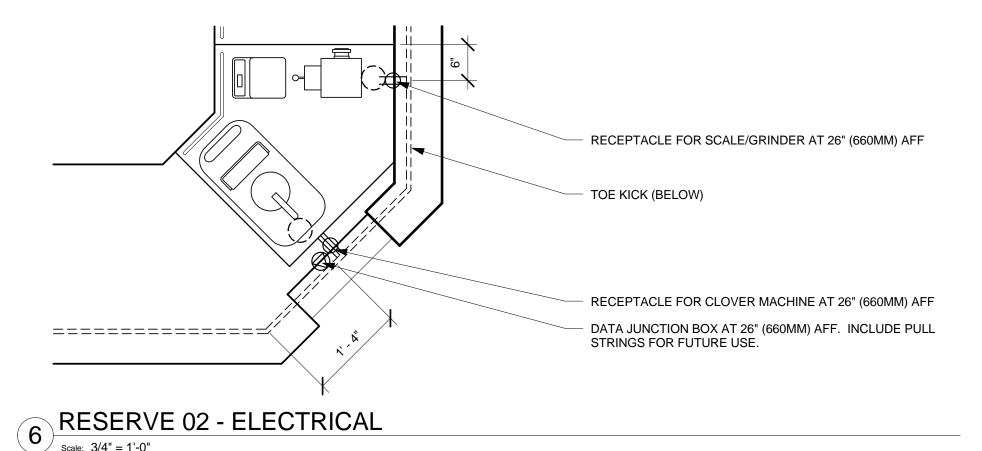

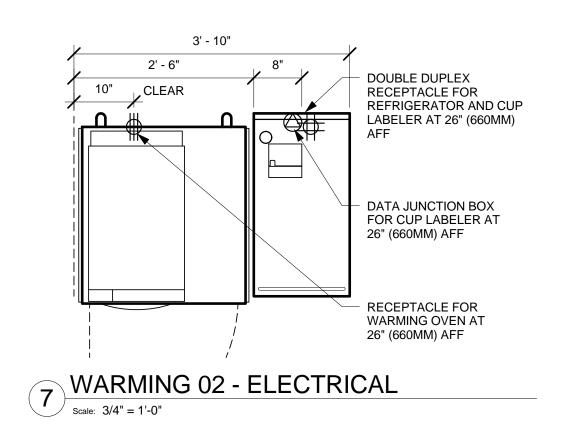



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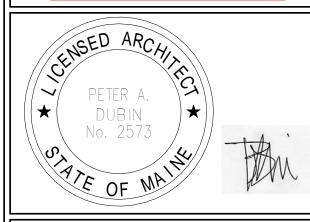
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Revision Schedule				
Rev	Date	Ву	Description	

STREE PROJECT NAME:

COMMERCIAL


- 1		
	STORE #:	19384
	PROJECT #:	58862-001
	CONCEPT:	MCS
	PALETTE:	HERITAGE
	ISSUE DATE:	JAN. 11, 2013
	DESIGN MANAGER:	E. ZAKAMAREK
	LEED <sup>®</sup> AP:	
	PRODUCTION DESIGNER:	NORR ILLINOIS
	CHECKED BY:	


SHEET TITLE: **CASEWORK DETAILS** 


SCALE: 3/4" = 1'-0"

SHEET NUMBER:


I-508

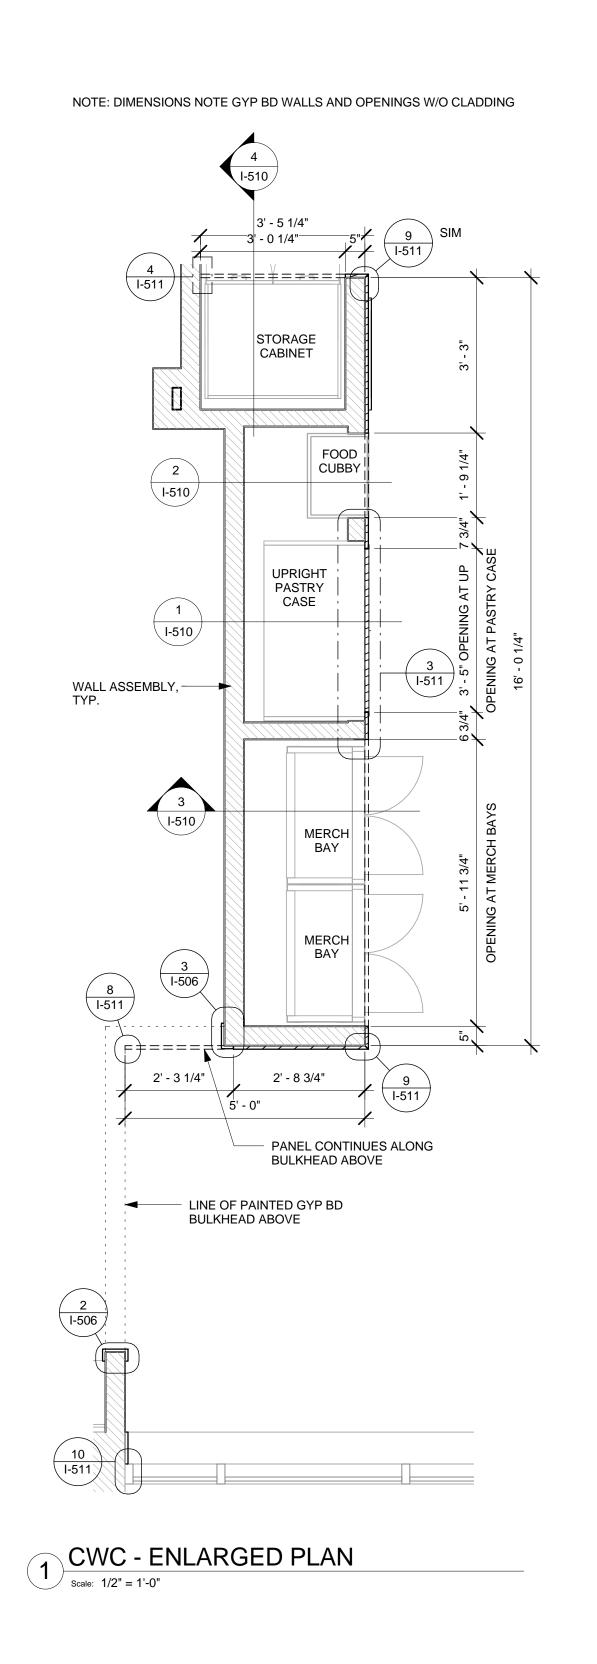

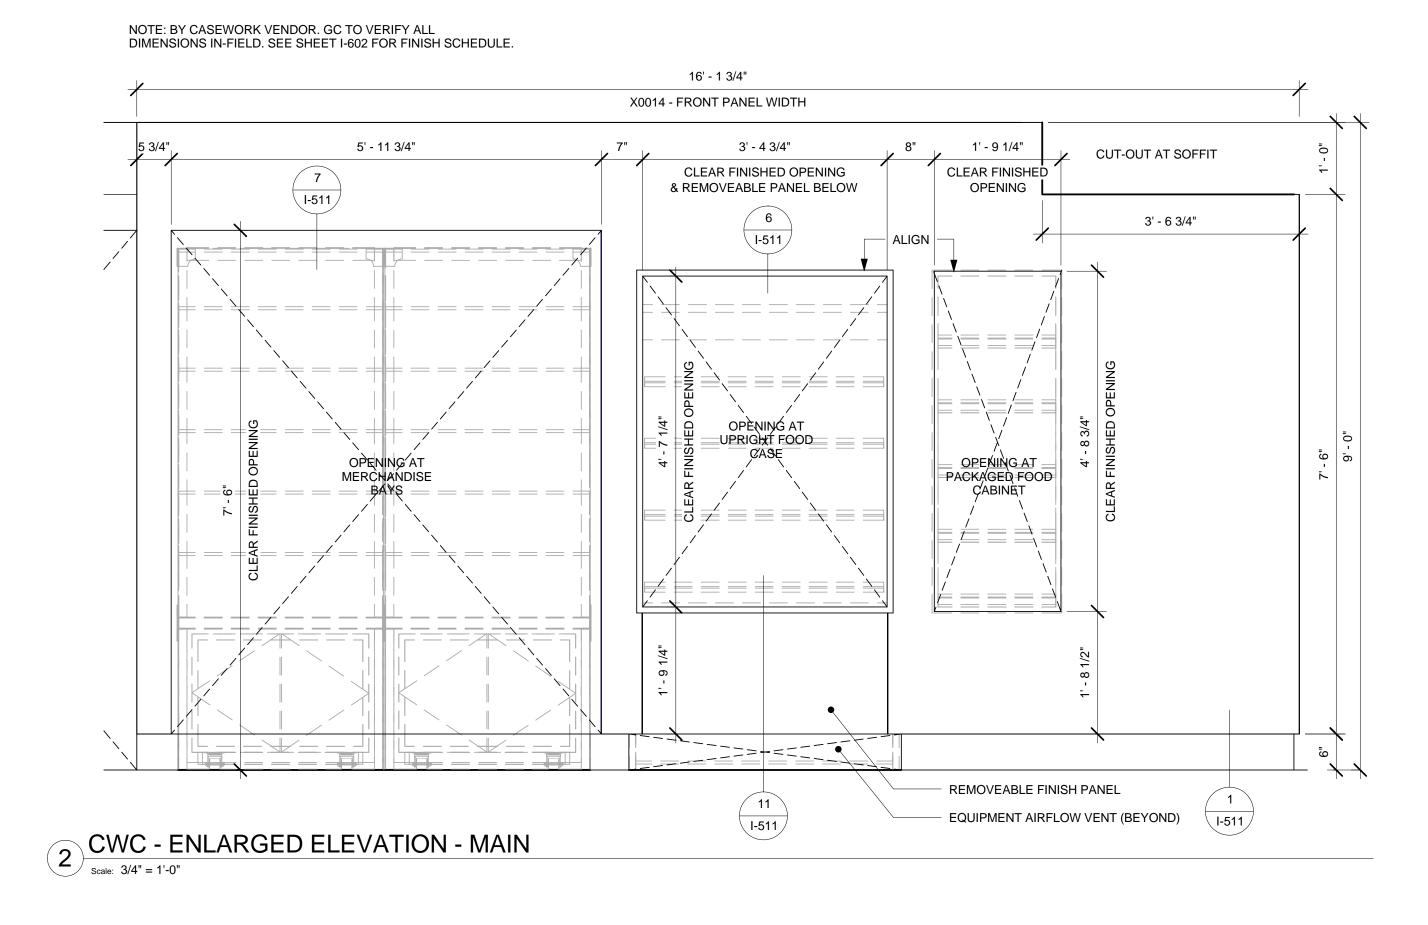

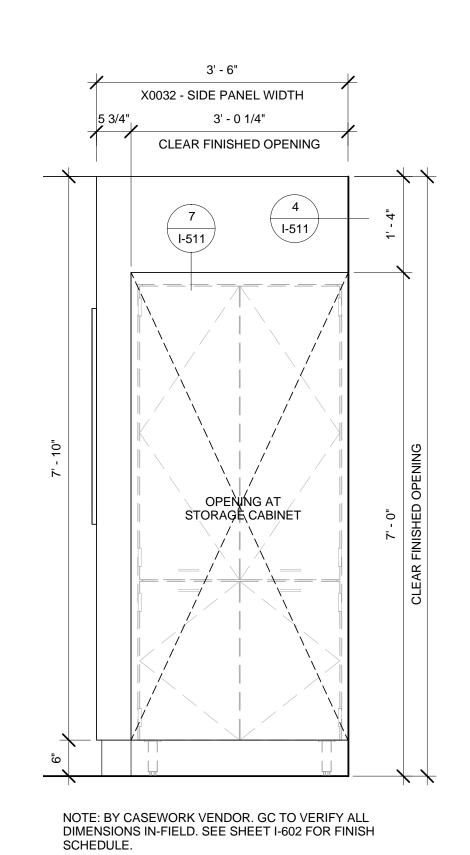



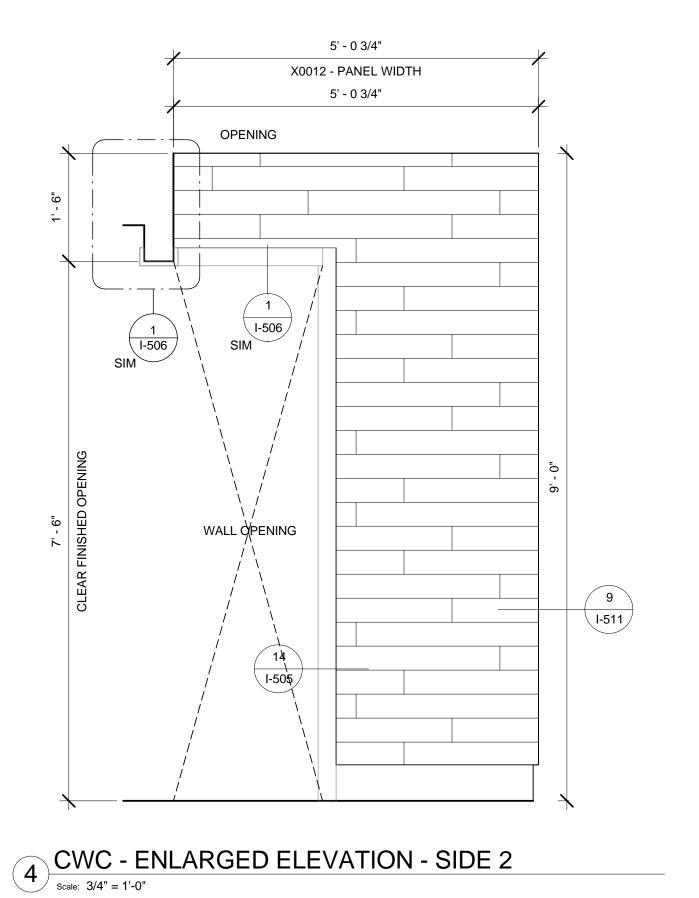



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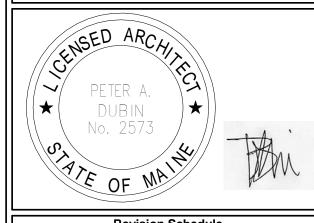
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Revision Schedule						
Rev	Date	Ву	Description			

# PROJECT NAME: COMMERCIAL STREET PROJECT ADDRESS: 145 COMMERCIAL STREET PORTLAND, ME 04101 CUMBERLAND COUNTY

STORE #: 19384

PROJECT #: 58862-001

CONCEPT: MCS

PALETTE: HERITAGE

ISSUE DATE: JAN. 11, 2013

DESIGN MANAGER: E. ZAKAMAREK

LEED® AP:

PRODUCTION DESIGNER: NORR ILLINOIS

SHEET TITLE:

CASEWORK DETAILS

SHEET NUMBER:

SCALE:

CHECKED BY:


I-509


As indicated


Y:\ME - 145 Commercial Street\_Portland\drawings\arch\Commercial Street\_ME - CD.rvt

13 11:25:06 AM Y:\ME - 145 Common



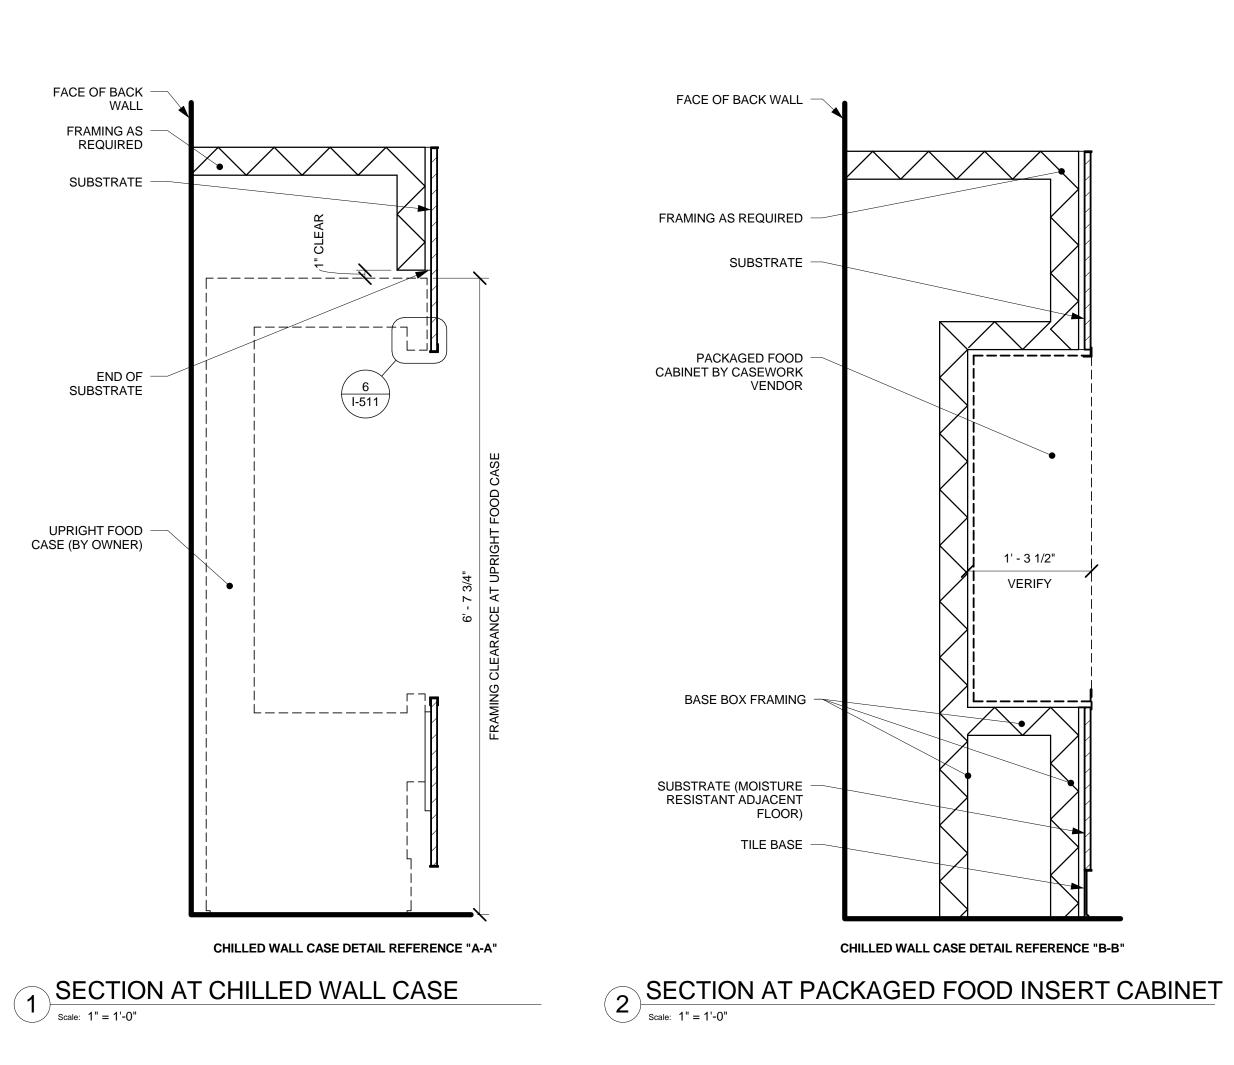

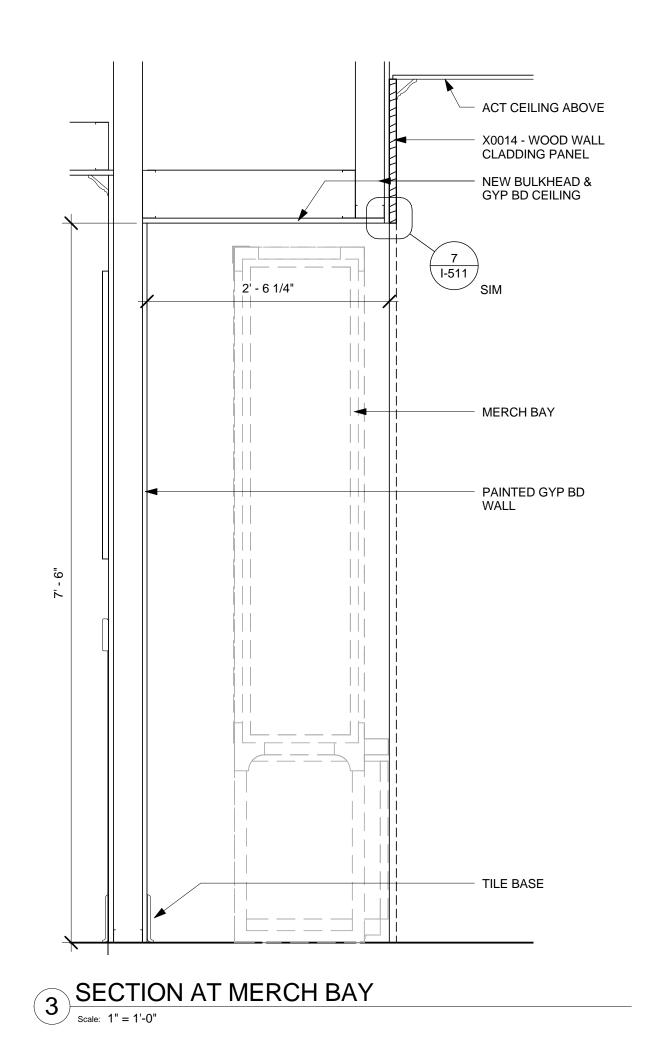

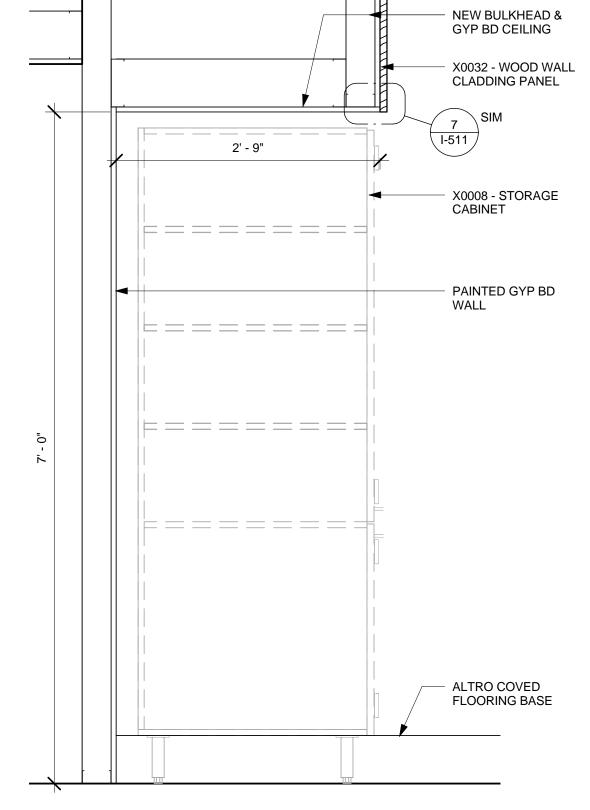



#### STARBUCKS COFFEE COMPANY


2401 UTAH AVENUE SOUTH SEATTLE, WASHINGTON 98134 (206) 318-1575

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ENGINEER OF RECORD St. Louis, Missouri 63119 Fax (314) 373-3514 Engineering Consultants Mechanical - Electrical - Plumbing



		ion Schedule	
Rev	Date	Ву	Description

PROJECT NAME:

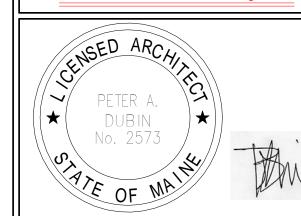COMMERCIAL STREET
PROJECT ADDRESS:
145 COMMERCIAL STREET
PORTLAND, ME 04101
CUMBERLAND COUNTY

STORE #: 19384 PROJECT #: 58862-001 MCS CONCEPT: PALETTE: HERITAGE ISSUE DATE: JAN. 11, 2013 DESIGN MANAGER: E. ZAKAMAREK LEED® AP:

PRODUCTION DESIGNER: NORR ILLINOIS

CASEWORK DETAILS


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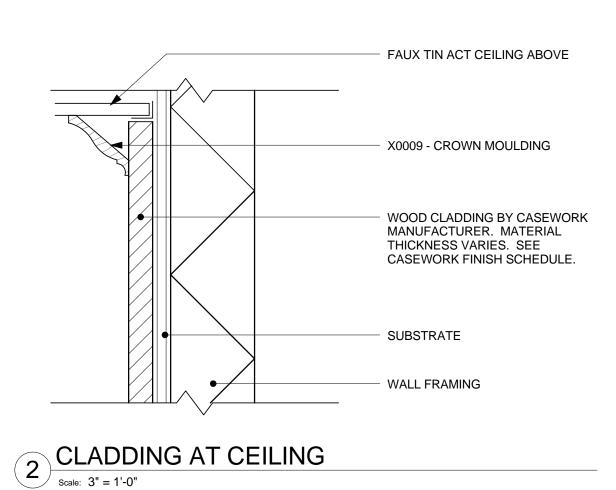
SHEET NUMBER:


I-510


SECTION AT STORAGE CABINET


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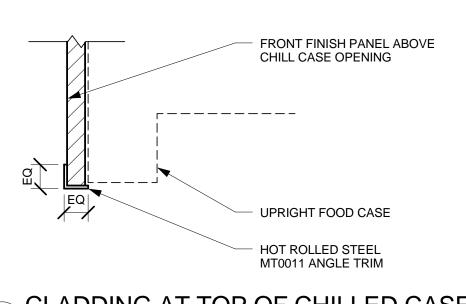





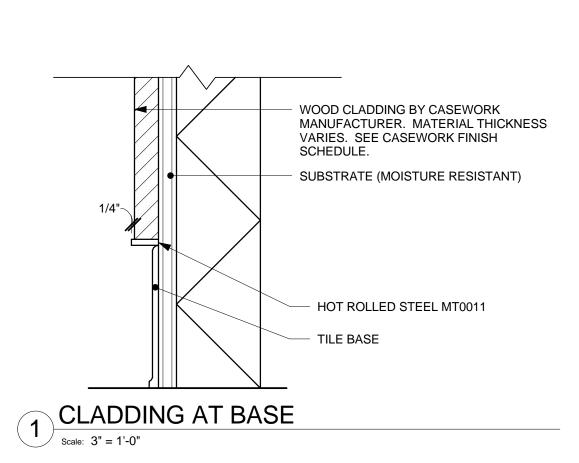

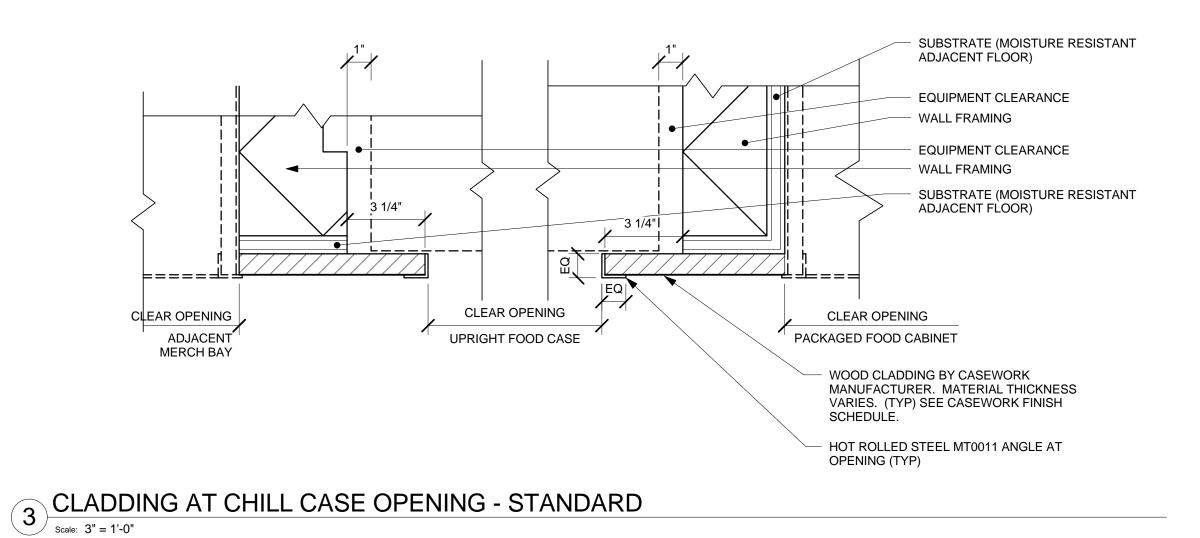

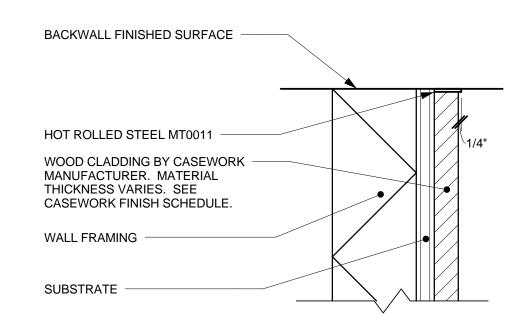

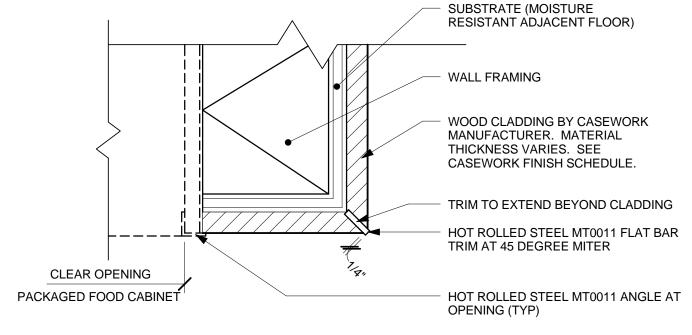


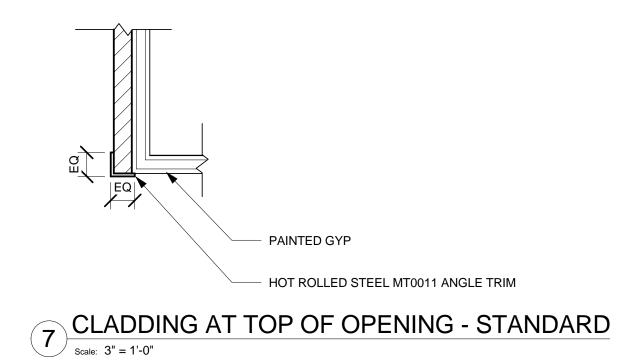










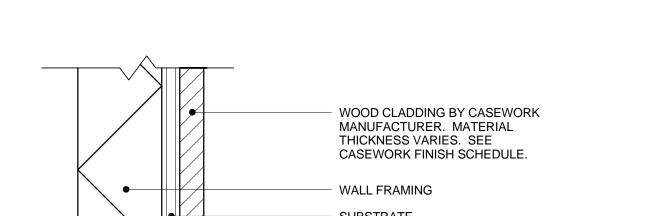

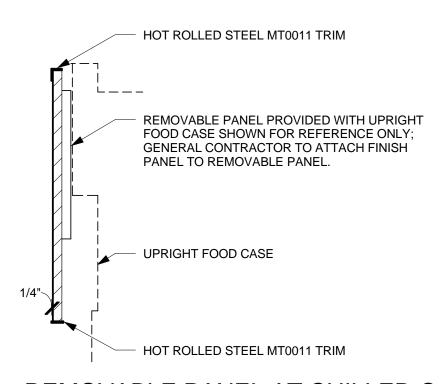

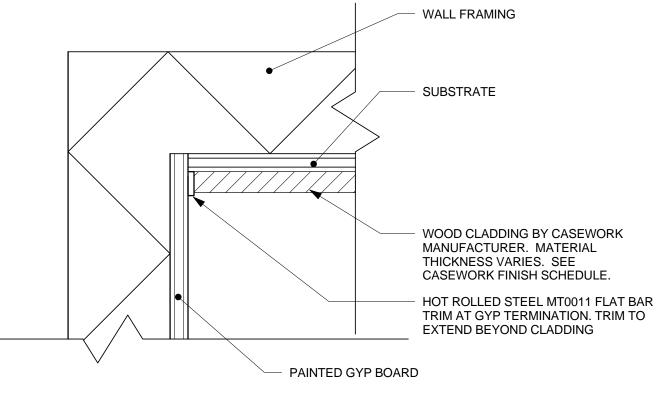



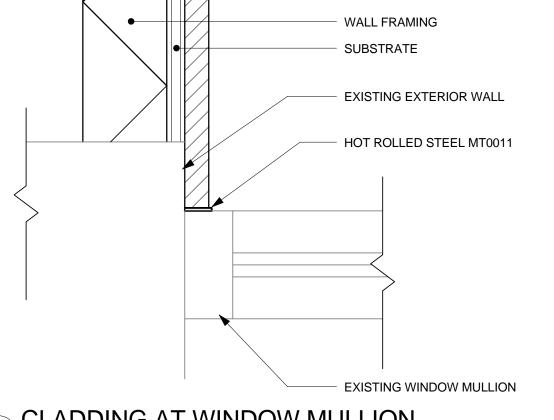

REMOVABLE PANEL AT CHILLED CASE

Scale: 1 1/2" = 1'-0"

8 CLADDING AT INSIDE CORNER

Scale: 3" = 1'-0"

SHEET TITLE: **CASEWORK DETAILS** 

PRODUCTION DESIGNER: NORR ILLINOIS

19384

MCS

58862-001

HERITAGE

JAN. 11, 2013

E. ZAKAMAREK

As indicated

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STARBUCKS COFFEE

COMPANY

2401 UTAH AVENUE SOUTH

SEATTLE, WASHINGTON 98134

(206) 318-1575

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**Revision Schedule** 

PROJECT ADDRESS:
145 COMMERCIAL STREET
PORTLAND, ME 04101
CUMBERLAND COUNTY

STREE<sup>-</sup>

PROJECT NAME:

COMMERCIAL

STORE #:

CONCEPT:

PALETTE:

ISSUE DATE:

LEED $^{ extsf{R}}$ AP:

CHECKED BY:

SHEET NUMBER:

DESIGN MANAGER:

PROJECT #:

Description

St. Louis, Missouri 63119 Phone (314) 772-1782 Fax (314) 373-3514

SCALE:

I-511

SUBSTRATE (MOISTURE RESISTANT ADJACENT FLOOR) WALL FRAMING WOOD CLADDING BY CASEWORK MANUFACTURER. MATERIAL THICKNESS VARIES. SEE CASEWORK FINISH SCHEDULE. TRIM TO EXTEND BEYOND CLADDING HOT ROLLED STEEL MT0011 FLAT BAR TRIM AT 45 DEGREE MITER CLADDING AT WINDOW MULLION

Scale: 3" = 1'-0"

DATA DEVICE SCHEDULE - "A"							
DESIGN ID	COUNT	DESCRIPTION	RESP.	COMMENTS			
AUDIO VISU	AL			•			
10005	1	MUSIC SYSTEM	WH				
10017	3	SPEAKER SURFACE MOUNTED - BLACK	WH	COLOR: BLACK			
10076	1	AMPLIFIER - 14IN 355MM	WH				
DATA							
10002	1	COMPUTER MANAGER WORKSTATION	VD	ENERGY STAR COMPLIANT			
10007	1	PRINTER MANAGER WORKSTATION	VD	ENERGY STAR COMPLIANT			
10011	1	EQUIPMENT RACK - 6FT 183CM	VD				
10019	1	WIDE AREA NETWORK HARDWARE	WH				
POINT OF S	ALE		·	•			
10008	2	REGISTER COMPACT	VD				
10014	2	POS PRINTER	VD				
10022	1	MONEY COUNTER	VD				
10029	4	POS BANK	WH				
SECURITY							
10004	1	ALARM SYSTEM	VD				
10024	1	SAFE LH - 20X18X26IN 510X455X660MM	VD				
10028	1	SAFE BASE	VD				

		SPECIALTY EQUIPMENT SCHE	1	1
DESIGN ID	COUNT	DESCRIPTION	RESP.	COMMENTS
CAFE			•	
12023	1	CONDIMENT CART SUGAR DISPENSER	VD	ELKAY
12230	1	CONDIMENT CART RECYCLE LABEL	WH	
12363	2	MERCH BAY UNIT BACK PANEL SOLID	WH	NOT PROVIDED BY CASEWORK VENDOR
12627	2	CONDIMENT CART TRASH LABEL	WH	
12640	 1	NEWSPAPER STAND 4 TIER - 39IN 990MM	VD	
13191	1	MERCH BAY UNIT END PANELS METAL MESH	WH	NOT PROVIDED BY CASEWORK VENDOR
13331	2	MERCH BAY UNIT	WH	NOT PROVIDED BY CASEWORK
COOLING				VENDOR
COOLING		EDIDOE DEAGLINIA DOOD DIL COIN 705MM	1,4/1,1	ENERGY OTAR COMPLIANT
10110	1	FRIDGE REACH IN 1 DOOR RH - 29IN 735MM	WH	ENERGY STAR COMPLIANT
10267	2	FRIDGE UNDERCOUNTER 1 DOOR - 27IN 685MM	WH	ENERGY STAR COMPLIANT
10473	1	FRIDGE UNDERCOUNTER 2 DOOR - 48IN 1220MM	WH	ENERGY STAR COMPLIANT
10967	1	FREEZER REACH IN 2 DOOR - 51IN 1295MM	VD	TRUE. ENERGY STAR COMPLIANT
11083	1	FRIDGE REACH IN 2 DOOR - 51X35IN 1295X890MM	WH	ENERGY STAR COMPLIANT
12480	1	FRIDGE 1 DOOR WITH COUNTERTOP - 29IN 735MM - SST	VD	DELFIELD. ENERGY STAR COMPLIANT
		7 JUNIVI - JU		
10312	2	BREWER SINGLE SOFT HEAT WARMING	WH	1
10012	۷	STAND	***	
10724	1	GRINDER GRINDMASTER	WH	GRINDMASTER
10724	1	BREWER DUAL SOFT HEAT	WH	CITINDIVIAGIEIX
10856	4	BREWER SERVER SOFT HEAT	WH	
11070	1	DISHWASHER SANITIZER	WH	ENERGY STAR COMPLIANT
11851	1	BREWER CLOVER	VD	
12407	1	OVEN TURBOCHEF NEXT GENERATION	VD	TURBOCHEF
12508	2	BLENDER QUIET MODEL ON COUNTER	VD	VITAMIX
12631	1	GRINDER DITTING KR804	VD	DITTING
12694	2	ESPRESSO MACHINE MASTRENA	WH	
FOOD CASE	<del></del>		1	
12394	1	FOOD CASE - UPRIGHT - 46IN 1170MM - BLACK	VD	STRUCTURAL CONCEPTS
X0015	1	FOOD CASE - HARMONY AMBIENT - 51IN	VD	STRUCTURAL CONCEPTS. HARMONY NON-REFRIGERATED SERVICE CASE. MODEL#: HMG5153.5023.
ICE				
10344	1	ICE - BIN DROP IN 95LB	VD	ELKAY
10475	1	ICE - MACHINE 1109LB AIR COOLED SIDE VENT	VD	MILE HIGH
10527	2	ICE - BIN DROP IN 45LB	WH	
10880	1	ICE - BIN 1000LB	VD	MILE HIGH
OTHER				1
10091	1	CUP DISPENSER TALL HOT VERTICAL	WH	
10314	1	SCALE DIGITAL WITH ADJUSTABLE DISPLAY MOUNT	WH	
10396	1	CUP DISPENSER SHORT HOT VERTICAL	WH	
10390	1	FILE CABINET 2 DRAWER	WH	
10501	1	FIRE EXTINGUISHER	GC	PER LOCAL CODE REGULATIONS
10855	2	CUP DISPENSER GRANDE VENTI HOT	WH	PER LOCAL CODE REGULATIONS
40047		VERTICAL COAR DISPENSED WALL MOUNTED	\A/I I	
10947	1	SOAP DISPENSER WALL MOUNTED	WH	
10977	1	PAPER TOWEL DISPENSER FULL SIZE - TRANSLUCENT GRAY	WH	
10992	1	PAPER TOWEL DISPENSER HALF SIZE - TRANSLUCENT GRAY	WH	
11115	1	SOAP DISPENSER SINK MOUNTED	WH	
11823	1	SCALE DIGITAL	WH	
STORAGE			1	
10176	1	ROLLING PASTRY TRAY RACK	WH	
10170	1	WIRE SHELF GRID AT SINK	WH	
10222	1	10 COMP LOCKER	WH	
	5	WORKROOM WIRE SHELVING	WH	
10416	_		13 A / L L	T. Control of the Con
10462	5	WORKROOM WIRE SHELVING POSTS	WH	
	5 1	MOP RACK WITH 3 HOLDERS	WH	

WH - STARBUCKS

GC - GENERAL CONTRACTOR

VD - VENDOR

LL - LANDLORD

DESIGN ID	COUNT	GRAPHICS DESCRIPTION	RESP.	COMMENTS
GRAPHICS -			0	1 JOHNSELLIO
12837	1	MENU BOARD - 1 FRONT PANEL	WH	
10000		INSERT STYLE	140	
12839	6	MENU BOARD - UNIVERSAL MOUNTING HARDWARE FOR FRONT PANELS	WH	
12859	2	MENU BOARD - 2 PANEL INSERT STYLE UNIVERSAL MOUNT	WH	
12976	2	MENU BOARD - DAILY OFFERING	WH	
		CHALKBOARD UNIVERSAL MOUNT RECTANGULAR		
13214	1	MENU BOARD - 1 FRONT PANEL INSERT STYLE RESERVE LH	WH	
GRAPHICS -	OTHER			
12678	1	EDUCATION DISK ALTERNATIVE TRANSPORTATION BUS	VD	DUGGAL VISUAL GROUP. CONTACT: STEVEN ARNESEN. PHONE: 646-638-7263. EMAIL: STEVEN@DUGGAL.COM.
12683	1	EDUCATION DISK ENERGY	VD	DUGGAL VISUAL GROUP. CONTACT: STEVEN ARNESEN.
				PHONE: 646-638-7263. EMAIL: STEVEN@DUGGAL.COM.
12684	1	EDUCATION DISK RESPONSIBLE MATERIALS	VD	DUGGAL VISUAL GROUP. CONTACT: STEVEN ARNESEN. PHONE: 646-638-7263. EMAIL: STEVEN@DUGGAL.COM.
12688	1	EDUCATION DISK RECYCLE	VD	DUGGAL VISUAL GROUP. CONTACT: STEVEN ARNESEN. PHONE: 646-638-7263. EMAIL: STEVEN@DUGGAL.COM.
12691	1	EDUCATION DISK WASTE DIVERSION CONSTRUCTION MATERIALS	VD	DUGGAL VISUAL GROUP. CONTACT: STEVEN ARNESEN. PHONE: 646-638-7263. EMAIL: STEVEN@DUGGAL.COM.
X0052	1	COMMUNITY BOARD	VD	BY PLANET GRAPHICS. CONTACT: BRIAN BETZGER. PHONE: 781-829-9222. EMAIL:
				BRIANBETZGER@YAHOO.COM. DIMENSIONS: 2'-4"W x 3'-0"H. FRAME: 3" WOOD (WD0001). TOP IMAGE: NS0210 (SCALED & CROPPED AS REQUIRED). BOTTOM SECTION: MAGNETIC CHALKBOARD
X0053	1	FRAMED ARTWORK	VD	BY PLANET GRAPHICS. CONTACT: BRIAN BETZGER.
				PHONE: 781-829-9222. EMAIL: BRIANBETZGER@YAHOO.COM. DIMENSIONS: 2'-0W X 3'-0"H. FRAME: 3" WOOD (WD0001). IMAGE: NS0052 (SCALED AND CROPPED AS REQUIRED)
X0054	1	FRAMED ARTWORK	VD	BY PLANET GRAPHICS. CONTACT: BRIAN BETZGER.
				PHONE: 781-829-9222. EMAIL: BRIANBETZGER@YAHOO.COM. DIMENSIONS: 1'-6"W x 3'-0H. FRAME: 3" WOOD (WD0001). IMAGE: NS0165 (SCALED & CROPPED AS REQUIRED)
X0055	1	FRAMED ARTWORK	VD	BY PLANET GRAPHICS. CONTACT: BRIAN BETZGER.
				PHONE: 781-829-9222. EMAIL: BRIANBETZGER@YAHOO.COM. DIMENSIONS: 1'-6"W x 1'-4 1/2"H. FRAME: 3" WOOD (WD0001). IMAGE: NS0379 (SCALED & CROPPED AS REQUIRED)
X0056	1	FRAMED ARTWORK	VD	BY PLANET GRAPHICS. CONTACT: BRIAN BETZGER.
				PHONE: 781-829-9222. EMAIL: BRIANBETZGER@YAHOO.COM. DIMENSIONS: 1'-6"W x 1'-4 1/2"H. FRAME: 3" WOOD (WD0001). IMAGE: NS0378 (SCALED & CROPPED AS REQUIRED)
X0057	1	FRAMED ART	VD	BY PLANET GRAPHICS. CONTACT: BRIAN BETZGER. PHONE: 781-829-9222. EMAIL: BRIANBETZGER@YAHOO.COM. DIMENSIONS: 1'-6"W x 3'-0"H. FRAME: 3" WOOD (WD0001). IMAGE: NS0184 (SCALED & CROPPED AS REQUIRED)
X0058	1	FRAMED MIRROR	VD	BY PLANET GRAPHICS. CONTACT: BRIAN BETZGER.
				PHONE: 781-829-9222. EMAIL: BRIANBETZGER@YAHOO.COM. DIMENSIONS: 2'-11 1/2"W x 3'-0"H (VIF - CENTER ART ON WALL W/ 10IN CLEAR ON EITHER SIDE). FRAME: 3" WOOD (WD0001). GLASS MIRROR WITH ANTIQUE FINISH.
X0061	1	FRAMED MURAL	VD	BY PLANET GRAPHICS. CONTACT: BRIAN BETZGER.
				PHONE: 781-829-9222. EMAIL: BRIANBETZGER@YAHOO.COM. DIMENSIONS: 8'-2"W x 3'-0" (VIF - CENTER ART ON WALL W/ 10IN CLEAR ON EITHER SIDE ). FRAME: 3" WOOD (WD0001). IMAGE: NS0205 (SCALED & CROPPED AS REQUIRED)
X0062	1	FRAMED MURAL	VD	BY PLANET GRAPHICS. CONTACT: BRIAN BETZGER.
	·		_	PHONE: 781-829-9222. EMAIL: BRIANBETZGER@YAHOO.COM. DIMENSIONS: 8'-1"W x 3'-0" (VIF - CENTER ART ON WALL W/ 10IN CLEAR ON EITHER SIDE ). FRAME: 3" WOOD (WD0001). IMAGE: NS0209 (SCALED & CROPPED AS REQUIRED)
X0063	1	FRAMED MURAL	VD	BY PLANET GRAPHICS. CONTACT: BRIAN BETZGER. PHONE: 781-829-9222. EMAIL: BRIANBETZGER@YAHOO.COM. DIMENSIONS: 7'-0"W x 3'-0" (VIF - CENTER ART ON WALL ). FRAME: 3" WOOD (WD0001). IMAGE: NS0212 (SCALED & CROPPED AS
				REQUIRED)
X0064	2	BEAN JAR WITH LABEL	VD	BY PLANET GRAPHICS. CONTACT: BRIAN BETZGER. PHONE: 781-829-9222. EMAIL:
X0065	4	TEA BOX	VD	BRIANBETZGER@YAHOO.COM  BY PLANET GRAPHICS. DIMENSIONS: 6"H x 10"W x 6"D.
				CONTACT: BRIAN BETZGER. PHONE: 781-829-9222. EMAIL: BRIANTBETZGER@YAHOO.COM

		FURNITURE SCHEE	ULE - "F"	
DESIGN ID	COUNT	DESCRIPTION	RESP.	COMMENTS
12188	6	TABLE - TOP SQUARE - 24IN 610MM - WHITE WITH VEINING CP0002	WH	
CHAIR				
10256	28	CHAIR - CAFE VERTICAL RUNGS - DISTRESSED DARK WARM BROWN WD0001	WH	
12224	6	CHAIR - LOUNGE BISTRO SUITE - TWEED WOVEN F0041	WH	
12485	3	CHAIR - STOOL 29IN 735MM INDUSTRIAL UPHOLSTERED WITH BACK - BRICK RED NATURAL F0017	WH	
12489	11	CHAIR - STOOL 24IN 610MM INDUSTRIAL UPHOLSTERED WITH BACK - BRICK RED NATURAL F0017	WH	
DESK			1	
10605	1	DESK - MANAGERS WORKSTATION KEYBOARD TRAY - BLACK PLASTIC	WH	
TABLE			,	
12160	1	TABLE - ACCESSIBLE METAL SUITE - 39X23IN 990X585MM - BLACK MT0028	WH	
12161	2	TABLE - CAFE METAL SUITE SQUARE - 30IN 760MM - BLACK MT0028	WH	
12186	6	TABLE - TOP ROUND - 24IN 610MM - GREY CP0002	WH	
12190	12	TABLE - BASE CAFE ORNATE - CAST IRON BLACK MT0013	WH	
12193	7	TABLE - BASE FIXED DOME ACCENT AND GUSSETS - 36IN 915MM - HOT ROLLED STEEL MT0011	WH	

	PLUMBING FIXTURE SCHEDULE - "P"						
DESIGN ID	COUNT	DESCRIPTION	RESP.	COMMENTS			
X0021	1	GREASE TRAP	GC	ENGINEERS TO PROVIDE SPEC			
DRAIN							
10309	6	DRAIN - FLOOR SINK WITH HALF GRATE SQUARE - 12IN 305MM	WH	REFER TO SHEET P-001. ENGINEERS TO PROVIDE SPEC.			
FAUCET			<u>'</u>				
10152	1	FAUCET - DOUBLE LABORATORY WITH BENT RISER SPOUT	WH				
10153	1	FAUCET - WATER TOWER - 12IN 305MM	WH				
10215	2	FAUCET - DOUBLE LABORATORY WITH SWING SPOUT	WH				
10447	1	FAUCET - PRE RINSE SPRAYER WALL MOUNTED	WH	1.2 GPM VALVE			
10597	1	FAUCET - SINGLE HANDLE	WH	'FC' MODEL, 0.5 GPM AERATOR			
10804	1	FAUCET - PRE RINSE SWING SPOUT	WH				
10874	1	FAUCET - HOT WATER DISPENSER GOOSENECK	WH				
10922	1	FAUCET - MOP SINK WALL MOUNTED	WH				
10943	1	FAUCET - SINGLE LABORATORY WITH SWING SPOUT	WH				
11003	1	FAUCET - DIPPERWELL	WH				
FILTER							
13076	1	FILTER - PREFILTRATION SYSTEM	WH	PENTAIR WATER SYSTEM - CONFIG 1			
13080	1	FILTER - HEAD QUAD	WH	PENTAIR WATER SYSTEM - CONFIG 1			
13081	4	FILTER - CARBON FILTER CARTRIDGE	WH	PENTAIR WATER SYSTEM - CONFIG 1			
13149	1	FILTER - PRESSURE GAUGE	WH	PENTAIR WATER SYSTEM - CONFIG 1			
OTHER			·				
11109	1	WATER HEATER 50GAL 190L ELECTRIC	GC	ENGINEERS TO PROVIDE SPEC			
SINK			·				
10505	1	SINK - RINSE DROP IN - 27X20IN 685X510MM	WH				
10549	1	SINK - WORK DROP IN SST - 12X20IN 305X510MM	WH				
10581	1	SINK - HAND WALL MOUNTED SST	WH	INTEGRAL FAUCET WITH 0.5 GPM AERATOR			
10995	1	SINK - MOP - 24X24IN 610X610MM	WH				
13264	1	SINK - 3 COMP WORK SST - 93IN 2350MM	VD	ELKAY			

			LIC	SHTING FIXTURE SCHEDULE - "L"	
DESIGN ID	COUNT	DESCRIPTION	RESP.	BULB	COMMENTS
XIT					
11419	2	EMERGENCY LIGHT DOUBLE - BLACK	VD	BODINE BALLAST TYPE LED	PROVIDED BY GEXPRO.
11611	5	EMERGENCY EXIT LIGHT - WHITE	VD	BODINE BALLAST TYPE LED	PROVIDED BY GEXPRO.
LAMP				1	1
12890	15	FL T8 20-29W - 48IN 1220MM	VD	N/A	PROVIDED BY GEXPRO.
12894	4	INCAND T9 EDISON 30-39W	VD	N/A	PROVIDED BY GEXPRO.
12903	51	LED PAR 30S 10-19W NFL	VD	N/A	PROVIDED BY GEXPRO.
12906	41	LED PAR 20 1-9W NFL - WHITE	VD	N/A	PROVIDED BY GEXPRO.
PENDANT			-	1	
12348	4	PENDANT - SMALL METAL MESH CYLINDER - BLACKENED STEEL MT0019	VD	(1) 12894 - Incand. T9 Edison 30-39w	PROVIDED BY GEXPRO.
X0050	1	PENDANT - CUSTOM	GC	(16) LED - BULB MANUFACTURER: BULBRITE. CHANDELIER LITE MEDIUM (E26) BASE. ITEM#: 770411. ORDERING CODE: LED2ETC/E.	RESTORATION HARDWARE. ROPE FILAMENT RECTANGLE CHANDELIER SMALL. ITEM#: 68060369 NATL.
RECESSED	CAN				
12861	41	CAN - ADJUSTABLE RECESSED HOUSING - 4IN 100MM - NEW CEILING	VD	(1) 12906 - LED PAR 20	PROVIDED BY GEXPRO.
13241	40	CAN - ADJUSTABLE RECESSED TRIM - 4IN 100MM - WHITE	VD	N/A	PROVIDED BY GEXPRO. TRIM FOR ID: 12861.
STRIP				1	
12552	14	TASK LIGHT INTEGRATED LED - 22IN 560MM - BLACK	VD	LED	JUMPER CORD REQUIRED WHEN CONNECTING MULTIPLE UNITS - QTY: 13
TRACK				1	
11427	33	TRACK - FIXTURE ENCLOSED - 5IN 125MM - WHITE	VD	(1) 12903 - LED PAR 30S	PROVIDED BY GEXPRO.
11521	18	TRACK - FIXTURE ENCLOSED - 5IN 125MM - BLACK	VD	(1) 12903 - LED PAR 30S	PROVIDED BY GEXPRO.
12934	1	TRACK - WITH CONNECTORS - 4FT 122CM - WHITE	VD	N/A	PROVIDED BY GEXPRO.
12935	1	TRACK - WITH CONNECTORS - 8FT 244CM - WHITE	VD	N/A	PROVIDED BY GEXPRO.
12944	1	TRACK - WITH CONNECTORS - 16FT 488CM - WHITE	VD	N/A	PROVIDED BY GEXPRO.
12945	2	TRACK - WITH CONNECTORS - 12FT 365CM - WHITE	VD	N/A	PROVIDED BY GEXPRO.
12946	5	TRACK - WITH CONNECTORS - 4FT 122CM - BLACK	VD	N/A	PROVIDED BY GEXPRO.
12949	1	TRACK - WITH CONNECTORS - 12FT 365CM - BLACK	VD	N/A	PROVIDED BY GEXPRO.
TROFFER					
11404	5	TROFFER - RECESSED - 48X24IN 1220X610MM - WHITE	VD	(3) 12890 - FL T8	PROVIDED BY GEXPRO.

### NOTE: GC TO SUPPLY (1) EXTRA BOX OF REPLACEMENT BULBS FOR STORE PARTNERS; BOX TO INCLUDE ORDERING INFORMATION FOR FUTURE REPLACEMENT REQUIREMENTS.

	DOOR SCHEDULE - "D"							
DESIGN ID	COUNT	DESCRIPTION	CONSTRUCTION TYPE	FINISH	FRAME MATERIAL	FIRE RATING	RESP.	COMMENTS
10086	1	DOOR - SINGLE IMPACT DOUBLE ACTING - 36IN 915MM	SC	PLAM: WITCHCRA FT	NO FRAME	NR	VD	PROVIDED BY LOCKNET. MANUFACTURER: ELIASON. MODEL SCP8. DIMENSIONS: 3'-0"W x 7'-0"H. HARDWARE SET: #11.
10190	2	DOOR - SINGLE FLUSH - 36IN 915MM	SC	PLAM: WITCHCRA	HM2: PAINT	45MIN (PER LL DWGS)	LL	PROVIDED BY LL

#### DOOR LEGEND

Construction:	Glazing:	Frame:
SC = Solid Core HM = Hollow Metal AL = Aluminum Storefront WD = Wood Storefront E = Existing	T = Solid Core W = Hollow Metal  Rating:  NR = Non-Rated 1HR = 1 hour 2HR = 2 hour	AL = Aluminum Storefront HM1 =Hollow Metal Single Rabbet HM2 =Hollow Metal Double Rabbet HM3 =Hollow Metal Single Rabbet for CMU HM4 =Hollow Metal No Rabbet
Miscellaneous:		
U = 1/2" undercut		



#### STARBUCKS COFFEE COMPANY 2401 UTAH AVENUE SOUTH SEATTLE, WASHINGTON 98134


(206) 318-1575

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ARCHITECT OF RECORD





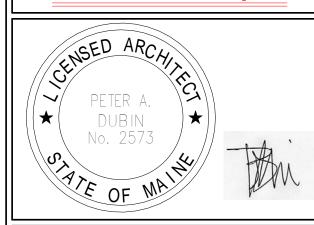

Revision Schedule					
Rev	Date	Ву	Description		

STREET PROJECT NAME:
COMMERCIAL

STORE #: 19384 PROJECT #: 58862-001 CONCEPT: MCS PALETTE: HERITAGE ISSUE DATE: JAN. 11, 2013 DESIGN MANAGER: E. ZAKAMAREK LEED® AP: PRODUCTION DESIGNER: NORR ILLINOIS

SHEET TITLE: SCHEDULES

SCALE: 1/4" = 1'-0"

SHEET NUMBER:

I-601

#### NOTE: ALL PAINTS TO BE VOC-FREE. GC TO PROVIDE.

	CEILING TREATMENT SCHEDULE - "U"					
DESIGN ID	AREA	DESCRIPTION	RESP.	COMMENTS		
OTHER			•			
10517	406 SF	ACT - WHITE - 2X2FT 61X61CM	GC	ARMSTRONG. MODEL: CLEAN ROOM VL (NONPERFORATED). COLOR: WHITE. EDGE PROFILE: SQUARE LAY-IN. ITEM#: 868 - 2X2'. SEE REFLECTED CEILING PLAN.		
11302	610 SF	ACT - WHITE - 2X4FT 61X122CM	GC	ARMSTRONG. MODEL: CLEAN ROOM VL (NONPERFORATED). COLOR: WHITE. EDGE PROFILE: SQUARE LAY-IN. ITEM#: 870 - 2X4'. SEE REFLECTED CEILING PLAN.		
X0007	1573 SF	ACT - FAUX TIN - 2X2FT	GC	ARMSTRONG. MODEL: METALWORKS - TIN. PATTERN: 56008. FINISH: COPPER (TCP). STANDARD 2X2' TEGULAR. PURCHASE GRID TO MATCH COLOR.		

		FLOOR TREAT	MENT SCHE	DULE - "T"
DESIGN ID	AREA	DESCRIPTION	RESP.	COMMENTS
PLASTIC				
X0010	581 SF	ALTRO FLOORING	GC	ALTRO FLOORING. PRODUCT: WALKWAY. COLOR: BLACK VM20892. PHONE: 1-800-377-5597.
X0011	31 SF	WALK OFF MAT - VINYL GRID - CHARCOAL	GC	GRAND ENTRANCE. MODEL: TREADLINE. COLOR: CHARCOAL. FRAME: RECESSED TAPERED ANGLE FRAME. FRAME FINISH: ANODIZED BRONZE. CONTACT: DONNA DAVIS - DMDAVIS@C-SGROUP.COM.
TILE				
12198	1088 SF	TILE - RUST BROWN - 12X24IN 305X610MM	VD	STONE PEAK. PATTERN: PARKLAND. COLOR: REDWOOD. GROUT GR0007: MAPEI 47 - CHARCOAL; LATICRETE 35 - MOCHA

	WALL BASE SCHEDULE - "B"						
DESIGN ID	LENGTH	DESCRIPTION	RESP.	COMMENTS			
TILE BASE							
12197		TILE BASE - RUST BROWN - 6X12IN 150X305MM	VD	STONE PEAK. FINISH: PARKLAND. COLOR: REDWOOD. GROUT GR0007: MAPEI 47 - CHARCOAL; LATICRETE 35 - MOCHA; USE WITH OUTSIDE CORNER TILE 13226			

WALL TREATMENT (AREA) SCHEDULE - "Q"						
DESIGN ID	AREA	DESCRIPTION	RESP.	COMMENTS		
PLASTIC			·			
11469	882 SF	FRP - WHITE	GC	MARLITE. STANDARD FRP. SMOOTH SURFACE. S 100 S/2/S WHITE.		
TILE						
12216	122 SF	TILE - ANTIQUE CREAM - 2X8IN 50X205MM	VD	MUTUAL MATERIALS. COLOR: PEWTER. GROUT GR0003: MAPEI 02 PEWTER; LATICRETE 78 - STERLING SILVER		

WALL TREATMENT (LENGTH) SCHEDULE- "R"									
<b>DESIGN ID</b>	LENGTH	DESCRIPTION	RESP.	COMMENTS					
CHAIR RAIL			•						
12173	93' - 8 1/4"	CHAIR RAIL - 4IN 100MM AT 48IN 1220MM AFF	VD	WD0001					
X0009 177' - 7 3/4" CROWN MOULDING			VD	DYKES LUMBER CO. MOULD#: 165. HEIGHT & PROJECTIONS: 2 1/2IN. MATERIAL: PRIMED ULTRALIGHT MDF. VENDOR: FYPON. PHONE: 1-800-446-3040. STAIN: WD0001.					
RAILING			•						
X0043	6' - 11"	WOOD TRIM - 2IN	VD	WD0001					
TRIM			•						
X0049	40' - 11"	SOFFIT TRIM	VD	WD0001					
WAINSCOT			•						
12814	119' - 6 3/4"	VINYL - WAINSCOT - DARK BROWN WOVEN PATTERN AT 48IN 1220MM AFF	VD	INSTALL AT CUSTOM HEIGHT AS INDICATED ON INTERIOR ELEVATIONS GC TO VERIFY HEIGHT AND CUT IN-FIELD.					

NOTE: CASEWORK VENDOR TO PROVIDE ALL ITEMS IN WALL TREATMENT (LENGTH) SCHEDULE AS WELL AS CASEWORK SCHEDULE.

X0002			05140514	COLUMN T. HOL
X0002	COUNT		RESP.	SCHEDULE - "C"  COMMENTS
	1	TABLE - COMMUNITY - CUSTOM	VD	Dimensions: 36"W x 108"L x 30.5"H. Wood Top Finish: WD0001 / Thickness: 1-1/2". Turned Wood Legs: Adams Wood Products - Model: A0901-28 Turned Table Leg. Size: 29" x 2 3/4". Wood: Paint Grade. Qty: 6. Vendor to procure legs, paint P551-ES (Sherwin Williams SW6148 Wool Skein), install as finished unit.
X0003 X0017	1	BANQUETTE - CUSTOM DRINK RAIL	VD VD	WOOD FINISH: WD0001 DIMENSIONS: 4"W x 12'-0"L x 3'-6"H. WOOD TOP FINISH: WD0001 / THICKNESS: 2". BASE:
				STEEL (MT0011)
X0018 X0019	1	CONDIMENT CART TOP - SOLID SURFACE - CUSTOM CONDIMENT CART BASE CABINET - CUSTOM	VD VD	CP0008 - OGEE EDGE PROFILE ON 2IN THICK SOLID SURFACE WITCHCRAFT. FINISHED BACK.
X0022	8	BRACKETS AT CUSTOMER COUNTER	VD	Manufacturer: Van Dyke's Restorers. Model: Restorers Shelf Bracket. Store ID: 203407. Height: 11"; Projection: 8 3/4"; Width: 1 1/8". Finish: Black Powder.
X0024	1	FOOT RAIL - CUSTOM	VD	MT0011. STARBUCKS LOCAL VENDOR. LENGTH: 7'-0".
X0025 X0026	1	FOOT RAIL - CUSTOM FOOT RAIL - CUSTOM	VD VD	MT0011. STARBUCKS LOCAL VENDOR. LENGTH: 5'-6". MT0011. STARBUCKS LOCAL VENDOR. LENGTH: 7'-6".
X0046	1	FOOT RAIL - CUSTOM	VD	MT0011. STARBUCKS LOCAL VENDOR. LENGTH: 7-6".
CABINET 11942	1	CABINET - WARMING WITH DRAWER - 16IN 405MM	VD	WITCHCRAFT PLAM
11971	1	CABINET - SINK OR ICE BIN - 15IN 380MM	VD	WITCHCRAFT PLAM
11972 11977	1 13	CABINET - ESPRESSO - 24IN 610MM CABINET - UPPER CUBBY - 24X16X21IN	VD VD	WITCHCRAFT PLAM WITCHCRAFT PLAM
12007	2	610X405X535MM CABINET - SINK OR ICE BIN - 24IN 610MM	VD	WITCHCRAFT PLAM
12034	1	CABINET - VARIABLE TO 36IN 915MM	VD	WITCHCRAFT PLAM
12043 12046	2	CABINET - POS - 29IN 735MM CABINET - END CAP - 12IN 305MM	VD VD	WITCHCRAFT PLAM WITCHCRAFT PLAM
12080	4	CABINET - 15IN 380MM	VD	WITCHCRAFT PLAM
12096 12098	3	CABINET - WITH DRAWER - 15IN 380MM  CABINET - BREW GRIND - 24IN 610MM	VD VD	WITCHCRAFT PLAM WITCHCRAFT PLAM
13250	1	CABINET - UPPER CUBBY 1 SHELF - VARIABLE TO 24IN 610MM  CABINET - RESERVE TOWER - RH	VD	WITCHCRAFT PLAM  MT0028
13646	1	CABINET - RESERVE CLOVER WITH DRAWER - 12IN	VD	WITCHCRAFT PLAM
X0008	1	305MM CABINET - STORAGE - CUSTOM	VD	DIMENSIONS: 6'-10"H x 2'-10"W x STANDARD DEPTH. BASE: 6IN STAINLESS STEEL LEGS.
X0013	1	CABINET - PACKAGED FOOD CUBBY INSET	VD	SIM TO 12846; CUSTOM HEIGHT: 4'-9"
COUNTERTO	ЭР 1	COUNTERTOP - HAND SINK STAINLESS - 15IN 380MM	VD	STAINLESS STEEL
11917 11929	1	COUNTERTOP - TRASH SOLID SURFACE - 15IN 380MM COUNTERTOP - CBS SOLID SURFACE - RH - 108IN	VD VD	CP0001 CP0001
11933	1	2745MM COUNTERTOP - WARMING SOLID SURFACE - 16IN	VD	CP0001
12011	1	405MM COUNTERTOP - POS SOLID SURFACE - 80IN 2030MM	VD	CP0001
12769	1	COUNTERTOP - ESPRESSO RINSE SINK AND ICE BIN STAINLESS - RH - 140IN 3555MM	VD	STAINLESS STEEL
13367	1	COUNTERTOP - RESERVE CLOVER HANDOFF SOLID SURFACE - RH	VD	CP0001
13653	1	COUNTERTOP - RESERVE CORNER SOLID SURFACE - RH	VD	CP0001
X0004	1	SIT-HERE COUNTER - 'L'	VD	WD0001
X0005 X0006	1	SIT-HERE COUNTER - STRAIGHT COUNTERTOP - BREW GRIND WORK SINK AND	VD VD	WD0001 CP0001. SIM TO 12875. CUSTOM WORK SINK CUT-OUT
70000	'	TRASH SOLID SURFACE - RH - 117IN 2970MM - CUSTOM		61 0001. GIW 10 12073. GOGTGW WORK GIVE GOT-GOT
X0044	1	COUNTERTOP - END CAP SOLID SURFACE - CUSTOM	VD	CP0001. DIMENSIONS: 1'- 1 1/2"W x 2'-6"L x 1 1/4" THICK.
DESK X0030	1	DESK - MANAGERS WORKSTATION - 48X30X30IN	VD	ALMOND PLAM. SIM TO 10123; CUSTOM LENGTH: 4'-0"
X0031	1	1525X760X760MM - ALMOND LAMINATE DESK - MANAGERS WORKSTATION SHELVES WALL	VD	ALMOND PLAM. SIM TO 10809; CUSTOM LENGTH: 4'-0"
		MOUNTED - ALMOND LAMINATE		ALMOND LEMM TO TODOS, GOSTOM LEMOTH. TO
DIEWALL 12526	1	DIEWALL - RESERVE - RH	VD	FRP AT PARTNER SIDE
12767 12770	1	DIEWALL - ESPRESSO TOP CAP - RH - 140IN 3555MM DIEWALL - ESPRESSO - RH - 140IN 3555MM	VD VD	WD0001 FRP AT PARTNER SIDE
X0001	1	DIEWALL - RESERVE TOP CAP - RH - CUSTOM	VD	WD0001. SIM TO 13319; CUSTOM DEPTH
FIT KIT 13328	1	FIT KIT - RESERVE CORNER	VD	WITCHCRAFT PLAM
OTHER			1.75	
11155	2	ESPRESSO MACHINE PUMP MOUNT - 10X10IN 255X255MM	VD	
11815 12100	5 4	CORNER GUARD - 1.25IN 30MM - HOT ROLLED STEEL ESPRESSO COUNTERTOP SUPPORT LEG STAINLESS	VD	MT0011 STAINLESS STEEL
12763	1	ESPRESSO SNEEZE GUARD - 140IN 3555MM	VD	
12816 X0016	<u>4</u> 1	FRENCH CLEAT - VARIABLE TO 96IN 2440MM RESERVE SNEEZE GUARD - CUSTOM	VD VD	LENGTH: 27'-6" (SEE UPPER CASEWORK PLAN) SIM TO 13350; CUSTOM LENGTH. ORDER ONLY AS REQUIRED BY LOCAL HEALTH
X0020	1	CONDIMENT CART TOE KICK - CUSTOM	VD	JURISDICTION. HEIGHT: 3 7/8"
X0020 X0027	3	RESERVE - DISPLAY SHELF	VD	WITCHCRAFT PLAM. DIMENSIONS: 10"D x 3'-6"L. 3/4"-HIGH LIP ON ALL EXPOSED SIDES.
	1	WOOD WINDOW SILL	VD	FINISH: WITCHCRAFT PLAM. WD0001. THICKNESS: 3/4"; LENGTH: 7'-10 1/2"; WIDTH: 9". FINISH: WD0001.
X0035				
X0036	1	WOOD WINDOW SILL	VD	WD0001. THICKNESS: 3/4"; LENGTH: 7'-10 1/2"; WIDTH: 9". FINISH: WD0001.
	1 1 1		VD VD VD	WD0001. THICKNESS: 3/4"; LENGTH: 7'-10 1/2"; WIDTH: 9". FINISH: WD0001.  WD0001. THICKNESS: 3/4"; LENGTH: 7'-10"; WIDTH: 9". FINISH: WD0001.  WD0001. THICKNESS: 3/4"; LENGTH: 7'-10"; WIDTH: 9". FINISH: WD0001.
X0036 X0037 X0038 X0039	1 1 1	WOOD WINDOW SILL WOOD WINDOW SILL WOOD WINDOW SILL WOOD WINDOW SILL	VD VD VD	WD0001. THICKNESS: 3/4"; LENGTH: 7'-10"; WIDTH: 9". FINISH: WD0001. WD0001. THICKNESS: 3/4"; LENGTH: 7'-10"; WIDTH: 9". FINISH: WD0001. WD0001. THICKNESS: 3/4"; LENGTH: 7'-10"; WIDTH: 9". FINISH: WD0001.
X0036 X0037 X0038	1	WOOD WINDOW SILL WOOD CASING 1	VD VD VD VD	WD0001. THICKNESS: 3/4"; LENGTH: 7'-10"; WIDTH: 9". FINISH: WD0001. WD0001. THICKNESS: 3/4"; LENGTH: 7'-10"; WIDTH: 9". FINISH: WD0001. WD0001. THICKNESS: 3/4"; LENGTH: 7'-10"; WIDTH: 9". FINISH: WD0001. WD0001. THICKNESS: 1"; LENGTH: 7'-10"; WIDTH: 9". FINISH: WD0001. WD0001
X0036 X0037 X0038 X0039 X0040 X0041 X0042	1 1 1 1	WOOD WINDOW SILL WOOD CASING 1 WOOD CASING 2	VD VD VD VD VD VD VD	WD0001. THICKNESS: 3/4"; LENGTH: 7'-10"; WIDTH: 9". FINISH: WD0001. WD0001. THICKNESS: 3/4"; LENGTH: 7'-10"; WIDTH: 9". FINISH: WD0001. WD0001. THICKNESS: 3/4"; LENGTH: 7'-10"; WIDTH: 9". FINISH: WD0001. WD0001. THICKNESS: 1"; LENGTH: 7'-10"; WIDTH: 9". FINISH: WD0001. WD0001 WD0001
X0036 X0037 X0038 X0039 X0040 X0041 X0042 X0067 PANEL	1 1 1 1 1	WOOD WINDOW SILL WOOD CASING 1 WOOD CASING 2 FRONTLINE END CAB TOE KICK - CUSTOM	VD VD VD VD VD VD VD VD	WD0001. THICKNESS: 3/4"; LENGTH: 7'-10"; WIDTH: 9". FINISH: WD0001. WD0001. THICKNESS: 3/4"; LENGTH: 7'-10"; WIDTH: 9". FINISH: WD0001. WD0001. THICKNESS: 3/4"; LENGTH: 7'-10"; WIDTH: 9". FINISH: WD0001. WD0001. THICKNESS: 1"; LENGTH: 7'-10"; WIDTH: 9". FINISH: WD0001. WD0001 WD0001 HEIGHT: 5 7/8"
X0036 X0037 X0038 X0039 X0040 X0041 X0042 X0067 PANEL 11957	1 1 1 1 1	WOOD WINDOW SILL WOOD CASING 1 WOOD CASING 2	VD VD VD VD VD VD VD	WD0001. THICKNESS: 3/4"; LENGTH: 7'-10"; WIDTH: 9". FINISH: WD0001. WD0001. THICKNESS: 3/4"; LENGTH: 7'-10"; WIDTH: 9". FINISH: WD0001. WD0001. THICKNESS: 3/4"; LENGTH: 7'-10"; WIDTH: 9". FINISH: WD0001. WD0001. THICKNESS: 1"; LENGTH: 7'-10"; WIDTH: 9". FINISH: WD0001. WD0001 WD0001
X0036 X0037 X0038 X0039 X0040 X0041 X0042 X0067 PANEL	1 1 1 1 1 1 1 1 1	WOOD WINDOW SILL WOOD CASING 1 WOOD CASING 2 FRONTLINE END CAB TOE KICK - CUSTOM  PANEL - CUP DISPENSER PANEL - POS - 29IN 735MM PANEL - POS BRIDGE FOR SAFE - 22X27IN	VD	WD0001. THICKNESS: 3/4"; LENGTH: 7'-10"; WIDTH: 9". FINISH: WD0001. WD0001. THICKNESS: 3/4"; LENGTH: 7'-10"; WIDTH: 9". FINISH: WD0001. WD0001. THICKNESS: 3/4"; LENGTH: 7'-10"; WIDTH: 9". FINISH: WD0001. WD0001. THICKNESS: 1"; LENGTH: 7'-10"; WIDTH: 9". FINISH: WD0001. WD0001 WD0001 HEIGHT: 5 7/8"
X0036 X0037 X0038 X0039 X0040 X0041 X0042 X0067 PANEL 11957 12028	1 1 1 1 1 1 1 1 1	WOOD WINDOW SILL WOOD CASING 1 WOOD CASING 2 FRONTLINE END CAB TOE KICK - CUSTOM  PANEL - CUP DISPENSER PANEL - POS - 29IN 735MM	VD	WD0001. THICKNESS: 3/4"; LENGTH: 7'-10"; WIDTH: 9". FINISH: WD0001. WD0001. THICKNESS: 3/4"; LENGTH: 7'-10"; WIDTH: 9". FINISH: WD0001. WD0001. THICKNESS: 3/4"; LENGTH: 7'-10"; WIDTH: 9". FINISH: WD0001. WD0001. THICKNESS: 1"; LENGTH: 7'-10"; WIDTH: 9". FINISH: WD0001. WD0001 WD0001 HEIGHT: 5 7/8" WITCHCRAFT PLAM WD0018 WD0018
X0036 X0037 X0038 X0039 X0040 X0041 X0042 X0067 PANEL 11957 12028 12050	1 1 1 1 1 1 1 1 1 2	WOOD WINDOW SILL WOOD CASING 1 WOOD CASING 2 FRONTLINE END CAB TOE KICK - CUSTOM  PANEL - CUP DISPENSER PANEL - POS - 29IN 735MM PANEL - POS BRIDGE FOR SAFE - 22X27IN 560X685MM	VD	WD0001. THICKNESS: 3/4"; LENGTH: 7'-10"; WIDTH: 9". FINISH: WD0001. WD0001. THICKNESS: 3/4"; LENGTH: 7'-10"; WIDTH: 9". FINISH: WD0001. WD0001. THICKNESS: 3/4"; LENGTH: 7'-10"; WIDTH: 9". FINISH: WD0001. WD0001. THICKNESS: 1"; LENGTH: 7'-10"; WIDTH: 9". FINISH: WD0001. WD00001 WD00001 HEIGHT: 5 7/8"  WITCHCRAFT PLAM WD0018 WD0018
X0036 X0037 X0038 X0039 X0040 X0041 X0042 X0067 PANEL 11957 12028 12050 12473 12768	1 1 1 1 1 1 1 1 2 1	WOOD WINDOW SILL WOOD CASING 1 WOOD CASING 2 FRONTLINE END CAB TOE KICK - CUSTOM  PANEL - CUP DISPENSER PANEL - POS - 29IN 735MM PANEL - POS BRIDGE FOR SAFE - 22X27IN 560X685MM PANEL - POS - 22IN 560MM PANEL - ESPRESSO - RH - 140IN 3555MM  PANEL - RESERVE - RH	VD V	WD0001. THICKNESS: 3/4"; LENGTH: 7'-10"; WIDTH: 9". FINISH: WD0001. WD0001. THICKNESS: 3/4"; LENGTH: 7'-10"; WIDTH: 9". FINISH: WD0001. WD0001. THICKNESS: 3/4"; LENGTH: 7'-10"; WIDTH: 9". FINISH: WD0001. WD0001. THICKNESS: 1"; LENGTH: 7'-10"; WIDTH: 9". FINISH: WD0001. WD0001 WD0001 HEIGHT: 5 7/8"  WITCHCRAFT PLAM WD0018 WD0018 WD0018 WD0018. HANDOFF FINISH PANEL NOT REQUIRED WHEN INCORPORATING RESERVE STATION. VERIFY DESIGN PRIOR TO FABRICATION. WD0018
X0036 X0037 X0038 X0039 X0040 X0041 X0042 X0067 PANEL 11957 12028 12050	1 1 1 1 1 1 1 1 2 1	WOOD WINDOW SILL WOOD CASING 1 WOOD CASING 2 FRONTLINE END CAB TOE KICK - CUSTOM  PANEL - CUP DISPENSER PANEL - POS - 29IN 735MM PANEL - POS BRIDGE FOR SAFE - 22X27IN 560X685MM PANEL - POS - 22IN 560MM PANEL - ESPRESSO - RH - 140IN 3555MM	VD V	WD0001. THICKNESS: 3/4"; LENGTH: 7'-10"; WIDTH: 9". FINISH: WD0001. WD0001. THICKNESS: 3/4"; LENGTH: 7'-10"; WIDTH: 9". FINISH: WD0001. WD0001. THICKNESS: 3/4"; LENGTH: 7'-10"; WIDTH: 9". FINISH: WD0001. WD0001. THICKNESS: 1"; LENGTH: 7'-10"; WIDTH: 9". FINISH: WD0001. WD0001 WD0001 HEIGHT: 5 7/8"  WITCHCRAFT PLAM WD0018 WD0018 WD0018 WD0018. HANDOFF FINISH PANEL NOT REQUIRED WHEN INCORPORATING RESERVE STATION. VERIFY DESIGN PRIOR TO FABRICATION.
X0036 X0037 X0038 X0039 X0040 X0041 X0042 X0067 PANEL 11957 12028 12050 12473 12768 13353 X0012 X0014 X0032	1 1 1 1 1 1 1 1 2 1 1 1 1 1	WOOD WINDOW SILL WOOD CASING 1 WOOD CASING 2 FRONTLINE END CAB TOE KICK - CUSTOM  PANEL - CUP DISPENSER PANEL - POS - 29IN 735MM PANEL - POS BRIDGE FOR SAFE - 22X27IN 560X685MM PANEL - POS - 22IN 560MM PANEL - ESPRESSO - RH - 140IN 3555MM  PANEL - RESERVE - RH PANEL - UPRIGHT FOOD CASE SIDE PANEL - UPRIGHT FOOD CASE FRONT - CUSTOM PANEL - UPRIGHT FOOD CASE SIDE	VD V	WD0001. THICKNESS: 3/4"; LENGTH: 7'-10"; WIDTH: 9". FINISH: WD0001. WD0001. THICKNESS: 3/4"; LENGTH: 7'-10"; WIDTH: 9". FINISH: WD0001. WD0001. THICKNESS: 3/4"; LENGTH: 7'-10"; WIDTH: 9". FINISH: WD0001. WD0001. THICKNESS: 1"; LENGTH: 7'-10"; WIDTH: 9". FINISH: WD0001. WD0001 WD0001 HEIGHT: 5 7/8"  WITCHCRAFT PLAM WD0018 WD0018 WD0018 WD0018. HANDOFF FINISH PANEL NOT REQUIRED WHEN INCORPORATING RESERVE STATION. VERIFY DESIGN PRIOR TO FABRICATION. WD0018. SIM TO 13580 WD0018. SIM TO 13571; CUSTOM LENGTH WD0018. SIM TO 13580
X0036 X0037 X0038 X0039 X0040 X0041 X0042 X0067 PANEL 11957 12028 12050 12473 12768 13353 X0012 X0014	1 1 1 1 1 1 1 1 2 1 1	WOOD WINDOW SILL WOOD WINDOW SILL WOOD WINDOW SILL WOOD WINDOW SILL WOOD CASING 1 WOOD CASING 2 FRONTLINE END CAB TOE KICK - CUSTOM  PANEL - CUP DISPENSER PANEL - POS - 29IN 735MM PANEL - POS BRIDGE FOR SAFE - 22X27IN 560X685MM PANEL - POS - 22IN 560MM PANEL - ESPRESSO - RH - 140IN 3555MM  PANEL - RESERVE - RH PANEL - UPRIGHT FOOD CASE SIDE PANEL - UPRIGHT FOOD CASE FRONT - CUSTOM	VD V	WD0001. THICKNESS: 3/4"; LENGTH: 7'-10"; WIDTH: 9". FINISH: WD0001. WD0001. THICKNESS: 3/4"; LENGTH: 7'-10"; WIDTH: 9". FINISH: WD0001. WD0001. THICKNESS: 3/4"; LENGTH: 7'-10"; WIDTH: 9". FINISH: WD0001. WD0001. THICKNESS: 1"; LENGTH: 7'-10"; WIDTH: 9". FINISH: WD0001. WD0001 WD0001 HEIGHT: 5 7/8"  WITCHCRAFT PLAM WD0018 WD0018 WD0018 WD0018. HANDOFF FINISH PANEL NOT REQUIRED WHEN INCORPORATING RESERVE STATION. VERIFY DESIGN PRIOR TO FABRICATION. WD0018 WD0018. SIM TO 13580 WD0018. SIM TO 13571; CUSTOM LENGTH
X0036 X0037 X0038 X0039 X0040 X0041 X0042 X0067 PANEL 11957 12028 12050 12473 12768 13353 X0012 X0014 X0032 X0045 X0051 X0060	1 1 1 1 1 1 1 1 2 1 1 1 1 1 1 1 1	WOOD WINDOW SILL WOOD WINDOW SILL WOOD WINDOW SILL WOOD WINDOW SILL WOOD CASING 1 WOOD CASING 2 FRONTLINE END CAB TOE KICK - CUSTOM  PANEL - CUP DISPENSER PANEL - POS - 29IN 735MM PANEL - POS BRIDGE FOR SAFE - 22X27IN 560X685MM PANEL - POS - 22IN 560MM PANEL - ESPRESSO - RH - 140IN 3555MM  PANEL - RESERVE - RH PANEL - UPRIGHT FOOD CASE SIDE PANEL - UPRIGHT FOOD CASE SIDE PANEL - UPRIGHT FOOD CASE SIDE PANEL - FRONTLINE - CUSTOM	VD V	WD0001. THICKNESS: 3/4"; LENGTH: 7'-10"; WIDTH: 9". FINISH: WD0001. WD0001. THICKNESS: 3/4"; LENGTH: 7'-10"; WIDTH: 9". FINISH: WD0001. WD0001. THICKNESS: 3/4"; LENGTH: 7'-10"; WIDTH: 9". FINISH: WD0001. WD0001. THICKNESS: 1"; LENGTH: 7'-10"; WIDTH: 9". FINISH: WD0001. WD0001 WD0001 HEIGHT: 5 7/8"  WITCHCRAFT PLAM WD0018 WD0018 WD0018 WD0018. HANDOFF FINISH PANEL NOT REQUIRED WHEN INCORPORATING RESERVE STATION. VERIFY DESIGN PRIOR TO FABRICATION. WD0018 WD0018. SIM TO 13580 WD0018. SIM TO 11907; CUSTOM LENGTH
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	CW FINISH - NCS HERITAGE	E11.11.6	1
LOCATION	DESCRIPTION	FINISH	COMMENTS
COMPOSITE - DARK GREY WITH FLECKS	DESCRIPTION	CODE	COMMENTS
BACKBAR COUNTERTOPS	COMPOSITE - DARK GREY WITH FLECKS	CP0001	
CONDIMENT CART TOP	COMPOSITE - DARK GREY WITH FLECKS	CP0001	
HANDOFF PLANE	COMPOSITE - DARK GREY WITH FLECKS	CP0001	
POS, FRONTBAR COUNTERTOPS	COMPOSITE - DARK GREY WITH FLECKS	CP0001	
	COMPOSITE - DARK GRET WITH FLECKS	CPUUUT	
FLAT BLACK POWDER COAT	FLAT BLACK POWDER COAT	MTOOOG	1
RESERVE TOWER	FLAT BLACK POWDER COAT	MT0028	
HOT ROLLED STEEL WITH MATTE SEALER	LIOT BOLLED OTEFL WITH MATTE OF ALED	NATOOAA	
CORNER GUARDS	HOT ROLLED STEEL WITH MATTE SEALER		
FINISH PANEL BRACKETS	HOT ROLLED STEEL WITH MATTE SEALER		
FINISH PANEL TRIM	HOT ROLLED STEEL WITH MATTE SEALER	MT0011	
PLASTIC LAMINATE - ALMOND (ST655-S)	T	1	
CORE CASEWORK INTERIOR	PLASTIC LAMINATE - ALMOND (ST655-S)		
PLASTIC LAMINATE - BLACK			
ESPRESSO, POS, FRONTBAR CABINET BACK	PLASTIC LAMINATE - BLACK		
POS, FRONTBAR CABINET SIDE	PLASTIC LAMINATE - BLACK		
PLASTIC LAMINATE - PIONITE WITCHCRAF	Γ WX421		
BACKBAR CASEWORK EXTERIOR	PLASTIC LAMINATE - PIONITE WITCHCRAFT WX421		
BACKBAR STORAGE CUBBIES	PLASTIC LAMINATE - PIONITE		
	WITCHCRAFT WX421		
CONDIMENT CART	PLASTIC LAMINATE - PIONITE WITCHCRAFT WX421		FINISH BACK SIDE AS WELL
RESERVE DISPLAY SHELVES	PLASTIC LAMINATE - PIONITE WITCHCRAFT WX421		
STAINLESS STEEL - #4 BRUSHED 16GA SST			
ESPRESSO COUNTERTOP	STAINLESS STEEL - #4 BRUSHED 16GA SST		
HAND SINK COUNTERTOP	STAINLESS STEEL - #4 BRUSHED 16GA		
OMITOURI ATE DART WATER AND OF VENET	SST		
SWITCHPLATE - PART #4752-112-CD VENET		1	100000000
OVER "BLACK" DUPLEX OUTLETS IN	SWITCHPLATE - PART #4752-112-CD		GC SUPPLIED
WAINSCOT LOCATIONS	VENETIAN BRONZE		
WOOD - DARK RED	IMOOD DADK DED	IM/Doodo	DI ANIKINIO MITLI MITDED
ESPRESSO FINISH PANELS	WOOD - DARK RED	WD0018	PLANKING WITH MITRED CORNERS
ESPRESSO WING, HANDOFF FINISH PANELS	WOOD - DARK RED	WD0018	PLANKING WITH MITRED CORNERS
FOOD CASE WALL CLADDING	WOOD - DARK RED	WD0018	PLANKING WITH MITRED CORNERS
POS, FRONTBAR FINISH PANELS	WOOD - DARK RED	WD0018	PLANKING WITH MITRED CORNERS
WALL CLADDING PANELS	WOOD - DARK RED	WD0018	PLANKING WITH MITRED CORNERS
WOOD - WARM BROWN DARK TONE DISTR	L ESSED	I	
2IN TRIM AT BACKBAR WALL TILE	WOOD - WARM BROWN DARK TONE	WD0001	
	DISTRESSED		
BANQUETTE - FINISHED BACK PANEL	WOOD - WARM BROWN DARK TONE DISTRESSED	WD0001	
CASED OPENING TRIM	WOOD - WARM BROWN DARK TONE DISTRESSED	WD0001	
CHAIR RAIL	WOOD - WARM BROWN DARK TONE DISTRESSED	WD0001	
CROWN MOULDING	WOOD - WARM BROWN DARK TONE DISTRESSED	WD0001	
ESPRESSO TOP CAP & CUSTOMER COUNTER	WOOD - WARM BROWN DARK TONE DISTRESSED	WD0001	LIVE EDGE; DESIGNER TO SPECIFY STRAIGHT EDGE I NEEDED
SIT-HERE COUNTERTOPS	WOOD - WARM BROWN DARK TONE DISTRESSED	WD0001	
SOFFIT TRIM	WOOD - WARM BROWN DARK TONE DISTRESSED	WD0001	
WOOD TRIM/SILLS AT WINDOW	WOOD - WARM BROWN DARK TONE	WD0001	

#### RESPONSIBILITY LEGEND

WH - STARBUCKS

GC - GENERAL CONTRACTOR

VD - VENDOR

LL - LANDLORD



## STARBUCKS COFFEE COMPANY 2401 UTAH AVENUE SOUTH SEATTLE, WASHINGTON 98134


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ARCHITECT OF RECORD







		Revision	on Schedule
Rev	Date	Ву	Description
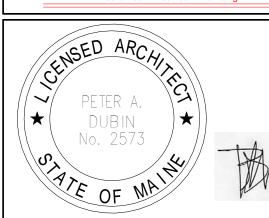
## PROJECT NAME: COMMERCIAL STREET PROJECT ADDRESS: 145 COMMERCIAL STREET PORTLAND, ME 04101 CUMBERLAND COUNTY

STORE #: 19384

PROJECT #: 58862-001

CONCEPT: MCS

PALETTE: HERITAGE

ISSUE DATE: JAN. 11, 2013

DESIGN MANAGER: E. ZAKAMAREK

LEED® AP:

PRODUCTION DESIGNER: NORR ILLINOIS

CHECKED BY:

SHEET TITLE: SCHEDULES

SCALE: 1/4" = 1'-0"

SHEET NUMBER:

I-602

#### **General Mechanical Notes**

1. Mechanical Contractor shall coordinate with the General Contractor to patch and repair all existing walls, floors, ceilings or other surfaces identified to remain that may become damaged during the course of work.

2. Drawings are diagrammatic and indicate general intent or arrangement of system(s). Furnish & Install all components needed whether indicated or not to provide a complete and operating system.

3. Contractor to verify all dimensions, including clearances required by other trades, and notify Starbucks Construction Manager of any discrepancies prior to proceeding with the work. All dimensions are to the face of the finished surface unless noted otherwise. All dimensions to be taken from from actual building dimensions.

4. The Mechanical Contractor shall coordinate HVAC work with other trades. The architectural drawings shall take precedence over all other drawings. See architectural drawings for dimensioned diffuser locations and mounting heights where exposed.

5. New ductwork and equipment shall not be installed where it obstructs any existing or new areas that require access.

#### **General Specification Notes**

The intent of the Specifications and the Drawings is to provide a complete and fully operational mechanical system. The Mechanical Contractor shall furnish all labor, material, and equipment necessary to complete the mechanical work.

The Mechanical Contractor shall thoroughly examine all areas where equipment, ductwork, and piping will be installed and will report any condition that, in his opinion, prevents the proper installation of the mechanical work.

Equipment and materials shall conform with the appropriate provisions of CSA, ULC, ARL, ASME, ASTM, UL, NEMA, ANSI, SMACNA, ASHRAE, NFPA, as applicable to each individual unit or assembly.

All work shall be performed in strict accordance with all applicable provincial and local codes and ordinances. In case of conflict between the drawings and specifications and the codes and ordinances, the highest standard shall apply. The Mechanical Contractor shall satisfy code requirements as a minimum standard without any extra cost to Starbucks.

The Mechanical Contractor shall procure and pay for all permits, fees, and inspections necessary to complete the mechanical work.

The Mechanical Contractor shall unconditionally warrant all work to be free of defects in material and workmanship for a period of one (1) year from the date of final acceptance by Starbucks and will repair or replace any defective work promptly and without charge and restore any other existing work damaged in the course of repairing defective materials and workmanship.

All work, materials and equipment shall meet LEED requirements & code. In case of conflict, the higher Standard shall apply.

#### Testing, Adjusting, Balancing

Independent Air balance Contractor or qualified mechanical contractor shall accurately balance the air (including exhaust fan[s]) and hydronic (where applicable) systems to provide air and water quantities indicated on the drawings and in this specification. Balancer shall be qualified for TAB work per NEBB or AABC standards. Operate automatic controls system and verify set points. Submit two (2) copies of the balance report to the Engineer and commissioning agent for approval. Include a copy of the balance report as approved by the Engineer with application for final contract payment.

#### **Ductwork and Accessories**

#### **Sheetmetal Ductwork**

All ductwork to be rigid sheetmetal constructed from galvanized sheet steel in accordance with SMACNA low velocity duct construction standards. Fiberglass ductboard is not allowed. All exposed ductwork to be spiral round, or rectangular lock-seam type, as shown on HVAC Plan sheet. Assemble and install ductwork in accordance with recognized industry practice for achieving air tight (5% leakage) and noiseless (no objectionable noise) systems, capable of performing each indicated service. Furnish and install all required dampers, transitions, connections to air terminals, and other accessories necessary for complete operating system. No variation of duct configuration or sizes will be permitted except by permission from the Engineer.

Seal all longitudinal and transverse joints with a non-hardening, non-migrating mastic or liquid elastic sealant, with VOC content no greater than 250g/L and of a type recommended by the manufacturer for sealing joints and seams in sheet metal ductwork. Cover all field joints, joints around spin-in fittings, and fastening screws with mastic.

#### Provide hot-dipped galvanized steel, fasteners, anchors, rods, straps, trim, and angles for

#### Dampers

Provide opposed-blade, multi-leaf volume control dampers where indicated on drawings and at points on low pressure supply, return, and exhaust ducts where branches are taken from larger ducts. Provide UL listed fire or fire/smoke dampers where required and in accordance with NFPA and local codes. Provide conveniently located access doors of ample size and quantity for servicing the dampers. Provide motorized dampers at all intake & exhaust building openings in accordance with local codes. Coordinate with other trades for access panels, power & fire alarm

#### Grilles, Registers, and Diffusers

Grilles, registers, and diffusers shall be as specified and shall be Mechanical Contractor supplied, unless otherwise noted. Diffusers shall be installed as indicated on the drawings and schedules. The Mechanical Contractor shall provide all miscellaneous items necessary for a complete and proper installation in the type of ceiling and walls used in this project.

#### Thermal Insulation

Provide external thermal insulation with an integral vapor barrier facing of sufficient thickness to meet local energy code requirements or ASHRAE 90.1-2004, whichever is more stringent. Provide insulation on exhaust and outside air ducts, and on concealed portions of supply and return air ducts. Do not externally insulate exposed ductwork and portions of ductwork that are internally lined with code required thickness. Thermal insulation to comply with an AFPA flame spread of 25 or less, and smoke developed no greater then 50. Internally insulate Exterior ductwork per Code.

#### **Acoustical Duct Liner**

Unless otherwise indicated on the plans, provide 1" (25mm) glass fiber acoustical duct liner on supply and return ductwork within 10'-0" (305cm) of the discharge and intake of air handling units. Increase duct size indicated on plans as needed to accommodate liner. Lines shall be fastened to duct with mechanical liner fasteners in accordance with SMACNA.


#### Flexible Ductwork

Flexible duct work shall only be installed as shown in plan and not above hard lid ceilings. Flexible ductwork shall not exceed 5'-0" (152cm) in length and two 45° elbows. It shall be pulled taut and appropriately fastened to rigid branch duct & diffuser. Bends shall be minimized and where needed be a full radius bend. Support bands shall be installed so as to not crimp flex duct. Flexible ductwork shall be UL 181 Listed as a Class 1 air duct.

#### Damper Air Leakage

Motorized and non-motorized dampers used for outside air intakes, exhaust & return outlets (including those within HVAC equipment) shall have a maximum air leakage value per the Energy Code or ASHRAE 90.1 when tested per AMCA Std 500.

#### Mechanical Symbol Legend

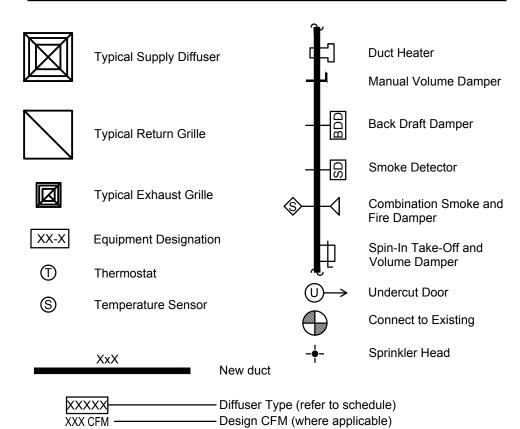

#### **Controls and Operation**

#### The Mechanical Contractor shall provide all control wiring in conduit necessary for the

setup instructions below for additional requirements.

complete and proper operating temperature control system including all modes of operation and interlock.

#### Thermostat(s) shall be Honeywell Programmable Series T7351F and remote sensor(s) T7770 furnished and installed per lease.

One thermostat and sensor is provided for each air handling unit. Mount thermostat(s) and sensor(s) in location & heights as indicated on drawings. Mechanical Contractor to provide thermostat identification labels with 1/8" (3mm) high white letters on kelly green or black phenolic background, i.e. "AC-1:Workroom" and "AC2:Customer Area". Refer to thermostat

#### Thermostat Setup Instructions

Provide the following setup and programming on the Honeywell T7351F thermostat: 1. Follow instructions in the Manual which comes with the thermostat. Additional information is available from Honeywell commercial field technical support at (612) 951-1019 or (763) 954-6464. 2. Configure as follows: a. Degrees "F" display b. 12 Hour Clock c. Continuous Fan Operation in Occupied Mode d. Disable Keyboard Programming 3. Set clock and day. 4. Set to display current temperature 5. Set Occupied Start Time at 30min before opening. Set Unoccupied start time at 30min after closing. Verify hours with Store Manager or Construction manager 6. Set Points shall be as follows: a. Occupied (5° F Deadband)(3° C Deadband) i. Heating: 70° F (21° C)

ii. Cooling: 75° F (24° C) b. Unoccupied i. Heating: 60° F (15° C)

ii. Cooling: 78° F (25° C) 7. Set three (3) hour occupied override function to provide the following set point overrides: a. Heating: +2° F (1° C)

#### b. Cooling: -2° F (1° C)

Restroom exhaust fan(s) to be operated in conjunction with store hours unless otherwise noted/approved. Fan to be controlled by Lighting Control Panel. If a Lighting Control Panel is not available, then utilize auxillary contacts (additional relays, etc. are needed) to control exhaust fan. (Coordinate with Electrical)

#### **HVAC** Equipment and Materials

**Exhaust Fans** 

Air handling units shall be as specified in the mechanical schedule and shall be furnished and installed per the lease agreement. The Mechanical Contractor is responsible for coordinating delivery, providing complete installation including curbs, piping, vibration isolation, and necessary accessories, and providing warranty.

Provide three (3) sets of 2" (51mm) MERV6 pleated disposable filters (or higher rating if required by LEED). Use one set until completion of construction. Install one set at completion of construction (prior to TAB) and deliver one set of filters to Starbucks labeled to denote their respective air handling unit.

#### Abbreviations

#### AFF Above Finished Floor Authorities Having Jurisdiction **APPROX** Approximate BLDG Building Ceiling CLG

CONST Ceiling Diffuser CD CO2 Carbon Dioxide CXA Commissioning Agent Degrees

DEG DTL Starbucks Design Manager DWG(S) Drawing(s)

EΑ Each **Electrical Contractor ELEC** Electrical FΜ Emergency (E) or (EX) Existing

EXT Exterior EG Exhaust Grille F&I Furnish & Install FLR Floor

Foot/Feet Gas Piping General Contractor

Heating, Ventilation, Air Conditioning HVAC I.D. Inside Dimension

Landlord LV Low Voltage MAX Maximum

MECH Mechanical MC MEP Mechanical Contractor Mechanical, Electrical and Plumbing MFG Manufacture MIN Minimum

NTS Not To Scale O.D. **Outside Dimension** OSA Outside Air PM Project Manager

REF Reference REQ('D) Require(d) Revision Return Grille Rooftop

SHT SPECS Specification(s) Square Feet SST Stainless Steel

Temporary TYP

WSHP

SHOP FABRICATED SHT ———

EQUALIZING GRID PERPEND—

MTL CLG DIFUSSER CAP NET INSIDE DIM. SAME

AS DIFFUSER NECK

TO STUB DUCT, FULL

SIZE OF DIFFUSER CAP

HEIGHT FROM DIFFUSER

NECK TO STUB CNTRLN.

FABRICATE FROM 22GA PERF SHT MTL (3/16"

HOLES ON  $\frac{1}{4}$ " CNTRS).

1. PROVIDE SUPPORT FOR

2. EQUALIZING GRID REQ'D

ON SUPPLY AIR DIFFUSERS

DIFFUSER & CAP PER

NOTES:

Water Heater

ROUND INSUL STUB DUCT

SAME SIZE AS FLEX DUCT

— OPPOSED BLADE DAMPER

TITUS AG-75 OR EQUAL WHERE NOTED ON MECHANICAL PLAN

FLEX DUCT. PULL INSIDE

- CLG DIFFUSER. FASTEN TO CAP

W/ SHT MTL SCREWS, MIN ONE

- TYP SUSP LAY-IN CEILING

PER SIDE. SEAL JOINT AIR TIGHT

FLEX DUCT CLAMP

LINER TAUT

Water Source Heat Pump

#### **Contractor Responsibilities for Building Commissioning** Contractor shall provide support and work as specified, needed and required to conduct and facilitate Starbucks staff building commissioning efforts. This work will be comprised of three distinct efforts: 1) support Starbucks Commissioning Agent (CXA) during installation verification and correct disclosed deficiencies; 2) perform testing, adjusting, balancing and system startup and support functional performance testing by Starbucks Construction CXA; 3) correct deficiencies disclosed by functional performance testing and submit reports. Contractor shall perform and provide the following: A. Systems subject to commissioning may include, but are not limited to, domestic hot water generation, HVAC systems, rooftop units, exhaust fans, HVAC controls.

lighting controls, air curtains, built-in refrigeration equipment, and renewable energy B. Contractor shall include commissioning activities in project schedule and show

intervals for performance of work for which contractor is responsible and intervals for

**LEED System Commissioning** 

work performed by Starbucks CXA. Contractor shall show resources for performing all work related to commissioning activities on a line item in the schedule of values. C. Contractor shall install equipment in accordance with the manufacturer's requirements and all contract documents. Ensure that all equipment is installed totally complete, and accessible to Starbucks CXA for installation verification and

functional performance testing prior to the scheduled start of installation verification.

D. Installation verification shall be performed by Starbucks' CXA. Contractor shall support Starbucks CXA installation verification efforts as necessary. Provide all access and equipment necessary for Starbucks staff to verify that the equipment is installed correctly.

E. Contractor shall be readily available during installation verification to correct any deficiencies or defects disclosed by the installation verification process. Corrections shall be made in a timely manner without disruption of the construction schedule.

F. All HVAC, exhaust fan, and air curtain equipment shall be tested, adjusted and balanced by the contractor's testing, adjusting and balance agent (see testing, adjusting and balancing) after the system is verified to be complete and correct by Starbucks CXA, in accordance with the requirements of these documents. All HVAC control systems shall be tested to ensure that control devices, components, equipment and systems are calibrated, adjusted and operate in accordance with these plans and specifications. Sequences of operation shall be tested to ensure that they operate in accordance with the contract requirements. Deliverables: preliminary, written testing and air balance report conforming to the requirements specified herein, documenting the information specified, etc. to the Starbucks CXA immediately upon completion of the work.

G. Contractor shall inform Starbucks CXA when equipment is ready for functional performance testing. All equipment shall be ready for functional performance testing prior to starting testing. Contractor shall operate equipment for Starbucks CXA and verify by demonstration the correct operation of equipment, response of sensors, and proper execution of HVAC control and lighting sequences; including but not limited to, air movement, temperature, sound, and control response. Provide any security access, hardware, software, or other support as needed for the Starbucks CXA to efficiently witness and document all equipment testing. Starbucks CXA will record the equipment operation and response to testing sequences and prepare a list of any deficiencies disclosed by the functional performance tests for correction by the contractor. Equipment includes, but is not limited to, air handling units, rooftop and split type, condensing units, exhaust fans, lighting controls, etc. Deliverables: provide completed copies of all start up reports, filled out on the manufacturers' forms, to the Starbucks CXA.

H. Contractor is responsible for correcting any issues or deficiencies disclosed during the functional performance testing process. Corrections should be made in a timely manner without disruption to the system and construction schedule.

J. Contractor shall be readily available for any re-testing of equipment deemed necessary by Starbucks CXA during installation verification and functional performance testing. Contractor is responsible for correcting any issues or deficiencies found in the system during any and all re-testing. Corrections should be Deliverables: final balance report, deficiencies list noting corrective actions performed by contractor in response to installation verification and functional performance test results.

K. Construction and post construction testing: additional testing may be required by LEED and other processes that may occur out of sequence with commissioning service. Contractor shall conduct, document, support and schedule this testing as directed by Starbucks CXA.



#### STARBUCKS COFFEE **COMPANY** 2401 UTAH AVENUE SOUTH SEATTLE, WASHINGTON 98134

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ARCHITECT OF RECORD

325 N. LaSalle St. Suite 700 Chicago, IL 60654 t 312.424.2400 | f 312.424.2424 | www.norr.com



## STREE RE OMMERCIAL

STORE #: 19384 PROJECT # 58862-001 CONCEPT MCS PALETTE: HERITAGE **ISSUE DATE** JAN. 11, 2013 **DESIGN MANAGER:** E. ZAKAMAREK LEED®AP: PRODUCTION DESIGNER: NORR ILLINOIS CHECKED BY: MG / DMC

SHEET TITLE:

SCALE:

Mechanical Specifications

SHEET NUMBER:

M-001

1/4" = 1'-0"

EXPANSION -BOLT INSERT & BOLT HANGER -STRAP SELF TAPPING SCREWS HANGER SIZE MAX SPACING FOR DUCTS OVER 48" —— DUCT SIZE WIDE, TURN UNDER UP THRU 2 SF 1" x 1/16" 8'-0" BOTTOM OF DUCT & FASTEN THRU 4 SF 1" x 1/8" 8'-0" 1" x ⅓" 4 THRU 10 SF 6'-0" OVER 10 SF 1" x 1/8" 4'-0"

**DUCT HANGING DETAIL** 

LAY-IN CLG DIFFUSER


#### WATER SOURCE HEAT PUMP SCHEDULE


PLAN	MANUFACTURER	SUPPLY	OUTSIDE	EXTERNAL		COOLING	CAPACITY	FLUID	(WATER)		HEATING		FLUID (WATER) DRY BULB WET BULB AMBIENT		1 - 1 1				FILTER HEATING	COOLING	T-STAT					OPERATING	
MARK	MODEL NUMBER	AIR (CFM)	AIR (CFM) MIN.	S.P. IN (WC)	MOTOR	MBH/TON	EER/SEER	ENTERING TEMP. (°F) 1	LEAVING EMP. (°F)	FLOW RATE(GMP)	CAPACITY (MBH)	LENTERING	LEAVING TEMP. (°F)	ENTER DEGR	NG AIR EES F	AIR (DEG F)	TYPE	STAGE(S)	STAGE(S)	TYPE	VOLTS	PH	HZ	MCA/MOCP	WEIGHT LBS.	NOTES	
HP1-3(EX)	TRANE GEHB06042G0220	2000	400	0.5"	1 HP	64.2/.5	12.8	85	95	14.5	64.6	55	44	80.6	70	95 <b>°</b>	THROW AWAY	1	1	TWO PIECE PROGRAM.	460	3	60	12.1/15	_	1,2	
HP1-4(EX)	CLIMATMASTER HP060FSCMLSGNSD	2000	320	0.3"	1 HP	56.7	12.8	85	95	11.4	66.5	55	45	80.6	70	95 <b>°</b>	THROW AWAY	1	1	TWO PIECE PROGRAM.	460	3	60	12.3/15	_	1,2	


NOTES 1. EXISTING TO REMAIN.
2. PROVIDE AND INSTALL WATER ECONOMIZER.

PROVIDE AND INSTALL MANUAL VOLUME DAMPERS AT ALL BRANCH DUCT CONNECTIONS

COORDINATE ROUTING OF DUCTWORK & AIR DEVICE LOCATIONS WITH LIGHTING PRIOR TO COMMENCEMENT OF WORK

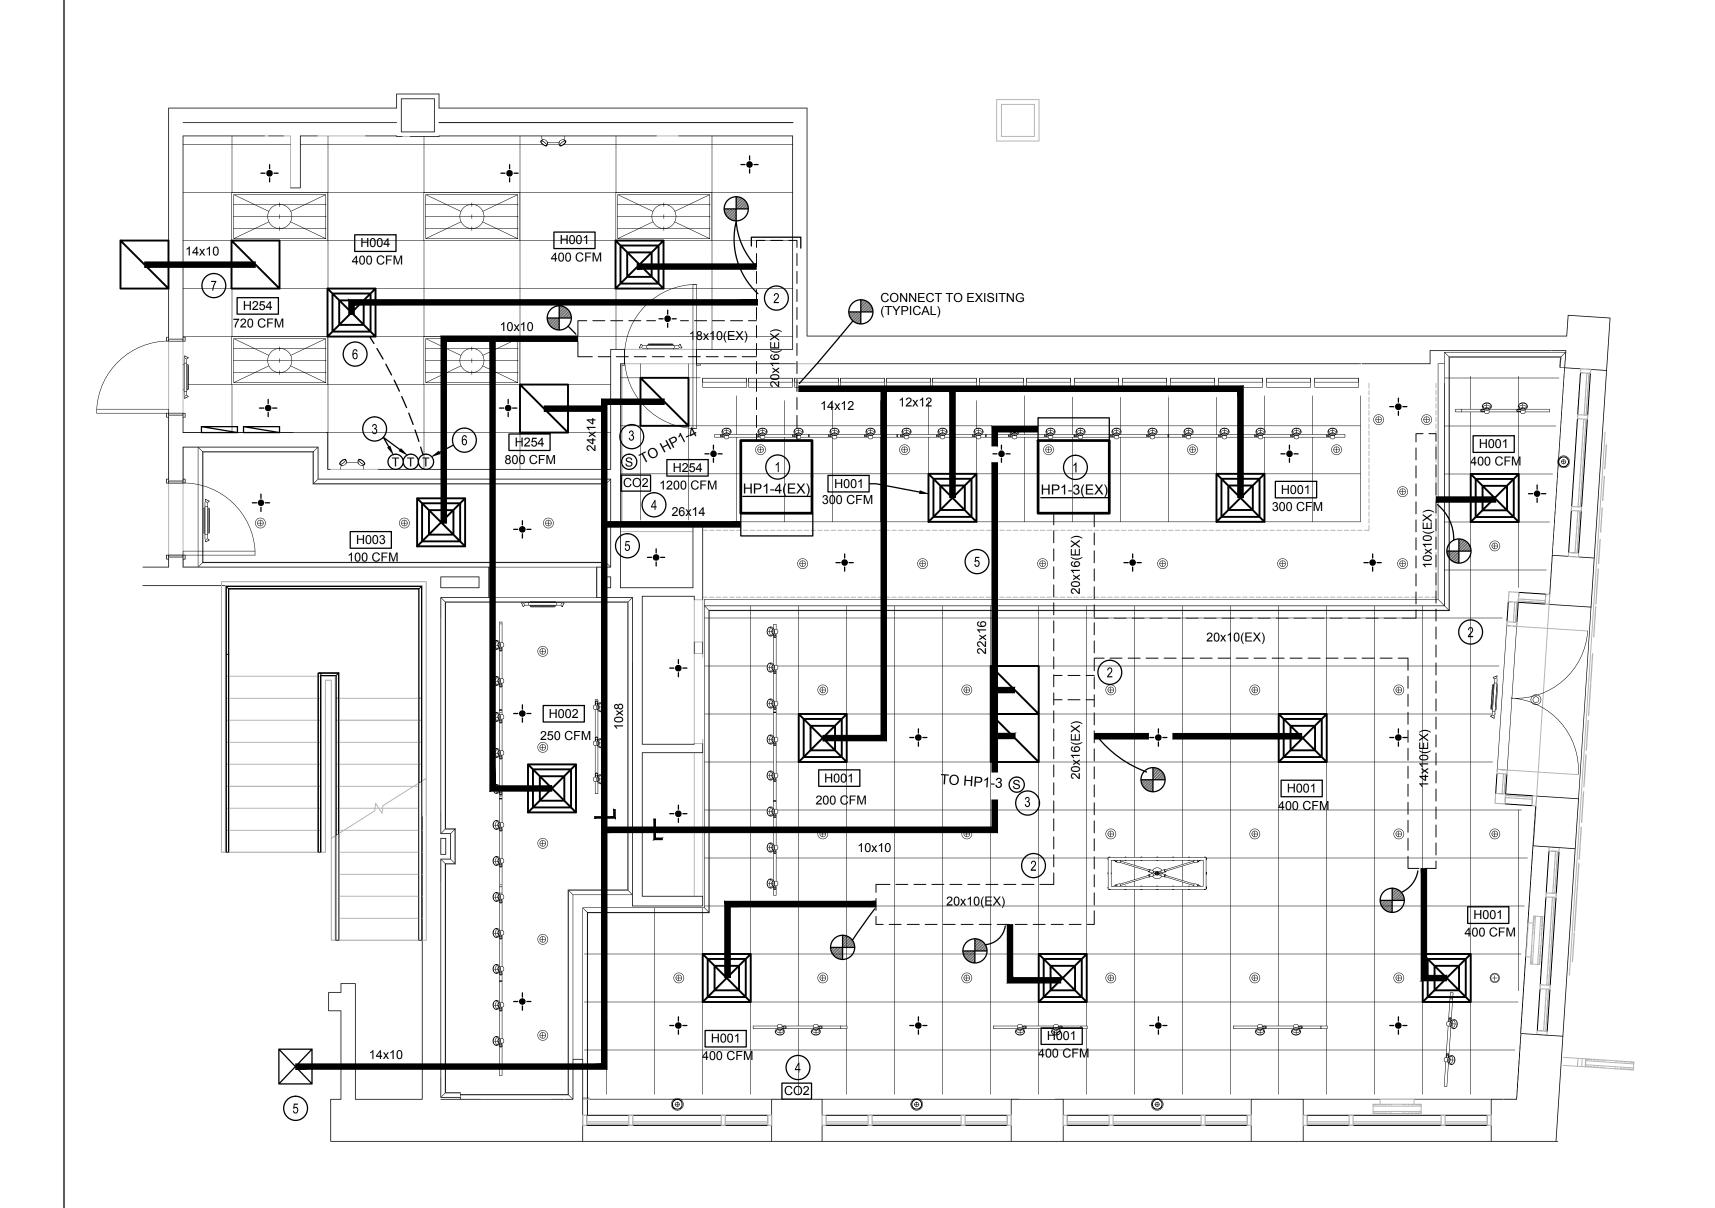

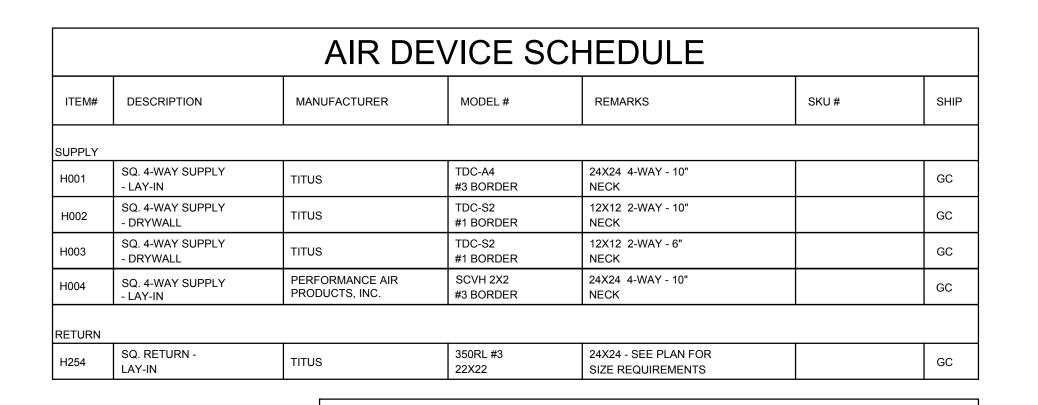

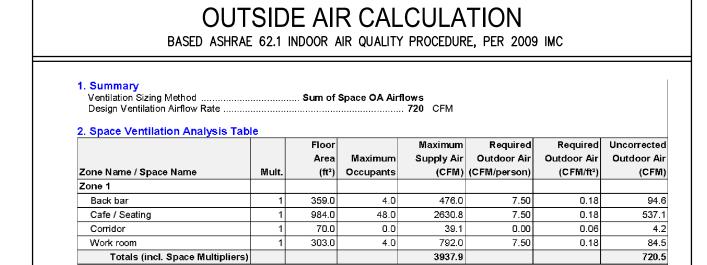

PROVIDED TOTAL

#### NOTES:

EXISTING WATER SOURCE HEAT PUMP TO REMAIN AND BE REUSED. VERIFY PROPER WORKING CONDITION, PROVIDE SERVICE AS REQUIRED TO RESTORE TO LIKE NEW CONDITION. VERIFY PROPER SMOKE DETECTOR OPERATION, REPLACE WITH NEW IF NECESSARY. PROVIDE AND INSTALL NEW WATER ECONOMIZER WITH ALL ASSOCIATED MANUFACTURER'S RECOMMENDED VALVES AND CONTROLS. EXTEND SUPPLY AND RETURN LINES TO ECONOMIZER FROM EXISTING (SET-UP FOR ECONOMIZER OPTION) SUPPLY AND RETURN SHUT-OFF VALVES.

720 CFM

- PARTIALLY REUSE EXISTING MAIN DUCT WORK (SHOWN DASHED).
  VERIFY EXACT LOCATION AND CONNECTION POINT IN FIELD.
  MODIFY IF REQUIRED.
- PROVIDE & INSTALL 2 PIECE THERMOSTAT. INSTALL AT 54" A.F.F. PER ADA AT MANAGER'S DESK. COORDINATE EXACT LOCATION WITH OWNER. INSTALL WALL MOUNTED SENSOR FOR CONTROL OF HP-1.4 AND CEILING MOUNTED SENSOR FOR HP1-3. COORDINATE LOCATIONS WITH OTHER ELEMENTS OF WALL/ CEILING. VERIFY EXACT LOCATIONS IN FIELD.
- 4 STAND-ALONE INDIRECT CO2 MONITOR / ALARM. MONITOR SHALL BE INSTALLED ON WALL IN BREATHING ZONE (BETWEEN 20" AND 60" A.F.F.). THE MONITOR SHALL PROVIDE A VISUAL ALARM (RED LIGHT) IN THE EVENT THAT THE CO2 LEVELS VARY BY 15% OR MORE FROM THE DESIGN VALUE OR IF THE CONCENTRATION READINGS ARE OVER 1000 PPM. THIS STRATEGY WAS IMPLEMENTED TO COMPLY WITH LEED EQC1: OUTDOOR AIR DELIVERY MONITORING CREDIT REQUIREMENTS.
- PROVIDE AND INSTALL NEW O.A. INLET GRILLE ON OVERHEAD CEILING. COORDINATE COLOR, FINISH AND SHAPE W/ L.L. (MINIMUM 160 SQ. INCH. FREE OPENING AREA). EXTEND O.A. DUCT THRU EXISTING CHASE AS SHOWN TO TENANT'S PREMISES AND CONNECT TO MIXING BOX/RETURN AIR DUCT OF EACH UNIT WITH VOLUME DAMPER. BALANCE AS INDICATED. VERIFY RUN-OUTS IN FIELD. PROVIDE DUCT OFFSET IF REQUIRED TO AVOID INTERFERENCE WITH OTHER EXISTING TRADES IN CHASE. PROVIDE FIRE DAMPER IF REQUIRED, OR INSTALL O.A. DUCT IN FIRE RATED DRYWALL ENCLOSURE THRU FIRE RATED PARTITION PENETRATION.
- 6 PROVIDE AND INSTALL SUPPLY GRILLE WITH A THERMALLY POWERED DIFFUSER TO PROVIDE ONE TEMPERATURE CONTROL ZONE 50% OF THE OFFICE ADMINISTRATION SPACE. INTERLOCK GRILLE WITH NEW THERMOSTAT PROVIDED AND INSTALLED AT 60" A.F.F. NEAR MANAGER'S DESK. VERIFY LOCATION OF THERMOSTAT WITH OWNER.
- 7 PROVIDE AND INSTALL TRANSFER AIR DUCT EXTENDED TO FLOOR COMMON AREA TO AVOID OVER PRESSURIZING THE TENANT SPACE. PROVIDE INFORMATION TO BUILDING ENGINEER TO ACCUMULATE FLOOR AIR BALANCE.
- 8 PROVIDE & INSTALL NEW SPRINKLER HEADS AS REQUIRED TO ACCOMMODATE CEILING AND PARTITION LAYOUT. COORDINATE EXACT LOCATION WITH CEILING FIXTURES AND LIGHTS.



STARBUCKS COFFEE
COMPANY
2401 UTAH AVENUE SOUTH
SEATTLE, WASHINGTON 98134
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ARCHITECT OF RECORD

NOR
ARCHITECTS

PLANNERS

325 N. LaSalle St. |Suite 700 |Chicago, IL 60654



PROJECT NAME:

COMMERCIAL STREET
PROJECT ADDRESS:
145 COMMERCIAL STREET
PORTLAND, ME 04101
CUMBERLAND COUNTY

STORE #: 19384 PROJECT #: 58862-001 CONCEPT: MCS PALETTE: HERITAGE ISSUE DATE: JAN. 11, 2013 DESIGN MANAGER: E. ZAKAMAREK LEED®AP: PRODUCTION DESIGNER: NORR ILLINOIS CHECKED BY: MG / DMC

SHEET TITLE:

Mechanical Design

1/4" = 1'-0"

SCALE:
SHEET NUMBER:

M-111

\_\_\_\_

)

MECHANICAL PLAN

#### **General Specification Notes**

The intent of the Specifications and the Drawings is to provide a complete and fully operational plumbing system. The Contractor shall furnish all labor, material, and equipment related to the installation of the plumbing work.

The Contractor shall thoroughly examine all areas where fixtures, equipment, and piping will be installed and will report any condition that, in his opinion, prevents the proper installation of the plumbing work.

Equipment and materials shall conform with the appropriate provisions of CSA, ULC, ASME, ASTM, UL, NEMA, ANSI, ASHRAE, NFPA, as applicable to each individual unit or assembly.

All work shall be performed in strict accordance with all applicable provincial and local codes and ordinances. In case of conflict between the drawings and specifications and the codes and ordinances, the highest standard shall apply. The Contractor shall satisfy code requirements as a minimum standard without any extra cost to Starbucks.

Permits and Fees The Contractor shall procure and pay for all permits, fees, and inspections necessary to complete the plumbing work.

The Contractor shall unconditionally warrant all work to be free of defects in material and workmanship for a period of one year from the date of final acceptance by Starbucks and will repair or replace any defective work promptly and without charge and restore any other existing work damaged in the course of repairing defective materials and workmanship.

All work, materials and equipment shall meet LEED requirements & code. In case of conflict, the higher Standard shall apply.

#### General Plumbing Notes

1. Plumbing Contractor shall coordinate with the General Contractor to patch and repair all existing walls, floors, ceilings or other surfaces identified to remain that may become damaged during the course of work.

2. Exposed/surface mounted piping is only allowed in the bar area under countertops, where it does not obstruct cabinets/devices and where approved by Starbucks Construction Manager. If routed through cabinets, it shall be routed to maximize storage space and be protected from damage.

3. Drawings are diagrammatic and indicate general intent or arrangement of system(s). Furnish and Install all components needed whether indicated or not to provide a complete and operating system.

4. Contractor to verify all dimensions, including clearances required by other trades, and notify Starbucks Construction Manager of any discrepancies prior to proceeding with the work. All dimensions are to the face of the finished surface unless noted otherwise. All dimensions to be taken from from actual building

5. The plumbing contractor shall coordinate plumbing work with other trades. The architectural drawings shall take precedence over all other drawings. See architectural drawings for fixtures in casework and plumbing details.

6. All piping and/or plumbing devices shall be supported from structure (not from

#### Plumbing Symbol Legend

<u> </u>	<u> </u>					
	S or W	Sanitary or Waste Piping				
	V	Vent Piping				
—— GW ——	GW	Grease Waste				
— CD — CD —	CD	Condensate Drain				
	CW	Cold Water Piping				
	HW	Hot Water Piping				
	CWF	Cold Water Filtered				
—— TW——	TW	Tempered Water				
—— RD ——	RD	Refrigerant Discharge Piping				
—— RS ——	RS	Refrigerant Suction Piping				
<u></u> —Ю	BV	Ball Valve				
<b>──</b>	GV	Gate Valve				
$\longrightarrow$	CH. V	Check Valve				
村	RV	Relief Valve				
—— <b>&gt;</b> ,	НВ	Hose Bibb				
$\dashv$ I	WCO	Wall Cleanout				
$\oplus$	FCO	Floor Cleanout				
	FD	Floor Drain (Square)				
	FD	Floor Drain (Round)				
0	HD	Hub Drain				
	FS	Floor Sink (Square)				
	FS	Floor Sink (Round)				
M	WM	Water Meter				
	POC	Connect to Existing				

Existing piping shown in a lighter shade.

#### Piping

#### Soil, Waste, and Vent Piping

Soil, Waste, and Vent piping 10" (254mm) and smaller shall be service weight, hubless, cast iron pipe, and fittings with neoprene gasket and stainless steel shield and clamp. Provide hub and spigot, service weight cast iron soil pipe and fittings below grade where required by local codes. Schedule 40 ABS or PVC pipe and fittings with solvent weld may be substituted for soil, waste, and vent piping above and below grade if allowed by local authority. Adhesives shall not exceed a VOC content of 510 g/L for PVC and 325 g/L for ABS. All horizontal runs shall drain at a grade of 1/4" per foot (21mm per meter) where possible but in no case less than 1/8" per foot (10mm per meter) where allowed & sized per

Coordinate with local authorities for drainage requirements for equipment designated with indirect waste to floor sinks. Provide piped drain (P-trap and vent) to sanitary if required by

Domestic water piping 2 1/2" (64mm) and smaller shall be copper tube with wrought copper sweat fittings joined with non-lead, non-antimony solder. Provide type "L" copper tube above grade and type "K" below grade.

#### **Condensate Drainage Piping**

The Plumbing Contractor shall provide condensate drains for air handling units and Starbucks equipment (refer to schedule). Condensate drainage piping shall be type "M" copper tubing with wrought copper sweat fittings joined with 50/50 solder.

Hangers and Supports

Gas piping shall be Schedule 40, seamless, black steel pipe. Provide piping support blocking on roof, compatible with roofing system.

The Plumbing Contractor shall furnish all pipe supports required for equipment and material. All horizontal runs of piping shall be supported by pipe hangers installed as required by local codes. Additional supports shall be provided where required to prevent sagging. Hangers and pipe attachments to be factory fabricated with galvanized coatings; non-metallic coated for hangers in direct contact with copper tubing.

#### Connections

Install unions adjacent to each valve and at final connection to each piece of equipment. Install dielectric couplings to connect piping materials of dissimilar metals. Screw joint steel piping up to and including 1-1/2" (38mm) for gas piping. Use non-lead, non-antimony solder for soldering domestic water copper pipe.

Provide floor and wall cleanouts as indicated on the drawings or where required by code in all soil, waste, and drain lines. In areas with ceramic tile or carpeted flooring, provide cleanouts with square, adjustable, nickel bronze top. In areas with resilient (vinyl) flooring, provide cleanouts with square, adjustable, nickel bronze top with tile recess. Cleanouts shall be same size as pipe except that cleanouts larger than 4" will not be required. Where cleanouts occur in walls of finished areas, they shall be concealed behind chrome plated access covers.

Install piping free of sags and bends. Provide bracket standoffs from mounting surfaces sufficient to allow 1" (25mm) of cleaning space all around piping, including any added piping insulation. Install fittings for changes in direction and branch connections. Install sleeves for pipes passing through concrete and masonry walls, gypsum board partitions, concrete floor and roof slabs. Seal pipe penetrations through rated construction with fire stopping sealant material per Code requirements. Underground water and sewer lines shall be laid in separate trenches with a minimum horizontal spacing as required by code, excavated to the proper depth and graded to produce the required fall.

All pipes shall be tested by an approved method before they are backfilled or concealed. After testing is complete, the Plumbing Contractor shall disinfect the potable water system as required by local authority. Test water purity according to local requirements and submit certified test results to engineer for review and approval

#### Insulation

Provide thermal insulation on all hot and cold water, and horizontal waste piping in ceiling spaces, and on all cold water piping in casework and bar areas. Use self sealing closed cell foam or jacketed fiberglass insulation with manufacturer approved adhesives, sealers, and coatings. All materials used shall not exceed 25 for flame spread index, 50 for fuel contributed or 50 for smoke developed index. Unless otherwise required by the local authority or energy codes, the minimum insulation levels shall be as follows. Pipe Size (diameter) Insulation Thickness Less than or equal to 1 1/2" (38mm)

1 1/2" (38mm) 2" (51mm) or greater (Insulation Value = k value not exceeding 0.027 BTU per inch/h\*ft2\*f)

Install specified no scald safety covers with insulated foam liner and tamper proof strap as furnished by Starbucks at all exposed piping.

#### Ice Bin Drain

Insulate ice bin drain lines with 1/2" (13mm) thick, self sealing, sectional, closed cell foam.

Insulate refrigerant suction piping and cooling coil condensate piping with 3/4" (19mm) thick, self sealing, closed cell foam. Insulate HVAC hot and chilled water piping systems and low pressure steam and condensate piping with 1 1/2" (38mm) thick, heavy duty, self sealing, jacketed fiberglass. Install thicker insulation where required by Code.

#### Rain Conductors

Insulate rain water conductors which pass through occupied areas with 1/2" (13mm) thick

#### **Valves**

Plumbing Contractor to provide valves where indicated on plans and as necessary for proper system operation and component isolation. Install valves for each fixture and item of equipment. Provide braided stainless steel hose (unless otherwise noted) between valve and equipment in accordance with manufacturer's specifications. Locate shut-off valves adjacent to equipment for easy access such that valves can be reached without moving equipment. Shut off valves to be ball type. Valves shall be listed/approved for use per Authorities Having Jurisdiction (AHJ) and code requirements.

Provide valves for working pressure in water piping of 125 PSI or greater. Unless noted otherwise valves shall meet the following minimum requirements:

Valve Type Check Valve (up to 2" (51mm)) Ball valve (up to 3" (76mm))

Gate Valve (up to 3" (76mm))

renewable seat/disc Brass, full port, quarter turn Bronze, non-rising stem, solid wedge Temperature and Pressure Relief Valve Rated for potable water heating storage vessel with safety certification

Pre-charged, sealed chamber

union ball valves and safety

Double check valve assembly with

Bronze, pressure based automatic

<u>Description</u> Bronze, horiz. swing, Y-pattern,

Water Hammer Arrestor Backflow Preventer (whole-house)

certification per AHJ Double check valve assembly with Backflow Preventer (single device) safety certification per AHJ Vacuum Relief Valve Brass body and stainless steel Pressure Reducing Valve Bronze, 25 to 75 psi reduce pressure range and upstream/downstream pressure gauges

#### **Supply Water Service**

If water pressure supplied to store is greater than and 65 PSI, then provide a pressure regulator in main supply to reduce water pressure. Provide backflow prevention on water service if required by local codes.

#### Thermostatic Mixing Valve

Trap Seal Primer

Provide a single Thermostatic Mixing Valve (TMV) located at hot water tank and set for 110° (or as required by AHJ) to serve hand sinks. Mixing valve to be installed per Manufacturer's requirements with check valves at supply inlets.

#### Plumbing Fixtures

#### **Water Heater**

Size water heater per Starbucks standard and per Authorities Having Jurisdiction (AHJ), whichever is more stringent. Provide a glass-lined, energy efficient, gas fired (or electric equivalent) water heater. Provide installation complete with fittings as shown in the drawings. Set hot water temperature at 120°F or as required by AHJ.

#### Water Filtration

Starbucks water filtration vendor will provide filtration system. Contractor shall confirm with Starbucks Construction Manager whether vendor or Plumbing Contractor is to install filtration system. Provide and coordinate installation complete with all piping, fittings, and equipment as indicated on the drawings.

The Plumbing Contractor shall make all final connections to equipment including required material such as piping, valves, filters, traps, checks valves, vacuum breakers, and flexible and rigid tubing.

Refer to schedules on drawings (Plumbing & Arch. Schedules) for a description of listed items and furnish any and all plumbing fixtures listed as "GC". Any discrepancies about who is to provide plumbing fixtures in the schedule shall be brought to Starbucks attention for clarification. Install all fixtures listed regardless of who supplies.

#### **Abbreviations** Third Party Logistics AFF Above Finished Floor **Authorities Having Jurisdiction** AHJ APPROX Approximate BLDG Buildina CLG Ceiling CONST Construction CW Domestic Cold Water CXA DEG Commissioning Agent Degrees DTL Detail Down DWG(S) Drawing(s) EΑ EC ELEC **Electrical Contractor** Electrical EM Emergency (E) or (EX) Existing Exterior FD Floor Drain Floor Sink F&I FLR Furnish & Install Floor Foot/Feet FCO **GFCI** GW HVAC HW HWS HWR MAX MECH MC

Floor Cleanout General Contractor Ground Fault Circuit Interrupter Grease Waste Heating, Ventilation, and Air Conditioning Hot Water Handsink Hot Water Supply Hot Water Return Landlord Low Voltage Maximum Mechanical Mechanical Contractor Main Distribution Panel Mechanical, Electrical,

MEP and Plumbing MFG Manufacturer Minimum Mop Sink Nightlight NTS Not to Scale Plumbing Contractor Prep Sink POC Point of Connection **Project Manager** REF Reference REQ('D) Required(d) REV Revision SHT SPECS Specification(s) Square Feet

SST Stainless Steel TEL Telephone **TEMP** Temporary TYP Temperature Mixing Valve Tempered Hot Water **Unless Noted Otherwise** 

Sanitary Waste Water Heater Weather Proof Wall Cleanout

#### **LEED System Commissioning**

#### **Contractor Responsibilities for Building Commissioning**

Contractor shall provide support and work as specified, needed and required to conduct and facilitate Starbucks staff building commissioning efforts. This work will be comprised of three distinct efforts: 1) support Starbucks Commissioning Agent (CXA) during installation verification and correct disclosed deficiencies; 2) perform testing, adjusting, balancing and system startup and support functional performance testing by Starbucks CXA; 3) correct deficiencies disclosed by functional performance testing and submit reports. Contractor shall perform and provide the following:

A. Systems subject to commissioning may include, but are not limited to, domestic hot water generation, HVAC systems, rooftop units, exhaust fans, HVAC controls, lighting controls, air curtains, built-in refrigeration equipment, and renewable energy

B. Contractor shall include commissioning activities in project schedule and show intervals for performance of work for which contractor is responsible and intervals for work performed by Starbucks CXA. Contractor shall show resources for performing all work related to commissioning activities on a line item in the schedule of values.

requirements and all contract documents. Ensure that all equipment is installed totally complete, and accessible to Starbucks CXA for installation verification and functional performance testing prior to the scheduled start of installation verification. D. Installation verification shall be performed by Starbucks' CXA. Contractor shall

C. Contractor shall install equipment in accordance with the manufacturer's

support Starbucks CXA installation verification efforts as necessary. Provide all access and equipment necessary for Starbucks staff to verify that the equipment is installed correctly. E. Contractor shall be readily available during installation verification to correct any

deficiencies or defects disclosed by the installation verification process. Corrections

shall be made in a timely manner without disruption of the construction schedule. F. All HVAC, exhaust fan, and air curtain equipment shall be tested, adjusted and balanced by the contractor's testing, adjusting and balance agent (see testing, adjusting and balancing) after the system is verified to be complete and correct by Starbucks CXA, in accordance with the requirements of these documents. All HVAC control systems shall be tested to ensure that control devices, components, equipment and systems are calibrated, adjusted and operate in accordance with these plans and specifications. Sequences of operation shall be tested to ensure that they operate in accordance with the contract requirements. Deliverables: preliminary, written testing and air balance report conforming to the requirements specified herein, documenting the information specified, etc. to the Starbucks CXA immediately upon completion of the work.

G. Contractor shall inform Starbucks CXA when equipment is ready for functional performance testing. All equipment shall be ready for functional performance testing prior to starting testing. Contractor shall operate equipment for Starbucks CXA and verify by demonstration the correct operation of equipment, response of sensors, and proper execution of HVAC control and lighting sequences; including but not limited to, air movement, temperature, sound, and control response. Provide any security access, hardware, software, or other support as needed for the Starbucks CXA to efficiently witness and document all equipment testing. Starbucks CXA will record the equipment operation and response to testing sequences and prepare a list of any deficiencies disclosed by the functional performance tests for correction by the contractor. Equipment includes, but is not limited to, air handling units, rooftop and split type, condensing units, exhaust fans, lighting controls, etc. Deliverables: provide completed copies of all start up reports, filled out on the manufacturers' forms, to the Starbucks CXA.

H. Contractor is responsible for correcting any issues or deficiencies disclosed during the functional performance testing process. Corrections should be made in a timely manner without disruption to the system and construction schedule.

J. Contractor shall be readily available for any re-testing of equipment deemed necessary by Starbucks CXA during installation verification and functional performance testing. Contractor is responsible for correcting any issues or deficiencies found in the system during any and all re-testing. Corrections should be Deliverables: final balance report, deficiencies list noting corrective actions performed by contractor in response to installation verification and functional performance test results.

K. Construction and post construction testing: additional testing may be required by LEED and other processes that may occur out of sequence with commissioning service. Contractor shall conduct, document, support and schedule this testing as directed by Starbucks CXA.

#### Note: Water Heater exceeds the minimum required Energy Factor (EF of .63) stated in LEED Credit EAp2.

	SPECIALTY EQUIPMENT SCHEDULE - "E"										
DESIGN ID	COUNT	DESCRIPTION	RESP.	COMMENTS							
<b>EQUIPMENT</b>	EQUIPMENT										
10746	1	BREWER DUAL SOFT HEAT	WH								
11070	1	DISHWASHER SANITIZER	WH	ENERGY STAR COMPLIANT							
11851	1	BREWER CLOVER	VD								
12694	2	ESPRESSO MACHINE MASTRENA	WH								
ICE											
10344	1	ICE - BIN DROP IN 95LB	VD	ELKAY							
10475	1	ICE - MACHINE 1109LB AIR COOLED SIDE VENT	VD	MILE HIGH							
10527	2	ICE - BIN DROP IN 45LB	WH								
10880	1	ICE - BIN 1000LB	VD	MILE HIGH							

#### DESCRIPTION COMMENTS DESIGN ID | COUNT 1 GREASE TRAP SEE SHEET P-112 FOR SPECIFICATION DRAIN - FLOOR SINK WITH HALF GRATE SQUARE - 12IN 305MM Jay R. Smith Model #304-12 or equal 2 DRAIN - 6" FLOOR DRAIN Wade Model #1103STD6 or Equal. FAUCET 1 FAUCET - DOUBLE LABORATORY WITH BENT RISER SPOUT 10153 1 FAUCET - WATER TOWER - 12IN 305MM 10215 2 FAUCET - DOUBLE LABORATORY WITH SWING SPOUT 1 FAUCET - PRE RINSE SPRAYER WALL MOUNTED .2 GPM VAI VF 1 FAUCET - SINGLE HANDLE C' MODEL, 0.5 GPM AERATOR 1 FAUCET - PRE RINSE SWING SPOUT 1 FAUCET - HOT WATER DISPENSER GOOSENECK 1 FAUCET - MOP SINK WALL MOUNTED 10943 1 FAUCET - SINGLE LABORATORY WITH SWING SPOUT lwн 11003 1 FAUCET - DIPPERWELL WH FILTER 13076 1 FILTER - PREFILTRATION SYSTEM PENTAIR WATER SYSTEM - CONFIG 1 13080 1 FILTER - HEAD QUAD 13081 4 FILTER - CARBON FILTER CARTRIDGE PENTAIR WATER SYSTEM - CONFIG 1 PENTAIR WATER SYSTEM - CONFIG 1 1 FILTER - PRESSURE GAUGE PENTAIR WATER SYSTEM - CONFIG 1 WATER HEATER 50GAL 190L ELECTRIC AO SMITH Model #DEL-50 or Equal, 54 GPH Recovery @ 90 Degree Rise. Set Water Heater to 120 Deg. Max. Energy Factor = .98 12 KW 3 PH 277 / 1 SINK - RINSE DROP IN - 27X20IN 685X510MM SINK - WORK DROP IN SST - 12X20IN 305X510MM 1 SINK - HAND WALL MOUNTED SST NTEGRAL FAUCET WITH 0.5 GPM AERATOR 1 SINK - MOP - 24X24IN 610X610MM 1 SINK - UTENSIL RINSE WITH GRATE SST - LH - 14X20IN 355X510MM IFI KAY 13264 1 SINK - 3 COMP WORK SST - 93IN 2350MM ELKAY VD

PLUMBING FIXTURE SCHEDULE - "P"

	CASEWORK SCHEDULE - "C"										
<b>DESIGN ID</b>	DESIGN ID COUNT DESCRIPTION RESP. COMMENTS										
COUNTERT	OP										
11915	1	COUNTERTOP - HAND SINK STAINLESS - 15IN 380MM	VD								



STARBUCKS COFFEE COMPANY 2401 UTAH AVENUE SOUTH SEATTLE, WASHINGTON 98134 (206) 318-1575

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OBLIGATION NOR LIABILITY TO THE OTHER (EXCEPT STATED ABOVE) UNTIL A WRITTEN AGREEMENT IS FULLY EXECUTED BY BOTH PARTIES

ARCHITECT OF RECORD

325 N. LaSalle St. |Suite 700 |Chicago, IL 60654 t 312.424.2400 | f 312.424.2424 | www.norr.com



Engineering Consultants

**Revision Schedule** Rev Date By Description

Ш STRI STREE 101 UNTY PROJECT ADDRESS:
145 COMMERCIAL S
PORTLAND, ME 041
CUMBERLAND COU PROJECT NAME:

COMMERCIAL

STORE #: 19384 PROJECT# 58862-001 CONCEPT: MCS PALETTE: HERITAGE **ISSUE DATE** JAN. 11, 2013 **DESIGN MANAGER:** E. ZAKAMAREK LEED®AP: PRODUCTION DESIGNER: NORR ILLINOIS CHECKED BY: CLL / SMD

SCALE:

Plumbing Specifications

1/4" = 1'-0"

SHEET NUMBER:

P-001

## \_|---| 7'-7" <u> 10152 (14)</u> ALL WATER PIPING TO BE 1/2" UNLESS OTHERWISE NOTED.

#### Plumbing Design Notes

A. Furnish and install a complete and operating system. All items are not necessarily shown.

B. Plumbing Contractor responsible for site investigation prior to start of work to reveal full scope of work.

C. All Plumbing lines to be routed such that they are not visible to

D. Refer to manufacturer specifications for location of connections unless otherwise noted.

E. Coordinate with Electrical Contractor for power connection to all plumbing equipment.

F. Dimensions are to finish face unless otherwise noted.

G. Refer to detail sheets for plumbing fittings located in casework.H. Cold water supply lines inside casework and bar area to be

H. Cold water supply lines inside casework and bar area to be covered with 1/2" (10mm) thick self sealing, sectional closed-cell foam insulation. Refer to specifications for hot water supply line insulation requirements.

J. Contractor shall contact water filter supplier before the time that the filter system is to be started up.

K. Verify proper water system with water test results.

WATER DEMAND CALCULATION									
FIXTURE	QUANTITY	WSFU EA.	WSFU TOTAL						
MOP SINK	1	3	3						
3-COMP. SINK (FAUCETS)	2	2	4						
KITCHEN SINK	3	1.5	4.5						
HAND SINK	2	1	2						
DIPPER WELL	1	1	1						
ICE MACHINE	1	.5	.5						
GLASS FILLER	2	.5	1						
INSTAHOT TAP	2	1	2						
DISHWASHER	1	4	4						
COFFEE BREWER	1	.5	.5						
ESPRESSO MACHINE	2	.5	1						
HOSE BIBB	1	2.5	2.5						
TOTAL WSFU REQUIRED			26						

26 WSFU = 20 GPM = 1-1/2"Ø WATER SERVICE

#### Sheet Notes

1. 1" CW TO WATER HEATER & 1" HW FROM WATER HEATER. WATER HEATER AS SPECIFIED AND IN COMPLIANCE WITH APPLICABLE CODES AND ORDINANCES. DIMENSIONS OF THE HEATER SHALL ALLOW INSTALLATION ABOVE THE MOP SINK. REFER TO WATER HEATER DETAIL ON SHEET P-501.

2. 1/2" HW & CW TO FAUCET AT MOP SINK. CAULK AND SEAL BACK OF SINK TO WALL.

3. 3/4" CW TO WATER FILTER AND 3/4" CWF FROM WATER FILTER. PLUMBING CONTRACTOR TO FOLLOW MANUFACTURER'S INSTALLATION INSTRUCTIONS AND ACTIVATION PROCEDURES FOR FILTERS. VERIFY REQUIREMENTS PRIOR TO BID.

4. 1/2" HW & CW TO FAUCET AND SPRAY AT COMPARTMENT SINK. CAULK AND SEAL BACK OF SINK TO WALL.

5. 3/4" HW TO DISHWASHER. INSTALL SHUT-OFF WITH 3/4" MALE HOSE-END FITTING @ 18" A.F.F. UNDER COMPARTMENT SINK. SHUT-OFF TO INCLUDE PRESSURE REDUCING VALVE, PRESSURE GAUGE (SET @ 20 PSIG, \* OR - 5 PSIG), LINE STRAINER, AND SHOCK ARRESTOR IN WALL. CONNECT SANITIZER TO HW SUPPLY WITH 72" LONG BRAIDED STAINLESS STEEL HOSE.

6. 1/2" CWF TO ICE MACHINE. REDUCE TO 3/8" AT MACHINE.7. 1/2" TW & CW TO SINK.

8. 1/2" CWF TO COFFEE BREWER. INSTALL SHUT-OFF IN CABINET @ 24" AFF. REDUCE TO 3/8" AT UNIT.

9. 1/2" CWF TO ESPRESSO MACHINE PUMP. SEE DETAIL PROVIDED ON SHEET P-501.

10. 1/2" CW TO DIPPERWELL FAUCET. REDUCE TO 1/4" AT UNIT.

11. 1/2" CWF TO INSTAHOT TAP. REDUCE TO 1/4" AT UNIT.

12. 1/2" CWF TO WATER TOWER FAUCET LOCATED IN WATER STATION.

13. 3/4" CWF, CW AND 1/2" HW TO BE ROUTED BELOW SLAB, STUB-UP THRU FLOOR OR TO DROP IN WALL AND ROUTE THROUGH CABINETRY FOR FRONT FRONT BAR AREA. 10153, 10215, 10874, 11003, 11851 AND 12694(2). REFER TO NOTES 9, 10, 11, 12, 14, 17, 18 AND 20. VERIFY ROUTING IN FIELD WITH GC PRIOR TO INSTALLATION. CONTRACTOR TO DETERMINE IN FIELD THE MOST COST EFFECTIVE ROUTING AND COORDINATE WITH OWNER'S REPRESENTATIVE PRIOR TO COMMENCING WORK.

14. 1/2" HW & CW TO SINK.

15. 1/2" CW TO SINK.

16. MAKE CONNECTION TO 1-1/2" WATER LINE STUBBED INTO PREMISES BY LANDLORD. LANDLORD TO PROVIDE METER AND BACKFLOW PREVENTER IN LANDLORD'S UTILITY ROOM. VERIFY THAT THE DOMESTIC WATER SERVICE IS ADEQUATE TO SUPPLY A MINIMUM OPERATING FLOW RATE OF 50 GALLONS PER MINUTE; AT A MINIMUM 50PSIG AND A MAXIMUM OF 80PSIG DYNAMIC PRESSURE AT ALL TIMES. IF FLOW RATE OR PRESSURE IS NOT SUFFICIENT, LANDLORD SHALL ENGINEER, FURNISH AND INSTALL A BOOSTER PUMP IN A LOCATION AGREED UPON WITH THE TENANT. ENTIRE INSTALLATION SHALL BE IN ACCORDANCE WITH LOCAL CODES. CONTRACTOR SHALL FIELD VERIFY REQUIREMENTS PRIOR TO BID. BID SHALL INCLUDE ALL WORK NECESSARY FOR A FULLY OPERATIONAL SYSTEM.

AT ESPRESSO AND COFFEE MAKERS ETC. AS REQUIRED BY AHJ. VERIFY REQUIREMENTS PRIOR TO COMMENCING WORK.

17. PROVIDE A WATTS 9D ASSE 1012 BACKFLOW PREVENTER

18. PROVIDE A WATTS 8 ASSE 1011 BACKFLOW PREVENTER ON THE FAUCET (10215) FOR THE BLENDER PITCHER RINSER AS REQUIRED BY CODE.

19. FREEZE PROOF HOSE BIBB BY LANDLORD. COORDINATE PROVISION OF HOSE BIBB WITH LANDLORD AND VERIFY REQUIREMENTS PRIOR TO COMMENCING WORK. HOSE BIBB MUST BE CONNECTED TO 1/2" INSULATED, COPPER PIPE AND RUN WITHIN CONDITIONED SPACE. IT MUST BE EXPOSED AND VISIBLE FOR TENANT'S CONNECTION.

20. 1/2" CWF TO CLOVER BREWER. INSTALL SHUT-OFF IN CABINET. CONNECT 3/8" COMPRESSION BRAIDED STAINLESS STEEL HOSE FROM SHUT-OFF TO BREWER INLET. SEE DETAIL ON SHEET P-501.

21. PROVIDE A WATTS MODEL #008PC-QT ASSE 1056 TYPE BACKFLOW PREVENTER FOR CHEMICAL DISPENSERS AND SANITIZER AS REQUIRED BY AHJ. VERIFY REQUIREMENTS PRIOR TO COMMENCING WORK.



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NORR



St. Louis, Missouri 63119
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Engineering Consultants
Mechanical - Electrical - Plumbing

Revision Schedule

Rev Date By Description

PROJECT NAME:

COMMERCIAL STREET
PROJECT ADDRESS:
145 COMMERCIAL STREET
PORTLAND, ME 04101
CUMBERLAND COUNTY

STORE #: 19384

PROJECT #: 58862-001

CONCEPT: MCS

PALETTE: HERITAGE

ISSUE DATE: JAN. 11, 2013

DESIGN MANAGER: E. ZAKAMAREK

LEED ® AP:

SHEET TITLE:

CHECKED BY:

Plumbing Supply Plan

PRODUCTION DESIGNER: NORR ILLINOIS

CLL /SMD

1/4" = 1'-0"


SCALE:
SHEET NUMBER:

P-111

- N

PLUMBING SUPPLY PLAN

| Scale: 1/4" = 1'-0"

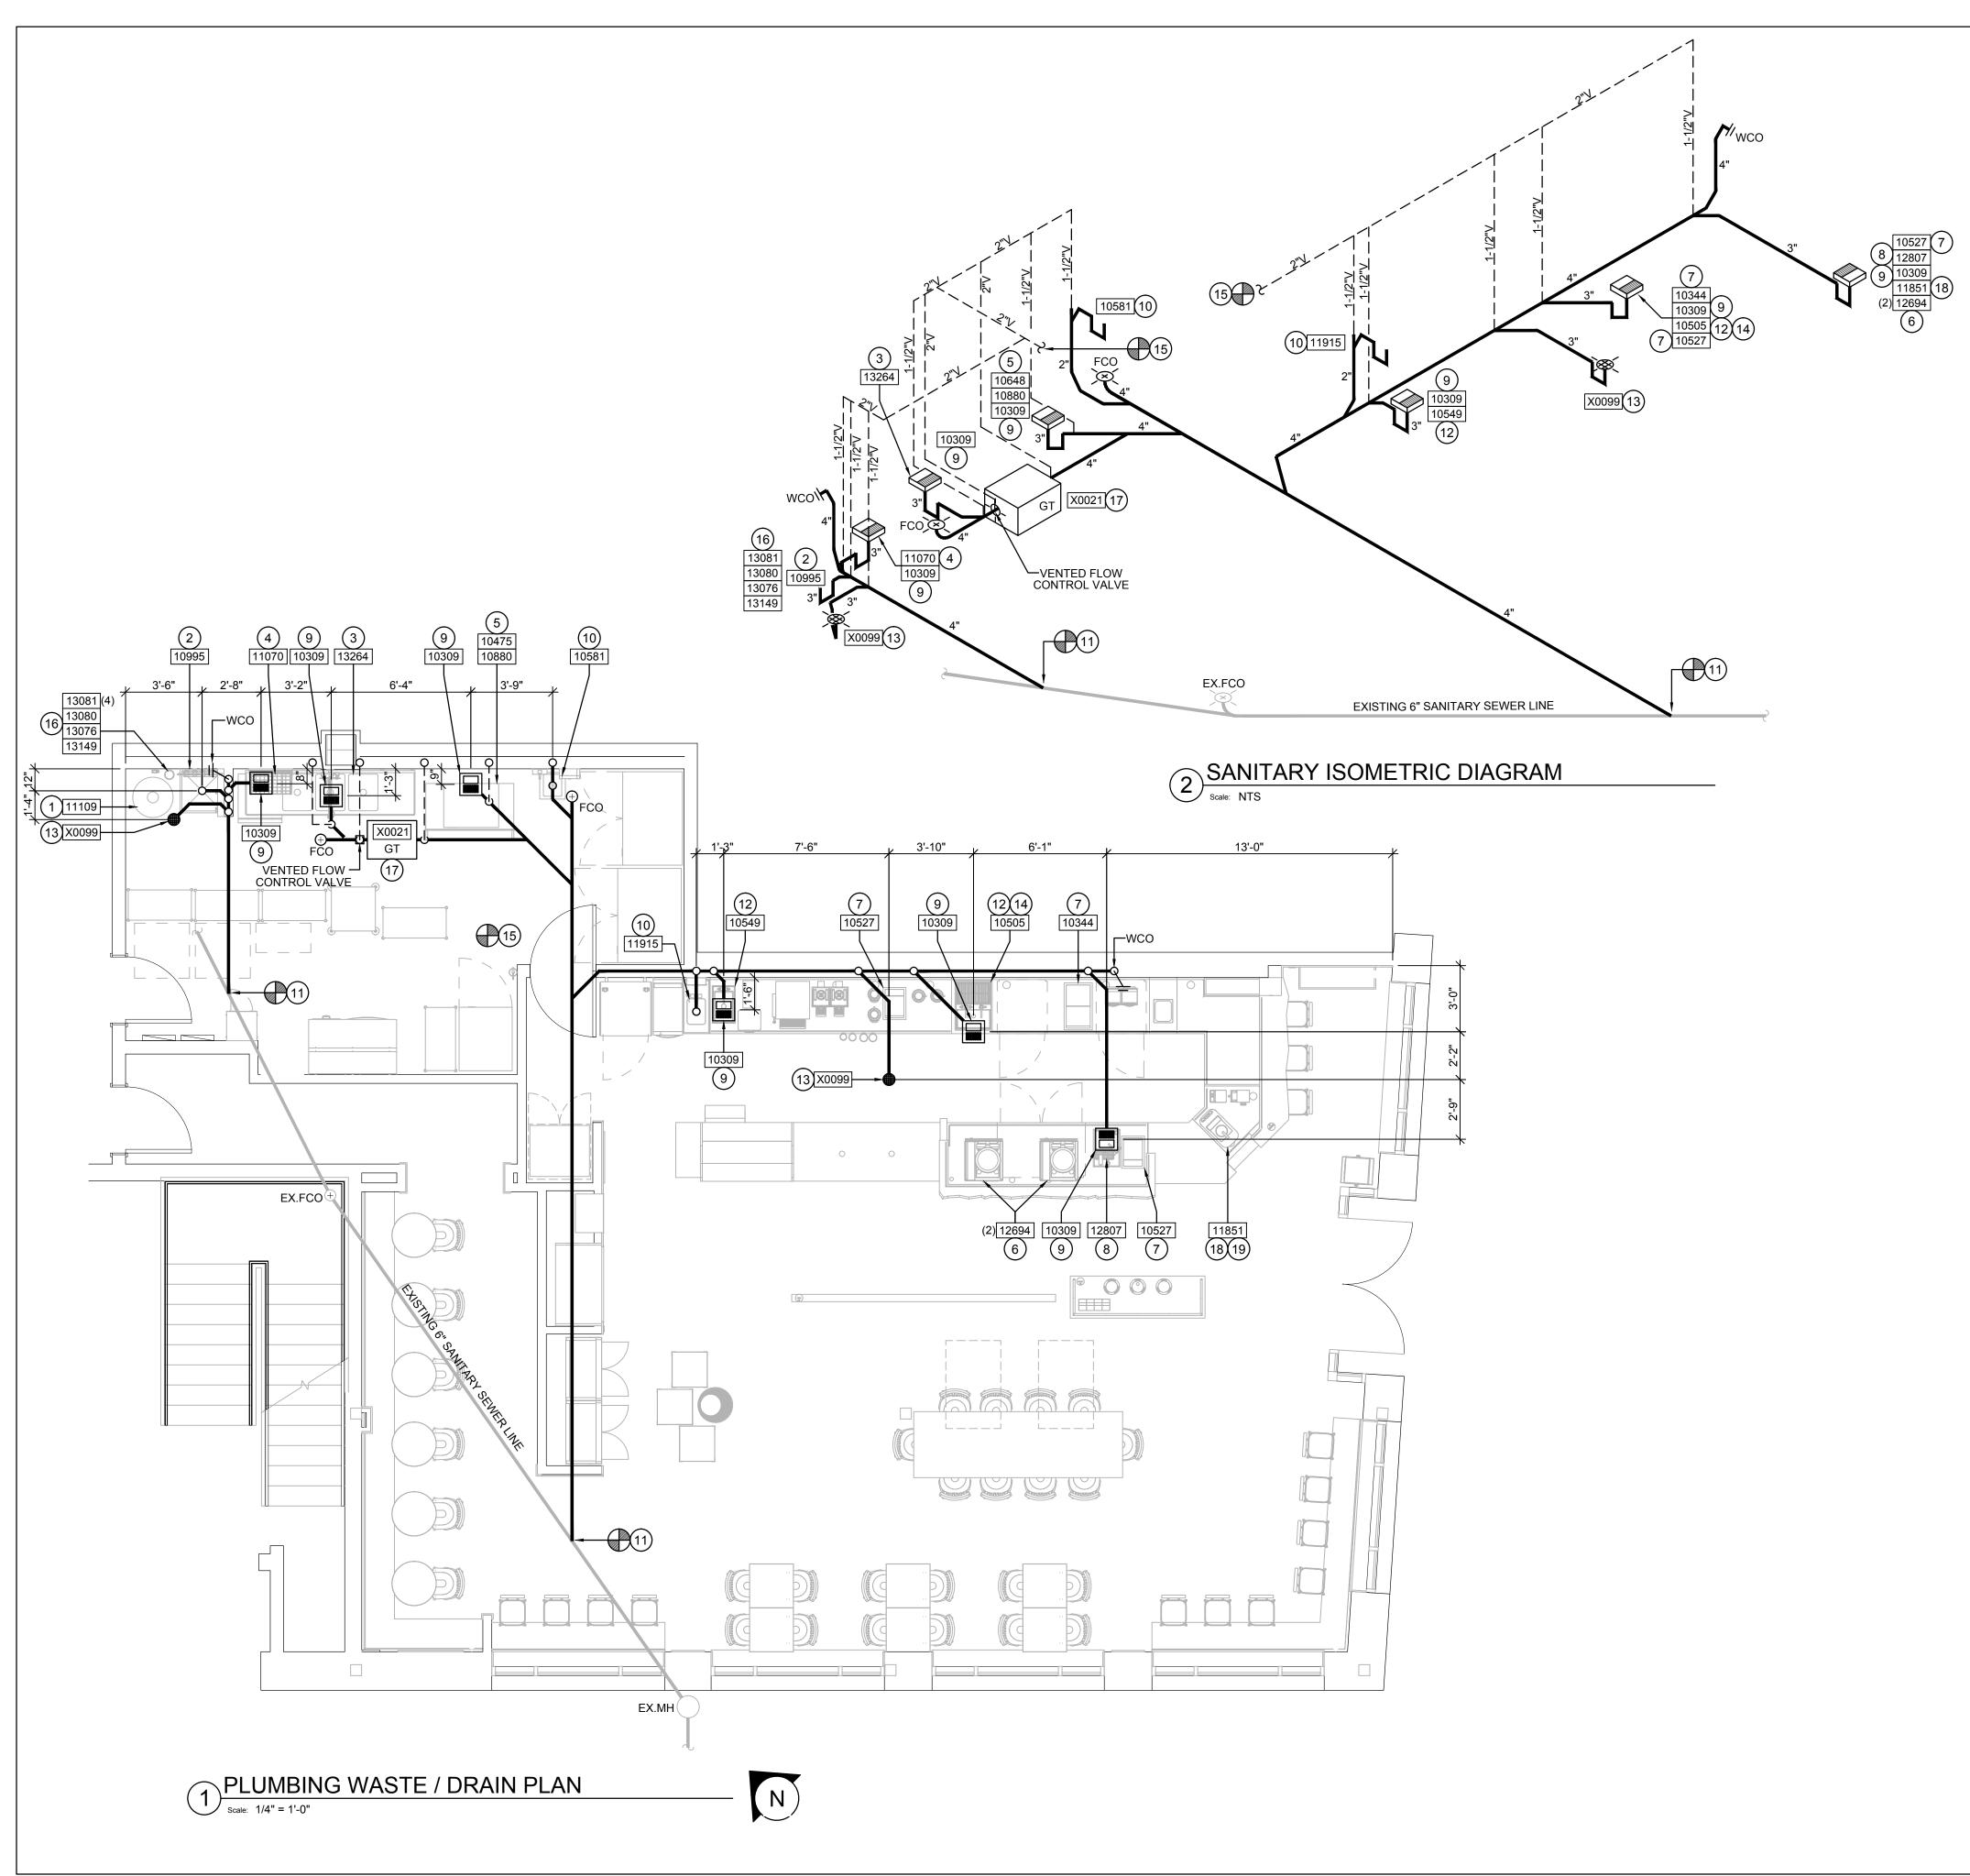

#### Plumbing Design Notes

A. Furnish and install a complete and operating system. All items are not necessarily shown.

B. Plumbing Contractor responsible for site investigation prior to start of work to reveal full scope of work.

C. All Plumbing lines to be routed such that they are not visible to

D. Refer to manufacturer specifications for location of connections unless otherwise noted.

E. Coordinate with Electrical Contractor for power connection to all plumbing equipment.

F. Dimensions are to finish face unless otherwise noted.

G. Refer to detail sheets for plumbing fittings located in casework.

H. Cold water supply lines inside casework and bar area to be covered with 1/2" (10mm) thick self sealing, sectional closed-cell foam insulation. Refer to specifications for hot water supply line insulation requirements.

J. Contractor shall contact water filter supplier before the time that the filter system is to be started up.

K. Verify proper water system with water test results.

#### Sheet Notes

1. 1" INDIRECT DRAIN FROM DRIP PAN AND 3/4" PRESSURE RELIEF FROM WATER HEATER TO FLOOR DRAIN.

2. 3" WASTE FROM MOP SINK.

3. 2" INDIRECT DRAIN FROM COMPARTMENT SINK TO FLOOR

4. 1-1/4" INDIRECT DRAIN FROM DISHWASHER TO FUNNEL OVER FLOOR SINK IF PERMITTED.

5. 5/8" I.D. F.P.T. FROM DRAIN ON ICE MACHINE TO INDIRECT DRAIN AT FLOOR SINK.

6. 5/8" DRAIN HOSE TO INDIRECT DRAIN RISER. SEE DETAIL ON

SHEET P-501.

7. 1" INDIRECT INSULATED DRAIN LINE FROM ICE BIN DROP TO

8. 3/4" INDIRECT DRAIN FROM WATER STATION DRAIN BOARD TO FLOOR SINK.

\_\_\_\_\_

9. 3" WASTE FROM FLOOR SINK.

FLOOR SINK.

10. 2" WASTE FROM SINK.

11. MAKE CONNECTION TO EXISTING SANITARY SEWER WITHIN PREMISES. VERIFY EXACT LOCATION, INVERTS AND REQUIREMENTS ON SITE.

12. 1-1/2" INDIRECT DRAIN TO FLOOR SINK. IF INDIRECT NOT ALLOWED, PROVIDE 2" DIRECT DRAIN. SEE DETAIL ON SHEET

13. 3" WASTE FROM FLOOR DRAIN.

14. 1-1/2" INDIRECT DRAIN FROM PITCHER RINSER SINK.

15. MAKE CONNECTION TO EXISTING VENT SYSTEM (MIN 2") IN PREMISES BY LANDLORD. VERIFY EXACT LOCATION, SIZE AND REQUIREMENTS ON SITE. LANDLORD TO EXTEND VENT LINE TO ABOVE ROOF AND MAINTAIN 10 FOOT CLEARANCES TO ANY AIR INTAKES.

16. 3/4" INDIRECT DRAIN FROM WATER EQUIPMENT TO MOP SINK. CONTRACTOR TO VERIFY EXACT REQUIREMENTS WITH EQUIPMENT SUPPLIER.

17. PROVIDE AND INSTALL GREASE TRAP RECESSED IN FLOOR AS SPECIFIED IN THE GREASE TRAP CALCULATION ON THIS SHEET. VERIFY EXACT LOCATION IN FIELD. PROVIDE WITH VENTED FLOW CONTROL.

18. CLOVER BREWER: ROUTE 1" FLEXIBLE DRAIN HOSE THROUGH COUNTER INTO A RIGID PIPE. ROUTE 1" RIGID PIPE INDIRECT DRAIN TO FLOOR SINK.

19. INDIRECT WASTE LINE: ROUTE CONCEALED AND INSTALL PER CODE WITH 2% SLOPE TO INDIRECT RECEPTOR (SEE DETAIL ON SHEET P-501). NOT ALL INDIRECT WASTE LINES ARE SHOWN BUT SHALL BE INSTALLED AS NEEDED.

#### **GREASE TRAP CALCULATION**

 EQUIPMENT
 DESCRIPTION
 COMP'T SIZE
 FLOW RATE REQUIRED

 13264
 3-COMP SINK
 3(16"x19"x14") = 12,768 CI/231(.75)=
 41.5

 TOTAL GPM = 2 MIN. DRAIN TIME
 41.5 GPM 20.75 GPM

PROVIDE A SCHIER MODEL GB-25 FLUSH WITH FLOOR GREASE TRAP OR APPROVED EQUAL. VENT PER LOCAL CODE.

TOTAL FLOW RATE SUPPLIED

--ATTENTION, ACTION REQUIRED PRIOR TO INSTALLATION --

TOTAL GREASE CAPACITY SUPPLIED 75 LBS

25 GPM

ADDITIONAL PLUMBING NEEDED: CHECK VALVE INSTALLED BETWEEN WATER HEATER & SOFTENER LOCATION, SOFT WATER LINE RUN TO WATER HEATER FROM SOFTENER LOCATION, SERVICE BYPASS FOR SOFTENER.

ADDITIONAL ELECTRICAL NEEDED: DUPLEX OUTLET.

18" DUNNAGE RACK FOR SOFTENER.



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ARCHITECT OF RECORD

NORR

ARCHITECTS

PLANNERS



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Engineering Consultants
Mechanical - Electrical - Plumbing

		Rev	vision Schedule
Rev	Date	Ву	Description

PROJECT NAME:

COMMERCIAL STREET

PROJECT ADDRESS:

145 COMMERCIAL STREET

PORTLAND, ME 04101

CUMBERLAND COUNTY

STORE #: 19384 PROJECT #: 58862-001 CONCEPT: MCS PALETTE: HERITAGE ISSUE DATE: JAN. 11, 2013 DESIGN MANAGER: E. ZAKAMAREK LEED®AP: PRODUCTION DESIGNER: NORR ILLINOIS CLL / SMD CHECKED BY:


SHEET TITLE:

Plumbing Waste/Drain Plan

1/4" = 1'-0"

SCALE:
SHEET NUMBER:

P-112

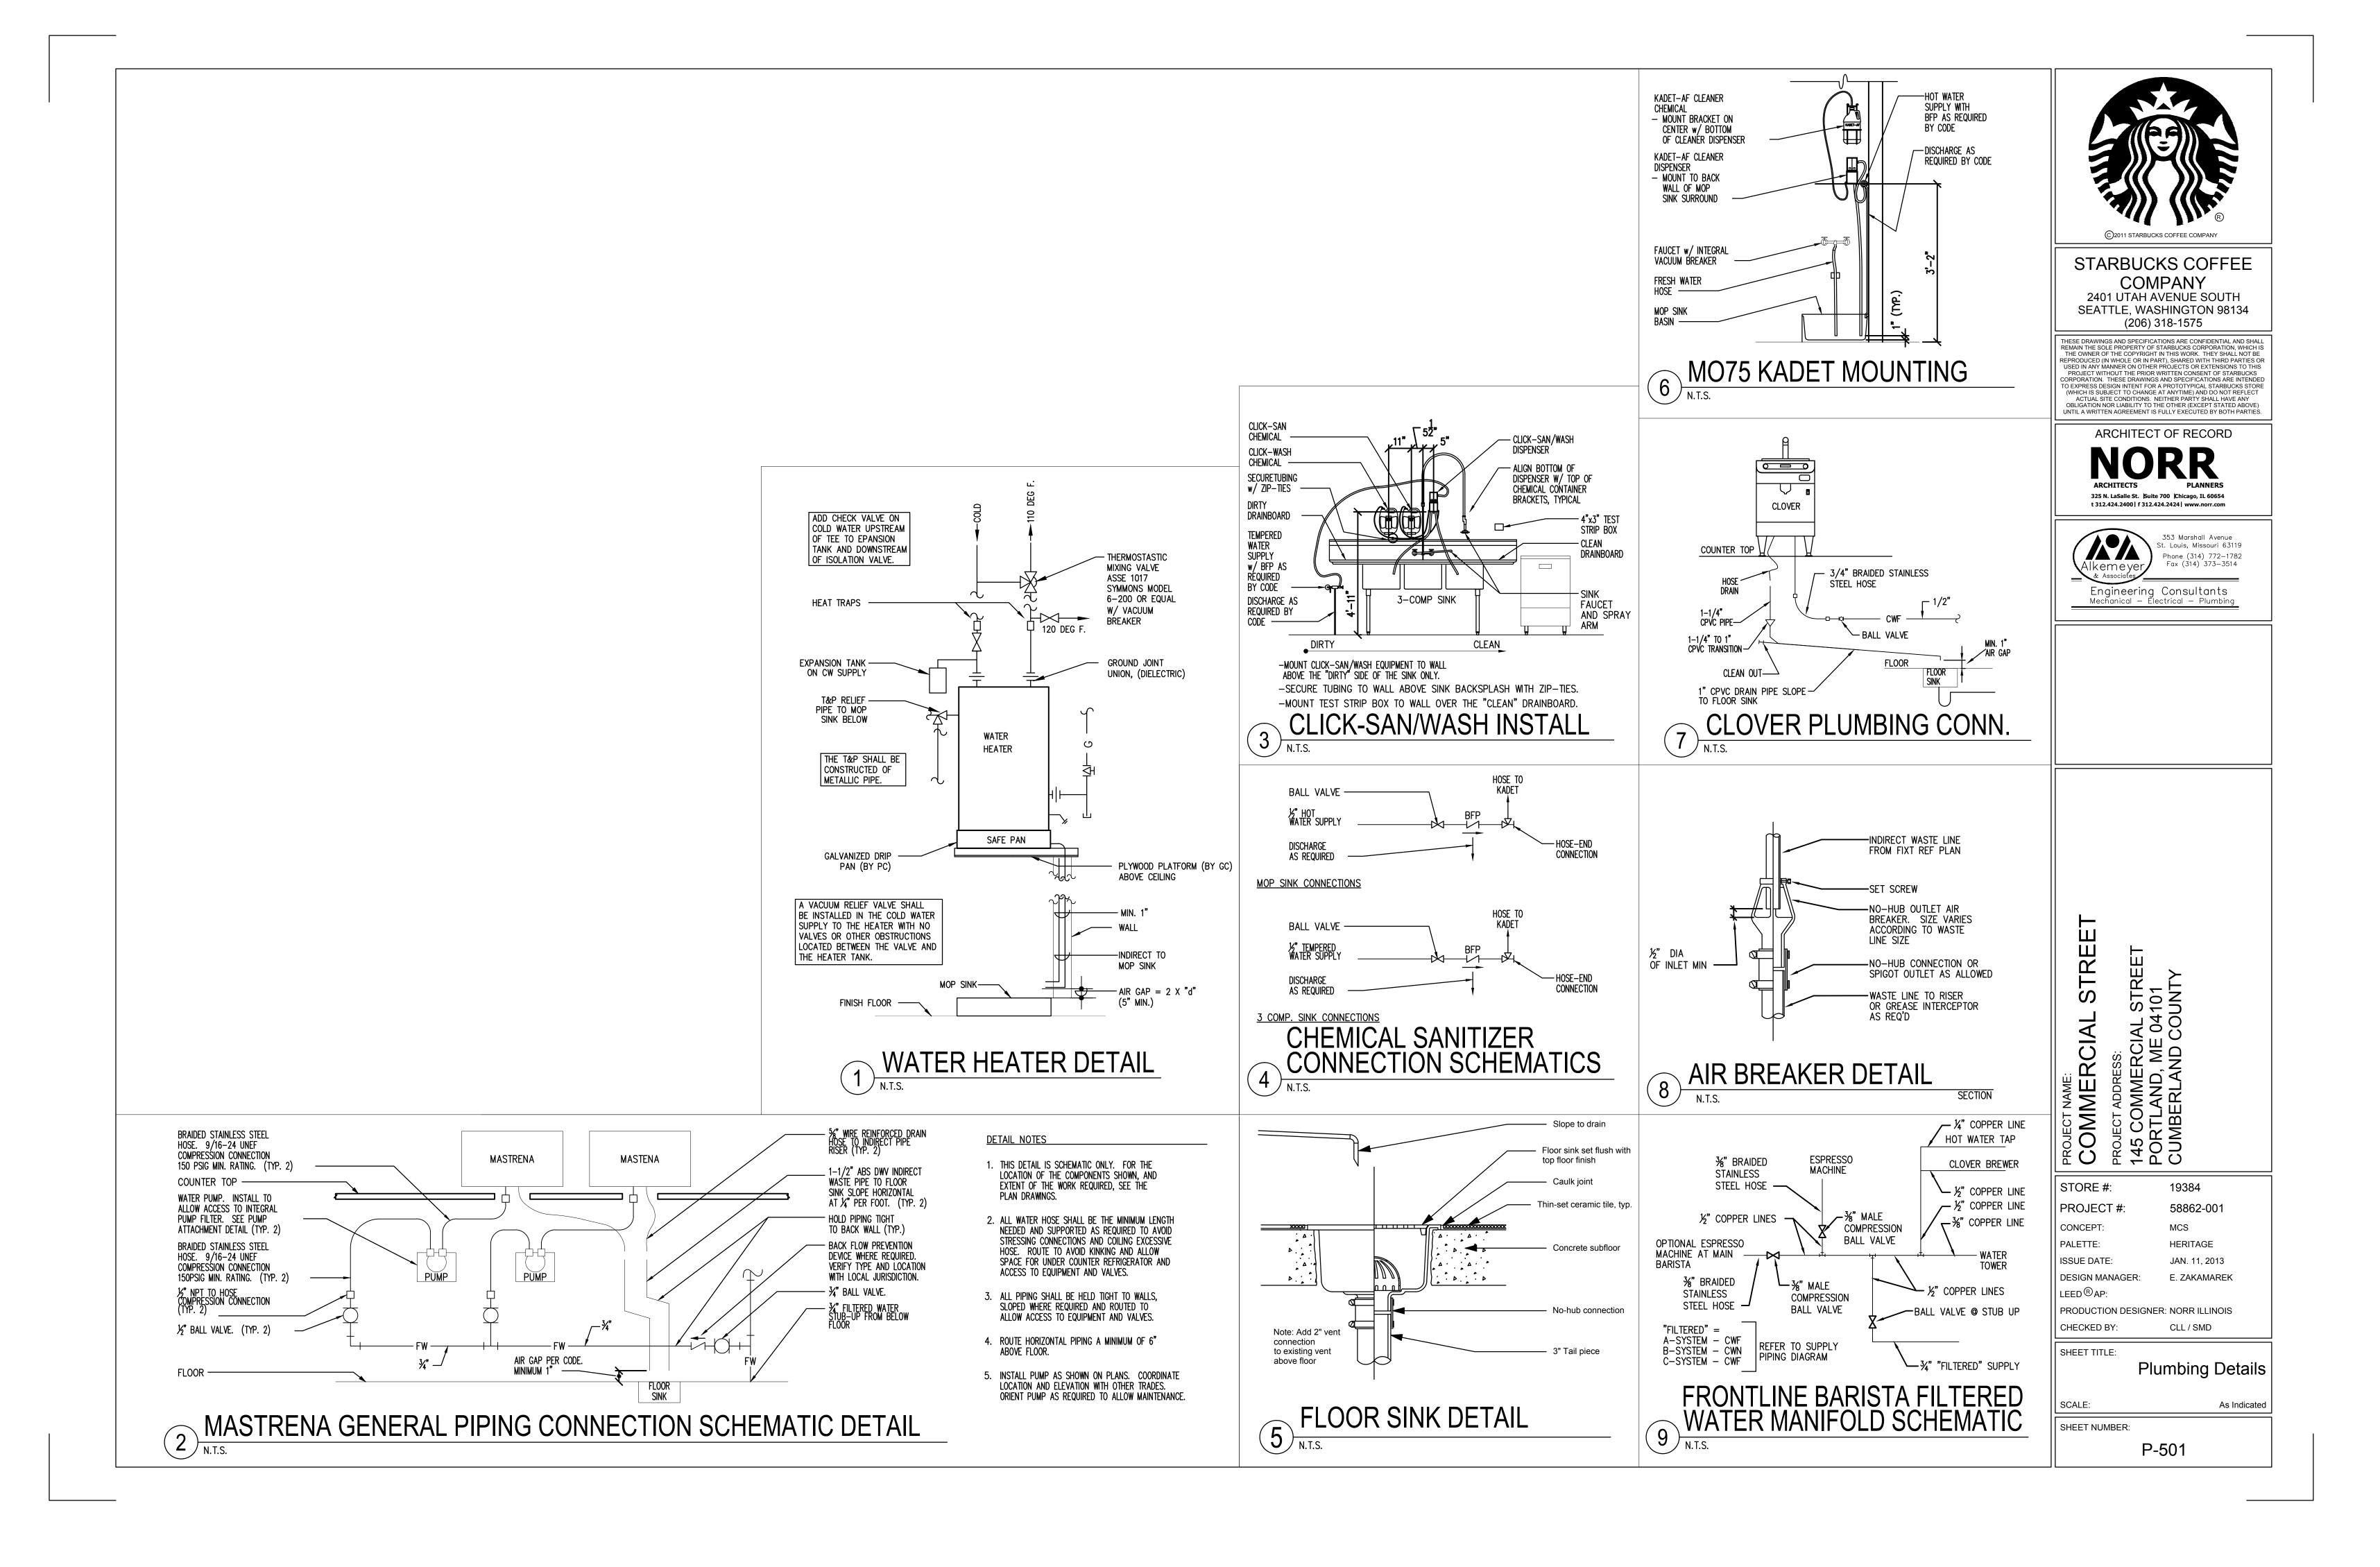

#### Abbreviations Above Finished Floor AHJ Authorities Having Jurisdiction **APPROX** Approximate BLDG Building CLG Ceiling CKT CONST Construction CW Cold Water CM Starbucks Construction Manager CXA Commissioning Agent Lights within Daylight Zone DEG DTL DM Starbucks Design Manager DWG(S) Drawing(s) Each Electrical Contractor ELEC Electrical EM Emergency (E) or (EX) Existing EG Exhaust Grille Furnish & Install FIR Foot/Feet **General Contractor** GFCI Ground Fault Circuit Interrupter GND Ground HVAC HW Hot Water Landlord Low Voltage MAX Maximum MECH Mechanical MC Mechanical Contractor MDP Main Distribution Panel MEP Mechanical, Electrical, and Plumbing MFG Manufacturer MIN Minimum

NTS

OCP

PM

REQ('D)

SPECS

SST

**TEMP** 

TYP

REV

#### **General Specification Notes**

The intent of the specification and the drawings is to provide a complete and fully operational electrical system. The Electrical Contractor shall furnish and install all labor, material, and equipment necessary to complete the electrical work.

Site Examination The Electrical Contractor shall thoroughly examine all areas where equipment,

opinion, prevents the proper installation of the electrical work. Standards Equipment and materials shall conform with appropriate provisions of CSA.

conduit, and wiring will be installed and will report any condition that, in his

ULC, NEC, ASTM, UL, ETL, NEMA, ANSI, as applicable to each individual unit or assembly.

All work shall be performed in strict accordance with all applicable provincial and local codes and ordinances. In case of conflict between the drawings and specifications and the codes, the highest standard shall apply. Electrical Contractor shall satisfy code requirements as a minimum standard without any extra cost to Starbucks.

Permits and Fees

The Electrical Contractor shall procure and pay for all permits, fees, and inspections necessary to complete the Electrical work.

Warranty

The Electrical Contractor shall unconditionally warrant all work to be free of defects in material and workmanship for a period of one (1) year from the date of final acceptance by Starbucks and will repair or replace any defective work promptly and without charge and restore any other existing work damaged in the course of repairing defective materials and workmanship.

All work, materials and equipment shall meet LEED requirements & code. In case of conflict, the higher Standard shall apply.

Heating, Ventilation, Air Conditioning

Not to Scale

Reference

Require(d)

Revision

**Project Manager** 

Specification(s)

Stainless Steel

Square Feet

Telephone

Temporary

Water Heater

Weather Proof

Typical

Overcurrent Protection

Security System Notes

Starbucks contracts directly with Security Vendor to supply and install the security system. Contractor to schedule installation of security system for two (2) times; 1. Rough-in prior to drywall installation 2. Final trim prior to store turnover

Security Vendor requires a minimum two (2) weeks lead time for each installation. Security Vendor will coordinate regional installers. All additional expenses incurred due to the Contractors failure to schedule accordingly will be the responsibility of the Contractor

#### **Telephone System Notes**

LIGHTING FIXTURE SCHEDULE - "L'

General Contractor shall contact Starbucks prior to beginning construction to order telephone lines. Report any telephone installation issues immediately to Starbucks.

Confirm prior to beginning construction that Landlord has furnished and installed one (1) 2" (51mm) conduit including pull string from the telephone point of presence to the Starbucks data rack. Notify Starbucks Construction Manager immediately if conduit and pull string are not installed.

All telephone/network cabling is the scope of work of the Telephone/Network Cabling Vendor and the Security System Vendor. Telephone/Network Cabling Vendor shall be scheduled such that cabling is complete prior to arrival of Security System Vendor.

General Contractor shall schedule on-site work performed by the Telephone/Network Cabling Vendor and the Security System Vendor. The Telephone/Network Cabling Vendor shall be scheduled such that cabling is complete prior to arrival of the Security System Vendor.

#### **General Electrical Notes**

1. The Electrical Contractor shall coordinate electrical work with other trades. The architectural drawings shall take precedence over all other drawings. Do not scale distances off the electrical drawings; use actual building dimensions.

2. All electrical systems shall be tested for proper operation. Balance all branch circuit loads between the phases of the system within 10% of the highest phase load in each panel board.

3. The Electrical Contractor shall be responsible for de-energizing circuits in demolition areas to insure a safe condition. Electrical devices and associated wiring located within the demolition area that will no longer be used shall be removed and properly disposed of at Contractors expense unless otherwise

4. The Electrical Contractor shall schedule all electrical system outages with the General Contractor and Landlord at least 24 hours in advance. Unless approved otherwise all outages shall occur between 11:00pm and 5:00am.

5. Electrical Contractor shall furnish and install all necessary conduit and J-boxes to support a complete security, phone, POS and data systems. See Manager Workstation and Bar Point of Sale (POS) Power/Telecom/Security Diagram. Coordinate all device locations and mounting heights with security vendor prior to rough-in. Provide end-to-end pull strings in all conduits. Label each end of the pull string with conduit system ("Security") and destination ("Café", "Front bar", etc.). Provide insulated bushings on all stubbed-up and exposed conduit ends.

6. Electrical Contractor shall coordinate with the General Contractor to patch and repair all existing walls, floors, ceilings or other surfaces identified to remain that may become damaged during the course of work.

7. Exposed/surface mounted conduits shall only be allowed where necessary in exposed ceiling areas. If conduits need to be surface mounted to walls, coordinate with Starbucks Construction Manager for approval.

8. Verify location of all outlets and switches with architectural drawings, interior details, finish schedules, General Contractor, equipment vendors, Starbucks and existing site conditions. Verify final door hinge location prior to switch installation and adjust switch location if needed. Do not mount receptacles/switches in locations that would conflict with mirrors, seams of walls, wainscots, tile transitions, etc.

#### POS \ Data Line Notes

Data cable referenced in this section is separate from the telephone and T-1 circuits

Starbucks contracts directly with the Data Cabling Vendor to supply and install Category 5 (CAT5) LAN cable and connectors for the Point of Sale (POS) system. Contractor to schedule installation of data cabling with Data Cabling Vendor. Data Cabling Vendor requires a lead time for installation. Data Cabling Vendor will coordinate regional installers. All additional expenses incurred due to the Contractor's failure to schedule accordingly will be the responsibility of the Contractor.

At the start of construction, Starbucks Construction Manager schedules delivery of cash register/manager's workstation equipment and installation by a Data Cabling Technician for two (2) day's prior to construction end. Contractor to verify delivery schedule two (2) weeks prior to delivery and installation date. Equipment is shipped directly to the store, Contractor to accept POS Equipment delivery. Do not refuse delivery.

Data Cabling Technician to provide all Category 5 LAN cabling and connectors to all designed and future cash register locations, and manager's workstation.

Starbucks New Store Group is responsible for coordinating Starbucks POS system delivery and installation with the Data Cabling Vendor. This group may be contacted at: newstore@starbucks.com

|DESIGN ID | COUNT

#### Music System Notes

Provide and install a complete wiring system for all speakers. Connect all speakers to

All cabling and infrastructure to support the T-1 Hotspot or Wi-Fi network shall

#### **Communication System Notes**

communication cables to the space. Four (4) CAT5 cables are dedicated to Store Operations/Communications

#### **Electrical Symbol Legend**

Dimmer Switch

**COMMENTS** 

①	Junction Box	$\bigcirc$	Data Outlet
\$	Switch	$\Rightarrow$	Receptacle: 110 Duplex
<b>\$</b> <sub>3</sub>	Three-Way Switch	$\Rightarrow$	Receptacle: 110 Dedicated
os	Motion (Occupancy) Sensor Switch	#	Receptacle: 110 Quad
SWITCH BANK	Switch Bank See detail on E-113	$\Rightarrow$	Receptacle: 208V or 220V
L <sub>1</sub>	Telephone	₹	Grounding Electrode Connection
1	Thermostat	NL	Nightlighting 24hr/Day
S	Thermostat Sensor	PE	Photoelectric Cell
ı			

Raceway concealed in ceiling or wall. Hash marks indicate number of wires. #12 AWG Wire unless otherwise noted. Two wires plus ground if no hash marks shown. Long hash mark denotes neutral.

the owner provided music system. Mount owner furnished speakers where shown and in coordination with architectural plans and details. Follow manufacturer's installation requirements.

#### Hotspot or Wi-Fi Network Notes

be furnished and installed by the vendor. Coordinate with Starbucks.

Starbucks contracts directly with the Landlord to provide four (4) CAT5 (white)

Ground Wire not shown.

#### **LEED System Commissioning**

#### **Contractor Responsibilities for Building Commissioning**

Contractor shall provide support and work as specified, needed and required to conduct and facilitate Starbucks staff building commissioning efforts. This work will be comprised of three distinct efforts: 1) support Starbucks commissioning agent (CXA) during installation verification and correct disclosed deficiencies; 2) perform testing, adjusting, balancing and system startup and support functional performance testing by Starbucks CXA; 3) correct deficiencies disclosed by functional performance testing and submit reports. Contractor shall perform and provide the following:

A.Systems subject to commissioning may include, but are not limited to, domestic hot water generation, HVAC systems, rooftop units, exhaust fans, HVAC controls, lighting controls, air curtains, built-in refrigeration equipment, and renewable energy

B.Contractor shall include commissioning activities in project schedule and show intervals for performance of work for which contractor is responsible and intervals for work performed by Starbucks CXA. Contractor shall show resources for performing all work related to commissioning activities on a line item in the schedule of values.

C.Contractor shall install equipment in accordance with the manufacturer's requirements and all contract documents. Ensure that all equipment is installed totally complete, and accessible to Starbucks CXA for installation verification and functional performance testing prior to the scheduled start of installation verification.

D.Installation verification shall be performed by Starbucks CXA. Contractor shall support Starbucks CXA installation verification efforts as necessary. Provide all access and equipment necessary for Starbucks staff to verify that the equipment is installed correctly.

E. Contractor shall be readily available during installation verification to correct any deficiencies or defects disclosed by the installation verification process. Corrections shall be made in a timely manner without disruption of the construction schedule.

F. All HVAC, exhaust fan, and air curtain equipment shall be tested, adjusted and balanced by the contractor's testing, adjusting and balance agent( see testing, adjusting and balancing) after the system is verified to be complete and correct by Starbucks CXA, in accordance with the requirements of these documents. All HVAC control systems shall be tested to ensure that control devices, components, equipment and systems are calibrated, adjusted and operate in accordance with these plans and specifications. Sequences of operation shall be tested to ensure that they operate in accordance with the contract requirements. Deliverables: preliminary, written testing and air balance report conforming to the requirements specified herein, documenting the information specified, etc. to the Starbucks CXA immediately upon completion of the work.

G.Contractor shall inform Starbucks CXA when equipment is ready for functional performance testing. All equipment shall be ready for functional performance testing prior to starting testing. Contractor shall operate equipment for Starbucks CXA and verify by demonstration the correct operation of equipment, response of sensors, and proper execution of HVAC control and lighting sequences; including but not limited to, air movement, temperature, sound, and control response. Provide any security access, hardware, software, or other support as needed for the Starbucks CXA to efficiently witness and document all equipment testing. Starbucks CXA will record the equipment operation and response to testing sequences and prepare a list of any deficiencies disclosed by the functional performance tests for correction by the contractor. Equipment includes, but is not limited to, air handling units, rooftop and split type, condensing units, exhaust fans, lighting controls, etc. Deliverables: provide completed copies of all start up reports, filled out on the manufacturers' forms, to the Starbucks CXA.

H.Contractor is responsible for correcting any issues or deficiencies disclosed during the functional performance testing process. Corrections should be made in a timely manner without disruption to the system and construction schedule.

J. Contractor shall be readily available for any re-testing of equipment deemed necessary by Starbucks CXA during installation verification and functional performance testing. Contractor is responsible for correcting any issues or deficiencies found in the system during any and all re-testing. Corrections should be made in a timely manner without disruption to the system and construction schedule. Deliverables: final balance report, deficiencies list noting corrective actions performance test results.

K. Construction and post construction testing: additional testing may be required by LEED and other processes that may occur out of sequence with commissioning service. Contractor shall conduct, document, support and schedule this testing as directed by Starbucks CXA.

COOLING				
10110	1	FRIDGE REACH IN 1 DOOR RH - 29IN 735MM	WH	ENERGY STAR COMPLIANT
10267	2	FRIDGE UNDERCOUNTER 1 DOOR - 27IN 685MM	WH	ENERGY STAR COMPLIANT
10473	1	FRIDGE UNDERCOUNTER 2 DOOR - 48IN 1220MM	WH	ENERGY STAR COMPLIANT
10967	1	FREEZER REACH IN 2 DOOR - 51IN 1295MM	WH	ENERGY STAR COMPLIANT
11083	1	FRIDGE REACH IN 2 DOOR - 51X35IN 1295X890MM	WH	ENERGY STAR COMPLIANT
12480 1 FRIDGE 1 DOOR WITH COUNTERTOP - 29IN 735MM - SST				DELFIELD. ENERGY STAR COMP
EQUIPMENT		•	•	•
10312	2	BREWER SINGLE SOFT HEAT WARMING STAND	WH	
10724	1	GRINDER GRINDMASTER	VD	
10746	1	BREWER DUAL SOFT HEAT	WH	
11070	1	DISHWASHER SANITIZER	WH	ENERGY STAR COMPLIANT
11851	1	BREWER CLOVER	VD	
12407	1	OVEN TURBOCHEF NEXT GENERATION	VD	TURBOCHEF
12508	2	BLENDER QUIET MODEL ON COUNTER	VD	VITAMIX
12631	1	GRINDER DITTING KR804	VD	DITTING
12694	2	ESPRESSO MACHINE MASTRENA	WH	
FOOD CASE				•
12394	1	FOOD CASE - UPRIGHT - 46IN 1170MM - BLACK	VD	STRUCTURAL CONCEPTS
X0015	1	FOOD CASE - HARMONY AMBIENT - 51IN	VD	STRUCTURAL CONCEPTS. HARN NON-REFRIGERATED SERVICE ( MODEL#: HMG5153.5023.
ICE				
10475	1	ICE - MACHINE 1109LB AIR COOLED SIDE VENT	VD	MILE HIGH

DATA DEVICE SCHEDULE - "A"						
DESIGN ID	COUNT	DESCRIPTION	RESP.	COMMENTS		
AUDIO VISU	AL			•		
10005	1	MUSIC SYSTEM	WH			
10076	1	AMPLIFIER - 14IN 355MM	WH			
DATA			-			
10000	1	PHONE 1 LINE	WH			
10001	1	PHONE 2 LINE	WH			
10002	1	COMPUTER MANAGER WORKSTATION	WH	ENERGY STAR COMPLIANT		
10007	1	PRINTER MANAGER WORKSTATION	WH	ENERGY STAR COMPLIANT		
10019	1	WIDE AREA NETWORK HARDWARE	WH			
POINT OF SA	ALE					
10008	2	REGISTER COMPACT	VD			
10014	2	POS PRINTER	VD			
10022	1	MONEY COUNTER	VD			
SECURITY						
10004	1	ALARM SYSTEM	VD			
10024	1	SAFE LH - 20X18X26IN 510X455X660MM	VD			

PLUMBING FIXTURE SCHEDULE - "P"							
DESIGN ID	SIGN ID COUNT DESCRIPTION			COMMENTS			
FAUCET							
10874	1	FAUCET - HOT WATER DISPENSER GOOSENECK	WH				
OTHER							
11109	1	WATER HEATER 50GAL 190L ELECTRIC	GC	ENGINEERS TO PROVIDE SPEC			



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ARCHITECT OF RECORD





Alkemeyer Engineering Consultants Mechanical - Electrical - Plumbing

Revision Schedule							
Rev	Rev Date By Description						

STREE RE OMMERCIAL

STORE #: 19384 PROJECT #: 58862-001 CONCEPT: MCS PALETTE: HERITAGE ISSUE DATE: JAN. 11, 2013 E. ZAKAMAREK **DESIGN MANAGER:** LEED®AP: PRODUCTION DESIGNER: NORR ILLINOIS CHECKED BY: JAK / CJS

SHEET TITLE:

SCALE:

Electrical Specifications

SHEET NUMBER:

E-001

1/4" = 1'-0"

DESIGN ID	COUNT	DESCRIPTION	RESP.	BULB	COMMENTS
EXIT		·	•	•	•
11419	2	EMERGENCY LIGHT DOUBLE - BLACK	VD	BODINE BALLAST TYPE LED	PROVIDED BY GEXPRO.
11611	5	EMERGENCY EXIT LIGHT - WHITE	VD	BODINE BALLAST TYPE LED	PROVIDED BY GEXPRO.
PENDANT					
12348	4	PENDANT - SMALL METAL MESH CYLINDER - BLACKENED STEEL MT0019	VD	(1) 12894 - Incand. T9 Edison 30-39w	PROVIDED BY GEXPRO.
X0050	1	PENDANT - CUSTOM	GC	(16) LED CHANDELIER BULB	RESTORATION HARDWARE. ROPE FILAMEI RECTANGLE CHANDELIER SMALL. ITEM#: 68060369 NATL. BULB MANUFACTURER: BULBRITE. CHANDELIER LITE MEDIUM (E26 BASE. ITEM#: 770411. ORDERING CODE: LED2ETC/E.
RECESSED (	CAN	•	•	•	•
12861	41	CAN - ADJUSTABLE RECESSED HOUSING - 4IN 100MM - NEW CEILING	VD	(1) 12906 - LED PAR 20	PROVIDED BY GEXPRO.
STRIP					
12552	14	TASK LIGHT INTEGRATED LED - 22IN 560MM - BLACK	VD	LED	JUMPER CORD REQUIRED WHEN CONNECTING MULTIPLE UNITS - QTY: 13
TRACK			•	•	•
11427	33	TRACK - FIXTURE ENCLOSED - 5IN 125MM - WHITE	VD	(1) 12903 - LED PAR 30S	PROVIDED BY GEXPRO.
11521	18	TRACK - FIXTURE ENCLOSED - 5IN 125MM - BLACK	VD	(1) 12903 - LED PAR 30S	PROVIDED BY GEXPRO.
12934	1	TRACK - WITH CONNECTORS - 4FT 122CM - WHITE	VD	N/A	PROVIDED BY GEXPRO.
12935	1	TRACK - WITH CONNECTORS - 8FT 244CM - WHITE	VD	N/A	PROVIDED BY GEXPRO.
12944	1	TRACK - WITH CONNECTORS - 16FT 488CM - WHITE	VD	N/A	PROVIDED BY GEXPRO.
12945	2	TRACK - WITH CONNECTORS - 12FT 365CM - WHITE	VD	N/A	PROVIDED BY GEXPRO.
12946	5	TRACK - WITH CONNECTORS - 4FT 122CM - BLACK	VD	N/A	PROVIDED BY GEXPRO.
12949	1	TRACK - WITH CONNECTORS - 12FT 365CM - BLACK	VD	N/A	PROVIDED BY GEXPRO.
TROFFER		•	•	•	•
11404	5	TROFFER - RECESSED - 48X24IN 1220X610MM - WHITE	VD	(3) 12890 - FL T8	PROVIDED BY GEXPRO.


SIGNAGE SCHEDULE - "S"								
DESIGN ID COUNT DESCRIPTION RESP. BULB COMMENTS								
SIGNAGE - DISK								
13157	2	SIGN - DISK DF ILLUMINATED SUSPENDED EVOLVED - 24IN 610MM	VD	LED	BY LOCAL SIGNAGE VENDOR.			
13159		SIGN - DISK BLADE DF ILLUMINATED WITH BRACKET WALL MOUNTED EVOLVED - 24IN 610MM	VD	LED	BY LOCAL SIGNAGE VENDOR.			

10473	1	FRIDGE UNDERCOUNTER 2 DOOR - 48IN 1220MM	TER 2 DOOR - 48IN WH ENERGY STAR COMPLIA	
10967	1	FREEZER REACH IN 2 DOOR - 51IN 1295MM	WH	ENERGY STAR COMPLIANT
11083	1	FRIDGE REACH IN 2 DOOR - 51X35IN 1295X890MM	WH	ENERGY STAR COMPLIANT
12480	1	FRIDGE 1 DOOR WITH COUNTERTOP - 29IN 735MM - SST	VD	DELFIELD. ENERGY STAR COMPLIANT
EQUIPMENT	•			
10312	2	BREWER SINGLE SOFT HEAT WARMING STAND	WH	
10724	1	GRINDER GRINDMASTER	VD	
10746	1	BREWER DUAL SOFT HEAT	WH	
11070	1	DISHWASHER SANITIZER	WH	ENERGY STAR COMPLIANT
11851	1	BREWER CLOVER	VD	
12407	1	OVEN TURBOCHEF NEXT GENERATION	VD	TURBOCHEF
12508	2	BLENDER QUIET MODEL ON COUNTER	VD	VITAMIX
12631	1	GRINDER DITTING KR804	VD	DITTING
12694	2	ESPRESSO MACHINE MASTRENA	WH	
FOOD CASE				
12394	1	FOOD CASE - UPRIGHT - 46IN 1170MM - BLACK	VD	STRUCTURAL CONCEPTS
X0015	1	FOOD CASE - HARMONY AMBIENT - 51IN	VD	STRUCTURAL CONCEPTS. HARMONY NON-REFRIGERATED SERVICE CASE. MODEL#: HMG5153.5023.
ICE				
10475	1	ICE - MACHINE 1109LB AIR COOLED SIDE VENT	VD	MILE HIGH
OTHER				
10314	1	SCALE DIGITAL WITH ADJUSTABLE DISPLAY MOUNT	WH	
11823	1	SCALE DIGITAL	WH	

SPECIALTY EQUIPMENT SCHEDULE - "E"

RESP.

**DESCRIPTION** 

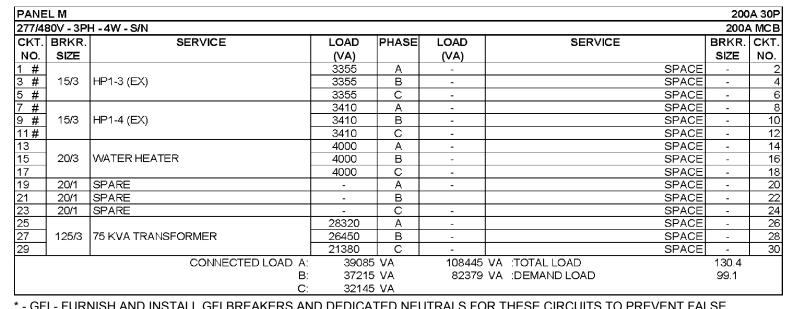

\* - GFI - FURNISH AND INSTALL GFI BREAKERS AND DEDICATED NEUTRALS FOR THESE CIRCUITS TO PREVENT FALSE TRIPPING. EQUIPMENT AIC RATINGS SHALL EXCEED THE AVAILABLE FAULT CURRENT. CONTRACTOR SHALL VERIFY AVAILABLE FAULT CURRENT WITH UTILITY PRIOR TO CONSTRUCTION. SYSTEM SHALL BE SERIES RATED IF NECESSARY TO LIMIT SHORT CIRCUIT CURRENT TO BELOW 22,000 AIC (FOR GFI BREAKERS). COORDINATE WITH LANDLORD.

6 11083 A-6

ФФ-

8 X<sub>0015</sub> A-21,23 J

10000

# - LANDLORD E.C. SHALL EXTEND CIRCUITRY FROM EXISTING WSHPS TO NEW PANEL AS REQUIRED.

10004 10022 10005 10076


(24)

24

1 ELECTRICAL POWER PLAN

(19)A-30,32,34

PANEL B

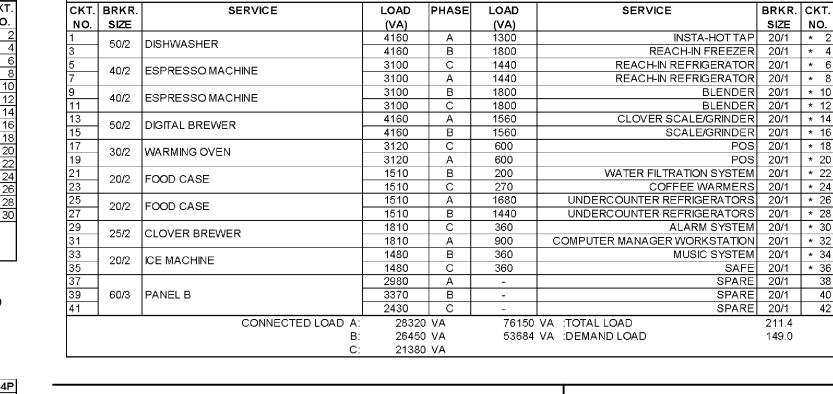

12694 (4) (13)


12694 (4) (13)

10008 10014 (15)

11)

**⊕**B-3(24)

A-29,31 11851 (22)

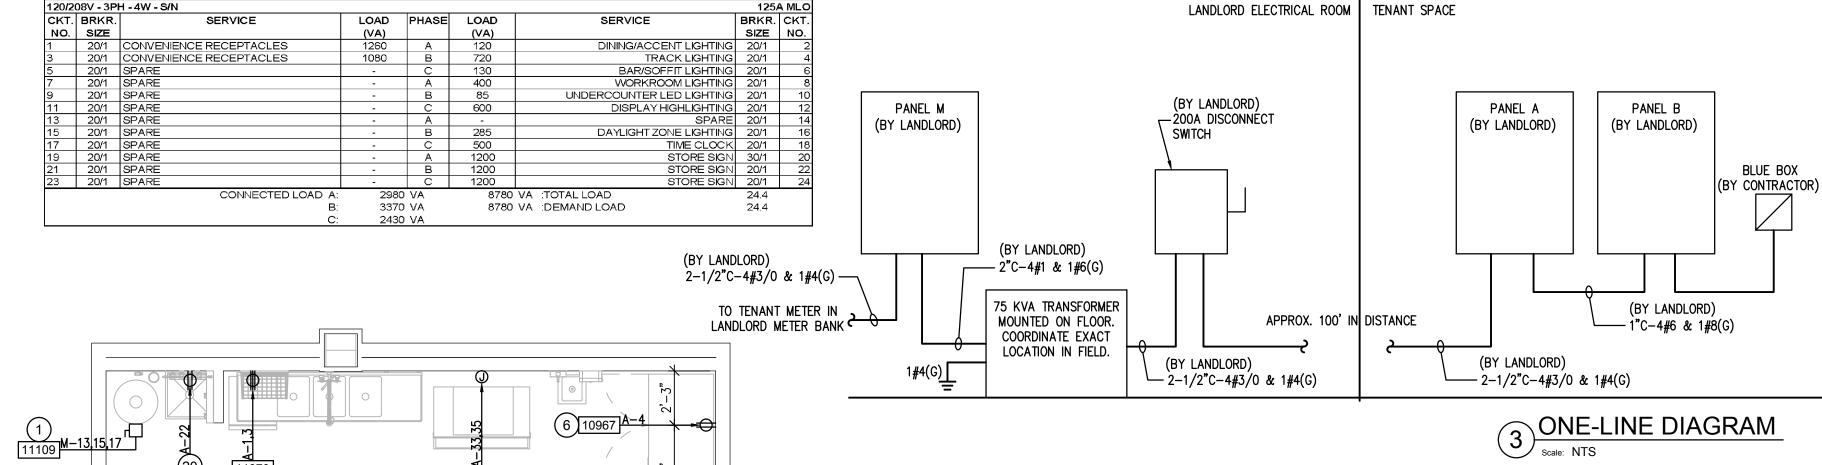

PANELA

120/208V - 3PH - 4W - S/N

#### **Electrical Design Notes**

225A 42P

225A MCB

A. Refer to Architectural detail sheets for exact locations and mounting heights of electrical devices.

B. The Electrical Contractor is responsible for confirming all voltage requirements on all equipment and providing buck-boost transformers as may be needed for code. All are not necessarily indicated.

C. Electrical Contractor shall coordinate with Plumbing and Heating, Ventilating, and Air Conditioning (HVAC) Contractors for any additional equipment needing power.

D. All future equipment needed herein shall be provided with an appropriate receptacle and fully wired. Even if not specifically indicated.

E. Ground fault circuit interrupter (GFCI) breakers (not receptacles) shall be utilized where required by code and at any floor boxes. Provide dedicated neutral wire for all these circuits.

F. Equipment requires connection to the building electrical system. Furnish and install all necessary conduct, wire, connections, receptacles and overcurrent protection necessary to ensure the equipment functions properly and complies with all applicable local and national codes. Coordinate equipment requirements with manufacturer cut sheet prior to rough-in.

G. All back bar and front bar J-boxes and outlets shall be surface mounted. Provide conduits as needed and one (1) additional spare conduit between all J-boxes for future electrical requirements. All J-boxes shall be positioned to avoid obstruction of any equipment such as refrigerators and dishwashers.


#### **ONE-LINE DIAGRAM NOTES:**


LANDLORD TO PROVIDE NEW 200A, 277/480V-3PH ELECTRICAL SERVICE TO SPACE INCLUDING INSTALLATION OF METERING AND DISCONNECT IN LANDLORD ELECTRICAL ROOM (CONTRACTOR TO VERIFY CONNECTION REQUIREMENTS WITH BUILDING ENGINEER).

LANDLORD IS RESPONSIBLE FOR, BUT NOT LIMITED TO, ALL WORK DOWNSTREAM OF EXISTING BUILDING DISTRIBUTION PANEL. ALL WORK SHALL BE IN ACCORDANCE WITH UTILITY COMPANY REQUIREMENTS AND LOCAL CODE.

LANDLORD SHALL CONTACT THE ELECTRIC UTILITY CO. TO VERIFY ALL DETAILS OF NEW SERVICE AND IS RESPONSIBLE FOR ANY FEES.

LANDLORD IS RESPONSIBLE FOR A COMPLETE AND OPERATIONAL SYSTEM IN COMPLIANCE WITH NEC AND ALL STATE AND LOCAL CODES.

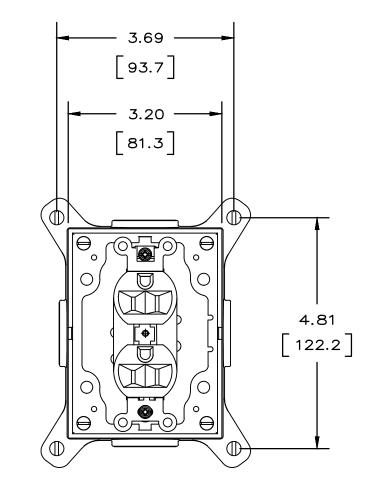

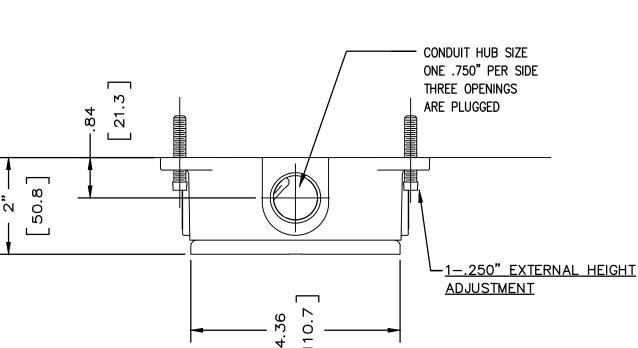

FLOOR MOUNTED RECEPTACLE

Scale: NTS

#### **Sheet Notes**

1. PROVIDE ELECTRICAL CONNECTION TO WATER HEATER. CONFIRM ELECTRICAL REQUIREMENTS PRIOR TO ROUGH-IN.

2. RETAIL GRINDER AND SCALE, PROVIDE RECEPTACLE @ 26" AFF.

3. TWIN BREWER: PROVIDE RECEPTACLE @ 26" AFF.

4. ESPRESSO MACHINE: FURNISH AND INSTALL HEAVY DUTY RECEPTACLE AT 30" AFF. FURNISH AND INSTALL HEAVY DUTY ANGLED PLUG.

5. UNDER COUNTER REFRIGERATOR: PROVIDE RECEPTACLE @ 26" AFF.

6. REFRIGERATOR AND/OR FREEZER: PROVIDE RECEPTACLE AS SHOWN AT

7. ICE MACHINE: CONFIRM VOLTAGE CONFIGURATION PRIOR TO ROUGH-IN WITH EQUIPMENT PROVIDED. FURNISH AND INSTALL ALL NECESSARY CONDUIT, WIRE CONNECTIONS AND BREAKERS TO SUPPORT ICE MACHINE.

8. FOOD CASE: PROVIDE ELECTRICAL CONNECTION FOR REFRIGERATION AND LIGHTING.

9. DISHWASHER (HIGH TEMP.): PROVIDE HEAVY DUTY RECEPTACLE. ROUTE 3/4" CONDUIT WITH (3) #6, #10 GROUND TO PANEL. PROVIDE HEAVY DUTY ANGLED PLUG AND CORD TO DISHWASHER.

10. COFFEE WARMERS: PROVIDE AND INSTALL RECEPTACLE @ 26" AFF.

11. INSTA-HOT: PROVIDE RECEPTACLE AT 26" AFF.

12. BLENDERS: PROVIDE A DUPLEX RECEPTACLE AT 26" AFF ON A DEDICATED CIRCUIT FOR EACH BLENDER.

13. ESPRESSO MACHINES: CIRCUIT VOLTAGE SHALL BE BETWEEN 198 VOLTS AND 218 VOLTS. IF NEEDED, THE CONTRACTOR SHALL PROVIDE A SQUARE-D BUCK-BOOST TRANSFORMER TO BE LOCATED IN AN ACCESSIBLE LOCATION WITHIN 6'-0" OF THE ELECTRICAL PANEL. CONFIRM LOCATION WITH PROJECT MANAGER PRIOR TO ROUGH-IN. PROVIDE ANY ADDITIONAL CONDUIT. WIRE. PRIMARY AND SECONDARY PROTECTION, AND CONNECTIONS NECESSARY TO INSURE A FUNCTIONAL SYSTEM.

14. SAFE: PROVIDE RECEPTACLE ON DEDICATED CIRCUIT. ADJACENT TO RECEPTACLE, PROVIDE J-BOX FOR SAFE AND ROUTE CONDUIT BACK TO SECURITY PANEL J-BOX. SEE ALSO MANAGER WORKSTATION & BAR POS POWER / TELECOM / SECURITY ELEVATION.

15. POS: FURNISH AND INSTALL DOUBLE DUPLEX ISOLATED-GROUNDING TYPE RECEPTACLE AT 18" AFF., INCLUDING GREEN GROUNDING WIRE AND ISOLATED GROUNDING WIRE BACK TO SERVING POWER PANEL PER CODE. FURNISH AND INSTALL (1) J-BOX FOR DATA OUTLET AND (1) J-BOX FOR PHONE OUTLET AT 18" AFF.

16. STUB UP POWER, DATA, AND PHONE CONDUITS 6" AFF IN THIS LOCATION. ROUTE POWER CONDUCTORS IN FLEXIBLE METAL CONDUIT TIGHT TO WALL FROM RECEPTACLES TO NEARBY RIGID STUB-UP AND BACK TO SERVING POWER PANEL. ROUTE DATA AND PHONE CONDUITS UNDERFLOOR BACK TO DATA RACK NEAR MANAGERS WORKSTATION. LABEL DATA AND PHONE CONDUITS "FOR DATA CABLING", PROVIDE INSULATED BUSHINGS, AND PROVIDE PULL STRING FROM END TO END. LABEL SECURITY CONDUIT "FOR SECURITY" AND PROVIDE PULL STRING FROM END TO END.

17. FURNISH AND INSTALL NEMA 6-30R RECEPTACLES AT 28" AFF TO SUPPORT WARMING OVENS.

18. PROVIDE DATA CONNECTION AS REQUIRED FOR WARMING OVEN. WORK SHALL INCLUDE ROUGH-IN AND CONDUIT WITH CAT5 CABLE FROM EQUIPMENT TO DATA RACK. COORDINATE LOCATION AND CONNECTION REQUIREMENTS WITH STARBUCKS PROJECT MANAGER IN FIELD.

19. MANAGER'S WORKSTATION: PROVIDE LAN/POS/ELECTRICAL DEVICES. SEE DETAILS ON ARCHITECTURAL SHEETS FOR LOCATIONS AND EQUIPMENT. ALL REQUIRED OUTLETS ARE NOT NECESSARILY SHOWN.

20. WATER FILTER SYSTEM: RECEPTACLE AT 60" AFF.

21. CLOVER SCALE & RETAIL GRINDER: FURNISH AND INSTALL QUADPLEX RECEPTACLE IN CABINET FOR EQUIPMENT AND MAINTENANCE.

22. CLOVER BREWER: FURNISH AND INSTALL NEMA L6-30R RECEPTACLE IN CABINET WITH SUFFICIENT CLEARANCE TO OPERATE LOCKING PLUG. ROUTE (2) #10G AND (1) #10G CONDUCTORS IN CONDUIT SIZED PER CODE TO

SÉRVICE PANÈL. 23. NEW FLOOR RECEPTACLE TO BE LOCATED AS SHOWN. COORDINATE LOCATION WITH EXISTING CONDITIONS PRIOR TO CHANNELING OF FLOOR. CONTRACTOR TO CONNECT NEW GENERAL POWER RECEPTACLES TO

24. PROVIDE RECEPTACLE AT 18" A.F.F. IN SEATING AREAS. LOCATE IN MILLWORK/WALL PER ARCHITECTURAL DETAILS, COORDINATE WITH GC.

25. ELECTRICAL CONTRACTOR TO PROVIDE AND INSTALL RECEPTACLE AT MANAGERS WORK STATION TO PROVIDE POWER FOR TASK LIGHT. TASK LIGHT TO SATISFY REQUIREMENTS FOR LEED CREDIT EQc6. COORDINATE RECEPTACLE LOCATION TYPE OF TASK LIGHT WITH OWNER PRIOR TO

#### Electrical Symbols Legend

Junction Box



Thermostat

Receptacle: Data

Receptacle: Duplex

Receptacle: Duplex - Dedicated ₩ Receptacle: High Voltage

Receptacle: Quadplex

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ARCHITECT OF RECORD



Engineering Consultants

Mechanical - Electrical - Plumbing

**Revision Schedule** Description Rev Date By

STREE STREE1 1101 UNTY PROJECT NAME:
COMMERCIAL

STORE #: 19384 PROJECT #: 58862-001 MCS CONCEPT: PALETTE: HERITAGE ISSUE DATE: JAN. 11, 2013 **DESIGN MANAGER:** E. ZAKAMAREK LEED®AP: PRODUCTION DESIGNER: NORR ILLINOIS CHECKED BY: JAK / CJS

SHEET TITLE:

SCALE:

**Electrical Design** 


1/4" = 1'-0"

SHEET NUMBER:

E-112



- . RELAYS ARE HOUSED WITHIN BLUE BOX
- COORDINATE ALL TIME CLOCK SETTINGS WITH OWNER 3. CONTROL MODELS SHALL BE AS FOLLOWS:
- 3.1. DIGITAL SWITCH: CHELSEA DIGITAL SWITCH (SEE DETAILS AND NOTES FOR SWITCH TYPE AND
- COORDINATE WITH OWNER AND MANUFACTURER FOR SWITCH OPTIONS) TIME CLOCK: BLUE BOX #GR1416-LT-ENC-SM-NE1
- 3.3. OUTDOOR PHOTOCELL: #PCELL-2WO OR EQUAL\*
- \* IF DIFFERENT PHOTOCELL IS USED THEN WHAT IS SPECIFIED THEN VERIFY COMPATIBILITY WITH
- 3.4. INDOOR PHOTOCELL: #CMR-PC OR EQUAL\*

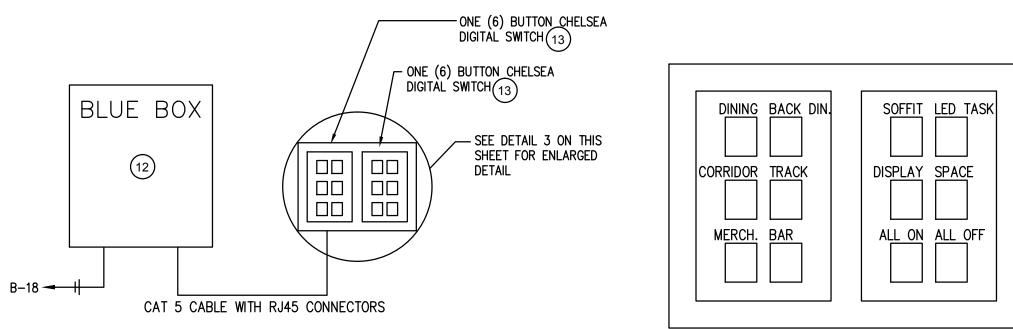

2 LIGHTING CONTROLLER DETAIL

Scale: NTS

3 ENLARGED DIGITAL SWITCH DETAIL

CURRENT LIMITER SCHEDULE

2 TCL2 - 2A CURRENT LIMITING CIRCUIT BREAKER 240W COLOR TO MATCH 3 TCL3 - 3A CURRENT LIMITING CIRCUIT BREAKER 360W COLOR TO MATCH

	6						
	MAXIMUM LIGHTING WATTS  SQUARE FEET ALLOWED ACTUAL						
	DINING: FAST FOOD	1748 FT <sup>2</sup>	3256 WATTS	2581 WATTS			

#### **Lighting Plan Notes**

A. Refer to Architectural Plans for dimensioned fixture locations.

B. All fixtures in food preparation area shall have shatterproof lamps if the fixture is not lensed. Architect of Record to verify per local jurisdictional requirements.

C. Provide grommet at all ceiling penetrations for fixtures/supports.

D. Center emergency/exit lights above doors, unless

otherwise noted. E. Adjust focus of all track and recessed directional

lighting to fully illuminate all artwork, menu boards, and merchandise bays.

F. If pendant cylinders can suspended length exceeds 48" (1220mm) from ceiling, replace with surface mounted cylinder cans and suspend with General Contractor supplied conduit and J-box to dimensioned

#### **Sheet Notes**

1. TRACK LIGHTING TO BE INSTALLED IN LOCATION

2. UNDER CABINET TASK LIGHTING TO BE CIRCUITED THROUGH 20 AMP CIRCUIT BREAKER IN PANEL. VERIFY SWITCHING REQUIREMENTS IN FIELD WITH LIGHTING SCHEME.

3. CAN LIGHT FIXTURES TO BE INSTALLED IN LOCATION

4. PROVIDE AND INSTALL CMR-PC CEILING MOUNTED, LINE VOLTAGE PHOTOCELL, OR EQUAL, FOR CONTROLLING LIGHTING IN DAYLIGHT ZONE TO COMPLY WITH LEED CREDIT EAc1.2: OPTIMIZE ENERGY PERFORMANCE - LIGHTING CONTROLS. LOCATION SHOWN ON PLAN FOR REFERENCE ONLY. VERIFY EXACT LOCATION AND REQUIREMENTS WITH SUPPLIER. PHOTOCELL ALSO TO BE CONTROLLED BY BLUE BOX LIGHTING CONTROLLER.

5. INSTALL 2x4 FLUORESCENT LIGHT FIXTURES.

6. E.C. SHALL PROVIDE ROUGH-IN AND FINAL CONNECTION TO STOREFRONT SIGN. FIELD VERIFY EXACT MOUNTING HEIGHT AND LOCATION WITH OWNER PRIOR TO COMMENCING WORK AND/OR PLACING BID.

7. EXIT SIGN TO BE INSTALLED IN LOCATION SHOWN. CIRCUIT WITH LOCAL LIGHTING. CIRCUIT AHEAD OF ANY BLUE BOX CONTROLS OR SWITCHING.

8. EMERGENCY LIGHT TO BE INSTALLED IN LOCATION SHOWN. CIRCUIT WITH LOCAL LIGHTING. CIRCUIT AHEAD OF ANY BLUE BOX CONTROLS OR SWITCHING.

9. CIRCUIT SERVING THIS DEVICE SHALL BE CONTROLLED BY BLUE BOX. SEE DETAILS AND RELAY SCHEDULE ON THIS SHEET FOR MORE INFORMATION.

10. NIGHT LIGHT TO BE INSTALLED IN LOCATION SHOWN. CIRCUIT AHEAD OF ANY BLUE BOX CONTROLS AND TO UNSWITCHED LEG OF LOCAL LIGHTING.

11. INSTALL PENDANT LIGHTS AND PROVIDE JUNCTION BOXES WHERE APPLICABLE.

12. PROVIDE AND INSTALL BLUE BOX #GR1416-LT-ENC-SM-NE1. CONTRACTOR SHALL PROVIDE ALL NECESSARY PARTS AND MATERIALS FOR COMPLETE INSTALLATION. BLUE BOX SHALL BE ORDERED WITH OUTDOOR PHOTOCELL #PCELL 2W0, OR EQUAL AND COMPATIBLE WITH BLUE BOX LT, FOR EXTERIOR LIGHTING CONTROLS (VERIFY LOCATION OF OUTDOOR PHOTOCELL WITH MANUFACTURER PRIOR TO COMMENCING WORK). COORDINATE ALL REQUIREMENTS WITH EQUIPMENT SUPPLIER PRIOR TO COMMENCING WORK. MOUNT TOP OF CABINET AT 48" A.F.F. SEE DETAILS AND "RELAY SCHEDULE" ON THIS SHEET FOR MORE INFORMATION. ALL TIME CLOCK SETTINGS TO BE COORDINATED WITH OWNER.

13. PROVIDE AND INSTALL CHELSEA DIGITAL SWITCH. SEE DETAIL 3 ON THIS SHEET FOR TYPE OF CHELSEA DIGITAL SWITCH (# OF BUTTONS) AND PUSHBUTTON DESIGNATION. PUSHBUTTON DESIGNATIONS NEED TO BE SPECIFIED AT TIME OF ORDERING. MOUNT TOP OF DIGITAL SWITCH AT 48" A.F.F. LOCATION OF DIGITAL SWITCH SHOWN ON PLANS IS FOR REFERENCE ONLY, COMMENCING WORK.



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> ARCHITECT OF RECORD 325 N. LaSalle St. |Suite 700 |Chicago, IL 60654 t 312.424.2400 | f 312.424.2424 | www.norr.com



STREET PROJECT NAME:

COMMERCIAL

STORE #: 19384 PROJECT #: 58862-001 MCS CONCEPT: HERITAGE ISSUE DATE: JAN. 11, 2013 **DESIGN MANAGER:** E. ZAKAMAREK LEED®AP: PRODUCTION DESIGNER: NORR ILLINOIS

SHEET TITLE:

SCALE:

CHECKED BY:


Lighting Design

1/4" = 1'-0"


JAK / CJS

SHEET NUMBER:

E-113

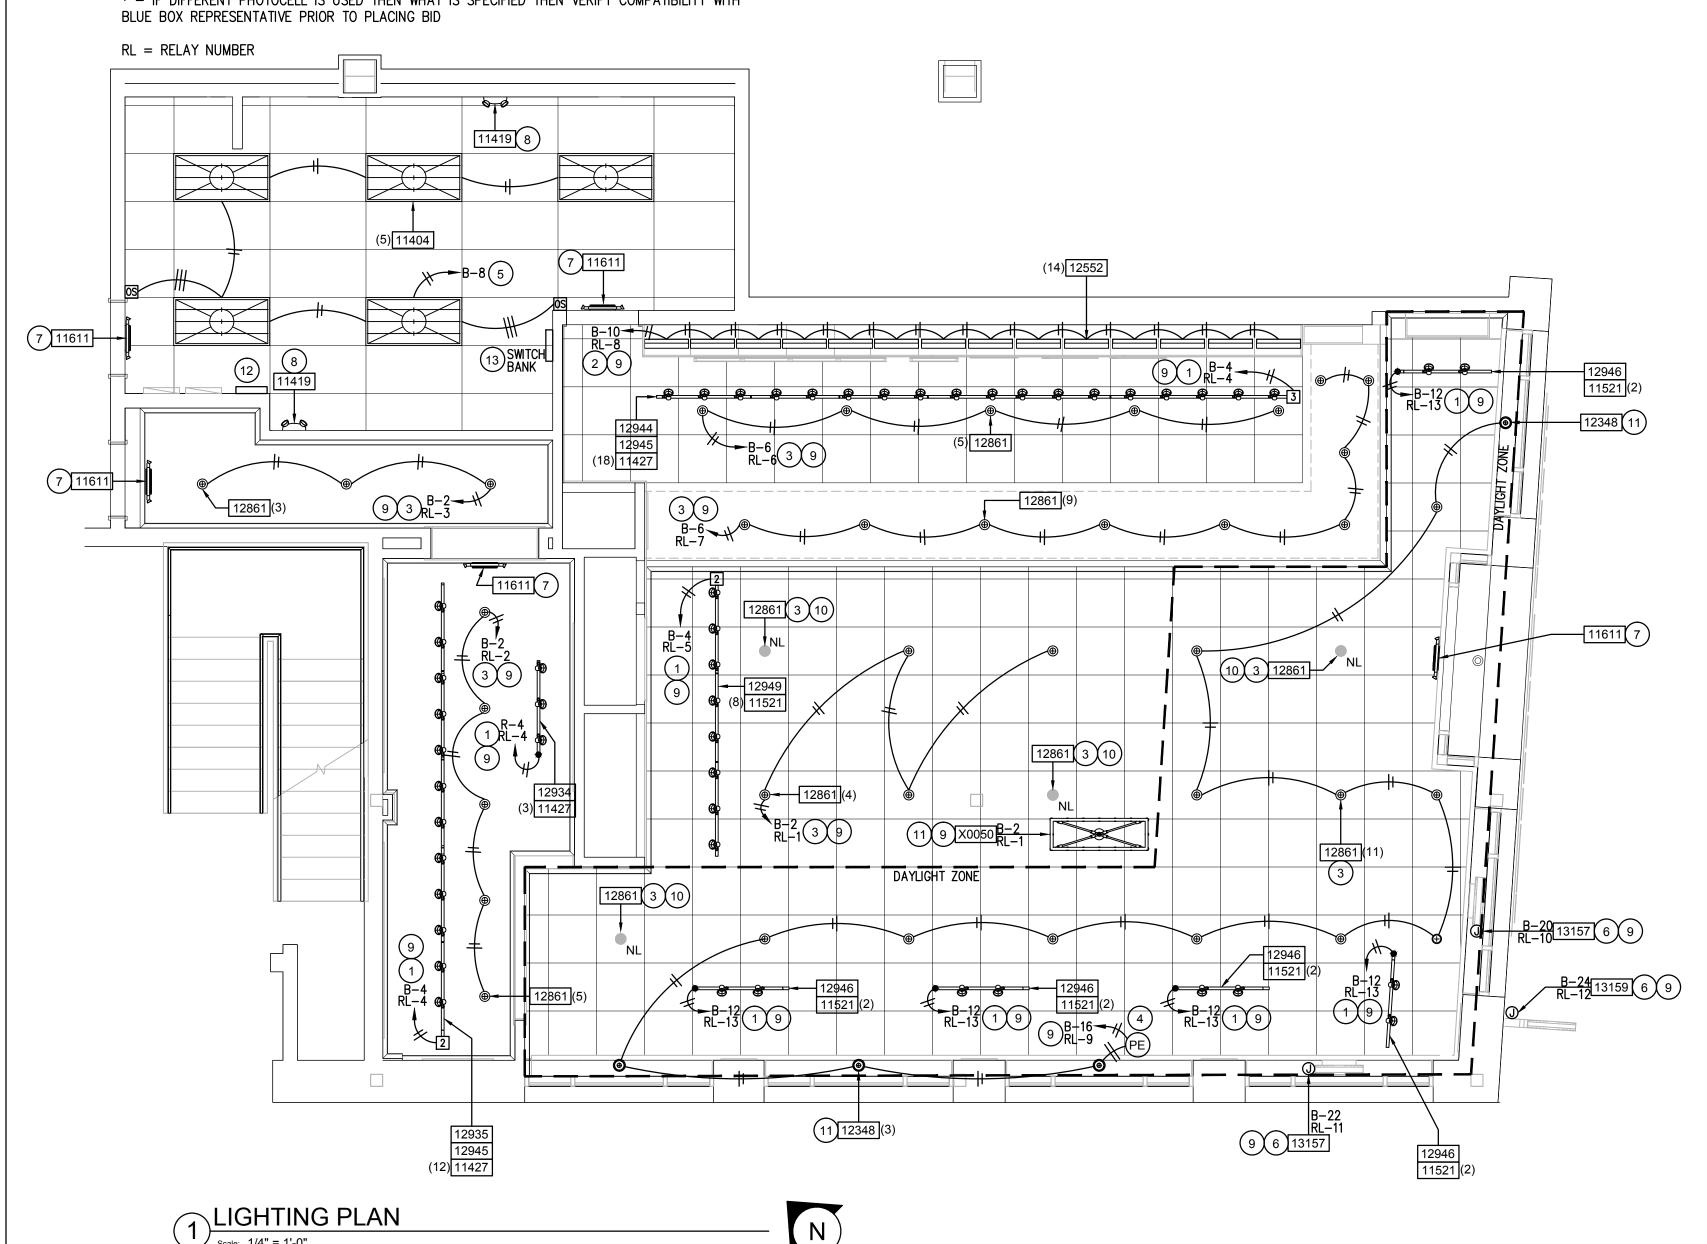

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COMPANY
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SEATTLE, WASHINGTON 98134
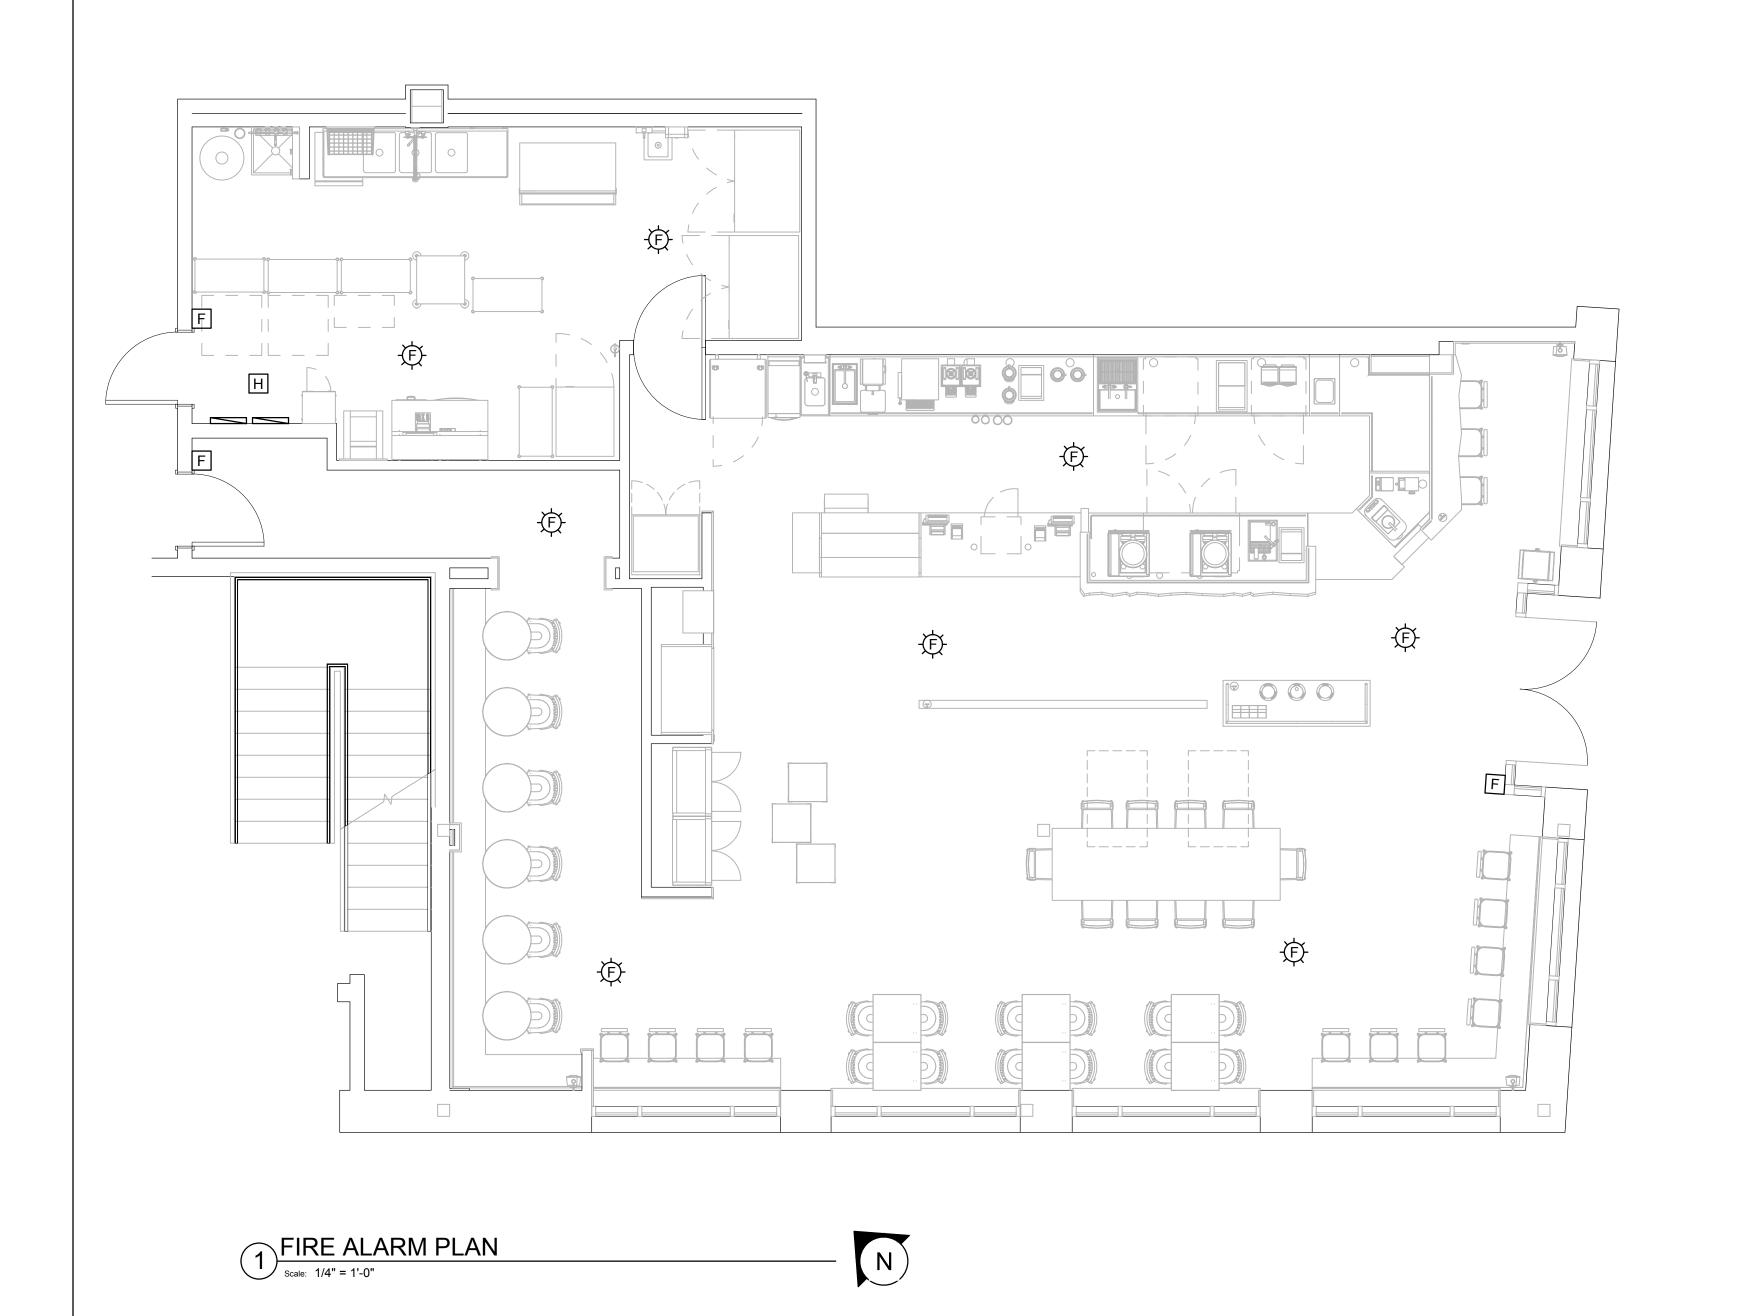
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ARCHITECT OF RECORD

ROBER

ARCHITECTS

PLANNERS

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t 312.424.2400 | f 312.424.2424 | www.norr.com



PROJECT NAME:

COMMERCIAL STREET
PROJECT ADDRESS:
145 COMMERCIAL STREET
PORTLAND, ME 04101
CUMBERLAND COUNTY

STORE #: 19384 PROJECT #: 58862-001 CONCEPT: MCS PALETTE: HERITAGE ISSUE DATE: JAN. 11, 2013 DESIGN MANAGER: E. ZAKAMAREK LEED®AP: PRODUCTION DESIGNER: NORR ILLINOIS CHECKED BY: JAK / CJS

SHEET TITLE:

Fire Alarm Plan

1/4" = 1'-0"

SHEET NUMBER:

SCALE:

FA-001

H HEAT DETECTOR

F FIRE ALARM PULL STATION

CEILING MOUNTED AUDIO/VISUAL ALARM DEVICE

NOTE: CONTRACTOR TO SUPPLY AND INSTALL ALL DEVICES
AND WIRING. ENTIRE INSTALLATION SHALL BE IN
ACCORDANCE WITH LOCAL JURISDICTION REQUIREMENTS.
VERIFY CONNECTION REQUIREMENTS WITH THE BUILDING
SYSTEM. COORDINATE ANY WORK REQUIRED ON BUILDING
SYSTEM WITH OWNER PRIOR TO WORK.

PIRE ALARM SYSTEM LEGEND

Scale: NTS