GENERAL NOTES:

1. ALL WIRING IN ACCORDANCE WITH NATIONAL ELECTRICAL CODE, INTERNATIONAL BUILDING CODE (IBC), CITY OF PORTLAND REQUIREMENTS, AND MANUFACTURER'S REQUIREMENT & RECOMMENDATIONS.


WIRING NOTES:

- 1. ALL ADDRESSABLE DEVICES MUST BE INSTALLED IN A HEATED LOCATION.
- 2. ADDRESSABLE CONTROL RELAYS (CR or MCR) SHALL SWITCH ONLY 12/24V (AC/DC) @ 2.0 Amps OR LESS. SWITCHED CIRCUITS REQUIRING HIGHER VOLTAGE SHALL USE AN INTERMEDIATE LISTED FOR THE PURPOSE
- 3. ADDRESSABLE LOOP CONSISTS OF (1) 2C #16 TWISTED NON-SHIELDED FROM FACP AT 1ST DEVICE; (1) 2C #16 TWISTED NON-SHIELDED THROUGH REMAINING DEVICES ON CIRCUIT AND RETURN TO FACP. MAINTAIN PROPER SEPARATION BETWEEN FEEDS AND RETURNS.
- 4. STROBE CIRCUITS CONSIST OF 2C #14 FROM FACP TO 1ST DEVICE; 2C #14 THROUGH REMAINING DEVICES ON CIRCUIT AND RETURN TO END AT END OF LINE RESISTOR. MAINTAIN PROPER SEPARATION BETWEEN FEEDS AND RETURNS.

LEGEND:

RISER DIAG SYM	NFPA SYMBOL	* DESCRIPTION	CATALOG #
FACP	FACP	Silent Knight Fire Alarm Control Panel	existing
F	Р	Manual Pull Station	SK-PULL
СМ	AOM	Addressable Control Relay	SK-RELAY
	X #	Horn/Strobe Unit (White Ceiling Mount) # Indicates Candela Setting	PC2WL
Ø#	Ø #	Strobe Unit (White Ceiling Mount) # Indicates Candela Setting	SCWL
MB		Radio Master Box	AES 7788
MM	AIM	Addressable Monitor Module	SK-MONITOR

* NFPA 170 (2009) Tables: 6.5, 6.7.1, 6.7.2, & 6.7.3 (Some symbols may not appear on drawing)

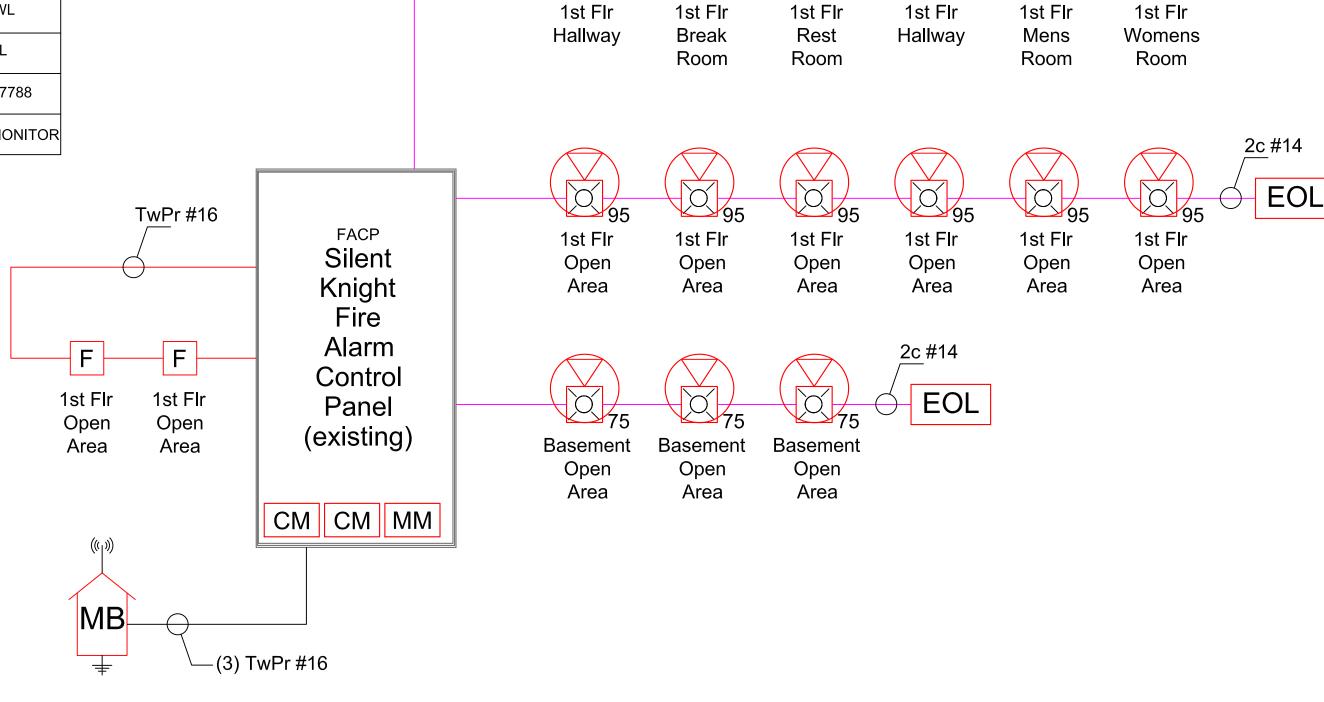

West Elm 164 Middle Street Porland, Maine Fire Alarm Riser Diagram

R.B. Allen
Co., Inc.
P.O. BOX 770
131 LAFAYETTE RD
NO. HAMMPTON, NH 0382
1-800-258-7284

West Elm 164 Middle Street Portland, Maine FIRE ALARM RISER DIAGRAM

2c #14

EOL

15

15

 SCALE: NTS

 0 Original Issue
 5/17 KMB TR

 REV. DESCRIPTION
 DATE DRWN: RV

PO No. 00541
West Elm
164 Middle St
Portland, Maine
FIRE ALARM RISER
DWG NO. FA-101_RSR