




1 Demolition Detail
1-1/2" = 1'-0"

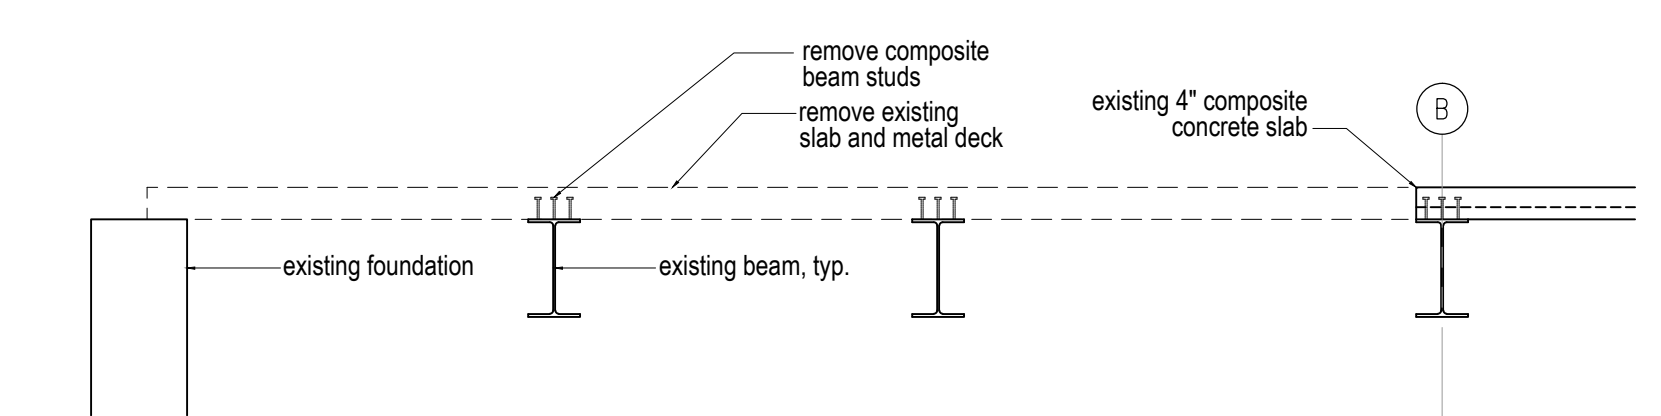

2 Demolition Detail section
Scale: 1/2" = 1'-0"

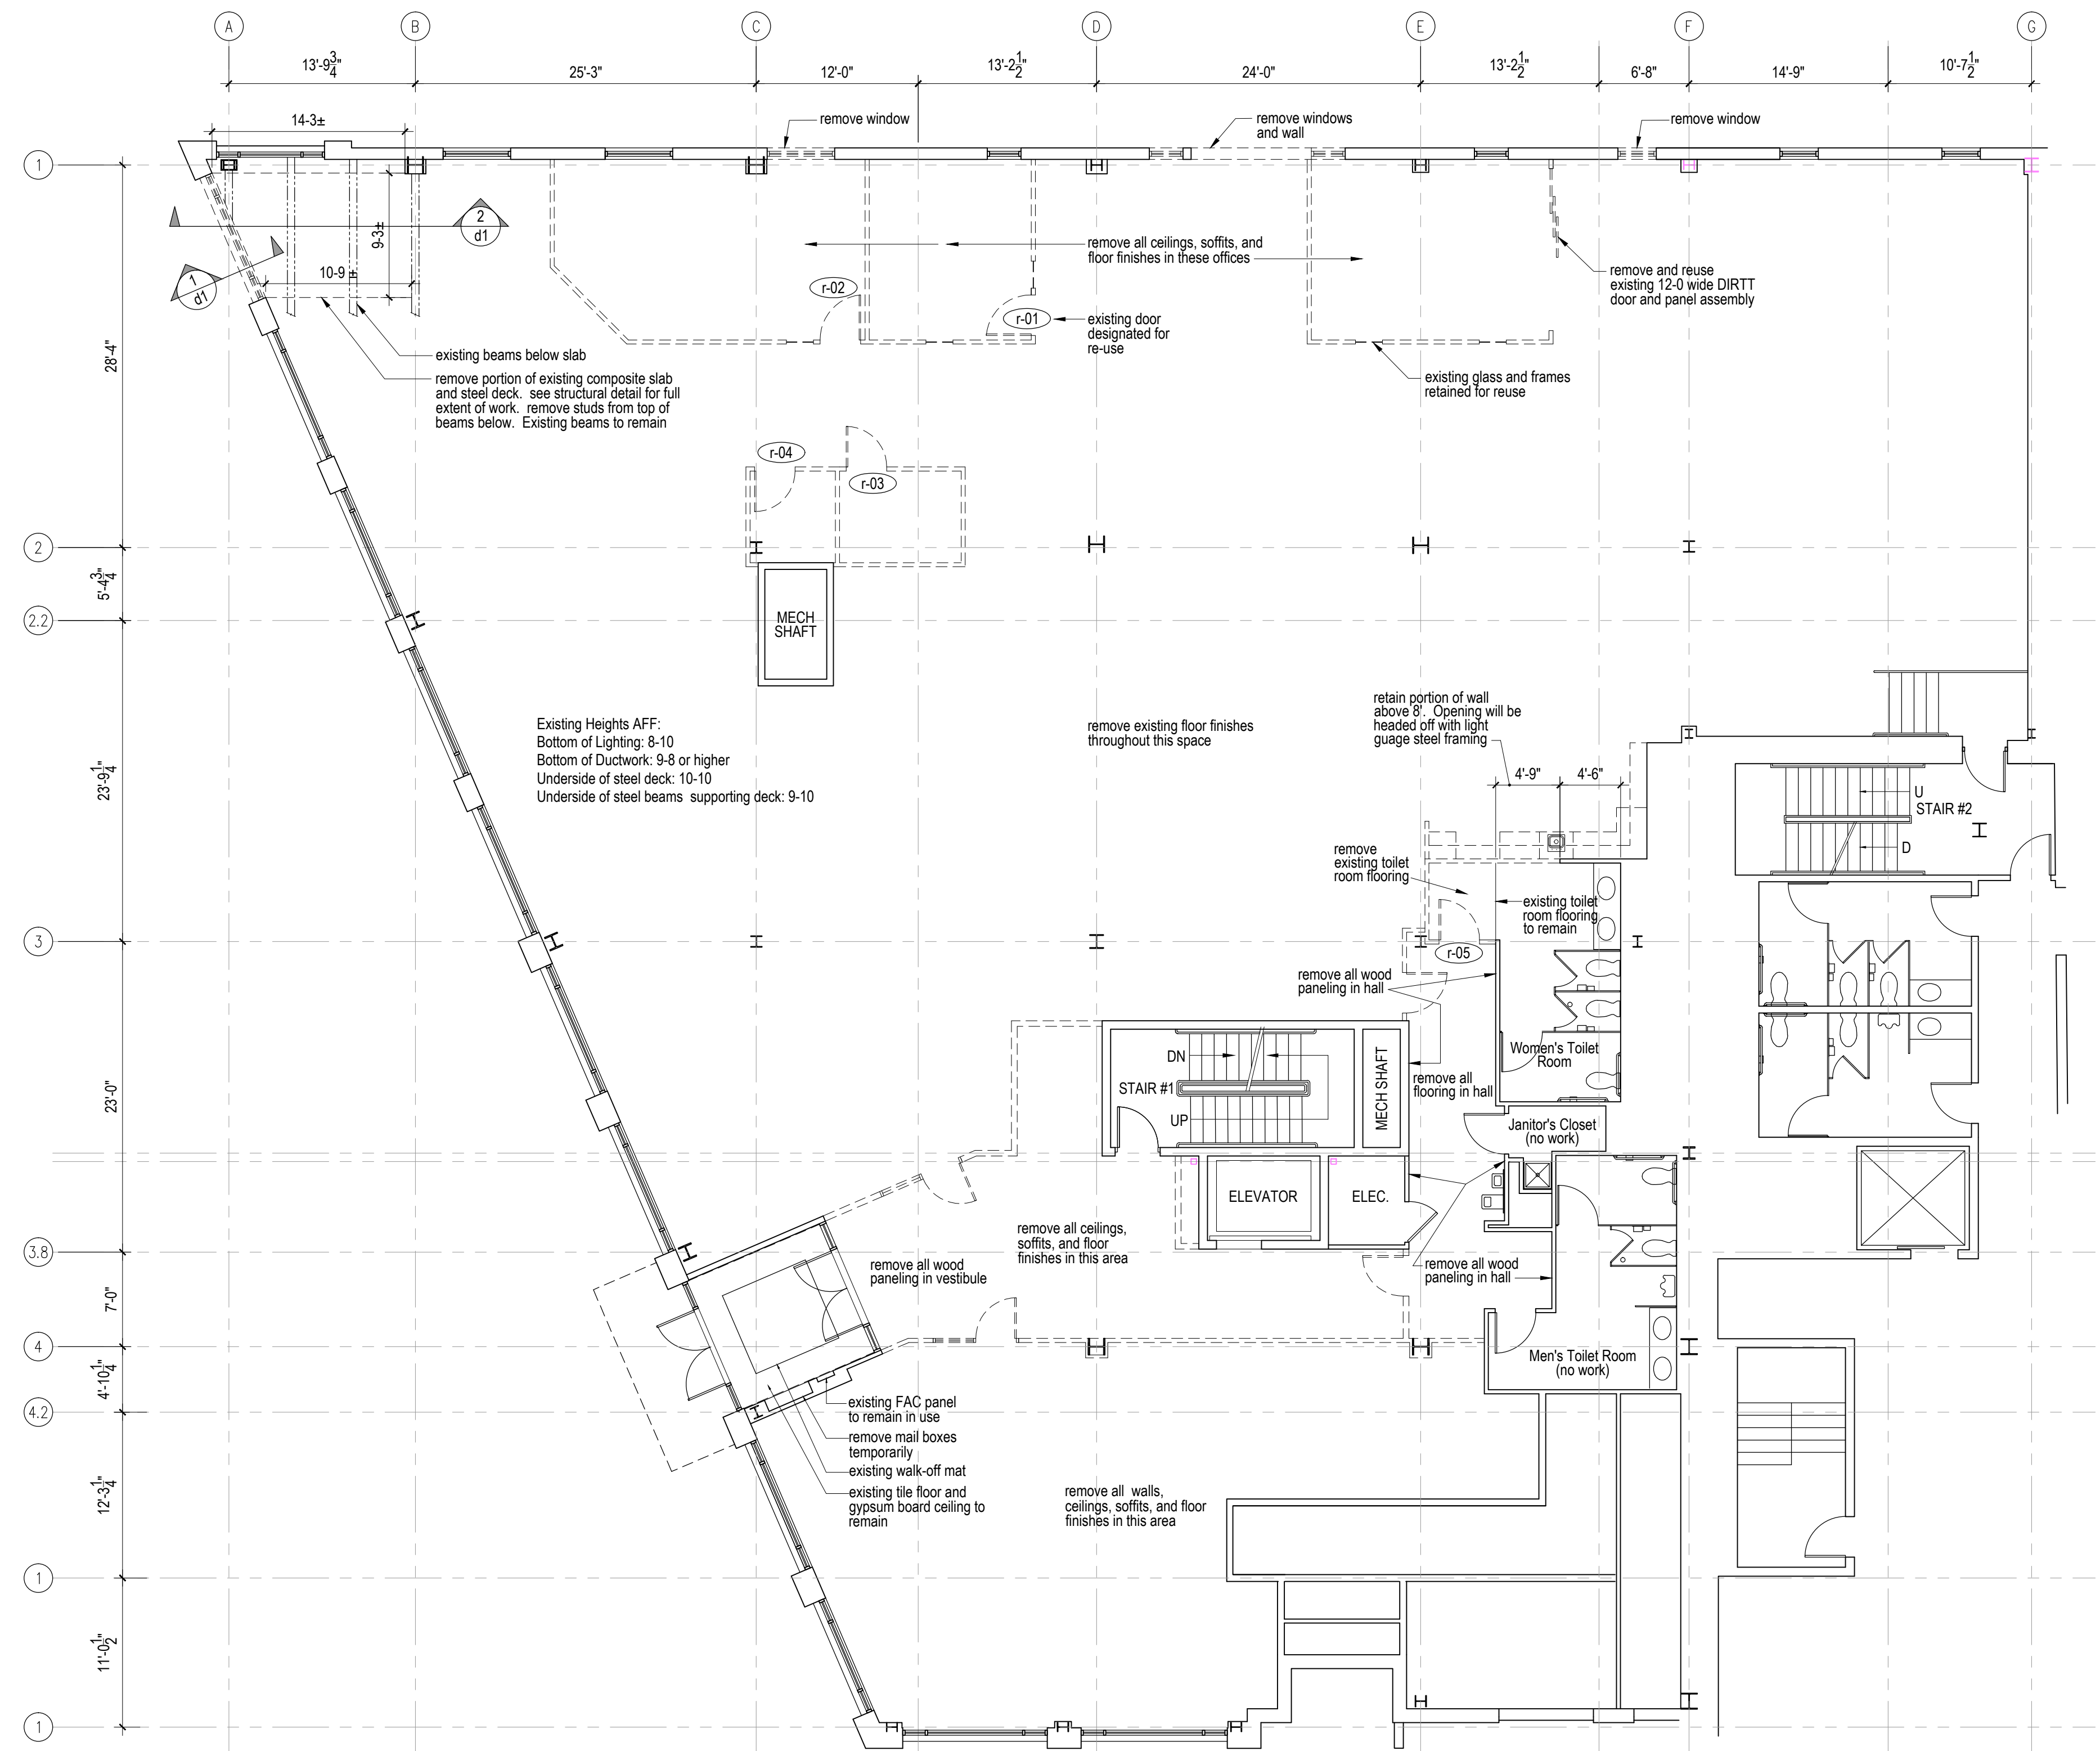


1st Floor Demolition Plan
Scale: 1/8" = 1'-0"

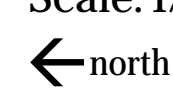

Demolition Notes

- Submittals**
1. Provide owner with demolition schedule that minimize disturbances and interruptions to the owner's onsite operations. The schedule shall indicate interruptions of utility services, use and protection of elevator and stairs, locations of partitions for dust and noise control, and path of waste removal from building
- Quality**
2. Comply with applicable EPA notification regulation before starting selective demolition. Comply with ANSI A10.6 Safety Requirements for Demolition Operations, and NFPA 241: Standard for Safeguarding Construction, Alteration, and Demolition Operations
- Project Conditions and Requirements**
3. Note that demolition in the basement is shown on the basement floor plan
 4. The owner will occupy areas of the building adjacent to the areas of demolition. Conduct the work in a manner that provides minimal disruption to the owners operations
 5. The demolition plan is intended to be a schematic guide for removing existing assemblies, structures and materials as required for the new work to be installed. It is not intended to be exhaustive in detail. The contractor shall be familiar with the work of the project and remove all items as required by the work
 6. Remove all construction assemblies, materials, finishes, mechanical and electrical items necessary for the completion of the work as depicted on the drawings, specifications, and supplementary instructions. Refer to mechanical and electrical drawings for additional information on demolition of those items.
 7. The removal disposal and associated fees of all demolished items shall be the responsibility of the General Contractor.
 8. All removed items, debris and salvage shall be the property of the General contractor unless noted otherwise in the drawings or by the Owner.
 9. Demolition may uncover existing conditions, structures or assemblies that were not foreseen by the Architect or owner. The contractor shall bring to the attention of the Architect any existing conditions that are discovered that will affect the scope or design of the project
 10. The Contractor shall restore any fire rated assemblies damaged by the demolition process to their required rating
 11. The contractor shall identify any pre-existing damage to fire rated walls, floors, ceilings and columns. The Architect will coordinate with the General Contractor to develop a plan to restore the continuity of rated assemblies
 12. The Contractor shall protect finishes, assemblies and structures not required to be demolished or that are outside the area of work.
 13. The contractor shall control dust, noise and vibration, to protect the
 14. The contractor shall provide shoring and temporary support of existing structural members that the work requires.
 15. materials to be removed and reused, such as light fixtures and other electrical equipment, doors, and plumbing fixtures, shall be stored and protected from damage by ongoing construction activities
 16. Maintain and ensure safe passage of building occupants around and through areas of demolition.
 17. Partition walls shown to be demolished shall be demolished in their entirety, for their full height.
- Hazardous Materials**
18. If the Contractor suspects that hazardous materials such as asbestos containing materials (ACM), lead based paint, polychlorinated biphenyl, (PCB) and petroleum products are present he shall not disturb the material and notify the owner's representative.
 19. Fluorescent lights shall be handled and disposed of properly to prevent the release of mercury vapor

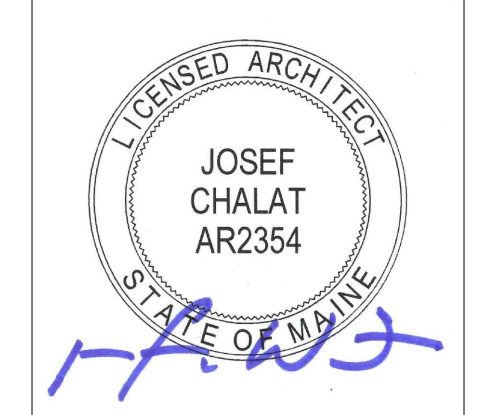

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Project:

CIEE
Council on International Educational Exchange
(Custom House Square Office Building)
Renovations
Basement
1st Floor
2nd Floor
3rd Floor

300 Fore Street, Portland
Maine
CBL: 029 K00601A
Zoning District:
B3 Downtown Business Zone

Owner/Tenant: CIEE
261 Commercial Street
Portland Maine, 04101

Owner/Tenant Contact
Anthony Newton, Facilities Manager
207.632.1825

PC Construction,
Construction Manager
131 Presumpscot Street
Portland, ME 04103
Contact: Jared Ballard
207.874.2323 x106
jballard@pcconstruction.com

Date
10/8/2015
Permit: 1st floor, basement

Sheet Title
1st Floor Demolition Plan

Sheet Number
d1.1