Form # P 04

# DISPLAY THIS CARD ON PRINCIPAL FRONTAGE OF WORK

**CITY OF PORTLAND** 

Please Read Application And Notes, If Any, Attached

PERMIT

rion.

Permit Number: 030112

epting this permit shall comply with all

stures, and of the application on file in

ances of the City of Portland regulating

Olympia Equity Investors Iv /Payton Maine Corp.

This is to certify that

Interior tenant fit-up on the fit is spermission to 85 Commercial St

Olympia Equity Investors Iv /Payton Maine Corp.

Olympia Equity Investors Iv /Payton Maine Corp.

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ne and of the

provided that the person or persons, of the provisions of the Statutes of I the construction, maintenance and u this department.

Apply to Public Works for street line and grade if nature of work requires such information.

N fication inspect in must go and with a permission procuble this leding or the thereof lands or consection.

H. IR NOTICE IS REQUIRED.

of buildings and sa

A certificate of occupancy must be procured by owner before this building or part thereof is occupied.

OTHER REQUIRED APPROVALS

Fire Dept. After Dept.

Appeal Board

Other

Department Name

Director - Building & Inspection Services

PENALTY FOR REMOVING THIS CARD

City of Portland, Maine -	Building or Use	Permit Application	n Permit No:	Issue Date:	CBL:	
389 Congress Street, 04101	Tel: (207) 874-870	3, Fax: (207) 874-87	03-0112		029 K001001	
Location of Construction:	Owner Name:		Owner Address:		Phone:	
85 Commercial St	Olympia Equ	ity Investors Iv Llc	50 Monument Sq 2nd Floor			
Business Name:	Contractor Nam		Contractor Address:		Phone	
Council on International Education	tion Payton Maine	Corp.	75 Market Street I	Portland	2077727222	
Lessee/Buyer's Name	Phone:		Permit Type:	Ortiana	Zone: •	
			Alterations - Com	mercial	20ne.	
Past Use:	Proposed Use:		Permit Fee:	Cost of Work:	Jone Pi de la Companya de la Company	
Vacant office space on 4th floor	] *	with four new office	\$499.00	\$68,000.0	CEO District:	
	spaces on 4th		EIDE DUM	<b>7</b>	00 1 SPECTION:	
•		' ¬(")		Apploved	a 0 - 1	
				Denied	Se Group: Type:	
Proposed Project Description:			_		$\sim 10^{-1}$	
Interior tenant fit-up on 4th) floo	τ		Signature:	uw Sie	gnature UV	
9			PEDESTRIAN ACTIV			
					•	
			Action: Approve	ed Approve	ed w/Conditions Denied	
			Signature:		Date:	
	ate Applied For:		Zoning	Approval		
gg	02/14/2003	<u>.</u>		pprovar		
1. This permit application doe	s not preclude the	Special Zone or Revie	ws Zoning	g Appeal	Historic Preservation	
Applicant(s) from meeting a	applicable State and	Shoreland	☐ Variance		Not in District or Landmari	
Federal Rules.		- '	-145		Not in District of Landman	
2. Building permits do not incl	lude plumbing,	☐ Wetland	Miscellan	eous	Does Not Require Review	
septic or electrical work.	. 0,	Supration			Boes Not Require Review	
3. Building permits are void if	work is not started	☐ Flood Zone Trans	Condition	ial Use	Requires Review	
within six (6) months of the	date of issuance.	ALL LYON 6	9.			
False information may inval	idate a building	Subdivision	Interpreta	tion	Approved	
permit and stop all work						
		Site Plan	Approved		Approved w/Conditions	
		Maj 🙀 Minor 🗌 MM	Denied		Denied Denied	
		01,500			any exterior wi	
	, 	Date:	D b Date:		Any exterior was	
					F1411 - 6 10 MA	
					12000 Alb	
		CERTIFICATION				
hereby certify that I am the owner have been authorized by the owner.	er of record of the name	med property, or that th	e proposed work is a	uthorized by tl	he owner of record and that	
mate boots addition zeed by tile OWI	ici to make uns addi	cation as his authorized	agent and I agree to	conform to all	l applicable lavva of this	
arisalenon. In addition, if a perm	HI TOT WOLK described	I in the application is is	sued. I certify that th	a code official	المستحد والمستحد المستحد المستحدد والمستحدد والمستحدد والمستحد والمستحدد والمستحد والمستحدد والمستحد والمستحد والمستحدد والمستحد والمستحد والمستحد والمستحد والمستحد والمستحد والمستحد وال	
hall have the authority to enter al uch permit.	i areas covered by su	on permit at any reason	able hour to enforce	the provision	of the code(s) applicable to	
•						
SIGNATURE OF APPLICANT		ADDRESS		DATE	PHONE	

RESPONSIBLE PERSON IN CHARGE OF WORK, TITLE

PHONE

DATE

	DEP	T. OI CITY	F BU 'OF	ILD POI	L ING RTL	ING AND	PEC Live	The state of the s
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All Purpose Building Permit Application

If you or the property owner owes real estate or personal property taxes or user charges on any property within

Location/Address of Construction: 7	9-85 Con	MERCIAL St.	3RD F	LOOR
Total Square Footage of Proposed Struc	•	Square Footage of		
Tax Assessor's Chart, Block & Lot Chart# Block# Lot#	Owner: L	ESSOR: RSN 19-85 COMM 4th FLOOR	nercial St.	Telephone:
Lessee/Buyer's Name (If Applicable)  Council on International Emcaronal Exchange	telephone:	PATTON MAINE CO 56 INDUSTRIAL PARKS SACO, ME 04072	er. Wo	st Of rk: \$ <u>68,000</u> : \$ 499.00
I the location is currently vacant, what was approximately how long has it been vacant to the proposed use:  OFFICE SPAN TO	ce (4) NF		w Sill PA	VEC, R, NEW LIGHTIM
contractor's name, address & telephone: The should we contact when the permit alling address:  Payrow Mayo  Sh Industria  e will contact you by phone when the permit when the requirements before starting and a \$100.00 foo if any work starts before	Is ready: 61  VE Co EP.  O 409Z  Dermit is ready  ny work, with a	. You must come in a pign Reviewer. A st	op work or	der will be issued
nd a \$100.00 fee if any work starts before		• •		

This is NOT a permit, you may not commence ANY work until the permit is issued. If you are in a Historic District you may be subject to additional permitting and fees with the Planning Department on the 4th floor of City Hall



#### CITY OF PORTLAND ACCESSIBILITY CERTIFICATE

Designer:	McMahon Architects
Address of Proje	ect 79-85 COMMERCIAL ST. PORTLAND, MA
	t INTERIOR RENOVATION
	THE PROPERTY OF THE PROPERTY O
Date Do f	
(SEAL)	Signature Signature
	Title PRESIDENT
DARCHITCH	Firm McMatton ARCHITECTS
AVID R. MAHON	Address 535 ALBANY STREET
305993	BOSTON, HA 02118
	Telephone /4/7 481 5352



# CITY OF PORTLAND MAINE

389 Congress St., Rm 315 Portland, ME 04101 Tel. - 207-874-8704 Fax - 207-874-8716

TO:

Inspector of Buildings City of Portland, Maine

Planning & Urban Development

Division of Housing & Community Services

	Division of flodsing & Community Bervices
	FROM DESIGNER: McMAHON ARCHITECTS
	535 ALBANY ST. BOSTON, MA 02118
	DATE: 06 FEB 03
	Job Name: CIEE- COUNCIL ON INTERNATIONAL EDUCATIONAL EXCHANGE
	Address of Construction: 79-85 COMMERCIAL ST. PORTLAND, HE
	THE BOCA NATIONAL BUILDING CODE/1999 FourteenthEDITION Construction project was designed according to the building code criteria listed below:
	Building Code and YearUse Group Classification(s)BUSINESS
	Type of ConstructionBldg. HeightBldg. Sq. Footage
-	Seismic ZoneGroup Class
\ \ \ \ \ \ \ \ \ \ \ \ \ \ \ \ \ \ \	Roof Snow Load Per Sq. FtDead Load Per Sq. Ft
•	Basic Wind Speed (mph)Effective Velocity Pressure Per Sq. Ft
ZULDING	Floor Live Load Per Sq. Ft
FIT-OUT	Structure has full sprinkler system? Yes No Alarm System? Yes No Sprinkler & Alarm systems must be installed according to BOCA and NFPA Standards with approval from the Portland Fire Department.
	Is structure being considered unlimited area building: Yes_No
	If mixed use, what subsection of 313 is being considered
	If mixed use, what subsection of 313 is being considered  List Occupant loading for each room or space, designed into this Project.
	(Designers-Stamp & Signature) No. 305993
	PSH 6/07/2K





#### CITY OF PORTLAND BUILDING CODE CERTIFICATE 389 Congress St., Rm 315 Portland, ME 04101

TO:	Inspector of Buildings City of Portland, Maine Department of Planning & Urban Development Division of Housing & Community Service
FROM:	PAYTON MAINE LORP.
RE:	Certificate of Design
DATE:	2/10/03
79 Po	nd/or specifications covering construction work on:  -85 COMMERCIAL STREET SED FLOOR  ETIAND, M.E
architect/engine	signed and drawn up by the undersigned, a Maine registered neer according to the BOCA National Building Code/1999 Fourteenth local amendments.  Signature The Code of the BOCA National Building Code/1999 Fourteenth local amendments.
(SEAL)	McMAHON No. 305993  Title CAREST DENT  McMAHON ARCHITECTS
As per Maine	Address 535 ALBANY STREET  BOSTON, MA 02118

\$50,000.00 or more in new construction, repair, expansion, addition, or modification for Building or Structures, shall be prepared by a registered design Professional.

PSH 6/20/2k



Monday, February 10, 2003

ATTN: PERMITTING DIVISION

RE: General

Document Number GEN-0001

CIEE - Portland, ME

The attached building permit application is for the office fit out for the 3rd floor of 79-85 Commercial Street. The access to the space is from the new entrance on Custom House Way. The scope of work includes adding a conference room, copy room, one office, and expanding an existing IT room. New lighting and office furniture will be installed. A couple of sprinkler heads will be relocated to facilitate the construction of new walls; coverage will be maintained. HVAC scope is minimal and includes the addition of one VAV to provide an extra zone of heating/cooling. The 4th floor tenant RSN will be subletting the space to Council on International Educational Exchange.

Enclosed for review is a full set of stamped drawings along with a reduced set. Any questions regarding the construction should be directed to Geoff Mitchell at 772-7222.

Respectfully,

Geoff Mitchell Project Manager





#### **OLYMPIA** EQUITY INVESTORS

February 11, 2003

Mr. Geoff Mitchell Payton Maine Corp. 56 Industrial Park Road Saco, ME 04072

50 Monument Square Floor 2 Portland, ME 04101

ww.olymplaequity.com

RE: Olympia Equity Investors IV, LLC

Dear Geoff:

We are in receipt of one set of architectural plans, issued for permit, dated 2-07-03 and prepared by MaMahon Architects Inc., which arrived this afternoon, for my review and approval.

We have reviewed the proposed plans and authorize the work as specifically detailed in the above noted documents. Please be advised that any revisions in plans or specifications should be again reviewed and approved by Olympia Equity Investors IV, LLC (Owner) as may be required during the build out of the third floor.

Thank you,


James H. Brady

James H. Brody

Olympia Management Corp, managing member for Olympia Equity Investors IV, LLC

CC: McMahon Architects Inc. - Jennifer Peters Resort Sports Network - Jeff Dumais

# CIEE

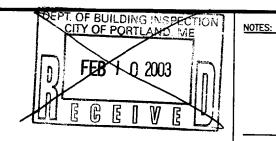





# 79-85 COMMERCIAL ST. 3RD FLOOR PORTLAND, ME

# SITE PLAN


79-85 Commercial St. Portland, ME

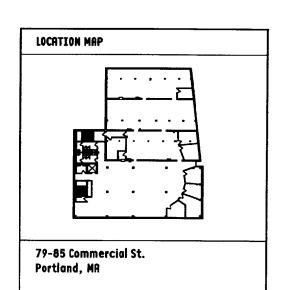

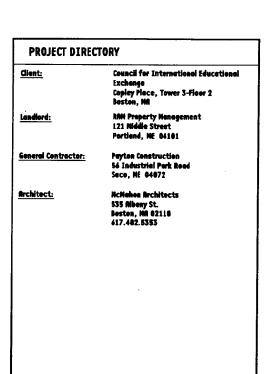

	TITLE	MITE	Т	ISSUE
	R PERMIT	07 FEB 03		Issue A
				Issue B
-				Issue C
-				Issue D
T1	Title Sheet		A	
86.1	Schedules and General Note			
RO.2	Specifications	•	"	
R0.3	Specifications		A	
D1	Demolition - Keynote Plan		A	
<b>D2</b>	Demolition - Reflected Ceili	ng Plan	A	
<b>A1</b>	New Construction - Keynote	Plen	A	
M2	New Construction - Dimension		"     A	+
R3	New Construction - Reflects		A	<del>     </del>
R4	New Construction - Power P	len	A .	
A5	New Construction - Equipme	New Construction - Equipment Plan		
R6	New Construction - Elevation	<u> </u>		
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#### €ODE SUMMARY

BUILDING CODE: 1984 BOCA

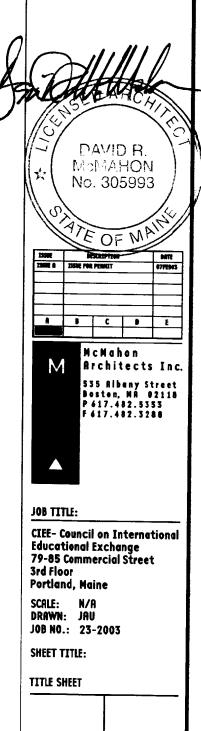ELECTRICAL CODE 1999 NATIONAL ELECTRICAL CODE MECHANICAL CODE-

PLUMBING CODE: HANDICAP CODE:


MAINE HUMAN RIGHTS ACT/ AMERICANS WITH DISABILITIES ACT

CONSTRUCTION TYPE:

#### GENERAL NOTES - NEW WORK

1. THE GENERAL CONTRACTOR SHALL VERIFY THE LOCATION AND LAYOUT OF ALL EXISTING COLLIMAS OR STRUCTURES THAT PROTRIDE INTO THE AFFECTED SPACE PRIOR TO THE START OF NEW MORK ACTIVITIES. A FIELD SKETCH SHALL BE SUBMITTED TO THE ARCHITECT MANUFACTURES AND PRIOR TO ORDERING. OR INSTALLING NEW WORK.

- ALL DIMENSIONS INDICATED ARE TO FINISHED FACE OF PARTITIONS, CEILINGS AND SOFFITS INLESS OTHERWISE NOTED. THE GENERAL CONTRACTOR SHALL IMMEDIATELY NOTIFY MCMAHON RICHITECTS OF ANY DIMENSION DISCREPANCIES.
- DO NOT SCALE THESE DOCUMENTS. THE PRINTING PROCESS WILL DISTORT SCALE.
- THE GENERAL CONTRACTOR SHALL BE RESPONSIBLE FOR COORDINATING THE INSTALLATION OF ALL OWNER SUPPUED MATERIALS WITH THE MANUFACTURER AND OR BUILDING MANAGEMENT. REFER TO THE "RESPONSIBILITY SCHEDULE" FOR BREAKDOWN OF RESPONSIBILITY.
- ALL HVAC BALANCING SHALL BE DONE BY A CERTIFIED BALANCING CONTRACTOR
- ALL ELECTRICAL WIRING SHALL BE DONE BY LICENSED ELECTRICIAN. THIS SHALL INCLUDE, BUT NOT BE LIMITED TO, ALL 24 VOLT CONTROL WIRING. COORDINATE WITH ENGINEFRING.

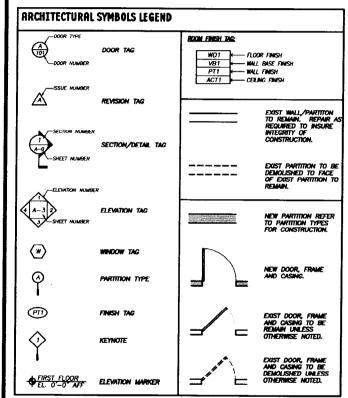

#### TELEPHONE AND DATA SPECIFICATIONS

1. ALL MATERIALS AND INSTALLATION WILL MEET OR EXCEED NATIONAL ELECTRICAL CODE STANDAROS AND ALL OTHER FEDERAL, STATE, COUNTY AND CITY CODES THAT APPLY. IN ADDITION, ALL MATERIALS AND INSTALLATION WILL MEET OR EXCEED STANDARDS AND PROCEDURES SPECIFIED BY THE BUILDING MANAGEMENT AND WILL MEET OR EXCEED ELYTIA 568, EIA/TIA/TSB 40 AND TSB-67 CATEGORY 5 COMMUNICATIONS STANDARDS.

VISIBLE CHECKS FOR WORKMANSHIP WILL BE PERFORMED, AND ALL CONNECTIONS WILL BESTED FOR SHORTS, OPENS, CORRECT POLARTY, CORRECT PAIR ORDER AND CONTINUITY USING A 100 MBP LAN CABLE TESTER. IF DAMAGED CABLE INSULATION IS SUSPECTED A TEST FOR HIGH IMPEDANCE BETWEEN PAIRS AND GROUND WILL BE PERFORMED USING AN OHMMETER ON HIGH RESTANCE CRANGE.

EACH LOCATION OF A COMM OUTLET IS DESIGNATED ON THE PLANS. THE TERMS: COMM OUTLET, DATA DROP AND VOICE DROP ARE DEFINED BELOW.

4. A DOUBLE GANGED PLASTER RING WITH A PULL STRING IS TO BE INSTALLED WHERE A WALL TYPE COMM OUTLET IS SHOWN. A ROUNDED BUSHING IS TO BE INSTALLED IN THE OPENING IN THE WALL TOP TRACK WHERE THE WIRES ARE TO BE PULLED.

5. ALL CABLES MUST BE ROUTED SO THAT NO SINGLE CABLE IS LONGER THAN 250 FEET FROM THE COMM ROOM PATCH PANEL TERMINATION TO COMM OUTLET TERMINATION.

7. A "COMM OUTLET" IS A GROUP OF COMM COMPONENTS AT A WALL OR FLOOR LOCATION WHERE THE USER COMMUNICATION DEVICES, SUCH AS A COMPUTER, PHONE, PRINTER, FAX OR COMBINATION, IS CONNECTED TO OFFICE COMMUNICATION SERVICES. EACH COMM OUTLET IS A COMBINATION OF "DATA DROPS" AND/OR "VOICE DROPS." A COMM OUTLET SYMBOL IS USED ON THE PLANS TO DESIGNATE HE REQUIRED LOCATION OF THE COMM OUTLET. A COMM OUTLET THE PROJURED NUMBER AND COMBINATION OF "DATA DROPS" AND "VOICE DROPS" FOR A PARTICULAR COMM OUTLET. FOR EXAMPLE: A "2D/1V" NOTED WITH THE COMM OUTLET SYMBOL INDICATES A COMM OUTLET REQUIRING 2 "DATA DROPS" AND I "VOICE DROP." REFER TO DETAIL FOR WALL TYPE COMM OUTLET LAYOUT AND FOR FLOOR MONUMENT TYPE COMM OUTLET.

#### GENERAL CONDITIONS

THE WORK TO BE PERFORMED UNDER THIS CONTRACT SHALL BE DONE IN STRICT SCORDANCE W/ THE RULES & REGULATIONS OF THE BUILDING MANAGEMENT OFFICE & ALL PRICABLE STATE, LOCAL & FEDERAL CODES & REGULATIONS. REFER TO THE PROPERTY WIGGENERY CONSTRUCTION RULES & REGULATIONS FOR ADDITIONAL INFORMATION.

THE GENERAL CONTRACTOR SHALL DIRECT ALL CORRESPONDENCE REGARDING THIS PROJECT MICHAELON ARCHITECTS. MICHAELON ARCHITECTS WILL COORDINATE THE DISPERSION OF ALL ORMATION TO THE APPLICABLE PARTIES INCLUDING THE OWNER AND PROPERTY MANAGEMENT.

UNLESS OTHERWISE SPECIFICALLY NOTED IN THE RESPONSIBILITY SCHEDULE, THE GENERAL CONTRACTOR SHALL BE RESPONSIBLE FOR THE COMPLETE SCOPE OF MATERIALS AND LABOR AS REQUIRED TO COMPLETE THE CONSTRUCTION AS INDICATED IN THE CONSTRUCTION DOCUMENTS.

4. THE GENERAL CONTRACTOR SHALL BE RESPONSIBLE FOR THE STRICT ADHERENCE TO THE PROJECT SCHEDULE AS PROVIDED IN THE CONSTRUCTION DOCUMENT PACKAGE. THIS INCLUDES THE RESPONSIBILITY FOR ALL COSTS ASSOCIATED WITH OVERTIME THAT MAY BE REQUIRED TO COMPLETE THE PROJECT ON SCHEDULE. THE SCHEDULE MAY ONLY BE ALTERED WITH WRITTEN APPROVAL FROM THE OWNER.

5. ANY DISCREPANCIES, ERRORS OR OMISSIONS DISCOVERED IN THE CONSTRUCTION DOCUMENT PACKAGE SHALL BE IMMEDIATELY BROUGHT TO THE ATTENTION OF MAMAHON ARCHITECTS PRIOR TO PROCEEDING WITH RELATED WORK. MOMENION ARCHITECTS WILL PROVIDE THE CONTRACTOR WITH A FILED CLARIFICATION OR CHAMGE ORDER TO ADDRESS THE ISSUE AS WELL AS MAKING ANY NECESSARY CHANGES TO THE PROJECT SCHEDULE.

6. THE GENERAL CONTRACTOR SHALL BE RESPONSIBLE FOR RECEIVING ALL MATERIALS PROVIDED BY OUTSIDE VENDORS TO THE JOB SITE. ALL DELIVERIES SHALL BE INSPECTED TO CONFIRM THE ACCURACY AND GENERAL CONDITIONS OF THE DELIVERY. ALL DELIVERY SLIPS ARE TO BE COPIED AND PROVIDED TO THE ARCHITECT AND TENANT LIPON RECEIPT. ANY DISCREPANCIES SHALL BE BROUGHT TO THE IMMEDIATE ATTENTION OF THE ARCHITECT.

7. THERE WILL BE NO SUBSTITUTION OF MATERIALS OR ALTERATION OF SCOPE UNLESS FIRST APPROVED BY THE ARCHITECT. THE GENERAL CONTRACTOR SHALL NOT PROCEED WITH ANY CHANGES NOT DOCUMENTED BY A WRITTEN FIELD CLARIFICATION OR CHANGE ORDER. ANY VARIANCE FROM THE CONSTRUCTION DOCUMENT SET WILL BE RECTIFIED AT THE DISCRETION OF THE OWNER AND COST OF THE GENERAL CONTRACTOR.

8. THE GENERAL CONTRACTOR SHALL COORDINATE ALL CONSTRUCTION PERMITS WITH THE OWNERS REPRESENTATIVE. THE GENERAL CONTRACTOR SHALL BE RESPONSIBLE FOR ALL ADDITIONAL SUB-CONTRACTOR PERMITS AND FEES AS REQUIRED TO MEET THE REQUIREMENTS OF THE BUILDING DEPARTMENT.

#### GENERAL NOTES - FIRE PROTECTION

1. ALL WORK ASSOCIATED WITH THE TENANT FIRE PROTECTION SYSTEM SHALL BE DONE BY A FIRE PROTECTION CONTRACTOR APPROVED BY THE PROPERTY MANAGER.

2. THE SCOPE OF WORK FOR THIS PROJECT INVOLVES THE RENOVATION OF AN EXISTING OFFICE SPACE. THERE WILL BE NO NEW SPRINKLER HEADS ADDED TO THE SPACE. EXISTING HEADS WILL BE REPLACED AND RELOCATED TO PROVIDE THE REQUIRED COVERAGE. REFER TO ENGINEERING DRAWINGS FOR FINAL SPRINKLER LAYOUT.

3. PROVIDE FIRE STOPPING AROUND ALL MECHANICAL SYSTEM PIPES, DUCTS, RACEWAYS AND CABLES PENETRATING SMOKE AND FIRE RATED BARRIERS.

 Installation of fire stopping shall be performed by an applicator/installer qualified and trained by the manufacturer. Installation shall be performed in STRICT ACCORDANCE WITH THE MANUFACTURER'S DETAILED INSTALLATION PROCEDURES.

5. COORDINATE WITH THE MECHANICAL, ELECTRICAL AND ALL OTHER TRACES TO ASSURE THAT ALL PIPE. CONDUIT, CABLE, DUCTS AND OTHER TRENS WHICH PENETRATE SMOKE AND FIRE-FRAILED CONSTRUCTION HAVE BEEN PERMANENTLY INSTALLED PRIOR TO INSTALLATION OF FIRESTOPS. SCHEDULE AND SEQUENCE THE WORK TO ASSURE THAT PARTITIONS AND OTHER CONSTRUCTION WHICH WOULD CONCEAL PENETRATIONS ARE NOT ERECTED PRIOR TO THE INSTALLATION OF FIRESTOPS.

i. Fire stop shall be sti specseal s100 or specseal putty. Refer to engineering Brawnings for details.

#### TELE. AND DATA FACE PLATE - NOT APPLICABLE FOR THIS LOCATION

1. FOR WALL TYPE OUTLETS: EACH "VOICE DROP" CALLED FOR CONSISTS OF TWO "VOICE JACKS" IN THE COMM OUTLET CONNECTED BY A SINGLE "VOICE DROP" CABLE TO A USER DESIGNATED PUNCH BLOCKS IN THE COMM ROOM. TERMINATE THE ONCE VOICE DROP CABLE IN A SOLIT PUBLIC CONNECTED TO THE COMM PAGE OF THE COMM PAGE A SPLIT PAIR CONFIGURATION IN THE COMM OUTLET.

COMMUNICATION COMPONENTS: (ITEM QUANTITY AS REQUIRED TO SUPPORT THE QUANTITY OF COMM QUILLETS UNLESS NOTED OTHERMISE IN THE ITEM DESCRIPTION. COMM CONTRACTOR TO SUPPLY, NO SUBSTITUTIONS ALLOWED UNLESS PREVIOUSLY APPROVED.

A. WALL OUTLET = 6-POSITION DOUBLE GANGED FACE PLATE (OFFICE WHITE)

DATA JACK = 8-POSITION, CATEGURY 5 (1568B) (OFFICE WHITE)
 VOICE JACK = 6-POSITON, CATEGORY 3 (USOC, RJ-25) (TELCO IVORY)
 SNAP IN CONNECTORS = (BLANKS) (OFFICE WHITE)


E. DATA DROP CABLE: UTP CATEGORY LEVEL 5 (+). 24 AWG, 4 PAIR PLENUM RATED
CABLE, BLUE IN COLOR.
F. VOICE DROP CABLE: UTP CATEGORY LEVEL 5 (+). 24 AWG, 4 PAIR PLENUM RATED
CABLE, YELLOW IN COLOR.

			ROOM NUMBER FROM PL COMM OUTLET WITHIN S ROOM, SEQUENTIAL AND
FACE PLATE LABEL	- m-b		CLOCKWISE AROUND ROO
CONNECTOR INSERT POSITION 1. (1ST DATA DROP)	1	[2]	CONNECTOR INSERT POSITION 2. (2ND DATA DROP)
CONNECTOR INSERT POSITION 3. (3RD DATA DROP OR BLANK)		4	CONNECTOR INSERT  POSITION 4. (4TH DATA DROP OR BLANK)
CONNECTOR INSERT POSITION 5. (5TH DATA, IST VOICE OR BLANK)	[5]	6	CONNECTOR INSERT  POSITION 6. (6TH DATA, 2ND VOICE OR BLANK)

	SCHEDULE OF RESPONSIBILITY											
	лы	TE	INST	PURM	.C.	SLDG. NA	MAGEMENT	FIRM	WER INST	DOIST	IV8	ROTES
	DIVISION 1 - GENERAL CONDITIONS				2001	1000	LASI	-	1831			
_	00700 GENERAL CONDITIONS 01010 SUMMARY OF WORK		<del> </del>	•	•					<u> </u>	•	
:T F.	01030 ALTERNATES 01045 CUTTING AND PATCHING										•	
	01060 REGULATORY REQUIREMENTS			•	•							MISC. FLOOR PATCHING, PATCHING AT ALL EXISTING FLOOR PENETRATIONS PERMIT TO BE APPLIED AND PAID FOR BY THE GENERAL CONTRACTOR
s	01300 SUBMITTALS 01500 TEMPORARY FACILITIES AND CONTROLS			•	•							ELECTRICAL EQUIP, MECHANICAL AND FIRE PROTECTION
'	TEMPORARY LIGHTING     TEMPORARY UTILITIES (MECH/ELEC)			•	•							AS REQUIRED TO MAINTAIN SAFE WORKING ENVIRONMENT
s	TEMPORARY BARRICADES			•	•					<u> </u>		AS REQUIRED TO MAINTAIN SAFE WORKING ENVIRONMENT AS REQUIRED TO MAINTAIN SAFE WORKING ENVIRONMENT
<b>'</b>	TEMPORARY PHONE/FAX     O1700 PROJECT CLOSEOUT			•	•							SITE PHONE AND FAX ARE REQUIRED
ır	01710 CLEAN-UP			•	•							CLIENT TO PERFORM FINAL REVIEW GENERAL CONTRACTOR IS TO PERFORM FINAL CLEANING
•	DIVISION 2 - SITE WORK		<b></b> -									
	02070 SELECTIVE DEMOLITION  • DEMOLITION											
	DUMPSTERS			•	•							DEMO ALL EXISTING ABANDONED WALLS, HVAC, ELEC. REMOVAL OF MATERIALS IS TO BE COORDINATED WITH BUILDING MANAGEMENT
	DIVISION 3 - CONCRETE											
ı	00300 CONCRETE										•	
	DEVESTOR 4 - MASONRY		<u> </u>									
	00400 MASONRY			•	•							
ı	PEVESION 6 - METRIS											
Į	05500 MISCELLANEOUS METALS 05800 EXPANSION JOINTS			•	•						•	
ı												
	91VISION 6 - CHAPENTRY  06100 ROUGH CARPENTRY			•	•							
$\neg$	06200 FINISH CARPENTRY			•	•							
ı	DIVISION 7 - THERMAL AND MOISTURE PROTECTION						-					
	07100 WATERPROOFING D7200 INSULATION	]		•	•							
١	07250 FIRE STOPPING		-	•	•							REPAIR OR REPLACE ANY EXISTING MISSING OR DAMAGED FIRE INSULATION REPAIR OR REPLACE ANY EXISTING MISSING OR DAMAGED FIRE STOPPING
-	07900 JOINT SEALANT			•	•							
ŀ	PIYESIAN 8 - POORS AND WINDOWS											
I	08100 METAL DOORS AND FRAMES 08200 WOOD DOORS AND FRAMES			•	•							REFER TO SCHEDULE DRAWING A-1 REFER TO SCHEDULE DRAWING A-1
ı	08300 SPECIAL DOORS 08352 ACCESS PANELS			•	•							
ľ	08700 FINISH HARDWARE			•	•							GC TO PROVIDE AND INSTALL ALL REQUIRED DOOR HARDWARE
	08800 GLAZING 08900 GLAZED CURTAIN WALLS			•	•						•	
- [												
-	DIVISION 9 - PINISMES  09110 LIGHT GAUGE METAL FRAMING			•	•					-		3 5/8 METAL STUD FRAMING
-	09120 CEILING SUSPENSION SYSTEMS 09250 GYPSUM DRYWALL			•	•							
ı	09500 WALL COVERING										•	5/8" GWB — REFER TO DETAILS DRAWING A-9
- 1	09510 ACOUSTICAL CEILING SYSTEM 09600 FLOORING										•	
- 1	• VCT			•	•							
	• TILE 09900 PAINTING			•	•	-						
١	OTVISION 10 - SPECIALTIES											
- 1	10000 GRAPHICS			•	•							TBO, PROVIDE \$750 ALLOWANCE
ļ	10440 SIGNAGE 10520 FIRE EXTINGUISHERS		-+	•	•	•	•					CORRIDOR SIGNAGE PROVIDED AND INSTALLED BY PROPERY OWNER
-	10800 TOILET ACCESSORIES										•	
	DIVISION 11 - EQUIPMENT											
J	NOT USED				F							
$\neg$	PIVISION 12 - FUNNISHINGS											
╝	12000 SYSTEMS FURNITURE	•	•				-+					
	DEVISION 15 - SPECIAL CONSTRUCTION  NOT USED											
										-		
1	PIVISION 14 - CONVEYING SYSTEMS  NOT USED											
-												
	DIVISION 18 - NECHNICAL 15000 HVAC SYSTEM			•	•	•	-+					C. TO PROVIDE & INSTALL/COORDINATE REQUIREMENTS W/ BLDG WANAGEMENT.
	15000 SMOKE EXHAUST SYSTEM 15000 SPRINKLER SYSTEM			-	•						•	
1	15000 THERMOSTATS AND CONTROLS			•	•				-+			ELOCATE HEADS AS REQUIRED
	15300 FIRE PROTECTION SYSTEM 15400 PLUMBING SYSTEMS			•	•							
	16000 TEL/DATA CABLING AND COMM OUTLETS	•	•									LL T/D CABLING, TERMINATIONS AND TESTING BY TENMIT
.	18000 EXTERNAL COMM CONNECTION	•	•									TO CHOOM, TERMINATIONS AND TESTING BY TENANT
-	16000 COMM ROOM EQUIPMENT (RACKS, PATCH PANELS HARDWARE)	•	•		-	-+				+	-+	
	16000 PANELS AND TRANSFORMERS 16505 LIGHTING			•	•							
	LOCATION LOCATION			•	•		+			_+		
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			82.33			

ISSUE & ISSUE FOR PERSON

JOB TITLE:

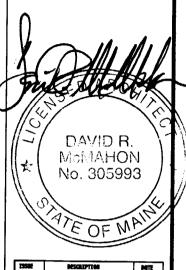CIEE- Council on International Educational Exchange 79-85 Commercial Street 3rd Floor Portland, Maine

SCALE: N/A DRAWN: jau JOB NO.: 23-2003

SHEET TITLE:

SCHEDULES & GENERAL NOTES

A0.1

#### **00700 GENERAL CONDITIONS**

- . General Requirements:
- The Contractor is to give his personal superintendence and direct urnish all transportation, labor, materials, apparatus, scaffolding and the performance meaning of these specifications and plans.
- Permits, Licenses and Liabilities: The Contractor shall give to the proper authorities all stices relating to his work, obtain permits as required and all licenses, carry satisfactory impensation and public liability. Social Security Insurance and properly damage and be liable only occidents from either contracts, his subcontractors, or extra work done under his any occidents from either contracts, his subcontractors, or extra work done under his to the contract of the contracts of the contracts of the contract of t
- 3. Extras: Charges for extra work done by the Contractor will not be honored unless the wand the amount are agreed to by the Tenant (Council for International Educational Euchange) in writing before the work is done, based upon unit pricing. All correspondence including, but not limited to, requests for substitution and change orders must be directed to the Architect for review and distribution.
- . Inspections: As required by code, each Contractor and each Subcontractor shall obtain equired inspection of that portion of work.
- i. Release of Liens: The Contractor shall provide Contractor's affidavit of payment of Debts in Odinis in form of Release of Liens Affidavit with each requisition representing with Contractor's Company, Malerial Suppliers and Subcontractors along with Affidavits of Warranty.
- 6. Insurance and Identification: The Contractor and all Sub-Contractors shall provide as a minimum, the insurance coverage's described below and shall deliver to the Client Certificates of Insurance before commencing work. The required Insurance shall be maintained through the work.
- Worker's Compensation with statutory limits, and Employer's Liability Insurance with limits and less than \$100,000.
- b. General liability Insurance with limits of not less than \$1,000,000 combined single limit for bodily injury and property domage, including personal injury, Cantractual Liability coverage specifically endorsed to cover the indemnity provisions contained herein, and Contractor's Protective Liability coverage.
- c. Motor Vehicle Liability Insurance with limits of not less than \$250,000 per person, \$500,000 per occident for bodily injury and \$100,000 for property damage.
- t. These insurance certificates shall name Landlord (Owner) and Tenant (Client) as additiona d. These insurance certificates shall name Landlord (Owner) and Tenant (Client) as additional insureds for the tuti amount of insurance.

  Hold Harmless Agreement: The Contractor agrees to indemnify and hold harmless the Landlord (Property Owner), the Management Company, the Tenant (The Clarks Company) and the Architect (McMahon Architects, Inc.), their agents and employees from and against any and all liability or damage orising from injuries to persons or damage to property occasioned by any act or omission of the Contractor, his Sub-Contractors, agents, or employees, including any and all expense, legal or otherwise, which may be incurred in the defense of any claim,

  \*\*Estimated To suit\*\*

#### 01010 GENERAL

- Landlard: PAM Property Management, 121 Middle Street, Portland, ME 04101
  Tenant / Client: Council for International Educational Exchange, Copiey Tower Floor 2,
  ston, MA 02199
  Architect: McMohan Architects Inc., 535 Albany Street, Boston MA 02118
- Building Occupancy: The building in which this project is to be constructed is occupin will remain occupied for the duration of the work. Take all necessary precautions to en the safety of the occupants. Give odequate prior notice to the Landlord and the Tenan to disconnecting or interrupting any building services.
- Coordination with work by others: Coordinate the work of this Contract with work to be performed separately by the Landlord and Tenant in order to facilitate timely completion of entire project.
- Existing Utilities: Do not shut off services to the building or other tenants, including but n imited to HVAC, woter, fire sufety systems, and electrical service, without obtaining prior permission and giving odequate notice to the Landlord and Tenant. Obtain permission from andlord, Tenant and, if necessary, from utility company.
- Applications for Payment: Submit applications monthly on AIA form G702/G703. Provide a supporting documentation including, without limitation, waivers of lien or other evidence that payments to subcontractors and suppliers are current.
- <sup>7</sup>. Contractor is responsible for all patching, painting, and repair of all existing partitions, loors, and ceiling unless otherwise indicated in the specifications or construction docume.

#### 01045 CUTTING AND PATCHING

- Perform cutting, fitting and patching required to complete the Work and make its severa parts fit tagether properly; to uncover partions of the Work to provide for installation of ill—timed work; to remove and replace defective work; to remove and replace work not conforming to requirements of Contract Documents; or to penetrate construction for installa
- 2. Do not cut structural members for any reason.
- 3. Do not damage other work. Leave surfaces in proper condition to receive repairs.
- 4. After uncovering work, inspect existing conditions and immediately report to McMahon Architects. Inc. and the Client, in writing, unsatisfactory or questionable conditions, which may affect the installation of products or the performance of the Work. Do not proceed with the work until McMahon Architects, Inc. has provided further instructions.
- Repair or replace all materials or finishes, whether existing or installed under this c which are damaged by the work of this contract. Each trade or subcontractor shall p repair or replacement of items damaged by that trade.

#### 01060 REGULATORY REQUIREMENTS

- a. Where references are made on Drawings or in Specification to codes, they shall be considered an integral part of Contract Documents as though reproduced therein. Nothing contained in the Contract Documents shall be as construed as to be in conflict with any low, by-law, or regulation of the municipal, State, Federal or other authorities having jurisdiction.
- Perform work in compliance with all State, Local or Federal regulations governing the work of this contract. State Building Code is minimum requirement. Where Specifications and Drawings exceed Code requirements, Specifications and Drawings shall toke precedence.

#### 01300 SUBMITTRIS

- Product data, shop drawings, and samples to be submitted for McMahon Architects, Inc. eview are called out elsewhere in these notes. McMahon Architects, Inc. and the Project ngineer will review required submittals for conformance with the design concept and with their information given in the Contract Documents. NO substitutions shall be allowed with he prior written approval of the Architect and the Owner.
- If the Contractor and Sub-contractors have ideas as to a more cost-effective approach for the construction of any of the parts of this project, that maintain the integrity of the design, they should submit them to McMahon Architects, Inc. and the Client for consideration,
- 3. Notify the Architect and the Client, in writing, at time of submission, of any deviati

#### 01500 TEMPORARY FACILITIES AND CONTROLS

- Enclosure: During construction, enclose the work area with suitable barriers to contain dua and construction debris, and to prevent unauthorized entry. Coordinate temporary barrier with the building management
- Electrical Service and Lighting: Provide temporary distribution circuits and wiring: provide temporary lighting as necessary for construction and adequate to permit McMahon Architects, inc. or The Tenant/Client to judge the quality of the finished work.
- 3. HVAC: If building ventilation system is in operation during construction, provide temporary filters in front of each exhaust register. Replace filters when Works is finished.
- 4. Security: Take responsibility for security of the work area. Lock up the work area at e of each day's work.
- Barricades and signs: Place suitable barricades and post signs as required to direct people around the work area and to warn them of hazards.
- 6. Cleaning: Clean the Work daily to keep the Work, and adjacent areas free from accumulation of waste materials, rubbish and debris resulting from construction operation Comply with applicable codes, ordinances, regulations and anti-pollution laws. Disposal be performed after 8:00 a.m. and before 6:00 p.m. unless otherwise indicated. Coordin disposal with the Landford and the Client.

#### 01630 PRODUCTS

- 1. Furnish only products that are intended and recommended by the manufacturer for use
- 2. For products specified by name and manufacturer, furnish named product, or subwritten request for substitution.
- 3. When proposing a substitution for a named product, provide sufficient information to enal McMahan Architects, Inc. to make a comparison of the proposed product with the product specified. Contractor shall be responsible for all coordination required to integrate the substituted product with the rest of the work, and shall bear any incidental costs (such as additional cutting, patching, fitting, or matching, or modifications to adjacent work) arising fiths archafting.

#### 01700 PROJECT CLOSEOUT

- Substantial Completion
- When Contractor considers work substantially complete, he shall natify the Architect, the
- c. Within five business days of notification of substantial completion, the Client and McMohon Architects. Inc., sholl inspect Work to determine status on completion and submit a punch list reporting any incomplete or unacceptable items to Contractor.
- 2. Inspections: Contractor and Subcontractor(s) shall obtain certificates of inspection including plumbing, mechanical, and electrical and obtain a Certificate of Occupancy.
- 3. Final Inspection:
- . The Client shall inspect Work and report status to Contractor.
- . Re-inspection Fees: Should The Tenant/Client and/or Architect be required to perform s-inspection due to failure of Work to camply with claims af status of completion mode
- Client will deduct amount of such compensation from final payment to Contractor
- . Prior to submitting final application for payment, complete the following:
- . Dismantle and remove temporary facilities from the site, including temporary lighting in th
- c. Assemble in a loose-leaf binder maintenance and operating information for ne and finishes installed, and turn it over to the Client. Include all engineering as-

#### 01710 CLEANING

- Final Cleanina
- . Prior to final cleaning, remove all tools, surplus mo
- b. Remove all traces or splashed material from adjacent surfaces
- . Remove all paint droppings, spots, stains and dirt from finished surfaces

- For surfaces requiring routine application of buffed polish, apply the polish recom-the manufacturer of the material being polished.

#### 02070 SELECTIVE DEMOLITION

- 1. The extent of demolition work is, in general, indicated an the drawings, but not every item to be removed or demolished can be shown. Coordinate demolition with the construction word so that all interference with the new work is removed and so that construction, structure, substrates, etc. which remain are in suitable condition to receive the new work. Contractor will assume the costs for all "unforesseen" conditions if not indicated to McMahon Architects, Inc., the Client and the Building Manager prior to demolition/construction.
- Protect existing moterials and finishes that are to remain from unnecessary damage during demolition. Poy particular attention to protection of window and doorjambs, light fixtures, doors and hardware, bathroom areas, if any, finish floors, furnishings, and areas outside the
- Leave demolition area clean and ready for new construction. Legally dispose of debris a emolished material not scheduled for reuse. (Dump certificates are required to be provided o the Landlord's Agent.)
- Prepare surfaces for installation of new work as follows
- a. Where flooring is removed, remove completely, including adhesives, grinding down if necessary to prepare subfloor for new finish. Fill crocks wider than 1/16 inch.
- b. Pull nails, fasteners and adhesives which remain after removal of installed items. Remalath, strapping and other substructures and supports associated with items to be removed.
- c. Disconnect and remove all existing electrical fixtures, including lighting fixtures, switches, outlets, etc. except those explicitly noted to remain. Remove conduit and all wiring in walls, calling, etc. not required for installation of new work.
- e plumbing piping and cap off at floor, wall surface, or origin, unless it to remain to serve new fixtures or equipment.
- Patch and paint hole left by removal of fixtures, switches, receptocles, and the like the damaged surface is also scheduled for demoliting

#### 05800 METALS - EXPANSION JOINTS

Clean and renovate any expansion joint covers to be serviceable. If irreparable damage has occurred by these Works or from previous Work replace the existing covers with new to mate existing building standard.

#### 06100 ROUGH CARPENTRY

- Provide supports and fasteners of appropriate type and strength to hold the work securely place under anticipated conditions of exposure and use. Where supports and fasteners on hown, provide the type indicated, of appropriate size and strength.
- Provide blocking for support of wall mounted items such as shelving, countributes, and standing and running trim: do not depend on drywall far support. blocking requirements with key pian and furniture plan as provided in construct

#### 04400 CASEWORK

- Shop drawings for all items of architectural woodwork and casework, tections, elevations, and details of joinery.

- Fabricate tops in accordance with AWI "Premium Grade" standards. Provide laminate back
- . "Natural" Wood Finishes
- Finish to an even color, coverage, and gloss.
- 5. Installation:
- . Condition wood materials to prevailing humidity conditions before installing
- b. Standing and running trim: Keep number of joints to a minimum: use full-length pieces wherever possible. Scarf end-to-end joints and stagger joints in adjacent members. Cape trim at return and miter carners to produce tight-fitting joints with full surface contact.
- c. Casework: Anchor securely to blocking. Provide matching scribe pieces where necessary
- . Scribe and cutwork to fit adjoining work closely. Refinish cut surfaces in pref . At countertops with sinks, seal around plumbing fixtures and around perimeter sing clear sanitary silicone sealant.

#### 07200 INSULATION

- Provide sound attenuation batts within all partition cavities as noted on Partition Types
- 2. Materials:
- Hem: Sound Attenuation Batts /MW or approved equal Fisieh: N/A Manufacturer: Owens Corning Supplier: To be determined by Contractor Specifications: To match existing products on site

#### 08100 DOORS AND FRAMES

- Door frames: Tenant Standard, Hollow Metal knocked down as specified on drawing set.
- Doors: Solid Core oak natural finished door as indicted on drawing set.
- . Installation: Allow wood doors to become acclimated before hanging. In fitting for width, im equally from both sides. Do not trim top or bottom rails more than 1 inch. Require ainter to seal tops, bottoms, and edges of doors immediately after doors have been fitted.
- 5. Refer to Drawings for Hardware Specifications
- 5. Location and Quantity: Refer to Drawing Set
- Keying to be coordinated with Tenant and Building Owners locksmith

#### 08800 GLASS

- 7/16" TEMPERED GLASS

### Clear Virginia Glass and Mirror OR approved To be determined by Owner Per Manufacturer

#### 09120 CEILING SUSPENSION SYSTEMS

- Comply with the following industry standards:
- Steel studs, runner, and furring standard: ASTM C-654
- Installation of steel framing: ASTM C-754
- Application and finishing of gypsum board: ASTM C-840
- 2. Comply with manufacturer's installation instructions and recommendations that apply to
- 3. Design metal supports systems to limit deflection to L/175. Use min. 20 gauge galvaniz steel studs; space studs 16 inches on center unless otherwise noted. Provide additional bracing or "Rickers" above ceiling wherever shown or required for proper support or of partitions or rigidity of soffits.
- Fire-rated assemblies: Provide materials, accessories and application procedures which have been listed by UL or tested in accordance with ASTM E 119 for the type of construction shown. When patching new or existing partitions, maintain the integrity of fire-rated Tolerances: Install gypsum wallboard and gypsum board ceilings flat to a tolerand inch in 4 feet and 3/16 inch in 8 feet (in any direction), plumb or level, true to le plan, and with offset between adjacent boards not exceeding 1/16 inch.
- Metal Trim: Apply galvanized steel trim to external corners and exposed edges of gypsur drywali. Form control joints with back-to-back L-beads at maximum intervals of 30 feet locations approved by McMahon Architects, Inc. Provide all required expansion trim at
- . Tape joints in drywall and finish joints and cover fasteners and metal trim with three coats of joint compound, sanding between coats. (If not required for fire rating, second and third coats may be omitted where drywall is conceoled above ceiling.) After first coat of point has been applied to drywall, return and patch or refinish as deemed necessary by McMahon withdects, Inc. to obtain a uniform and smooth appearance.
- Provide and install all required access panels in gypsum drywall where require for access new electrical and mechanical controls if required. Locate as directed by Landford.
- 9. Coordination: Coordinate the location of diffusers, grilles, sprinkler heads and other ceiling mounted devices. Coordinate location of work above ceiling. If it is not possible to install ceiling grids or ceiling mounted devices as shown, notify McMahon Architects, Inc. at once, an wait for further instructions for McMahon Architects, Inc. before proceeding.
- Layout ceiling grids to match location of previous grid and ceiling heights shown of effected ceiling plan to minimize relocation of sprinkler heads. If not otherwise shown, layou constical ceilings so that they are centered in both directions within space or area.
- Install ceiling suspension systems to comply with ASTM C-636. Secure directly to structure; do not suspend from ducts, pipes or other non-structural items.

#### 09250 GYPSUM DRYWRII

- Comply with the following industry standards
- Steel studs, runner, and furring standard: ASTM C-654 Installation of steel framina: ASTM C-754
- Application and finishing of gypsum board: ASTM C-840
- Comply with manufacturer's installation instructions and recommendations that apply to
- Design metal supports systems to limit deflection to L/175. Use min. 20 gauge gal cel studs; space studs 16 inches on center unless atherwise noted. Provide additional acing or "kickers" above ceiling wherever shown or required for proper support or of rtitions or rigidity of soffits.
- Fire-rated assemblies: Provide materials, accessories and application procedures which haven listed by UL or tested in accordance with ASTM E 119 for the type of construction nown. When patching new or existing partitions, maintain the integrity of fire-rated
- 5. Tolerances: Install gypsum wallboard and gypsum board ceilings flat to a tolerance of 1 not in 4 feet and 3/16 inch in 8 feet (in any direction), plumb or level, true to location in lalar, and with offset between adjocent boards not exceeding 1/16 inch. Metal Trim: Apply galvanized steel trim to external corners and exposed edges of gypsum ywall. Form control joints with back—to—back L—beads at maximum intervals of 30 feet at cotions approved by McMahon Architects, Inc. Provide all required expansion trim at gransion joints.
- 7. Tape joints in drywall and finish joints and cover fasteners and metal trim with three coats of joint compound, sanding between coats. (If not required for fire rating, second and third coats may be amitted where drywall is conceeled above ceiling.) After first coat of point has been applied to drywall, return and patch or refinish as deemed necessary by McMahon Architects, Inc. to obtain a uniform and smooth appearance.
- 8. Provide and install all required access panels in gypsum drywall where require for access new electrical and mechanical controls if required. Locate as directed by Landlord.
- 1. Return air plenum: Install fusible link dampers. Coordinate with HVAC Contractor.

NOTES:





DATE ISSUE & TRUE FOR PERSON A B C D E



#### JOB TITLE:

CIEE- Council on International Educational Exchange 79-85 Commercial Street 3rd Floor Portland, Maine

SCALE: DRAWN: jau JOB NO.: 23-2003

SHEET TITLE:

SPECIFICATIONS

A.02

#### 99500 ACOUSTICAL CEILING

- Coordination: Coordinate the location of diffusers, grilles, sprinkler heads and other ceiling mounted devices. Coordinate location of work above ceiling. If it is not possible to install ceiling grids or ceiling mounted devices as shown, notify McMahon Architects, inc. at once, and wait for further instructions for McMahon Architects, Inc. before proceeding.
- . Installation
- a. Layout ceiling grids to match location of previous grid and ceiling heights shown of reflected ceiling plan to minimize relocation of sprinkler heads. If not otherwise shown, layout acoustical ceilings so that they are centered in both directions within space or area.
- b. Center fixtures and diffusers within a ceiling panel, unless otherwise noted.
- c. Install ceiling suspension systems to comply with ASTM C-636. Secure directly to structure do not suspend from ducts, pipes or other non-structural items.
- d. Align directionally patterned panels with pattern all in same direction.

#### 09600 FLOORING

- 1. Products: Refer to the Finish Schedule on construction documents.
- 2. Exomine the sub-floor and the conditions under which the flooring is to be installed and notify McMahan Architects, inc. in writing of conditions detrimental to the proper completion of the work or to the life of the flooring to be installed. Do not begin installation installer finds the substrate acceptable. General Contractor is responsible for all floor fees not covered by flooring contractor. General Contractor to coordinate.
- 3. Leveling: Fill minor depressions, cracks, and holes with latex underlayment so there in no visible waviness and floor is flat to 1/8 inch under a 10 foot straightedge. Vacuum floor just before beginning installation.
- 4. Resilient flooring: Install using waterproof odhesive recommended by flooring monufacturer. Balance tiles in each room or area, unless other pattern is shown on drawings. Protect all flooring from traffic during the remainder of the construction period.
- 5. Carpet: Install carpet pad underneath all carpeted areas. Maintain direction of pattern and texture and lay of pile in contiguous areas. Within any one room or area, use carpet from any one eye lot; also conspicuous color difference in the opinion of McMehan Architects, Inc., between dye-lots in adjacent areas will not be acceptable. Run carpet to centerline under doors. Provide autouts as required. Comply with additional recommendations of the Carpet and Rug Institute. Carpet must be installed in sequence as provided by the carpet
- 5. Resilient Base: Install throughout. Apply to all walls, columns, pilasters, casework and other permurent listures. Use preformed or corners and milter inside corners. Installed base shall lie flat to wall. General Contractor is responsible for the correct installation of base on all walls and must coordinate trades to insure flat clean installation of all base materials.

#### 09900 PRINTING NOTES

- Remove all hardware, occessories, fixtures and similar items before beginning work.
   Reinstall after completion of painting work.
- 2. Prior to pointing complete all spackling and patching of drywall surfaces required. Coulk gaps at changes of material (such as drywall to wood or metal frame), at both new and existing work, to provide a smooth surface for painting. Use paintable latex-ocrylic sealant.
- 3. Store, mix and apply paints in strict conformance with paint manufacturer's recommendations.
- 4. Painting: Apply one coat of primer and two topcoats. Paint surfaces behind moveable equipment and furniture same as adjacent surfaces. Point access panels and electric load center covers to match surrounding surfaces. Paint wood backboards with paint to match surrounding wall. Point exposed piping, hangers, and ductwork.
- 5. Touch-up where necessary all stained windowsills and doors.
- Painter is responsible for all "tauch-ups", repointing required after corpet, base, millwork, furniture installation.
- 7. Wall Covering/Graphics: Prime drywall surfaces to receive well coverings with one coat of non-pigmented oil-based primer. Locate seems away from corners and keep plumb; match patterns if opplicable; overlap seams prior to rozor cutting. Brush and roll to remove bubbles, Remove excess adhesive promptly from washable walkovering; for fabrics which cannot be washed, allow to dry and then brush clean.
- B. Turn excess paint and walkcovering over to Client for maintenance stock. Seal paint cans tightly, wipe clean so that label is readable, and clearly label with color. Neatly roll and wrap wall covering and clearly label with name of manufacturer, pattern and color.

#### 15300 FIRE PROTECTION

- Submittals: Contractor and Sprinkler Contractor shall provide a design-build engineered fire protection drawing and specifications. Submit plan and specifications to Client and McMahan Architects, inc. for approval.
- The work to be completed under this contract includes the furnishing of all necessary lobor, materials, scaffolding, equipment and tools for the complete construction and installation of the sprinkler work, all as described hereinafter and shown and indicated on the drawings, and set forth in these applications.
- All work and materials are to comply in every respect with the State Building Code, and such applicable building laws and regulations are to be considered as part of these specifications.
- 4. The Fire Protection (Sprinkler) subcontractor is to give all requisite notices, file all requisite plans relating to his work with the proper authorities and is to secure all permits and pay all fees for same. If any work is performed and changes are necessary to conform to the ordinances, these changes shall be made at the Fire Protection subcontractor's expense.

#### 15400 PLUMBING AND HEATING

- Submittals: General and HVAC Contractor shall provide a design-build engineered pian and specification. Plan and specification shall be submitted to the Tenant and McMahon Architects, Inc. for approval.
- Codes and Standards: Perform all mechanical and plumbing work in full compliance with applicable codes and regulations.
- 3. Separate HVAC from surrounding premises and tie into building system.
- Plumbing Products, if any: Submit catalog cuts to McMahon Architects, Inc. and Landlord for approval. Contractor to contact Landlord regarding location of wet column.

#### 16000 ELECTRICAL

- Perform electrical work in full compliance with applicable codes and regulations. Use only
  U.L. listed equipment and components.
- 2. It is the intent of the specification and drawings that the electrical system shall be furnished and installed complete. Electrical Contractor shall provide conduit, wire, boxes, equipment, devices and materials usually furnished in connection with similar work, whether specifically mentioned or not. Examine available power supply and panel boards and provide additional circuits or new panel boards if the present service is inadequate to support new work of this Contract.
- 3. Switches, Outlets & Cover plates: White on white. Coordinate color of all plates with Tel/Computer Cobling Contractor plates for both trades to match.
- 4. Provide emergency lighting equipment and exit signs that comply with applicable codes.
- 5. Mount electrical, telephone and data communications outlets 1'-6" A.F.F. to centerline, unless otherwise noted. Offset back-to-back autlets to allow clearance. For groups of cover plates, gang where appropriate or set cover plates 1" apart maximum.
- 6. Cabling above ceiling to be plenum rated Tetlan coated
- 7. Remove all unnecessary wiring throughout ceiling plenum. Contractor to verify removal of all existing cabling in writing to McMahon Architects, Inc. and Tenant.

#### 16505 SPECIALTY LIGHTING

1. Perform electrical work in full compliance with applicable codes and regulations. Use only U.L. listed equipment and components. It is the intent of the specification and drawings that the electrical fixtures shall be furnished and installed complete. Electrical Contractor shall provide conduit, wire, boxes, equipment, devices and materials usually furnished in connection with similar work, whether specifically mentioned or not. Examine available power supply and panel boards and provide additional circuits or new panel boards if the present service is inadequate to support new work of this Contract.

2. Materials: Refer to the attached cut sheets for each fixture specification. Refer to the Architectural Reflected Ceiling Plan for location and quantity. FRINKE DELIMING AND MISTALLARON STO BE COMPONING BY THE CHEMAL COMPONING.

NOTES:



DAVID R.
McMAHON
No. 305993

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JOB TITLE:


CIEE- Council on International Educational Exchange 79-85 Commercial Street 3rd Floor Portland, Maine

SCALE: N/A DRAWN: jau JOB NO.: 23-2003

SHEET TITLE:

SPECIFICATIONS

A.03

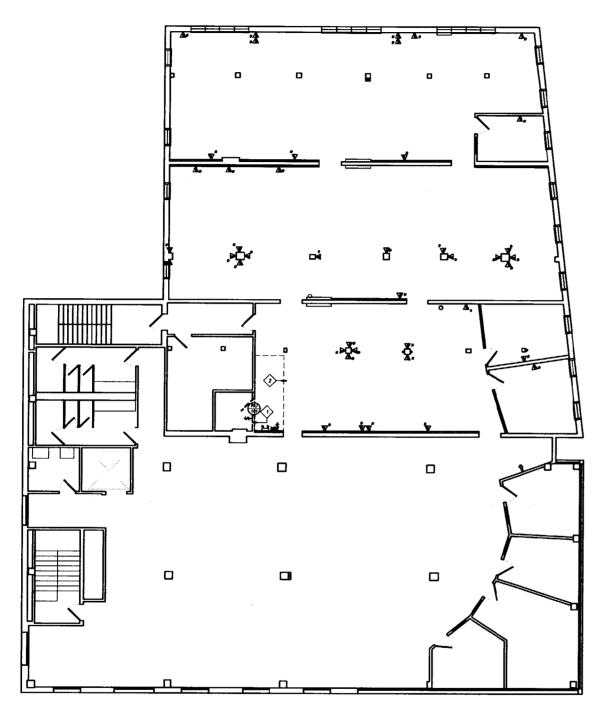

DEMOLITION - KEYNOTE PLAN
SOLE: 1/8" - 1'-4"

#### DEMOLITION GENERAL NOTES - FLOOR PLAN

1. THE WORK WHICH WILL BE PERFORMED UNDER THIS CONTRACT SHALL BE IN ACCORDANCE WITH THE RULES OF THE BUILDING MANAGEMENT OFFICE AND ALL STATE AND LOCAL BUILDING CODES. REFER TO THE CONSTRUCTION QUIDELINES AS OUTLINED BY THE BUILDING MANAGEMENT FOR CONSTRUCTION RULES AND REGULATIONS AND ADDITIONAL INFORMATION.

2. PRIOR TO THE INITIATION OF ANY DEMOLITION OR NEW CONSTRUCTION, THE GENERAL CONTRACTOR SHALL MEET WITH THE BUILDING MANAGER TO ESTABLISH THE PROCEDURE FOR REMOVING DEBRIS FROM THE PROJECT STE. ALL DEBRIS SHALL BE REMOVED FROM THE SITE ON A DAILY BASIS TO MAINTAIN A CLEAN AND SAFE WORKING ENARCHMENT.

3. THE GENERAL CONTRACTOR IS RESPONSIBLE FOR THE SCOPE OF WORK MONCATED ON THE ARCHITECTURAL AND ENGINEERING DOCUMENTS ISSUED AS REQUIRED TO COMPLETE THE WORK OF THIS CONTRACT. ITEMS NOT MONCATED THAT MAY INTERFERE WITH THE SCOPE OF WORK ARE TO BE BROUGHT TO THE IMMEDIATE ATTENTION OF MAINHAIN ARCHITECTS, INC.

4. REFER TO THE DIMENSION PLANS FOR DIMENSIONS AND REFERENCE TAGS. DIMENSIONS ARE TO FINISHED FACE OF PARTITION UNLESS OTHERMESE NOTED. THE GENERAL CONTRACTOR SHALL CONSIGN ALL DIMENSIONS ON SITE PRIOR TO ORDERING OR INSTALLING NEW MATERIALS OR FOURPHEIT. THE GENERAL CONTRACTOR SHALL NOTEY UNAMHORN ARCHITECTS, INC. OF ANY DIMENSIONAL DISCREPANCIES. DO NOTE SCALE THESE DIMININGS. PRINTING PROCESS WITH DISTORT SOME.


5. UPON COMPLETION OF DEMOLITION, GENERAL CONTRACTOR SHALL PERFORM A FIELD SURVEY TO CONTRIN ALL DIMENSIONS AS INDICATED ON THE NEW CONSTRUCTION PLANS. THIS SURVEY SHALL BE PROVIDED TO THE ARCHITECT FOR REVIEW AND SIGN-OFF AND COORDINATION WITH SCOPE OF NEW CONSTRUCTION.

6. CARE IS TO BE TAKEN NOT TO DISTURB OR DEWOLISH ANY EXISTING WORK TO REMAIN OR WHICH MAY AFFECT THE USE OR OPERATION OF ANY OTHER TENANT OR SPACE. ANY SUCH DAMAGE OR REMOVAL OF MATERIALS IS TO BE REPORTED TO THE ARCHITECT AND BUILDING MANAGER AND SHALL BE MANEDIATELY REPAIRED OR REPLACED AT THE SOLE COST OF THE GENERAL CONTRACTOR.

7. DEMOLISH COMPLETELY TO SOURCE ALL EXISTING TELEPHONE AND DATA CABLING, SMITCHES, HUBS, CUTLETS AND EQUIPMENT AS NOTED IN THE CONSTRUCTION DOCUMENTS.

8. DEMOUSH COMPLETELY ALL EXISTING LIGHTING FOXTURES, HANGING MECHANISMS, CONDUIT AND WIRING TO THE SOURCE, JUNCTION BOXES, EMERGENCY LIGHTING, BUT SCANS AND TRANSFORMERS AS NOTED IN THE CONSTRUCTION DOCUMENTS. REMOVE COMPLETELY ALL OUTLIETS AND ELECTRICAL PANELS AS REQUIRED TO ACCOMMODATE NEW CONSTRUCTION.

NOTES:

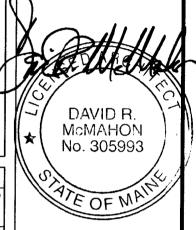

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JOB TITLE:

CIEE- Council on International Educational Exchange 79-85 Commercial Street 3rd Floor Portland, Maine

SCRLE: 1/8" = 1'-0" DRAWN: jau JOB NO.: 23-2003

SHEET TITLE: DEMOLITION -**KEYNOTE PLAN** 

**D1** 

#### **DEMOLITION KEYNOTES - FLOOR PLAN**

THE DEMOLITION KEY NOTES BELOW ARE TO PROVIDE THE GENERAL CONTRACTOR WITH A GENERAL OVERHABLY OF THE SCOPE OF DEMOLITION WORK. THESE SYMBOLS DO NOT REPRESENT THE ENTIRE SCOPE OF DEMOLITION THAT WILL BE REQUIRED. THE GENERAL CONTRACTOR SYMLL BE RESPONSIBLE FOR REVIEWING THE AS-BUILT CONDITIONS AS WELL AS THE SCOPE OF NEW CONSTRUCTION TO DETERMINE THE COMPLETE SCOPE OF REQUIRED CHARLITION.

EXISTING WALL TO BE DEMOLISHED

2 - EXISTING CARPET TO BE REMOVED. PREP FLOOR FOR NEW FINISH.


#### DEMOLITION LEGEND - FLOOR PLAN



EXISTING DOOR TO BE REMOVED AND CAREFULLY STORED FOR REUSE

EXISTING EMERGENCY LIGHT TO BE REMOVED AND CAREFULLY STORED FOR REUSE

EXISTING EXIT TO BE REMOVED AND CAREFULLY STORED FOR REUSE EXISTING TEL/DATA OUTLET TO BE DEWOLISHED. (TEL/DATA VEMOOR TO DETERMINE REUSE IF POSSIBLE OF CABLING) REF. A4 FOR SCOPE OF NEW

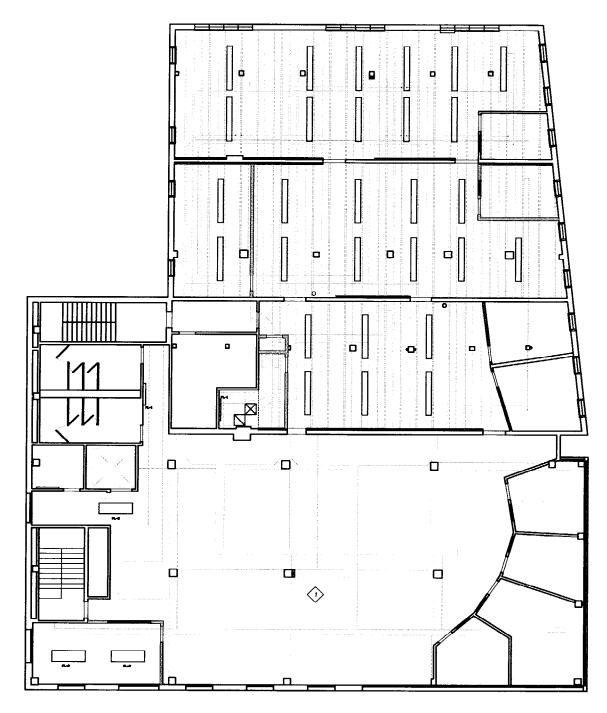

DEMOLITION- REFLECTED CEILING PLAN
SING: 10F - 1'-F'

#### **NEW CONSTRUCTION GENERAL NOTES - REFLECTED CEILING PLAN**

1. THE WORK WHICH WILL BE PERFORMED UNDER THIS CONTRACT SHALL BE IN ACCORDANCE WITH THE RULES OF THE BUILDING MANAGEMENT OFFICE AND ALL STATE AND LOCAL BUILDING CODES. REFER TO THE CONSTRUCTION CUIDELINES AS CUITAVED BY THE BUILDING MANAGEMENT FOR CONSTRUCTION RULES AND REGULATIONS AND ADDITIONAL INFORMATION.

PRIOR TO THE INITIATION OF ANY DEMOLITION OR NEW CONSTRUCTION, THE GENERAL CONTRACTOR SHALL MEET WITH THE BUILDING MANAGER TO ESTABLISH THE PROCEDURE FOR REMOVING DEBRIS FROM THE PROJECT STIE. ALL UEBRIS SHALL BE REMOVED FROM THE STE ON A DALLY BASIS TO MARITAIN A CLEAN AND SAFE WORKING ENVIRONMENT.

3. The ceneral contractor is responsible for the scope of work indicated on the architectural and engineering documents issued as required to complete the work of this contract. Items not indicated that may interfere with the scope of work are to be brought to the immediate attention of mamahon architects, inc.

4. THE GENERAL CONTRACTOR SHALL CONFIRM ALL DIMENSIONS ON SITE PRIOR TO ORDERING OR INSTALLING NEW IMPERIALS OR EQUIPMENT. THE GENERAL CONTRACTOR SHALL NOTIFY INSMHON ARCHITECTS, INC. OF ANY DIMENSIONAL DISCREPANCES. 100 NOT SCALE THESE DRIVINGS. PRINTING PROCESS WITH DISTORT SCALE.


5. THE ARCHITECTURAL REFELCTED CEILING PLAN SUPERCEDES THE ENGINEERING PLAN FOR QUANTITY AND LOCATION OF LIGHT FIXTURES.


6. THE GENERAL CONTRACTOR SHALL BE RESPONSIBLE FOR REVIEWING THE CONTENTS AND CONDITION OF ALL LICHTING PACKAGES MANEDIATELY UPON DELIVERY TO THE SITE. ANY DISCREPANCES BETWEEN THE CONTENTS OF THE PACKAGES AND THE FIXTURE SCHEDULE SHALL BE BROUGHT TO THE MANEDIATE ATTENTION OF MICHARION ARCHITECTS, INC.


7. PATCH, SAND AND PRIME ALL EXISTING TO REMAIN AND NEW CELLING SURFACES PRIOR TO FINAL PAINTING. ALL CIPSIAN WALEDARD CELINGS TO BE PRINTED 'PT2' PER FINEN SCHEDULE UNIESS MOTED OTHERWISE.

8. EXISTING SPRINGER HEADS WILL BE RELOCATED PER NEW LAYOUT. ADJUST HEAD HEIGHTS TO ACCOMMODATE NEW CEILING HEIGHTS.
REFER TO ENGINEERING DRAWNINGS FOR ADDITIONAL INFORMATION.

NOTES:

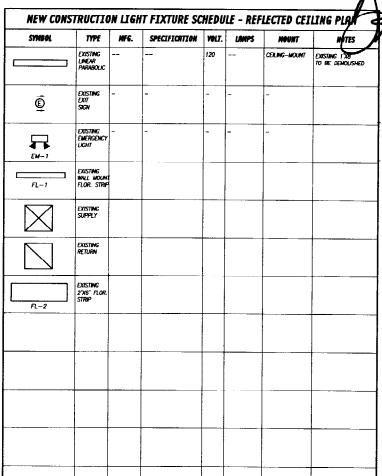

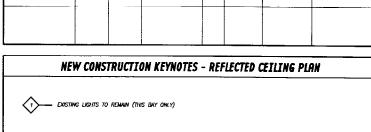

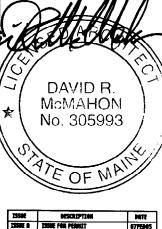




#### JOB TITLE:

CIEE- Council on International Educational Exchange 79-85 Commercial Street 3rd Floor Portland, Maine

SCALE: 1/8"=1'-0" DRRWN: jau JOB NO.: 23-2003

SHEET TITLE: DEMOLITION-REFLECTED CEILING PLAN

**D2** 

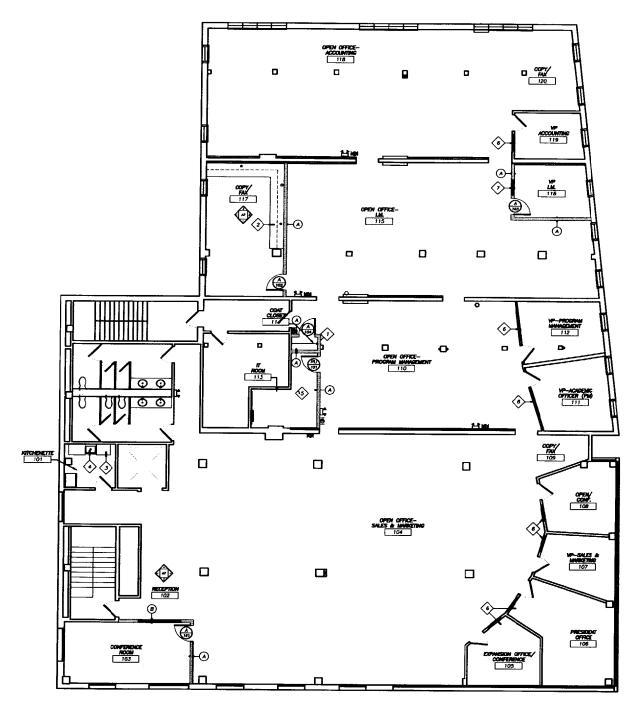

NEW CONSTRUCTION - KEYNOTE PLAN
SOME: 1/07-17-07

#### **NEW CONSTRUCTION GENERAL NOTES - FLOOR PLAN**

1. THE WORK WHICH WILL BE PERFORMED UNDER THIS CONTRACT SHALL BE IN ACCORDANCE WITH THE RULES OF THE BUILDING MANAGEMENT OFFICE AND ALL STATE AND LOCAL BUILDING CODES. REFER TO THE CONSTRUCTION GUIDELINES AS OUTLINED BY THE BUILDING MANAGEMENT FOR CONSTRUCTION SHAD ADDITIONAL MYDIORIDAL OF THE SHAD REGULATIONS AND ADDITIONAL MYDIORIMATION.

2. PRIOR TO THE INITIATION OF ANY DEMOLITION OR NEW CONSTRUCTION, THE GENERAL CONTRACTOR SHALL MEET WITH THE BUILDING MANAGER TO ESTABLES IT THE PROJECT FOR REMOVMED BERNS FROM THE PROJECT SITE. ALL DEBRIS SHALL BE REMOVED FROM THE SITE ON A DMAY BASIS TO MANTAM A CLEAN AND SAFE WORKING EMPRICAMENT EMPLOYMENT.

3. THE CENERAL CONTRACTOR IS RESPONSIBLE FOR THE SCOPE OF WORK INDICATED ON THE ARCHITECTURAL AND ENGINEERING DOCUMENTS ISSUED AS REQUIRED TO COMPLETE THE WORK OF THIS CONTRACT. ITEMS NOT INDICATED THAT MAY INTERFERE WITH THE SCOPE OF WORK ARE TO BE BROUGHT TO THE IMMEDIATE ATTENTION OF IMMAHON ARCHITECTS, INC.

4. REFER TO THE DIMENSION PLANS FOR DIMENSIONS AND REFERENCE TAGS. DIMENSIONS ARE TO FINISHED FACE OF PARTITION UNLESS OTHERWISE NOTED. THE GENERAL CONTRACTOR SHALL CONFIRM ALL DIMENSIONS ON SITE PRIOR TO GROENING OR INSTALLING NEW MATERIALS OR EQUIPMENT. THE CENTERAL CONTRACTOR SHALL NOTEY MEMAHON ARCHTECTS, INC. OF ANY DIMENSIONAL DISCREPANCIES. DO NOT SOME THESE DRAWMINGS. PRINTING PROCESS WITH DISTORT SCALE.

5. NEW PAINT AND VINIL BASE @ NEW CONSTRUCTION ONLY-TO WATCH ADJACENT.

NOTES:

#### **NEW CONSTRUCTION KEYNOTES & SYMBOLS - FLOOR PLAN**

#### REFER TO DWG AS FOR PARTITION DETAILS.

A — EULL HEIGHT, INTERIOR FARTITION - TYPICAL, 2 1/2"

STEEL STUDS TO EXTEND TO UPPER DECK. (1)
LAYER OF 5/8" GMB TO EXTEND FROM FINISHED
FLOOR TO UPPER DECK EACH FACE. FILL WITH
INSULATION.

GAZED CURTANIMAL - TYPICAL 1/4" (7'-10" W)
TEMPORED CLEAR GLASS SET IN STANLESS STEEL
GAZING CHAMBEL TOP AND BOTTOM WITH POLISHED
WERTICAL EDGS. HEAD HEIGHT TO ALIGN WITH TOP
OF DOOR FRAME.

COAT ROD & 18" DEEP PLAN SHELF TO BE MOUNTED AT 68" AFF.

— 30" DEEP PLAN COUNTER © 34"AF OPEN DELOW W/INTERNEDATE SUPPORTS © 36" OC MAX. PROVIDE & INSTALL BLACK PLASTIC GROMMETS AS MOCKETE W/ ADJUSTABLE SHELF ON STANDARDS ABOVE.

SPEC. COUNTERTOP-NEWMAR "ENTRISCAPE TEXTURED" (PEG-0017)
SUPPORTS & SHELVES-NEWMAR "STRING TEXTURED (S-6-027)

MEW PLAN COUNTER FOR EXISTING BASE CABINETS. 24°D X 1 1/2" SQUARE EDGE COUNTER: 4" BACKSPLASH. SPEC. MEMMAR "EARTHSCAPE-TIXTURED" (FGG-0011) EXISTING CABINETS TO, REPARM.

RELOCATED EMERGENCY LIGHT

NO RELOCATED EXIT SIGN

<b>⊹</b>	NEW STAINLESS STEEL SINK PROVIDE SLOPED PLAN FACE AT NEW SINK LOCATH SPEC: ELKAY LRAD2522 (VIF) LK 4123 FAUCET SE
$\wedge$	

\_\_\_\_ REPAIR & REPAINT EXISTING WINDOW FRAMES/SASHES. (SEMI-GLOSS BLACK)

NEW GLASS SIDELIGHT TO MATCH EXISTING

**NEW CONSTRUCTION DOOR SCHEDULE - FLOOR PLAN** 

SYMBOL	DOOR	FRAME		HARDINE			NOTES
			100K /	907 <i>j</i>	100R #	35 f	AUIES .
	REUSED DOOR	NEW PAINTED HOLLOW					i
<del>(**)</del>		METAL FRAME					Ī
<b>W</b>							1
							1
							<u> </u>
$\sim$	NEW 3'-0" DOOR	NEW PAINTED HOLLOW					MATCH EXISTING
(A)	1	METAL FRAME	L				STANDARD
<b>.</b>					L		HARDWARE TO BE
			L				BRUSHED STAINLESS STEEL
							PROMOE OFFICE
							FUNCTION LOCK
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DAVID R.

**McMAHON** 

No. 305993

McMahon Architects Inc. 535 Albeny Street Boston, NA 02114 P 617.482.5353 F 617.482.3288


#### JOB TITLE:

CIEE- Council on International Educational Exchange 79-85 Commercial Street 3rd Floor

Portland, Maine

SCALE: 1/8" = 1'-0" DRAWN: jau JOB NO.: 23-2003

SHEET TITLE: NEW CONSTRUCTION-KEYNOTE PLAN

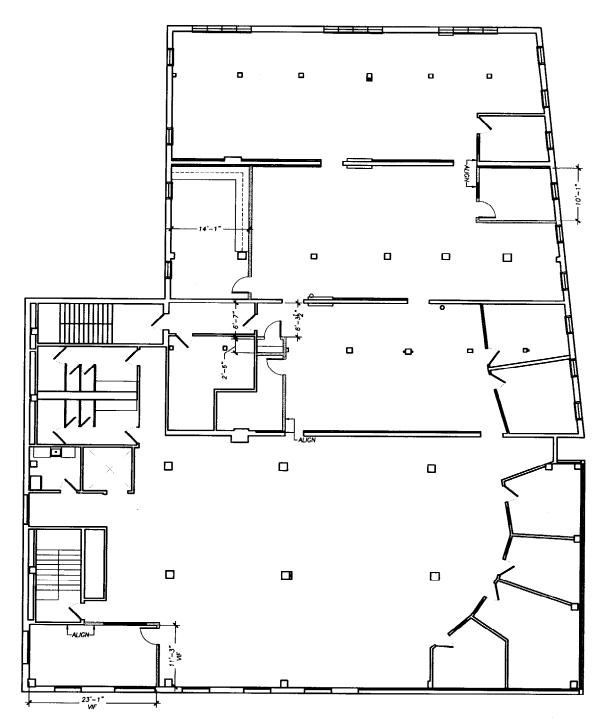

NEW CONSTRUCTION - DIMENSION PLAN
SONE: 1/4" - 1'-4"

#### **NEW CONSTRUCTION GENERAL NOTES - DIMENSION PLAN**

1. THE WORK WHICH MILL BE PERFORMED UNDER THIS CONTRACT SHALL BE IN ACCORDANCE WITH THE RULES OF THE BUILDING MANAGEMENT OFFICE AND ALL STATE AND LOCAL BUILDING CODES. REFER TO THE CONSTRUCTION GUIDELINES AS OUTLINED BY THE BUILDING MANAGEMENT FOR CONSTRUCTION RULES AND RECULATIONS AND ADDITIONAL INFORMATION.


2. PRIOR TO THE INITIATION OF ANY DEMOLITION OR NEW CONSTRUCTION, THE GENERAL CONTRACTOR SHALL MEET WITH THE BUILDING MANAGER TO ESTABLISH THE PROCEDURE FOR REMOVING DEBRIS FROM THE PROJECT STE. ALL DEBRIS SHALL BE REMOVED FROM THE STE ON A DALY BASIS TO MAINTAIN A CLEAN AND SAFE WORKING ENARRONMENT.

3. THE GENERAL CONTRACTOR IS RESPONSIBLE FOR THE SCOPE OF WORK INDICATED ON THE ARCHITECTURAL AND ENGINEERING DOCUMENTS ISSUED AS REQUIRED TO COMPLETE THE WORK OF THIS CONTRACT. ITEMS NOT MIDICATED THAT MAY INTERFERE WITH THE SCOPE OF WORK ARE TO BE BROUGHT TO THE IMMEDIATE ATTENTION OF MIGMAHON ARCHITECTS, INC.

4. DIMENSIONS ARE TO FINISHED FACE OF PARTITION UNLESS QUIENTIES MOTED. THE GENERAL CONTRACTOR SHALL CONFIRM ALL DIMENSIONS ON SITE PRIOR TO ORDERING OR INSTALLING NEW MATERIALS OR EQUIPMENT. THE GENERAL CONTRACTOR SHALL NOTIFY MEMBRION ARCHITECTS, INC. OF ANY DIMENSIONAL DISCREPANCES. DO NOT SIGNE THESE DEMBRISS. PRINTING PROCESS WITH DISTORT SIGNE.

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#### JOB TITLE:


CIEE- Council on International Educational Exchange 79-85 Commercial Street 3rd Floor Portland, Maine

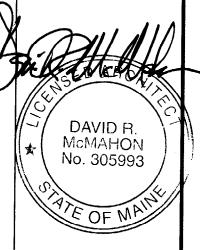SCALE: 1/8" = 1'-0" DRAWN: jau JOB NO.: 23-2003

SHEET TITLE:

NEW CONSTRUCTION -DIMENSION PLAN

**A2** 

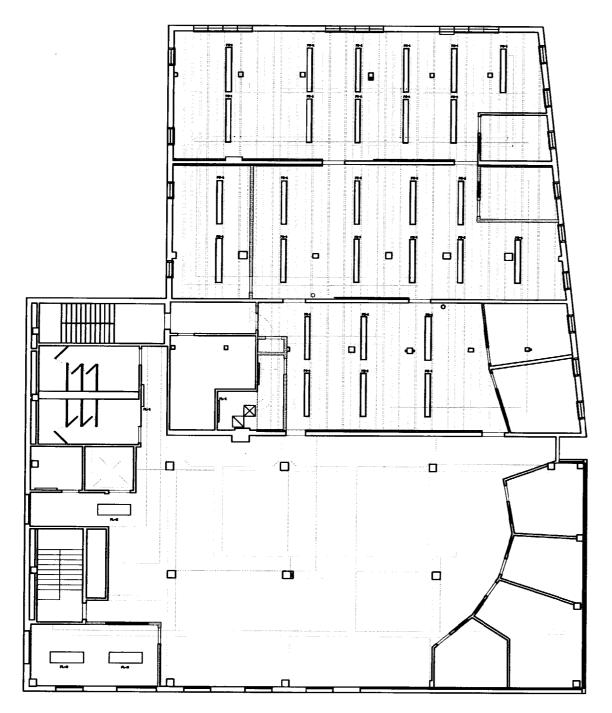

NEW CONSTRUCTION - REFLECTED CEILING PLAN
SOME: 1/4° - 1'-4°

#### **NEW CONSTRUCTION GENERAL NOTES - REFLECTED CEILING PLAN**

1. THE WORK WHICH WILL BE PERFORMED UNDER THIS CONTRACT SHALL BE IN ACCORDANCE WITH THE RULES OF THE BUILDING MANAGEMENT OFFICE AND ALL STATE AND LOCAL BUILDING CODES. REFER TO THE CONSTRUCTION GURDELINES AS OUTLINED BY THE BUILDING MANAGEMENT FOR CONSTRUCTION RULES AND REGULATIONS AND ADDITIONAL INFORMATION.

 PRIOR TO THE INITIATION OF ANY DEMOLITION OR NEW CONSTRUCTION, THE GENERAL CONTRACTOR SHALL MEET WITH THE BUILDING MANAGER TO ESTABLISH THE PROCEDURE FOR REMONNIC DEBRIS FROM THE PROJECT SITE. ALL DEBRIS SHALL BE REMOVED FROM THE SITE ON A DAILY BASIS TO MAINTAIN A CLEAN AND SAFE WORKING ENVIRONMENT.

3. THE GENERAL CONTRACTOR IS RESPONSIBLE FOR THE SCOPE OF WORK INDICATED ON THE ARCHITECTURAL AND ENGINEERING DOCUMENTS ISSUED AS REQUIRED TO COMPLETE THE WORK OF THIS CONTRACT. ITEMS NOT MOCKIED THAT MAY INTERFERE WITH THE SCOPE OF WORK ARE TO BE BROUGHT TO THE MAMEDIATE ATTENTION OF MUMAHON ARCHITECTS, INC.

4. THE GENERAL CONTRACTOR SHALL CONFIRM ALL DIMENSIONS ON SITE PRIOR TO ORDERING OR INSTALLING NEW MATERIALS OR EQUIPMENT. THE GENERAL CONTRACTOR SHALL NOTEY MEMAHON ARCHITECTS, INC. OF ANY DIMENSIONAL DISCREPANCES. <u>DO NOT SCALE</u> THESE DRAWNESS, PRAITING PROCESSE WITH DISTORT SCALE.

5. THE ARCHITECTURAL REFELCTED CELING PLIN SUPERCEDES THE ENGINEERING PLIN FOR QUANTITY AND LOCATION OF LIGHT FIXTURES.
6. THE GENERAL CONTRACTOR SHALL BE RESPONSIBLE FOR REVIEWING THE CONTENTS AND CONDITION OF ALL LIGHTING PACKAGES MANERALITY UPON DELINERY TO THE SITE. ANY DISCREPANCES BETWEEN THE CONTENTS OF THE PACKAGES AND THE FIXTURE SCHEDULE SHALL BE BROUGHT TO THE IMMEDIATE ATTENTION OF MEMAHON ARCHITECTS, INC.

7. PAICH, SAND AND PRIME ALL EXISTING TO REMAIN AND NEW CELLING SURFACES PRIOR TO FINAL PAINTING. ALL GIPSIAN WALFDONED CELLINGS TO BE PHATED "PIZ" FOR FINISH SCHEDULE LINESS NOTED OTHERWISE.

8. EXISTING SPRINKLER HEADS WILL BE RELOCKED PER HEW LAYOUT. ADJUST HEAD HEIGHTS TO ACCOMMODATE NEW CEILING HEIGHTS. REFER TO ENGINEERING DRAWINGS FOR ADDITIONAL INFORMATION.

NEW CONSTRUCTION LIGHT FIXTURE SCHEDULE - DEFLECTED CETUTAL DION


SYMBOL	TYPE	MFG.	SPECIFICATION	WLT.	LAMPS	MOUNT	HOTES	1
	HEW LINEAR PARABOLIC			120		CEILING MOUNT	1,X8,	
PC-1								
Ē	EXISTING EXIT SIGN	-	-	-	-	-	-	
EM-1	EXISTING EMERGENCY LIGHT	-	-	-	-	-	-	
FL-1	EXISTING WALL MOUNT FLOR. STRIP							
	EXISTING SUPPLY							
	EXISTING RETURN							
F1-2	EXISTING 2'X6' FLOR. STRIP							



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NOTES:



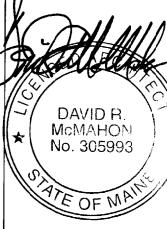

DESCRIPTION




#### JOB TITLE:

CIEE- Council on International Educational Exchange 79-85 Commercial Street 3rd Floor Portland, Maine

SCALE: 1/8"=1'-0" DRAWN: jau JOB NO.: 23-2003

SHEET TITLE: NEW CONSTRUCTION -REFLECTED CEILING PLAN

A3

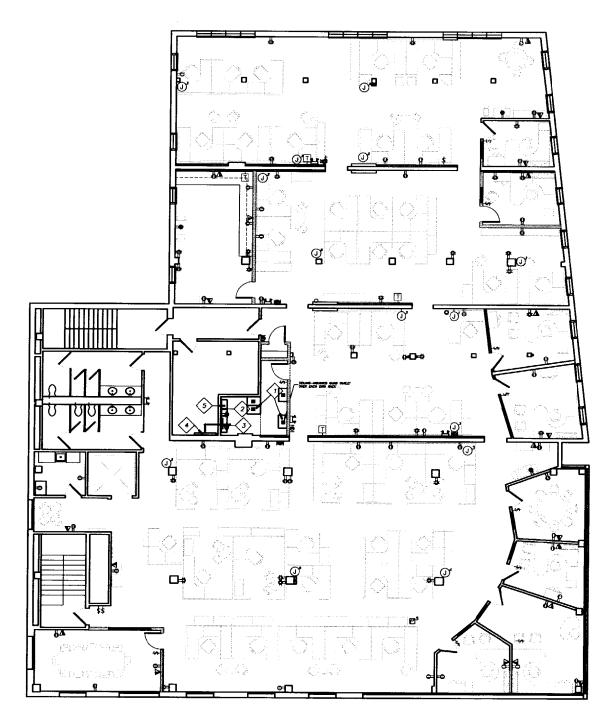

NEW CONSTRUCTION - POWER PLAN (FURNITURE SHOWN FOR INFORMATION ONLY)

#### NEW CONSTRUCTION GENERAL NOTES - POWER PLAN

1. THE WORK WHICH WILL BE PERFORMED UNDER THIS CONTRACT SHALL BE IN ACCORDANCE WITH THE RULES OF THE BUILDING MANAGEMENT OFFICE AND ALL STATE AND LOCAL BUILDING CODES. REFER TO THE CONSTRUCTION CURDELINES AS OUTLINED BY THE BUILDING MANAGEMENT FOR CONSTRUCTION RULES AND REGULATIONS AND ADDITIONAL INFORMATION.

2. PRIOR TO THE INITIATION OF ANY DEMOLITION OR NEW CONSTRUCTION, THE GENERAL CONTRACTOR SHALL MEET WITH THE BUILDING MANAGER TO ESTABLISH THE PROCEDURE FOR REMOVING DEBRIS FROM THE PROJECT STIE. ALL DEBRIS SHALL BE REMOVED FROM THE SITE ON A DALY BASIS TO MAINTAIN A CLEAN AND SAFE WORKING EMARCHMENT.

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4. THE GENERAL CONTRACTOR SHALL CONFIRM ALL DIMENSIONS ON SITE PRIOR TO ORDERING OR INSTALLING NEW MATERIALS OR EQUIPMENT. THE GENERAL CONTRACTOR SHALL NOTIFY MEMAHON ARCHITECTS, INC. OF ANY DIMENSIONAL DISCREPANCIES. <u>DO NOT SOME</u> THESE DRAWNES, PRINTING PROCESS WITH DISTRICT SOME

REFER TO THE EQUIPMENT PLANS FOR EQUIPMENT SPECIFICATIONS AND POWER REQUIREMENTS. THE GENERAL CONTRACTOR SHALL COORDINATE ALL REQUIREMENTS WITH THE MANUFACTURERS SPECIFICATIONS. 6. UNLESS NOTED OTHERWISE THE TEL/ELEC/DATA PLAN INDICATES NEW OUTLETS ONLY. THE GENERAL CONTRACTOR SHALL COORDINATE ON SITE THE LOCATIONS OF ALL ITEMS EXISTING TO REMAIN AND/OR TO BE DEMOLISHED.

ALL OUTLETS SHALL BE INSTALLED AT 18" AFF AND CENTERED HORIZONTALLY WITHIN WALL SECTION UNLESS NOTED OTHERWISE.
MUNIBERS INDICATED NEXT TO SPECIFIC SYMBOLS REFER TO THE HEIGHT ABOVE FINISHED FLOOR.

8. THE TEL/ELEC/DATA COVERS SHALL MATCH IN COLOR. STANDARD = WHITE ON WHITE.

SYMBOL	TYPE			
JIMPUL	<del></del>	MOTES		
P	NEW WALL MOUNTED DUPLEX OUTLET WITH COVER PLATE.			
Ħ	NEW WALL MOUNTED 20MP DEDICATED DUPLEX OUTLET WITH COVER PLATE.			
Ħ	NEW WALL MOUNTED GUAGRUPLEX OUTLET WITH COVER PLATE.			
Ħ	NEW WALL MOUNTED DEDICATED QUADRUPLEX OUTLET WITH COVER PLATE.			
P	EXISTING WALL MOUNTED DUPLEX OVILET			
V	NEW WALL MOUNTED TELEPHONE / DATA OUTLET WITH (1) PULL STRING.	2 DATA/ 1 VOICE		
∇ <sup>OUV</sup>	NEW WALL MOUNTED CABLE TELEVISION OUTLET W/ COMER PLATE. CABLING SHALL BE PROVIDED BY CABLE/SATELITE TV VENDOR, G.C. TO COORDINATE.			
\$	NEW WALL MOUNTED SWITCH WITH COVER PLATE.	OWNER SUPPLED FURNITURE SYSTEM: UP TO (4) 200mg CIRCUIS. POWER AND TEL/DATA AT BELTLINE. (§) MOICATES QUANTITY OF WORKSTATIONS FED FROM WHIP CONNECTION.		
① <sup>(0)</sup>	BLEC= EXTERNAL ENTRY DRECT CONNECT 4 CIRCUIT - 8 WRFE.  TEL/DATA= (2) DATA (1) VOICE PER WORKSTATION UNLESS OTHERWISE MOTED.	COORDINATE WITH SYSTEMS FURNITURE INSTALLATION DWGS.  NOTE: TEL/DATA/ELEC TO BE RUN IN CONDUIT OR BOX TERMINATE  SYSTEMS FURN. JUNCTION BOX & MASONRY WALLS & COLUMNS AS REQUIRED.		
P	POWER POLE			
T	THERMOSTAT	THERMOSTATS TO REMAIN IN CURRENT LOCATION, BUT TO BE REPLACED WITH PROGRAMMBLE THERMOSTATS WITH LOCKABLE COVERS		

# **NEW CONSTRUCTION KEYNOTES - POWER PLAN**

6' DATA RACKS WITH LADDER RACK ABOVE.
EXACT SPECKRONTON TO BE VERIFIED WITH
TEL/DATA VENDOR.
(WFR: QUADRARACK 50120-X15.
4 SOLD HEAVY DUTY SHELVES P/N 16351X19,
12 VENTED HEAVY DUTY SHELVES P/N 16350X19).
G.C. TO COORDINATE ELECTRICAL REQUIREMENTS
WITH SPECFICATION PROVIDED BY TENANT.

2>	EXISTING	PLYWOOD	BACK	PANE
V	ELECTRIC	AL/TEL/DA	TA.	


EXISTING COMMUNICATIONS PANEL TO BE REUSED.

NEW ELECTRICAL PANEL PROVIDE POWER TO DWINER SUPPLIED EQUIP.

5 - PHONE SYSTEM EQUIPMENT PROVIDED BY TEMANT

NOTES:



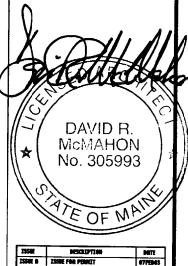

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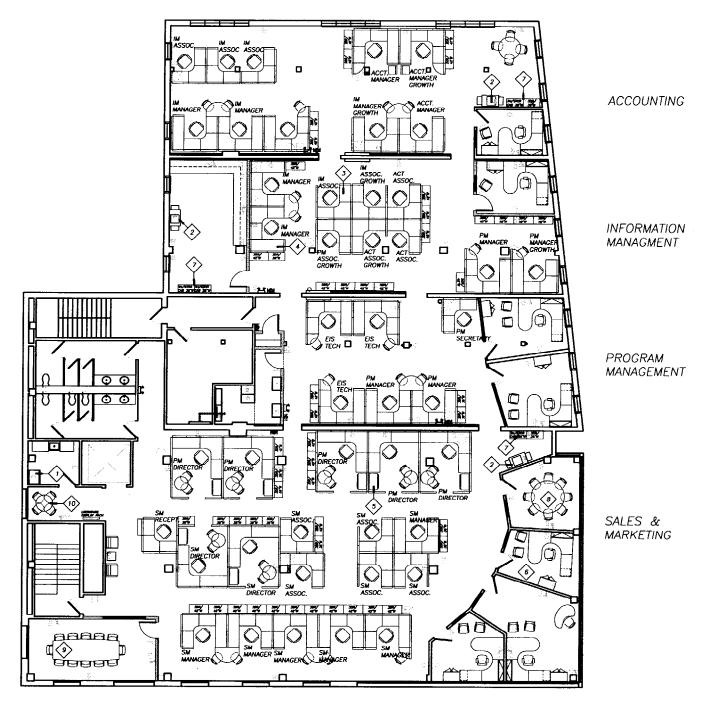
JOB TITLE:

CIEE- Council on International Educational Exchange 79-85 Commercial Street 3rd Floor Portland, Maine

SCALE: 1/8" = 1'-0" DRAWN: jau JOB NO.: 23-2003

SHEET TITLE:

NEW CONSTRUCTION -POWER PLAN



NEW CONSTRUCTION - EQUIPMENT PLAN
SOME 1/9" - 1'-9"

#### **NEW CONSTRUCTION GENERAL NOTES - EQUIPMENT PLAN**

1. THE WORK WHICH WILL BE PERFORMED UNDER THIS CONTRACT SHALL BE IN ACCORDANCE WITH THE RULES OF THE BUILDING MANAGEMENT OFFICE AND ALL STATE AND LOCAL BUILDING CODES. REFER TO THE CONSTRUCTION GUIDELINES AS OUTLINED BY THE BUILDING MANAGEMENT FOR CONSTRUCTION RULES AND REGULATIONS AND ADDITIONAL INFORMATION.

2. PRIOR TO THE INITIATION OF ANY DEMOLITION OR NEW CONSTRUCTION, THE GENERAL CONTRACTOR SHALL MEET WITH THE BUILDING MANAGER TO ESTABLISH THE PROCEDURE FOR REMOVING DEBMIS FROM THE PROJECT STIE. ALL DEBMIS SHALL BE REMOVED FROM THE STE ON A DALLY BASIS TO MAINTAIN A CLEAN AND SAFE WORKING ENVIRONMENT.

3. THE GENERAL CONTRACTOR IS RESPONSIBLE FOR THE SCOPE OF WORK MOICHTED ON THE ARCHITECTURAL AND ENGINEERING DOCUMENTS ISSUED AS REQUIRED TO COMPLETE THE WORK OF THIS CONTRACT. ITEMS NOT INDICATED THAT MAY INTERFERE WITH THE SCOPE OF WORK ARE TO BE BROUGHT TO THE MAMERIALE ATTENTION OF MEMAHON ARCHITECTS, INC.


4. REFER TO THE DIMENSION PLANS FOR DIMENSIONS AND RETERENCE TAGS. DIMENSIONS ARE FINESHED FACE OF PARTITION UNLESS OTHERWISE NOTED. THE GENERAL CONTRACTOR SHALL CONFIRM ALL DIMENSIONS ON SITE PROOR TO ORDERING OR INSTALLING NEW MATERIALS OR EQUIPMENT. THE CENTERAL CONTRACTOR SHALL NOTEY MEMBERS. PRINTING ENGLISH DISCREPANCIES. DO. NOT. SCALE THESE DRIMBNISS, PRINTING PROCESS. WITH DISTORT SCALE.

5. THE FURNITURE LAYOUT SHOWN IS FOR INFORMATION ONLY. ALL FURNITURE SHALL BE PROVIDED BY THE OWNER/TEMANT UNLESS NOTED OTHERWISE.

6. ALL EQUIPMENT, APPLIANCES, PLUMBING FIXTURES AND ALL ASSOCIATED ASSEMBLIES SHALL BE PROMDED AND INSTALLED BY THE GENERAL CONTRACTOR UNLESS MOTED OTHERMISE. THE GENERAL CONTRACTOR SHALL COORDINATE ALL POWER, ELECTRICAL AND PLUM REQUIREMENTS WITH THE MANUFACTURERS SPECIFICATIONS. REFER TO THE POWER PLAN FOR ADDITIONAL INFORMATION AND COORDINAT

4. THE GENERAL CONTRACTOR SHALL PROVIDE AND INSTALL ALL BLOCKING/FRAMING REQUIRED TO ACCOMMODATE THE INSTALLATION OF THE SPECIFIED EQUIPMENT. COORDINATE ALL REQUIREMENTS WITH THE MANUFACTURERS SPECIFICATIONS AND THE OWNERS/TENANTS FUNKNITURE PROVINCE.

NOTES:

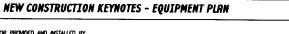

REFRIGERATOR PROVIDED AND INSTALLED BY

2 COPY MACHINE TO BE PROVIDED AND INSTALLED BY TENANT

3 TYPICAL 6'X6'
ASSOCIATE WORKSTATION

4 TYPICAL 6'X8' MANAGER WORKSTATION

5 TYPICAL 10'X12'
DIRECTOR WORKSTATION


6 TYPICAL WOOD
OFFICE FURNITURE


7 (2) 36°W FILES/STOR CABS WITH PLAN

8 CONFERENCE TABLE SIZE: 6' DIAM

9 CONFERENCE TABLE SIZE: 3'-4" X 12'

10 - LUNCH TABLE

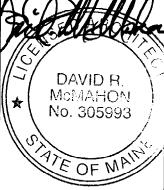

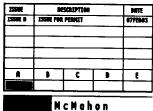




#### JOB TITLE:

CIEF- Council on International Educational Exchange 79-85 Commercial Street 3rd Floor Portland, Maine


SCALE: 1/8" = 1'-0" DRAWN: jau JOB NO.: 23-2003

SHEET TITLE: NEW CONSTRUCTION -EQUIPMENT PLAN


A5

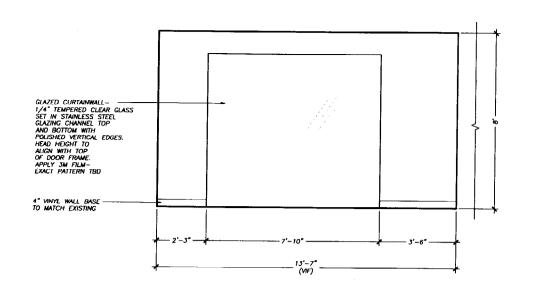


## ELEVATION-CONFERENCE ROOM SOME: 1/T'+1'-4"

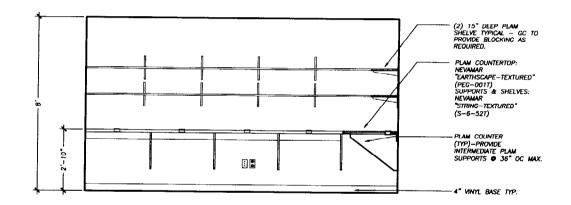

ELEVATION-COPY/FAX MILLWORK
SSML: 1/2"-1"-9"

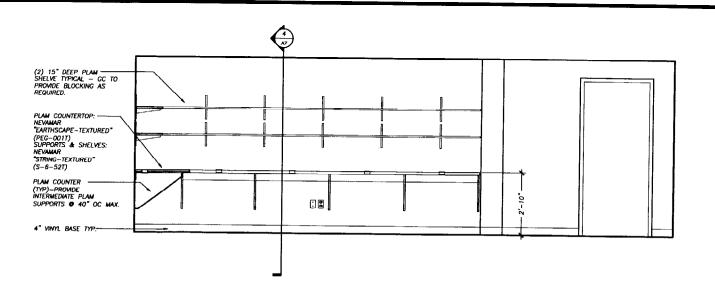

# ELEVATION-COPY/FAX MILLWORK SOME: 1/2" - 1"-9"

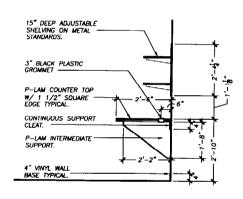


SECTION-MILLWORK

SUBSECTION-MILLWORK



NOTES:

DAVID R. McMAHON No. 305993

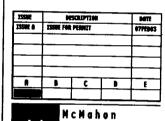

М

Architects Inc. 535 Albany Street Besten, MA 82118 P417.482.5353 F417.482.3288

#### JOB TITLE:


CIEE- Council on International Educational Exchange 79-85 Commercial Street 3rd Floor Portland, Maine

SCALE: As Noted DRAWN: jau JOB NO.: 23-2003

SHEET TITLE:

NEW CONSTRUCTION ELEVATIONS

**A6** 

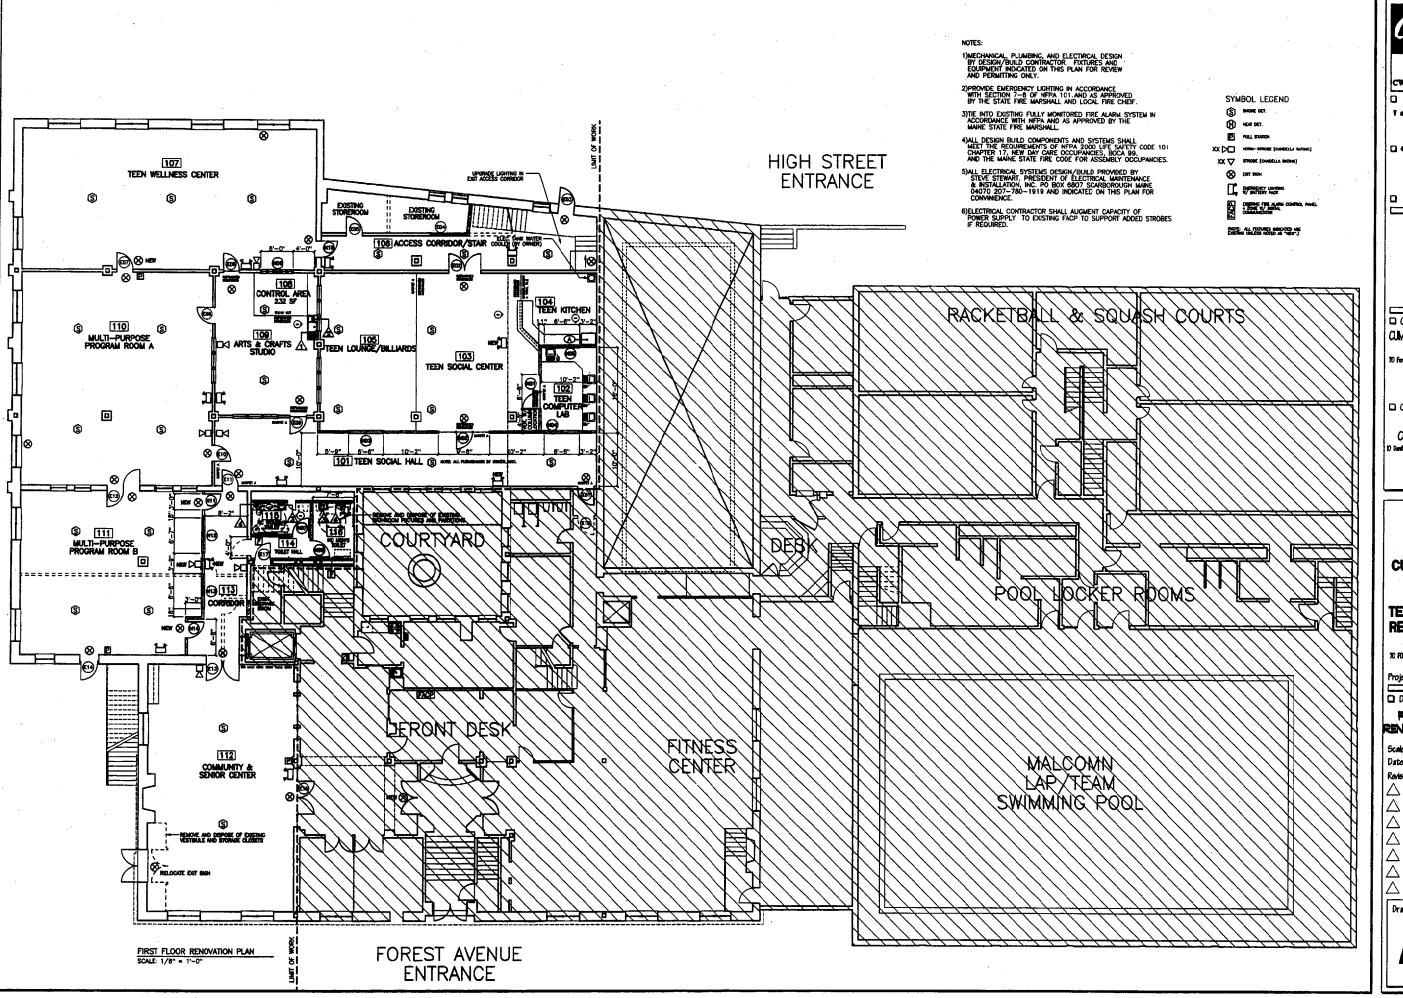

CWS Architect Arebiteeture

4 Decign

Partiana, ME 04101 Phone: (207)774-4441 Fat: (207)774-4016

wer.CMfarch.com

CUMBERLAND COUNTY YMCA

☐ Contractor:

WRIGHT-RYAN CONSTRUCTION, INC. Demforth Street Portland, ME 04101 (207) 773-8625



GREATER PURILAND YMCA TO POPEST ANDRE FORTLAND, WAVE

O Drawing Title


FIRST FLOOR RENOVATION PLAN

Date: PERMIT 12/27/02

 $\triangle$ 

Drawing Number:

**A1.** 1

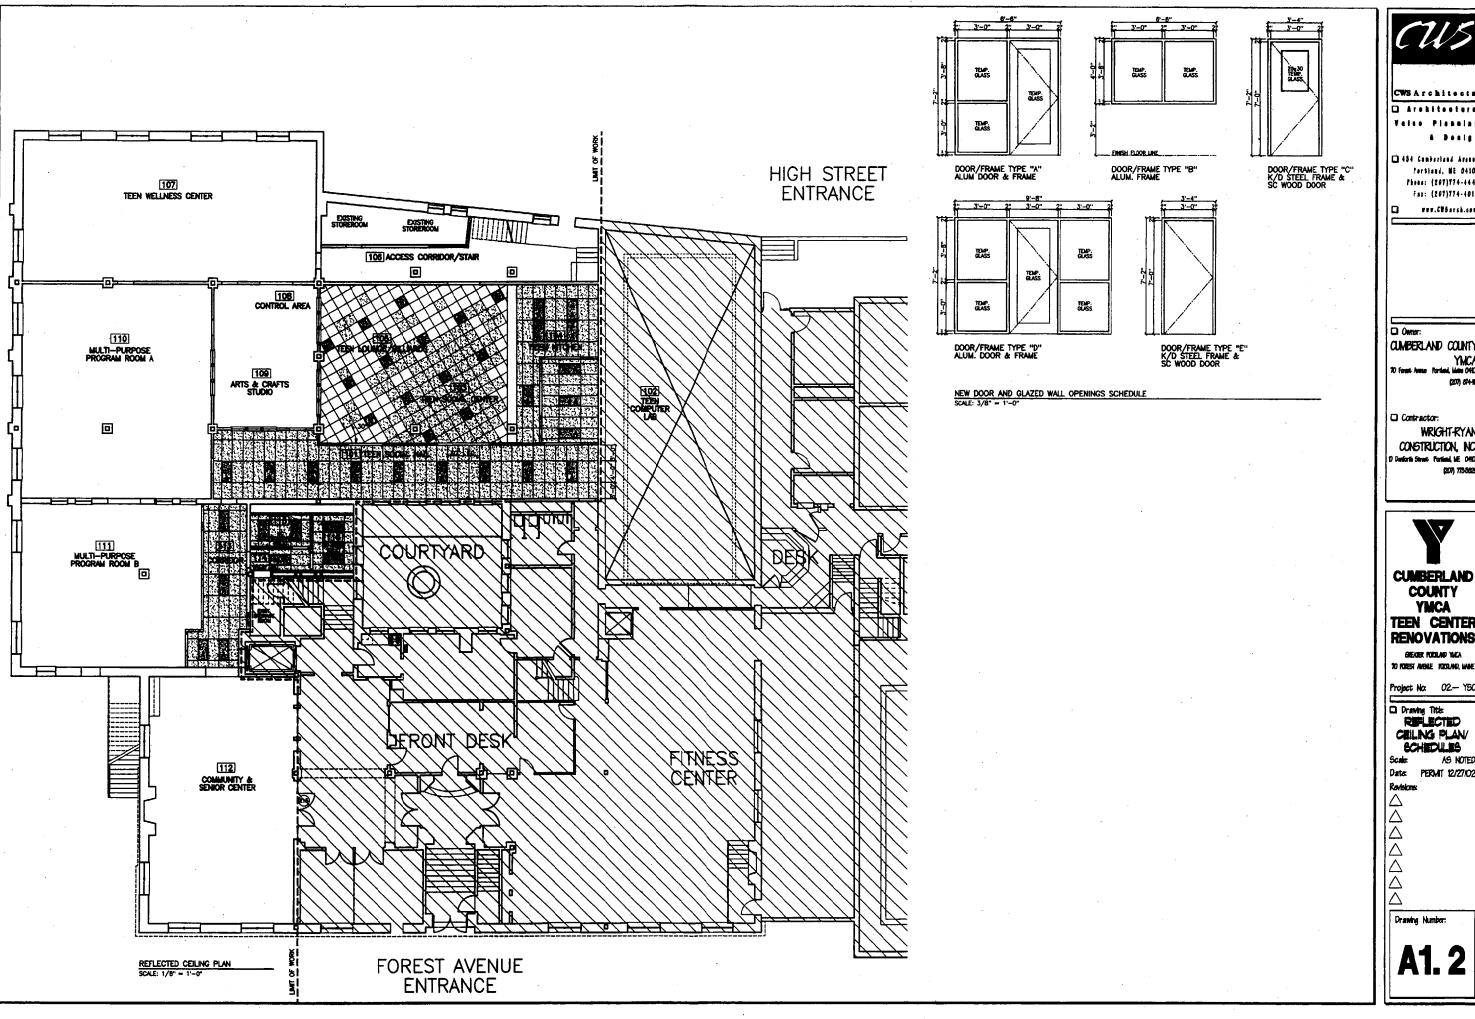

Arebitestura

Value Planelng

1 484 Camberland Arenne Phone: (201)774-4441 Fax: (207)774-4016

www.CTSarch.com

Owner: CUMBERLAND COUNTY

☐ Contractor:

WRIGHT-RYAN CONSTRUCTION, NC.

CUMBERLAND COUNTY YMCA TEEN CENTER

GREATER PORTILAND YMCA

CEILING PLAN/ SCHEDULES

Date: PERMIT 12/27/02