Administrative Authorization Decision

Name:

AT &T Mobility Wireless New Site Installation

Address:

25 Pearl Street

Project Description:

<u>Criteria for an Adminstrative Authorizations:</u> Section 14-523 (4) on page 2 of this application) Applicant's Assessment Y(yes), N(no), N/A

Planning Division Use Only

(See

a) Is the proposal within existing structures?	No	No
b) Are there any new buildings, additions, or demolitions?	Yes	Yes, 3 antennas and equipment
c) Is the footprint increase less than 500 sq. ft.?	Yes	Yes
d) Are there any new curb cuts, driveways or parking areas?	No	No
e) Are the curbs and sidewalks in sound condition?	Yes	Yes
f) Do the curbs and sidewalks comply with ADA?	Yes	Yes
g) Is there any additional parking?	No	No
h) Is there an increase in traffic?	No	No
i) Are there any known stormwater problems?	No	No
j) Does sufficient property screening exist?	Yes	Yes
k) Are there adequate utilities?	Yes	Yes
l) Are there any zoning violations?	No	No
m)Is an emergency generator located to minimize noise?	N/A	Yes
n) Are there any noise, vibration, glare, fumes or other impacts?	No	No

I confirmed with Deb Andrews, Historic Preservation Manager, that the proposed site is outside of the Historic District and does not require Historic Preservation Review.

The Administrative Authorization for wireless site installation was approved by Barbara Barhydt, Development Review Services Manager on June 29, 2012 with the following condition(s) of approval listed below:

- 1. The noise attenuation as proposed shall be installed to minimize noise levels.
- 2. The emergency generator will be tested during normal business hours of 9 to 5 during the week, Monday through Friday.
- 3. The applicant shall obtain all required City Permits, including building permits from the Inspection Division (874-8703) and any other permits required from the Department of Public Services (874-8801) prior to the start of any construction.

Barbara Barhydt

Development Review Services Manager

Jackara Bartydt

Date of Approval:



Administrative Authorization Application Portland, Maine Planning and Urban Development Department, Planning Division

PRO	DJECT NAW	E: AT&T MOBILITY WIRELES	S NEW S	SITE INSTALLLATION	
PR	PROJECT ADDRESS: 25 Pearl Street CHART/BLOCK/LOT: 029 E009001				
API	PLICATION	FEE: \$50.00 (\$50.00)			
PR	OJECT DES	CRIPTION: (Please Attach Sketch/F	Plan of the	Proposal/Development)	
		3 Additional Antennas and ass			
			ooidiod o	quipmont to extensing thems,	
CO		ORMATION:	001101	III TANTIACENT	
	OWNER/AF		CONS	ULTANT/AGENT	
	Name:	AT&T Mobility	Name:		
	Address:	c/o SAI Communications	Addres	ROTALY	
		22 Keewaydin Dr		Wolfeboro, NH 03894	
	Work #:	Salem, NH	Work #	978-399-8600	
	Cell #:	(603) 531-9230	Cell #:	978-399-8600	
	Fax #:	ATT: Toby Slagle	Fax #:		
	Home #:		Home:	#:	
	E-mail:	Toby.Slagle@SAI-Comm.com	E-mail	pcooke@wellmanassociates.net	
		Administrative Authorization: .523(4) on pg .2 of this appl.)		Applicant's Assessment Planning Division Y(yes), N(no), N/A Y(yes), N(no), N/A	
a)	Is the propo	sal within existing structures?		No	
b)	AND THE RESIDENCE OF THE PROPERTY OF THE PROPE		itions?	Yes	
c)				Yes	
d)	Are there a	ny new curb cuts, driveways or parkin	ng areas?	No	
e)	Are the curl	os and sidewalks in sound condition?		Yes	
f)	Do the curb	s and sidewalks comply with ADA?		Yes	
g)	Is there any	additional parking?		No	
h)	Is there an	increase in traffic?		No	
i)		ny known stormwater problems?		No	
, j)				Yes	
k)				Yes	
) 1)		ny zoning violations?		No	
m)		gency generator located to minimize r	noise?	N/A	
n)		ny noise, vibration, glare, fumes or ot		No No	
				Date: RECEIVED 6/12/12	
	11/1	1417-1	10	JI 16/16	

Planning Division Use Only	Authorization Granted	Partial Exemption	Exemption Denied
Standard Condition of Approve from the Inspection Division (F			
Planner Signature		Date	
IMPORTANT NOTICE TO APPL from site plan review does not authorization for construction (207)874-8703, to determine w	exempt this proposal from o . You should first check with	ther required approvals the Building Inspection	ns Office, Room 315, City Hall

PROVISION OF PORTLAND CITY CODE 14-523 (SITE PLAN ORDINANCE) RE: Administrative Authorization


Sec. 14-523 (b). Applicability

No person shall undertake any development identified in Section 14-523 without obtaining a site plan improvement permit under this article. (c) Administrative Authorization. Administrative Authorization means the Planning Authority may grant administrative authorization to exempt a development proposal from complete or partial site plan review that meets the standards below, as demonstrated by the applicant.

- 1. The proposed development will be located within existing structures, and there will be no new buildings, demolitions, or building additions other than those permitted by subsection b of this section;
- 2. Any building addition shall have a new building footprint expansion of less than five hundred (500) square feet;
- The proposed site plan does not add any new curb cuts, driveways, or parking areas; the existing site has no more than
 one (1) curb cut and will not disrupt the circulation flows and parking on-site; and there will be no drive-through services
 provided;
- 4. The curbs and sidewalks adjacent to the lot are complete and in sound condition, as determined by the public works authority, with granite curb with at least four (4) inch reveal, and sidewalks are in good repair with uniform material and level surface and meet accessibility requirements of the Americans with Disabilities Act;
- 5. The use does not require additional or reduce existing parking, either on or off the site, and the project does not significantly increase traffic generation;
- There are no known stormwater impacts from the proposed use or any existing deficient conditions of stormwater management on the site;
- 7. There are no evident deficiencies in existing screening from adjoining properties; and
- 8. Existing utility connections are adequate to serve the proposed development and there will be no disturbance to or improvements within the public right-of-way.
- 9. There are no current zoning violations;
- 10. Any emergency generators are to be located to minimize noise impacts to adjoining properties and documentation that routine testing of the generators occur on weekdays between the hours of 9 a.m. to 5 p.m. Documentation pertaining to the noise impacts of the emergency generator shall be submitted; and
- 11. There is no anticipated noise, vibration, glare, fumes or other foreseeable impacts associated with the project.
- a. Filing the Application. An applicant seeking an administrative authorization under this subsection shall submit an administrative authorization application for review, detailing the site plan with dimensions of proposed improvements and distances from all property lines, and stating that the proposal meets all of the provisions in standards 1-11 of Section 14-423 (b)1. The application must be accompanied by an application fee of \$50.
- b. **Review.** Upon receipt of such a complete application, the Planning Authority will process it and render a written decision of approval, approval with conditions or denial, with all associated findings.
- c. Decision. If a full administrative authorization is granted, the application shall be approved without further review under this article, and no performance guarantee shall be required. In the event that the Planning Authority determines that standards a and b of Section 14-523 (b) (1) and at least four (4) of the remaining standards have been met, the Planning Authority shall review the site plan according to all applicable review standards of Section 14-526 that are affected by the standards in this subsection that have not been met. If an exemption or partial exemption from site plan review is not granted, the applicant must submit a site plan application that will undergo a full review by the Planning Board or Planning Authority according to the standards of Section 14-526.



CUSTOM HOUSE GARAGE SITE NO.: ME2976 25 PEARL STREET PORTLAND, ME 04101

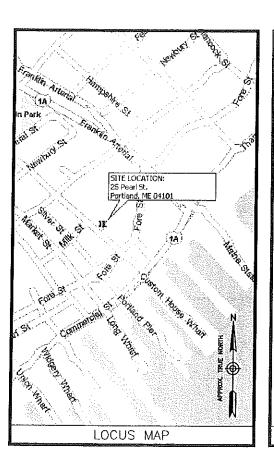

FROM FRAMINGHAM: TAKE I-90 E/MASSPIKE. TAKE EXIT 14 FOR I-95 N. SLIGHT RIGHT ONTO I-295 N. TAKE THE EXIT TOWARD S. PORTLAND. CONTINUE STRAIGHT ONTO VETERANS MEMORIAL BRIDGE. TURN RIGHT ONTO W COMMERCIAL ST/US-1. TURN LEFT ONTO PEARL ST. DESTINATION WILL BE ON THE RIGHT.

ENGINEER
DEWBERRY
280 SUMMER STREET
10TH FLOOR
80STON, MA 02210

PHONE # (617) 695-3400 FAX # (617) 695-3310 CONTACT: BENJAMIN REVETTE

SITE ACQUISITION
WELLMAN ASSOCIATES, INC.
70 BROADWAY STREET
P.O. BOX 738
WESTFORD, MA 01886

PHONE # (978) 846-4954 CONTACT: GIN VILANTE

CONSTRUCTION
SAI COMMUNICATIONS
22 KEEWAYDIN DRIVE
SALEM, NH 03079

PHONE # (603) 531-9230 FAX # (603) 893-1104

CONTACT: TOBY SLAGLE

CONSULTANT TEAM

SITE NAME: CUSTOM HOUSE GARAGE

PROPERTY OWNER: 25 PEARL MHR LLC. P.O. BOX 748B PORTLAND, ME 04112

APPLICANT/DEVELOPER:

AT&T MOBILITY

550 COCHITUATE ROAD
SUITES 13 & 14

FRAMINGHAM, MA 01701

ELECTRIC UTILITY: CENTRAL MAINE POWER (800) 696-1000

TELEPHONE UTILITY: FAIRPOINT (866) 984-3001

COORDINATES:*
LATITUDE: 43" 39" 27.68" N
LONGITUDE: 70" 15" 07.51" W
*PER 1A SURVEY

PROJECT SUMMARY

SITE ADDRESS: 25 PEARL STREET PORTLAND, ME 04101

MAP/LOT; MAP 29 LOT E009001

ZONING DISTRUCT 83-DOWNTOWN BUSINESS

PROJECT DIRECTORY

A PROPOSED EQUIPMENT SHELTER AND DIESEL GENERATOR AT GRADE. TWELVE (12) PANEL ANTENNAS WILL BE INSTALLED (4/SECTOR) ON THE BUILDING FACADE. POWER & TELCO WILL COME FROM EXISTING SOURCES ON SITE.

PROJECT DESCRIPTION

THIS DOCUMENT WAS DEVELOPED TO REFLECT A SPECIFIC SITE AND ITS SITE CONDITIONS AND IS NOT TO BE USED FOR ANOTHER SITE OR WHEN OTHER CONDITIONS PERTAIN. REUSE OF THIS DOCUMENT IS AT THE SOLE RISK OF THE USER.

A.D.A. COMPLIANCE: FACILITY IS UNMANNED AND NOT FOR HUMAN HABITATION.

T-1 TITLE SHEET G-1 GENERAL NOTES A-1 ABUTTERS PLAN C-1 PROPOSED SITE PLAN & EQUIPMENT PLAN C-2 ELEVATIONS C-3 CONSTRUCTION DETAILS - ! C-4 CONSTRUCTION DETAILS - !! C-5 CONSTRUCTION DETAILS - !! C-6 ANTENNA B.O.M. & ANTENNA DETAILS
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C-4 CONSTRUCTION DETAILS - II C-5 CONSTRUCTION DETAILS - III
C-5 CONSTRUCTION DETAILS - III
C-6 ANTENNA B.O.M. & ANTENNA DETAILS
E-1 ELECTRICAL RISER DIAGRAM
E-2 SCHEMATIC GROUNDING PLAN
E-3 GROUNDING DETAILS
SHEET INDEX



550 COCHITUATE ROAD SUITES 13 & 14 FRAMINGHAM, MA 01701

CUSTOM HOUSE GARAGE SITE NO.: ME2976



22 KEEWAŸDIN ƏRIVE SALEM, NH 03079

CC	NSTRUCT	ION	DRAWINGS	3
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Α	04/06/11	FOI	R COMMENT	_



Dewberry Engineers, Inc. 280 SUMMER STREET 10TH FLOOR BOSTON, MA 02210 PAN BET BY 1895-3400 FAX 817 1895-3310

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REVIEWED BY: DAS

CHECKED BY: PPB

PROJECT NUMBER: 50003936

JOB NUMBER: 50041016

SITE ADDRESS

25 PEARL STREET PORTLAND, ME 04101

SHEET TITLE

TITLE SHEET

SHEET NUMBI

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GENERAL CONSTRUCTION NOTES:

- ALL WORK SHALL CONFORM TO ALL CURRENT APPLICABLE FEDERAL, STATE, AND LOCAL CODES, INCLUDING ANSI/EIA/TIA-222, AND COMPLY WITH AT&T MOBILITY SPECIFICATIONS.
- CONTRACTOR SHALL CONTACT "DIG SAFE 1888 DIG SAFE" (888-344-7233) FOR IDENTIFICATION OF UNDERGROUND UTILITIES PRIOR TO START
 OF CONSTRUCTION.
- 3. CONTRACTOR IS RESPONSIBLE FOR COORDINATING ALL REQUIRED INSPECTIONS.
- ALL DIMENSIONS TO, OF, AND ON EXISTING BUILDINGS, DRAINAGE STRUCTURES, AND SITE IMPROVEMENTS SHALL BE VERIFIED IN FIELD BY CONTRACTOR WITH ALL DISCREPANCIES REPORTED TO THE ENGINEER.
- 5. DO NOT CHANGE SIZE OR SPACING OF STRUCTURAL ELEMENTS.
- 6. DETAILS SHOWN ARE TYPICAL; SIMILAR DETAILS APPLY TO SIMILAR CONDITIONS UNLESS OTHERWISE NOTED,
- THESE DRAWINGS DO NOT INCLUDE NECESSARY COMPONENTS FOR CONSTRUCTION SAFETY WHICH IS THE SOLE RESPONSIBILITY OF THE CONTRACTOR.
- 8. CONTRACTOR SHALL BRACE STRUCTURES UNTIL ALL STRUCTURAL ELEMENTS NEEDED FOR STABILITY ARE INSTALLED. THESE ELEMENTS ARE AS FOLLOWS: LATERAL BRACING, ANCHOR BOLTS, ETC.
- 9. CONTRACTOR SHALL DETERMINE EXACT LOCATION OF EXISTING UTILITIES, GROUNDS DRAINS, DRAIN PIPES, VENTS, ETC. BEFORE COMMENCING
- 10. INCORRECTLY FABRICATED, DAMAGED, OR OTHERWISE MISFITTING OR NONCONFORMING MATERIALS OR CONDITIONS SHALL BE REPORTED TO THE OWNER PRIOR TO REMEDIAL OR CORRECTIVE ACTION. ANY SUCH REMEDIAL ACTION SHALL REQUIRE WRITTEN APPROVAL BY THE OWNER'S REPRESENTATIVE PRIOR TO PROCEEDING.
- 11. EACH CONTRACTOR SHALL COOPERATE WITH THE OWNER'S REPRESENTATIVE, AND COORDINATE HIS WORK WITH THE WORK OF OTHERS.
- 12. CONTRACTOR SHALL REPAIR ANY DAMAGE CAUSED BY CONSTRUCTION OF THIS PROJECT TO MATCH EXISTING PRE-CONSTRUCTION CONDITIONS TO THE SATISFACTION OF THE AT&T MOBILITY CONSTRUCTION MANAGER.
- 13. ALL CABLE/CONDUIT ENTRY/EXIT PORTS SHALL BE WEATHERPROOFED DURING INSTALLATION USING A SILICONE SEALANT.
- 14. WHERE EXISTING CONDITIONS DO NOT MATCH THOSE SHOWN IN THIS PLAN SET, CONTRACTOR WILL NOTIFY ENGINEER, AT&T MOBILITY PROJECT CONSTRUCTION MANAGER, AND LANDLORD IMMEDIATELY.
- CONTRACTOR SHALL ENSURE ALL SUGCONTRACTORS ARE PROVIDED WITH A CURRENT SET OF DRAWINGS AND SPECIFICATIONS FOR THIS
 PROJECT.
- 16. ALL ROOF WORK SHALL BE DONE BY A QUALIFIED AND EXPERIENCED ROOFING CONTRACTOR IN COORDINATION WITH ANY CONTRACTOR WARRANTING THE ROOF TO ENSURE THAT THE WARRANTY IS MAINTAINED.
- 17. CONTRACTOR SHALL REMOVE ALL RUBBISH AND DEBRIS FROM THE SITE AT THE END OF EACH DAY.
- 18. CONTRACTOR SHALL COORDINATE WORK SCHEDULE WITH LANDLORD AND TAKE PRECAUTIONS TO MINIMIZE IMPACT AND DISRUPTION OF OTHER OCCUPANTS OF THE FACILITY.
- 19. CONTRACTOR SHALL FURNISH AT&T MOBILITY WITH THREE AS-BUILT SETS OF DRAWINGS LIPON COMPLETION OF WORK.
- 20. ANTENNAS AND CABLES ARE TYPICALLY PROVIDED BY AT&T MOBILITY. PRIOR TO SUBMISSION OF BID, CONTRACTOR SHALL COORDINATE WITH AT&T MOBILITY PROJECT MANAGER TO DETERMINE WHAT, IF ANY, ITEMS WILL BE PROVIDED BY AT&T MOBILITY WIRELESS. ALL ITEMS NOT PROVIDED BY AT&T MOBILITY SHALL BE PROVIDED AND INSTALLED BY THE CONTRACTOR. CONTRACTOR WILL INSTALL ALL ITEMS PROVIDED BY AT&T MOBILITY.
- 21. CONTRACTOR SHALL PROVIDE A 40 PINT DEHUMIDIFIER (GENERAL ELECTRIC OR WHITE WESTINGHOUSE) AND BASE TO BE INSTALLED IN THE EQUIPMENT SHELTER. THE BASE SHALL BE CONSTRUCTED OF 3/8" THICK (MIN.) PLYWOOD AND PAINTED TO MATCH THE SHELTER INTERIOR. CONTRACTOR SHALL INSTALL A DRAINAGE TUBE FROM THE DEHUMIDIFIER THROUGH A WALL PENETRATION IN THE SHELTER WALL CONTRACTOR SHALL SEAL THE WALL PENETRATION WITH SILCONE SEALANT AND ENSURE THAT IT IS WATERTIGHT. THE EXACT SIZE OF THE BASE SHALL BE COORDINATED WITH DEHUMIDIFIER SPECIFICATIONS AND LOCATION OF DRAIN HOLE.
- 22. PRIOR TO SUBMISSION OF BID, CONTRACTOR WILL COORDINATE WITH AT&T MOBILITY PROJECT MANAGER TO DETERMINE IF ANY PERMITS WILL BE OBTAINED BY AT&T MOBILITY. ALL REQUIRED PERMITS NOT OBTAINED BY AT&T MOBILITY MUST BE OBTAINED, AND PAID FOR, BY THE CONTRACTOR.
- 23. CONTRACTOR SHALL START UP HVAC UNITS AND SYNCHRONIZE THE THERMOSTATS.
- 24. CONTRACTOR SHALL INSTALL ALL SITE SIGNAGE IN ACCORDANCE WITH AT&T MOBILITY SPECIFICATIONS AND REQUIREMENTS.
- 25. CONTRACTOR SHALL SUBMIT ALL SHOP DRAWINGS TO ENGINEER FOR REVIEW AND APPROVAL PRIOR TO FABRICATION.
- 26. UNLESS OTHERWISE NOTED AT&T MOBILITY SHALL PROVIDE ALL REQUIRED RF MATERIAL FOR CONTRACTOR TO INSTALL, INCLUDING ANTENNAS, TMA'S, BIAS-T'S, COMBINERS, PDU, DC BLOCKS, SURGE ARRESTORS, GPS ANTENNA, GPS SURGE ARRESTOR, COAXIAL CABLE.
- 27. PRIOR TO SUBMISSION OF BID, CONTRACTOR SHALL VERIFY ALL EQUIPMENT TO BE PROVIDED BY AT&T MOBILITY FOR INSTALLATION BY CONTRACTOR.
- 28. ALL EQUIPMENT SHALL BE INSTALLED ACCORDING TO MANUFACTURER'S SPECIFICATIONS AND LOCATED ACCORDING TO AT&T MOBILITY SPECIFICATIONS, AND AS SHOWN IN THESE PLANS.
- 29. THE CONTRACTOR SHALL SUPERVISE AND DIRECT THE PROJECT DESCRIBED HEREIN, THE CONTRACTOR SHALL BE SOLEY RESPONSIBLE FOR ALL THE CONSTRUCTION MEANS, METHODS, TECHNIQUES, SEQUENCES AND PROCEDURES AND FOR COORDINATING ALL PORTIONS OF THE WORK UNDER THE CONTRACT.
- 30. EQUIPMENT SHELTER SHALL HAVE ONE (1) EXTERIOR MOTION DETECTOR OPERATED 100-WATT LIGHT WITH DOWNWARD REFLECTOR SHIELD.
- 31. CONTRACTOR SHALL NOTIFY THE ENGINEER A MINIMUM OF 48 HOURS IN ADVANCE PRIOR TO CONSTRUCTION START, MORE SPECIFICALLY BEFORE; SEALING ANY FLOOR, WALL OR ROOF PENETRATION, FINAL UTILITY CONNECTIONS, POURING CONCRETE, BACKFILLING UTILITY TRENCHES AND STRUCTURAL POST OR MOUNTING CONNECTIONS, FOR ENGINEERING REVIEW AND INSPECTION.
- 32. CONTRACTOR SHALL BE RESPONSIBLE FOR SITE SAFETY INCLUDING COMPLIANCE WITH ALL APPLICABLE OSHA STANDARDS AND RECOMMENDATIONS AND SHALL PROVIDE ALL NECESSARY SAFETY DEVICES INCLUDING PPE AND PPM AND CONSTRUCTION DEVICES SUCH AS WELDING AND FIRE PREVENTION, TEMPORARY SHORING, SCAFFOLDING, TRENCH BOXES/SLOPING, BARRIERS, ETC.

GENERAL FOUNDATION NOTES:

- THOROUGHLY COMPACT BOTTOM OF EXCAVATIONS PRIOR TO PLACING RIGID INSULATION BARRIER, BACKFILL AND COMPACTION
 PROCEDURES SHALL BE DONE PER INDUSTRY STANDARDS.
- ALL REINFORCING STEEL SHALL BE ASTM A615 GRADE 60. SECURE REINFORCING IN PLACE TO PREVENT MOVEMENT DURING CONCRETE PLACEMENT.
- 3. PROVIDE A CLEAR COVER OF 2" FOR ALL REINFORCING STEEL. THIS REQUIREMENT SHALL BE CONSIDERED ACTUAL AND SHOULD NOT BE ADJUSTED IN THE FIELD.
- 4. VERIFY DETAILS AND DIMENSIONS WITH SHELTER DRAWINGS, NOTIFY AT&T MOBILITY OF ANY DISCREPANCIES.
- 5. ALL WORK SHALL COMPLY WITH THE LOCAL AND STATE BUILDING CODES.
- INSULATION BARRIER PROVIDED IS FOR FROST PROTECTION IN LIEU OF STANDARD FOUNDATIONS WITH BEARING AT CODE REQUIRED FROST DEPTH.
- 7. SHELTER MUST BE ANCHORED TO ITS FOUNDATION, ANCHOR IN ACCORDANCE WITH SHELTER MANUFACTURER SPECIFICATIONS.

CONCRETE AND REINFORCING STEEL NOTES:

- DESIGN AND CONSTRUCTION OF ALL CONCRETE ELEMENTS SHALL CONFORM TO THE LATEST EDITIONS OF ALL APPLICABLE CODES INCLUDING: ACI 301 "SPECIFICATIONS FOR STRUCTURAL CONCRETE FOR BUILDINGS", AND ACI 318 "BUILDING CODE REQUIREMENTS FOR REINFORCED CONCRETE".
- 2. MIX DESIGN SHALL BE APPROVED BY OWNER'S REPRESENTATIVE AND SUBMITTED TO ENGINEER PRIOR TO PLACING CONCRETE.
- CONCRETE SHALL BE NORMAL WEIGHT, 6 % AIR ENTRAINED (+/- 1.5%) WITH A MAXIMUM 4" SLUMP AND HAVE A MINIMUM 28-DAY COMPRESSIVE STRENGTH OF 4000 PSI UNLESS OTHERWISE NOTED.
- 4. THE FOLLOWING MATERIALS SHALL BE USED:
 PORTLAND CEMENT: ASTM C-150, TYPE 1 OR 2
 REINFORCEMENT: ASTM A-185, PLAIN STEEL WELDED WIRE FABRIC
 REINFORCEMENT BARS: ASTM A615, GRADE 60, DEFORMED
 NORMAL WEIGHT AGGREGATE: ASTM C-33
 WATER: DRINKABLE
 ADMIXTURES: NON-CHLORIDE CONTAINING
- MINIMUM CONCRETE COVER FOR REINFORCING STEEL SHALL BE AS FOLLOWS (UNLESS OTHERWISE NOTED):
 A. CONCRETE CAST AGAINST EARTH: 3"
- A 3/4" CHAMFER SHALL BE PROVIDED AT ALL EXPOSED EDGES OF CONCRETE IN ACCORDANCE WITH ACI 301 SECTION 4.2.4, UNLESS NOTED OTHERWISE.
- 7. INSTALLATION OF CONCRETE EXPANSION/WEDGE ANCHOR SHALL BE PER MANUFACTURER'S WRITTEN RECOMMENDED PROCEDURE. THE ANCHOR BOLT, DOWEL, OR ROD SHALL CONFORM TO MANUFACTURER'S RECOMMENDATION FOR EMBEDMENT DEPTH OR AS SHOWN ON THE DRAWINGS. NO REBAR SHALL BE CUT WITHOUT PRIOR ENGINEERING APPROVAL WHEN DRILLING HOLES IN CONCRETE.
- 8. ADMIXTURES SHALL CONFORM TO THE APPROPRIATE ASTM STANDARD AS REFERENCED IN ACI 301.
- 9. DO NOT WELD OR TACK WELD REINFORCING STEEL,
- 10. ALL DOWELS, ANCHOR BOLTS, EMBEDDED STEEL, ELECTRICAL CONDUITS, PIPE SLEEVES, GROUNDS AND ALL OTHER EMBEDDED ITEMS AND FORMED DETAILS SHALL BE IN PLACE BEFORE START OF CONCRETE PLACEMENT.
- 11. REINFORCEMENT SHALL BE COLD BENT WHENEVER BENDING IS REQUIRED.
- 12. DO NOT PLACE CONCRETE IN WATER, ICE, OR ON FROZEN GROUND.
- DO NOT ALLOW REINFORCEMENT, CONCRETE OR SUBBASE TO FREEZE DURING CONCRETE CURING AND SETTING PERIOD, OR FOR A MINIMUM OF 3 DAYS AFTER PLACEMENT.
- 14. FOR COLD-WEATHER AND HOT-WEATHER CONCRETE PLACEMENT, CONFORM TO APPLICABLE ACI CODES AND RECOMMENDATIONS. IN EITHER CASE, MATERIALS CONTAINING CHLORIDE, CALCIUM, SALTS, ETC. SHALL NOT BE USED. PROTECT FRESH CONCRETE FROM WEATHER FOR 7 DAYS, MINIMUM.
- 15. CONCRETE SHALL BE RUBBED TO A ROUGH GROUT FINISH. PADS SHALL BE SEALED BY STEEL TROWEL
- 15. UNLESS OTHERWISE NOTED:
- A. ALL REINFORCING STEEL SHALL BE DEFORMED BARS CONFORMING TO ASTM A615, GRADE 60.
- B. WELDED WIRE FABRIC SHALL CONFORM TO ASTM A185.
- 17. SPLICING OF REINFORCEMENT IS PERMITTED ONLY AT LOCATIONS SHOWN IN THE CONTRACT DRAWINGS OR AS ACCEPTED BY THE ENGINEER. UNLESS OTHERWISE SHOWN OR NOTED REINFORCING STEEL SHALL BE SPLICED TO DEVELOP ITS FULL TENSILE CAPACITY (CLASS A) IN ACCORDANCE WITH ACL 318.
- 18. REINFORCING BAR DEVELOPMENT LENGTHS, AS COMPUTED IN ACCORDANCE WITH ACI 318, FORM THE BASIS FOR BAR EMBEDMENT LENGTHS AND BAR SPLICED LENGTHS SHOWN IN THE DRAWINGS. APPLY APPROPRIATE MODIFICATION FACTORS FOR TOP STEEL, BAR SPACING, COVER AND THE LIKE.
- DETAILING OF REINFORCING STEEL, SHALL CONFORM TO "ACI MANUAL OF STANDARD PRACTICE FOR DETAILING REINFORCED CONCRETE STRUCTURES" (ACI 315).
- 20. ALL SLAB CONSTRUCTION SHALL BE CAST MONOLITHICALLY WITHOUT HORIZONTAL CONSTRUCTION JOINTS, UNLESS SHOWN IN THE CONTRACT DRAWINGS.
- 21. LOCATION OF ALL CONSTRUCTION JOINTS ARE SUBJECT TO THE REQUIREMENTS OF THE CONTRACT DOCUMENTS, CONFORMANCE WITH ACI 318, AND ACCEPTANCE OF THE ENGINEER. DRAWINGS SHOWING LOCATION OF DETAILS OF THE PROPOSED CONSTRUCTION JOINTS SHALL BE SUBMITTED WITH REINFORCING STEEL PLACEMENT DRAWINGS
- 22. SPLICES OF WWF, AT ALL SPLICED EDGES, SHALL BE SUCH THAT THE OVERLAP MEASURED BETWEEN OUTERMOST CROSS WIRES OF EACH FABRIC SHEET IS NOT LESS THAN THE SPACING OF THE CROSS WIRE PLUS 2 INCHES, NOR LESS THAN 8".
- 23. BAR SUPPORTS SHALL BE ALL-GALVINIZED METAL WITH PLASTIC TIPS.
- 24. ALL REINFORCEMENT SHALL BE SECURELY TIED IN PLACE TO PREVENT DISPLACEMENT BY CONSTRUCTION TRAFFIC OR CONCRETE. TIE WIRE SHALL BE 16 GAUGE CONFORMING TO ASTM A82
- 25. SLAB ON GROUND
- A. COMPACT STRUCTURAL FILL TO 95% DENSITY AND THEN PLACE 6" GRAVEL BENEATH SLAB.
- B. PROVIDE VAPOR BARRIER BENEATH SLAB ON GROUND.



550 COCHITUATE ROAD SUITES 13 & 14 FRAMINGHAM, MA 01701

CUSTOM HOUSE GARAGE SITE NO.: ME2976



22 KEEWAYDIN DRIVE SALEM, NH 03079 NSTRUCTION DRAWII

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REVIEWED BY:	DAS
CHECKED BY:	PPB

JOB NUMBER:	50041016
	

50003936

PROJECT NUMBERS


25 PEARL STREET PORTLAND, ME 04101

SHEET TITLE

GENERAL NOTES

SHEET NUMBER

G - 1

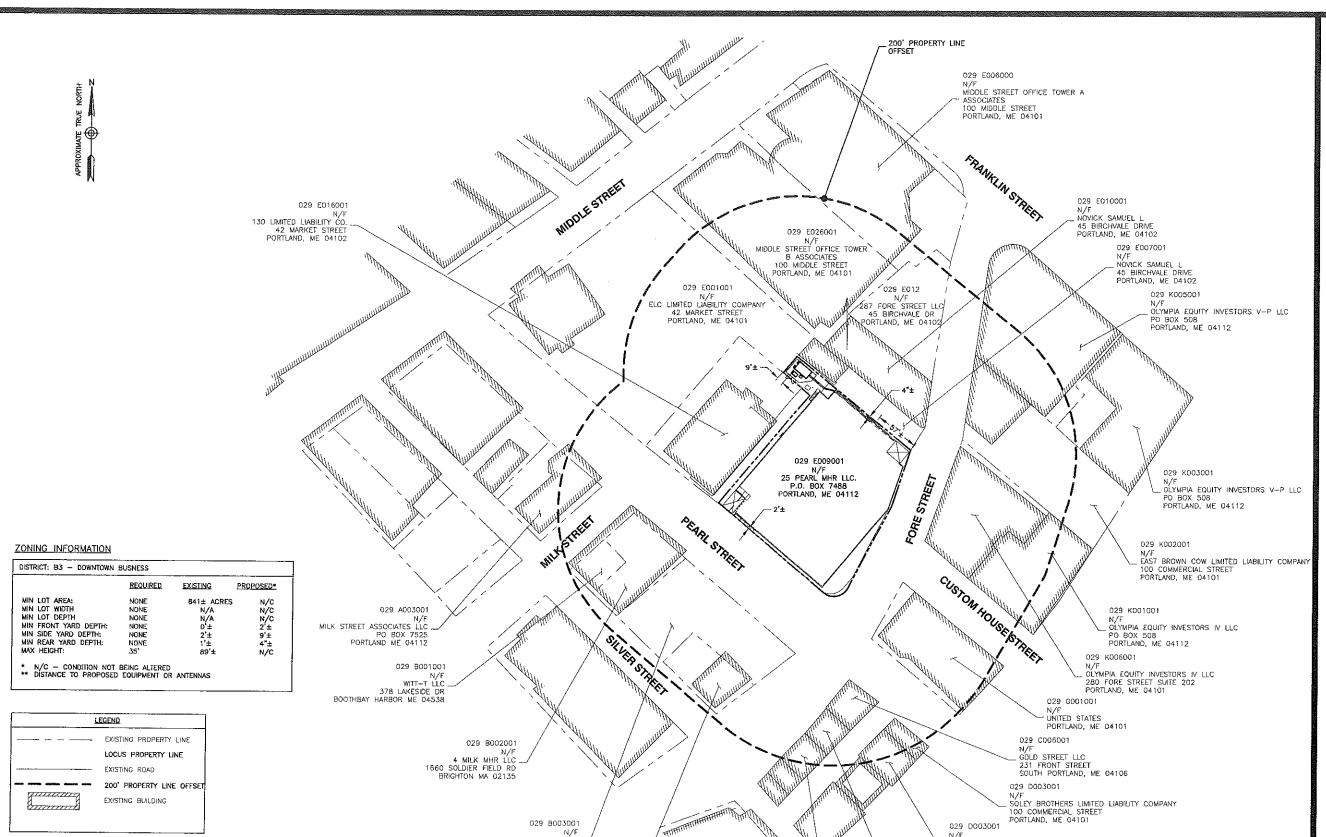


NOTES:

- 1. SOME EXISTING INFORMATION IS NOT SHOWN FOR CLARITY.
- 2. NORTH ARROW SHOWN AS APPROXIMATE.
- PLOT PLAN BASED ON INFORMATION OBTAINED FROM THE ONLINE CIS VIEWER FOR THE TOWN OF PORTLAND, ME (ACCESSED 02-27-12). ABUTTERS WITHIN 200 FEET OF SUBJECT PARCEL ARE SHOWN.
- PLOT PLAN HAS NOT BEEN VERIFIED THROUGH A COMPLETE BOUNDARY SURVEY. ALL ITEMS AND DISTANCES SHOWN AS APPROXIMATE.

LOCUS PROPERTY OWNER::

25 PEARL MHR LLC. P.O. BOX 7488 PORTLAND, ME 04112

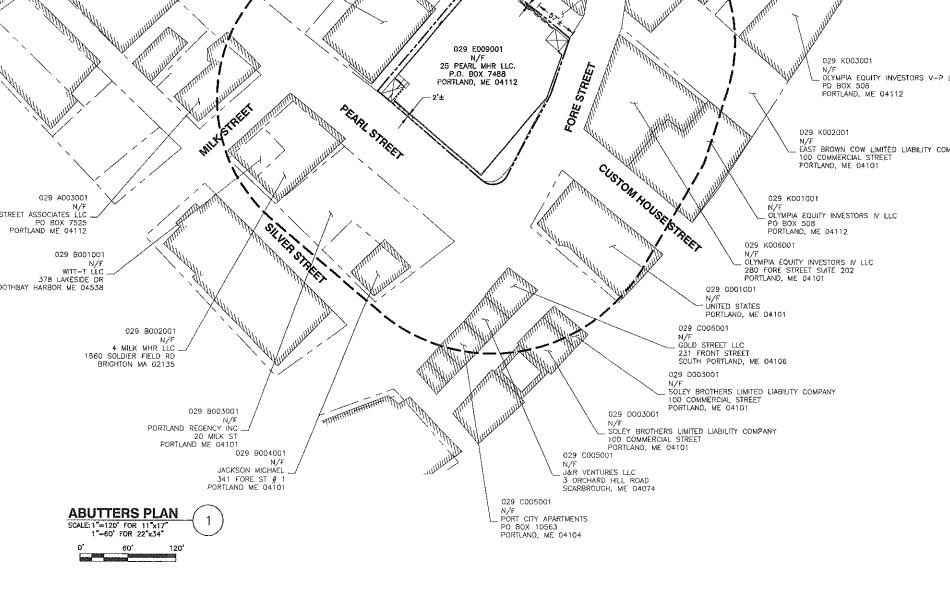



550 COCHITUATE ROAD SUITES 13 & 14 FRAMINGHAM, MA 01701

CUSTOM HOUSE GARAGE SITE NO.: ME2976



22 KEEWAYDIN DRIVE SALEM, NH 03079

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PROJECT NUMBER: 50003936 JOB NUMBER: 50041016


SITE ADDRESS

25 PEARL STREET PORTLAND, ME 04101

SHEET TITLE

ABUTTERS PLAN

SHEET NUMBER

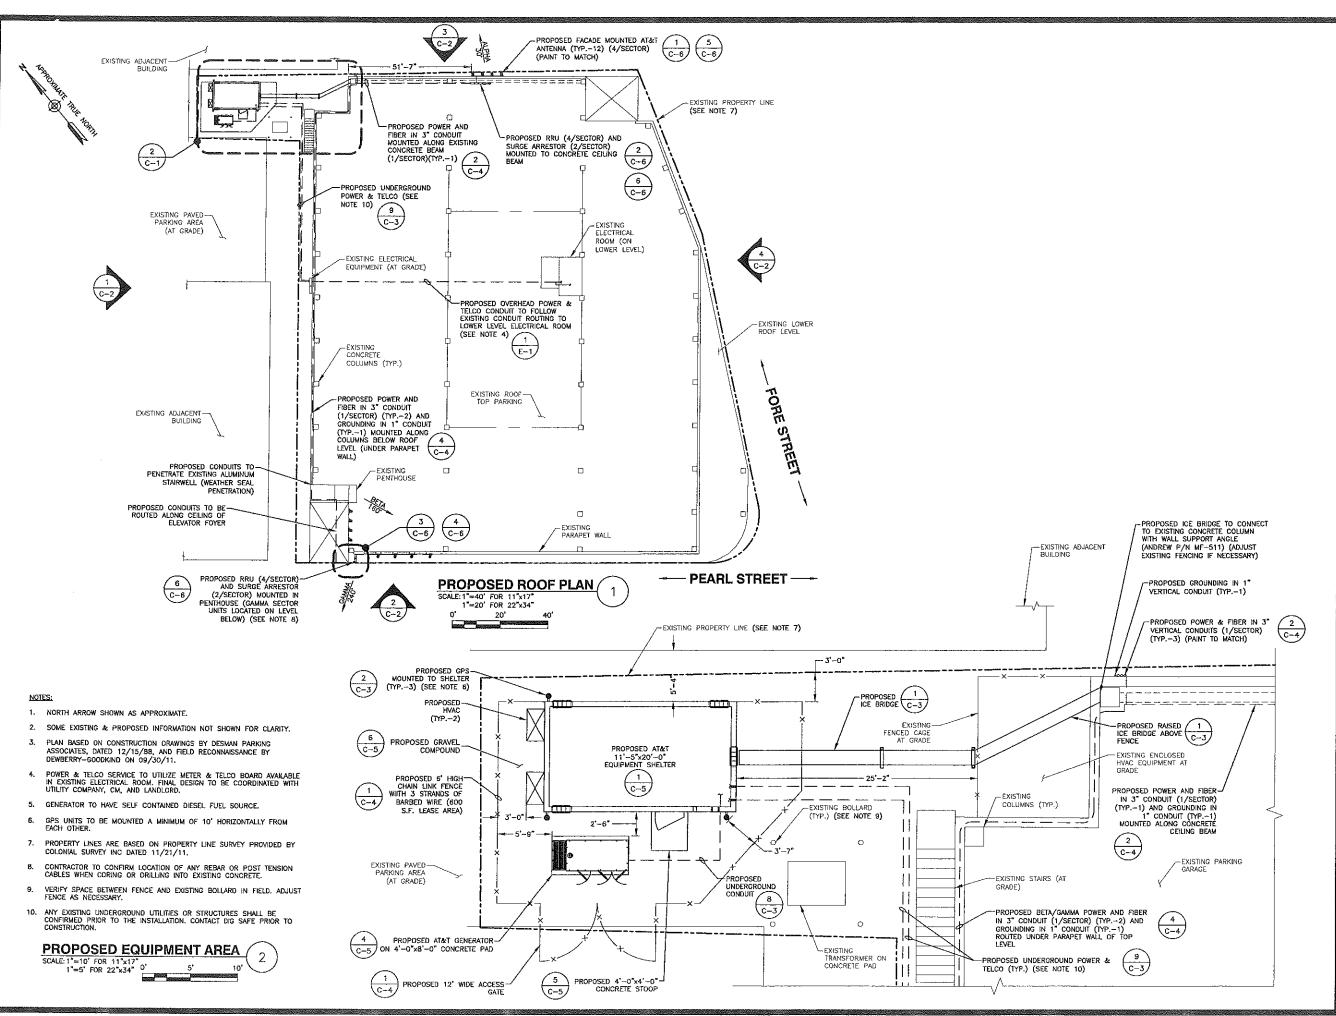



550 COCHITUATE ROAD SUITES 13 & 14 FRAMINGHAM, MA 01701

CUSTOM HOUSE GARAGE SITE NO.: ME2976



22 KEEWAYDIN DRIVE SALEM, NH 03079

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Dewberry*

Dewberry Engineers, Inc. 280 SUMMER STREET
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FAX: 6(7.695.340)


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DRAWN BY:	JIM
REVIEWED BY:	DAS
CHECKED BY:	PPB
PROJECT NUMBER:	50003936
JOB NUMBER:	50041016

25 PEARL STREET PORTLAND, ME 04101

SITE ADDRESS

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& EQUIPMENT PLAN
PROPOSED SITE PLAN
SHEET TITLE

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550 COCHITUATE ROAD SUITES 13 & 14 FRAMINGHAM, MA 01701

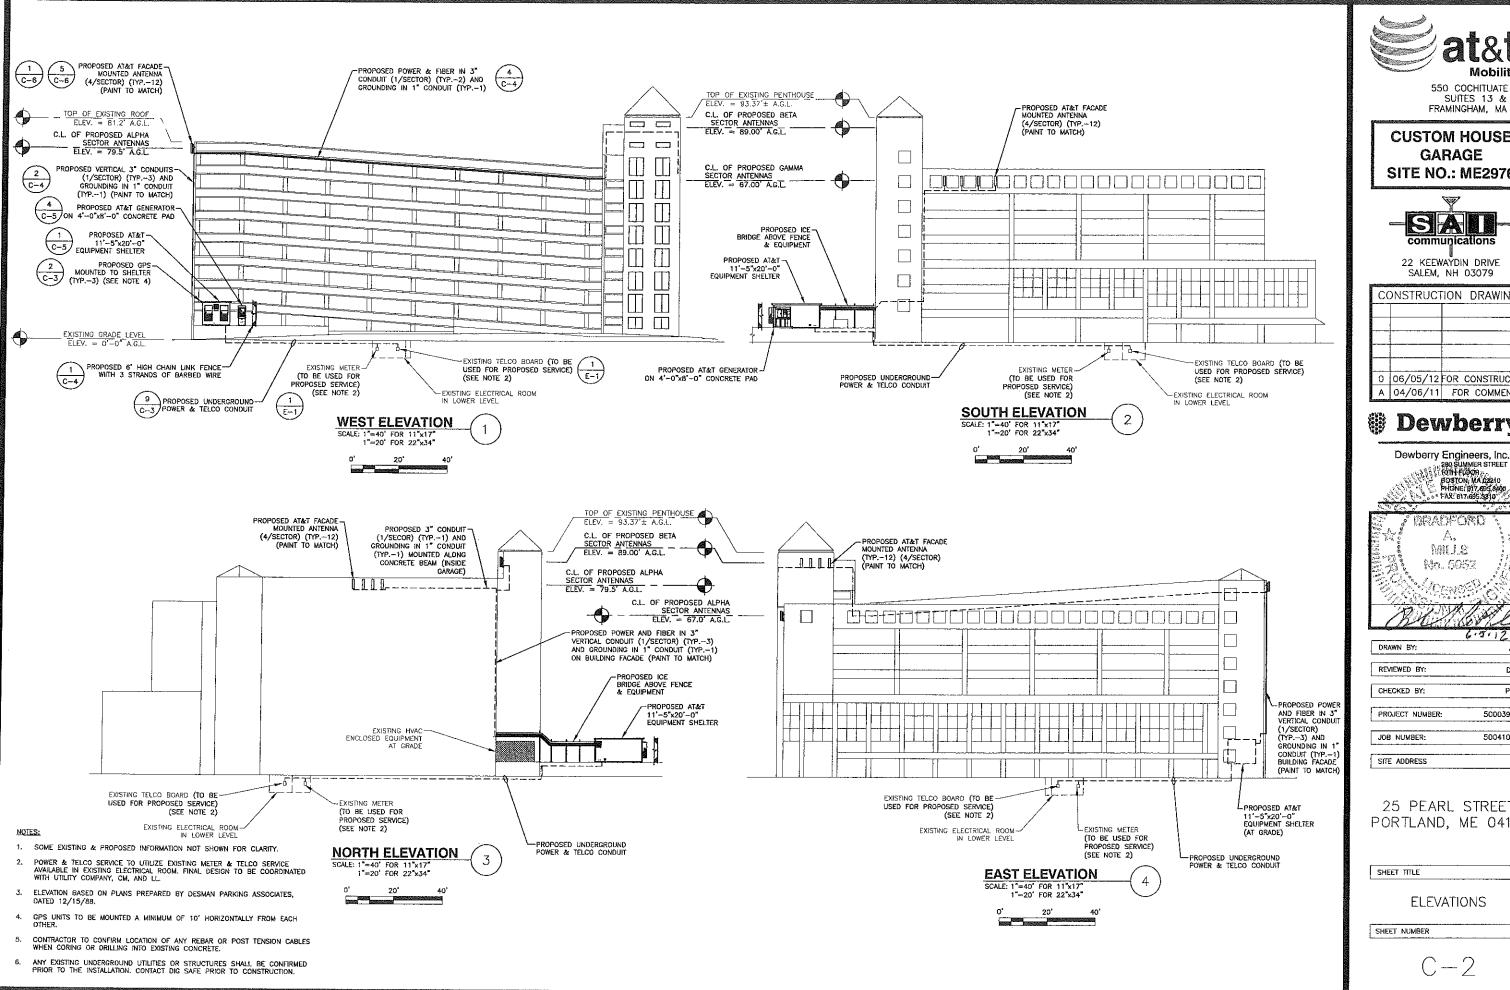CUSTOM HOUSE GARAGE **SITE NO.: ME2976**



22 KEEWAYDIN DRIVE SALEM, NH 03079

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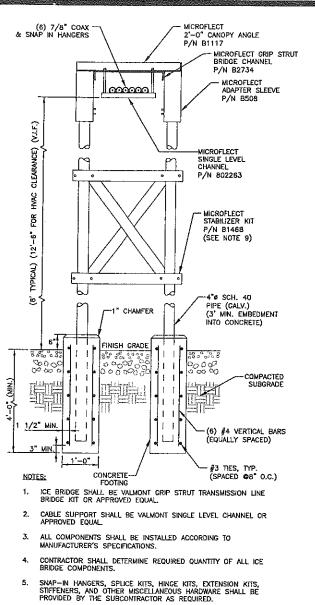
280 SUMMER STREET ROTH FLOOR BOSTON, WA 02210 PHONE 1917, 695, 6160 TAX: 617, 695, 5310

JIM DAS PPB


50041016


50003936

25 PEARL STREET PORTLAND, ME 04101



- ICE BRIDGE SHALL BE ROUTED TO ACCOMMODATE THE MINIMUM BENDING RADIUS OF THE COAXIAL CABLE.
- ICE BRIDGE COMPONENTS SHOWN ARE SCHEMATIC, CONSULT MANUFACTURER FOR EXACT AND CURRENT SPECIFICATIONS.
- 8. SUPPORT COLUMNS TO BE LOCATED AT 10'-0" O.C. MAX.
- STABILIZER KIT SHALL BE UTILIZED FOR RAISED ICE BRIDGE POSTS REQUIRED TO CLEAR EXISTING FENCING.

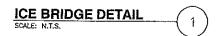


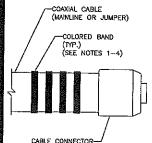


- . COLOR CODING SHALL BE PLACED ON GOTH ENDS OF ALL MAINLINE COAXIAL CABLES AND ALL JUMPER CABLES NEAT THE CONNECTORS. COLOR CODING SHALL ALSO BE PLACED ON EACH MAINLINE COAX ON THE EXTERIOR OF THE SHELTER NEAR THE CABLE PORT.
- 2. COLORED TAPE SHALL BE MINIMUM 3/4" WIDE.
- THE SPACING BETWEEN THE COLORED BANDS SHALL NOT BE LESS THAN THE THICKNESS OF THE COLORED TAPE.
- . COLOR AND QUANTITY OF COLORED BANDS SHALL BE AS SPECIFIED IN THE RF SCHEDULE.

CABLE COLOR CODING DETAIL SCALE: N.T.S.



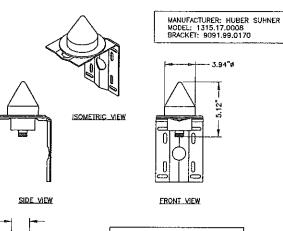


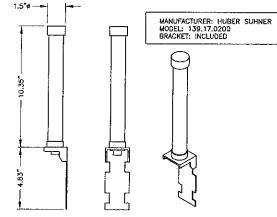


SIDE_VIEW FRONT_VIEW ISOMETRIC VIEW NOTES: GROUND ANTENNAS AND MOUNTS PER MANUFACTURERS RECOMMENDATIONS AND AT&T STANDARDS.

- 2. FIELD LOCATE GPS ANTENNAS WITH AT&T CM APPROVAL
- 3. MOUNT ANTENNAS PER MANUFACTURERS RECOMMENDATIONS.
- 4. PIPE MOUNT GPS TO CABLE BRIDGE WITH REQUIRED




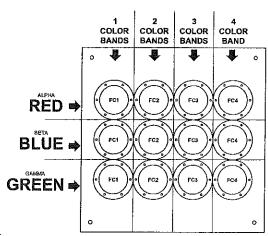


INTERIOR VIEW COAX COLOR CODING AND LABELING DETAIL

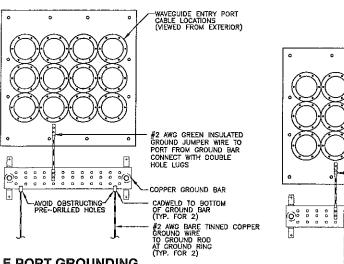

CABLE PORT GROUNDING EXTERIOR OF SHELTER (EXTERIOR VIEW)

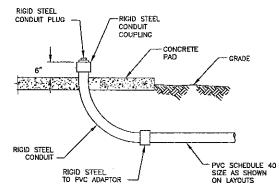


UNDERGROUND CONDUIT STUB-UP DETAIL

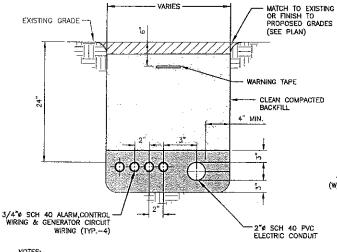

NOTES:

- IF FREE OF ORGANIC OR OTHER DELETERIOUS MATERIAL, EXCAVATED MATERIAL MAY BE USED FOR BACKFILL.
- IF NOT, PROVIDE CLEAN, COMPACTIBLE MATERIAL. COMPACT IN 8" LIFTS. REMOVE ANY LARGE ROCKS PRIOR TO BACKFILLING. CONTRACTOR TO VERIFY LOCATION OF EXISTING U/G UTILITIES PRIOR TO DIGGING.
- 3. IF CURRENT AS-BUILT DRAWINGS ARE NOT AVAILABLE CONTRACTOR SHALL HAND DIG U/G TRENCHING.


GENERATOR SERVICE TRENCH CONDUIT SCALE: N.T.S.

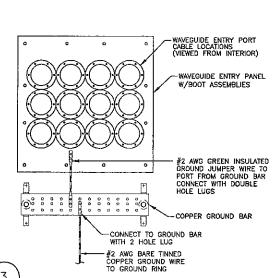

NOTE:

CONTRACTOR SHALL INSTALL AS SHOWN UNLESS GROUND BAR IS PREINSTALLED BY SHELTER

CABLE PORT GROUNDING ON INTERIOR OF SHELTER (INTERIOR VIEW)

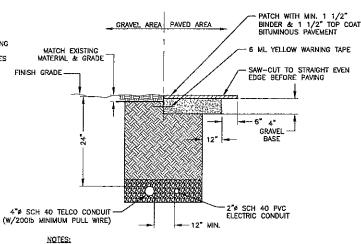

IF FREE OF ORGANIC OR OTHER DELETERIOUS MATERIAL, EXCAVATED MATERIAL MAY BE USED FOR BACKFILL.

- IF NOT, PROVIDE CLEAN, COMPACTIBLE MATERIAL. COMPACT IN 8" LIFTS. REMOVE ANY LARGE ROCKS PRIOR TO BACKFILLING, CONTRACTOR TO VERIFY LOCATION OF EXISTING U/G UTILITIES PRIOR TO DIGGING.
- 3. IF CURRENT AS-BUILT DRAWINGS ARE NOT AVAILABLE CONTRACTOR SHALL HAND DIG U/G TRENCHING.
- 4. CONCRETE ENCASE CONDUIT WHEN TRENCHING UNDER SITE ACCESS ROAD.

JOINT SERVICE TRENCH BURIED CONDUIT (ELECTRIC/TELEPHONE) SCALE: N.T.S.

Mobility

550 COCHITUATE ROAD SUITES 13 & 14 FRAMINGHAM, MA 01701

CUSTOM HOUSE GARAGE **SITE NO.: ME2976**



22 KEEWAYDIN DRIVE SALEM, NH 03079

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Dewberry Engineers, Inc. 280 SUMMER STREET 10TH FLOOR BOSTION MA 02210 PHONE: 617:695:3400 FAX: 517:695.3310 MILES Mo. SIEI?

(Mary)	Martine
**************************************	6.5.12
DRAWN BY:	JIM
REVIEWED BY:	DAS
CHECKED BY:	PPB

PROJECT NUMBER: 50003936 50041016 JOB NUMBER:

25 PEARL STREET PORTLAND, ME 04101

SHEET TITLE

SITE ADDRESS

CONSTRUCTION DETAILS-I

9

2-DIST 6 B.I.N. **B82**

MASSACHUSETTS DEPARTMENT OF TRANSPORTATION STRUCTURES INSPECTION FIELD REPORT SPECIAL MEMBER INSPECTION

BR. DEPT. NO. **B-16-295**

CITY/TOWN	8 - STRUCTURES NO.		11 - MIL	LE POINT	90 ROUTINE INSP. DATE		93 - *SPEC. MEMB. INSP.			
Boston	B16295-B8	32-PRI-BLD				10/15/2008		DATE		
								4/4/2012		
07 - FACILITY CARRIED		MEMORIAL NAM	IE / LOCA	L NAME	27 - YR	106 - YR REBUILT YR RE		*YR REHAB'D (NON 106)		
Interstate 90 - Eastb	ound &	Prudential Tu	unnel		BUILT	0000		0000		
Westbound				0000			•			
06 – FEATURES INTERSECTED		26 – FUNCTIONAL CLASS			TEAM LEADER					
Shaws Market		Principal Arterial-Interstate-Urban			A. Kurian, P.E.					
		· · · · · · · · · · · · · · · · · · ·				7.1.11.11.11.,1				
INSPECTION ENGINEER	22 – OWNE	R 21 – MAINTA	INER	43a - CONSTRUCTION QA/QC						
M. P. Griffin, P.E. Private		Private TYPE		D. Reip, P.E.						
•	Trace	1		Cast In Plac	e					
CONTRACT(S) WEATHER TEMP. (air)			43b – STRUCTURE TYPE		PE TEAM MEMBERS					
	Varied	Varied		Building		S. Gambarov, E. Mena				

SPECIAL MEMBER(S):

	OFAE MEMBER(O):	COND	ITION		
	MEMBER	PREVIOUS	PRESENT	Deficiencies	COMMENTS
		(0-9)	(0-9)		
A	ITEM 62c.17 – Conc. Panel Utility Sup	3	3	S/A	See remarks in comments section.
В					
С					
D					
E					

List of field tests performed:		I-62a	I-62b	I-62c	l-62d	I-62e	I-62f	I-62g
	(Overall Previous Condition)			4				
	(Overall Current Condition)			4				

DEFICIENCY: A defect in a structure that requires corrective action.


CATEGORIES OF DEFICIENCIES:

- C-H = Critical-Hazard Deficiency A deficiency in a component or element of a tunnel that poses an extreme hazard or unsafe condition to the public, but does not impair the structural integrity of the tunnel. Examples include but are not limited to: Loose concrete hanging down over traffic, loose bolts supporting ceiling panels, missing section of roadway joint, etc.
- C-S = Critical-Structural Deficiency A deficiency in a structural element in a tunnel that poses an extreme unsafe condition to the public due to a failure or an imminent failure of the element that will affect the structural integrity of the tunnel.
- M = Minor Deficiency Deficiencies which are minor in nature, generally do not impact the structural integrity of the tunnel and could easily be repaired. Examples include but are not limited to: Spalled concrete, minor potholes, minor corrosion to steel, clogged drainage, etc.
- S = Severe/Major Deficiency Deficiencies which are more extensive in nature and need more planning and effort to repair. Examples include but are not limited to:
 moderate to major deterioration in concrete, exposed and corroding rebar, considerable settlement, considerable leaking, moderate to extensive corrosion to steel with measurable loss of section, etc.

URGENCY OF REPAIR:

X=UNKNOWN


- I ≔ Immediate (Inspector(s) stay at the bridge until District Maintenance crew or the responsible Agency crew (if not a State bridge) show up and corrective action is taken].
- A = ASAP [Action will be taken by District Maintenance Engineer or the Responsible Agency (if not a State owned bridge) upon receipt of the Inspection Report].
- P = Prioritize [Shall be prioritized by District Maintenance Engineer or the Responsible Agency (if not a State owned bridge) and repairs made when funds and/or manpower available].

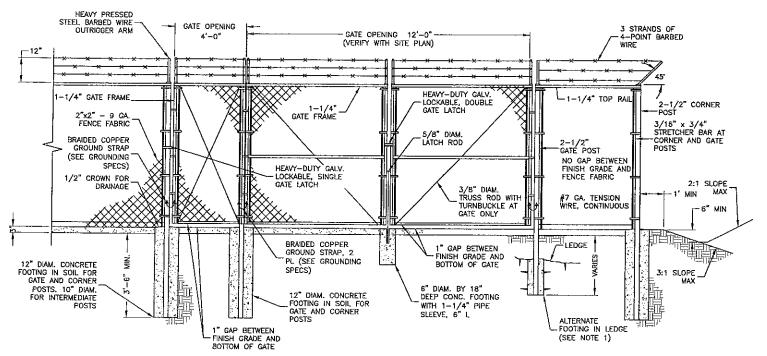

FENCE NOTES:

- ALTERNATE FOOTINGS FOR ALL FENCE POSTS IN LEDGE: IF LEDGE IS ENCOUNTERED AT GRADE, OR AT A DEPTH SHALLOWER THAN 3'-6", CORE DRILL AN 8" DIA HOLE 18" INTO THE LEDGE. CENTER POST IN THE HOLE AND FILL WITH CONCRETE OR GROUT, IF LEDGE IS BELOW FINISH GRADE, COAT BACKFILLED SECTION OF POST WITH COAL TAR, AND BACKFILL WITH WELL-DRAINING GRAVEL.
- ATTACH EACH GATE WITH 1-1/2 PAIR OF NON-LIFT-OFF TYPE, MALLEABLE IRON OR FORGING, PIN-TYPE HINGES. ASSEMBLIES SHALL ALLOW FOR 180' OF GATE TRAVEL.



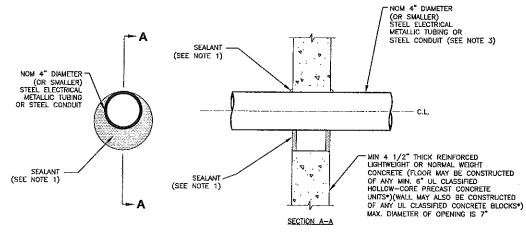


UL SYSTEM NO. C-AJ-1259 F RATING - 3 HR. T RATING - 0 HR.

NOTES:

- FILL, VOID OR CAVITY MATERIAL* SEALANT MIN. 1/2* THICKNESS OF FILL MATERIAL APPLIED WITHIN THE ANNULUS, FLUSH WITH BOTH SURFACES OF FLOOR OR WALL. AT THE POINT CONTACT LOCATION BETWEEN PENETRATING ITEM AND CONCRETE, A MIN. 1/4* THICK BEAD OF FILL MATERIAL SHALL BE APPLIED AT THE CONCRETE/ PENETRATING ITEM INTERFACE ON BOTH SIDES OF FLOOR OR WALL
- FORMING MATERIAL (OPTIONAL, NOT SHOWN) MINERAL WOOL BATT PACKING MATERIAL OR POLYURETHANE BACKER ROD FRICTION FITTED INTO OPENING AND RECESSED FROM FLOOR OR WALL SURFACES AS REQUIRED TO ACCOMMODATE THICKNESS OF FILL MATERIAL
- 3. ONE CONDUIT TO BE INSTALLED EITHER CONCENTRICALLY OR ECCENTRICALLY WITHIN THE FIRESTOP SYSTEM. THE ANNULAR SPACE BETWEEN THE CONDUIT AND THE PERIPHERY OF THE OPENING SHALL BE A MIN. OF O" (POINT OF CONTACT) TO A MAX. OF 3". CONDUIT TO BE RIGIDLY SUPPORTED ON BOTH SIDES OF FLOOR OR WALL ASSEMBLY.
 - * BEARING THE UL CLASSIFICATION MARK.

CORING DETAIL

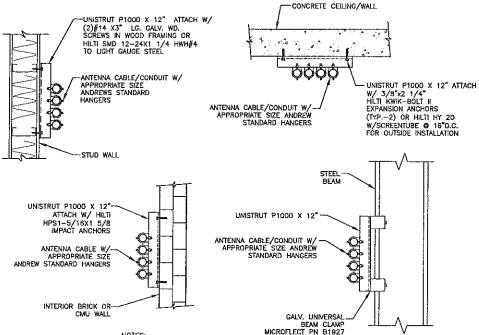

NOTES:

- ALL COAX SUPPORT SPACING: 4'-0" MAX.
- 2. ALL CONDUIT SUPPORT SPACING: 10'-0" MAX.
- CONTRACTOR TO CONFIRM LOCATION OF ANY REBAR OR POST TENSION CABLES WHEN CORING OR DRILLING INTO EXISTING

CONDUIT SUPPORT DETAIL

2

3/8"ø HILTI HIT HY 20 THREADED HIT-A SHORT ROD (TYP -2 PER - EXISTING PARAPET WALL CONCRETE GARAGE DECK L8X8X1/4" (V.I.F) MOUNTED TO UPPER LEVEL DECK (ONLY FOR -INTERMEDIATE SUPPORTS AT , 8.5" (V.i.F.)-MIDSPAN BETWEEN COLUMN LOCATIONS) (SEE NOTE 2) - 3" CONDUIT (TYP-2) 3/8"ø HILTI HIT HY 20 THREADED HIT-A SHORT ROD -1" CONDUIT (TYP-1) UNISTRUT (GALV.) MOUNTED AT CONCRETE COLUMN (TYP.-2 PER ATTACHMENT' LOCATIONS NOTES: CONTRACTOR TO CONFIRM LOCATION OF ANY REBAR OR POST TENSION CABLES WHEN CORING OR DRILLING INTO EXISTING EXISTING 2' X 2' CONCRETE COLUMN VERIFY REQUIRED PLATE SIZE IN FIELD FOR INTERMEDIATE SUPPORTS.

BETA/GAMMA CONDUIT SUPPORT DETAIL

ELEVATION



550 COCHITUATE ROAD SUITES 13 & 14 FRAMINGHAM, MA 01701

CUSTOM HOUSE GARAGE SITE NO.: ME2976



22 KEEWAYDIN DRIVE SALEM, NH 03079

CONSTRUCTION DRAWINGS							
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		COMMENT					
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Dewberry*

Dewberry Engineer Pad Spyrings In Heodi Guston Ma PHONE: 197-69-3 FAX: 617-69-3	TREET
MILLS MALS Mo. 5052	

	6.5.12
DRAWN BY:	JIM
REVIEWED 8Y:	DAS

PP8

PROJECT NUMBER: 50003936

JOB NUMBER: 50041016

SITE ADDRESS


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25 PEARL STREET PORTLAND, ME 04101

SHEET TITLE

CONSTRUCTION DETAILS-II

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550 COCHITUATE ROAD SUITES 13 & 14 FRAMINGHAM, MA 01701

CUSTOM HOUSE GARAGE SITE NO.: ME2976

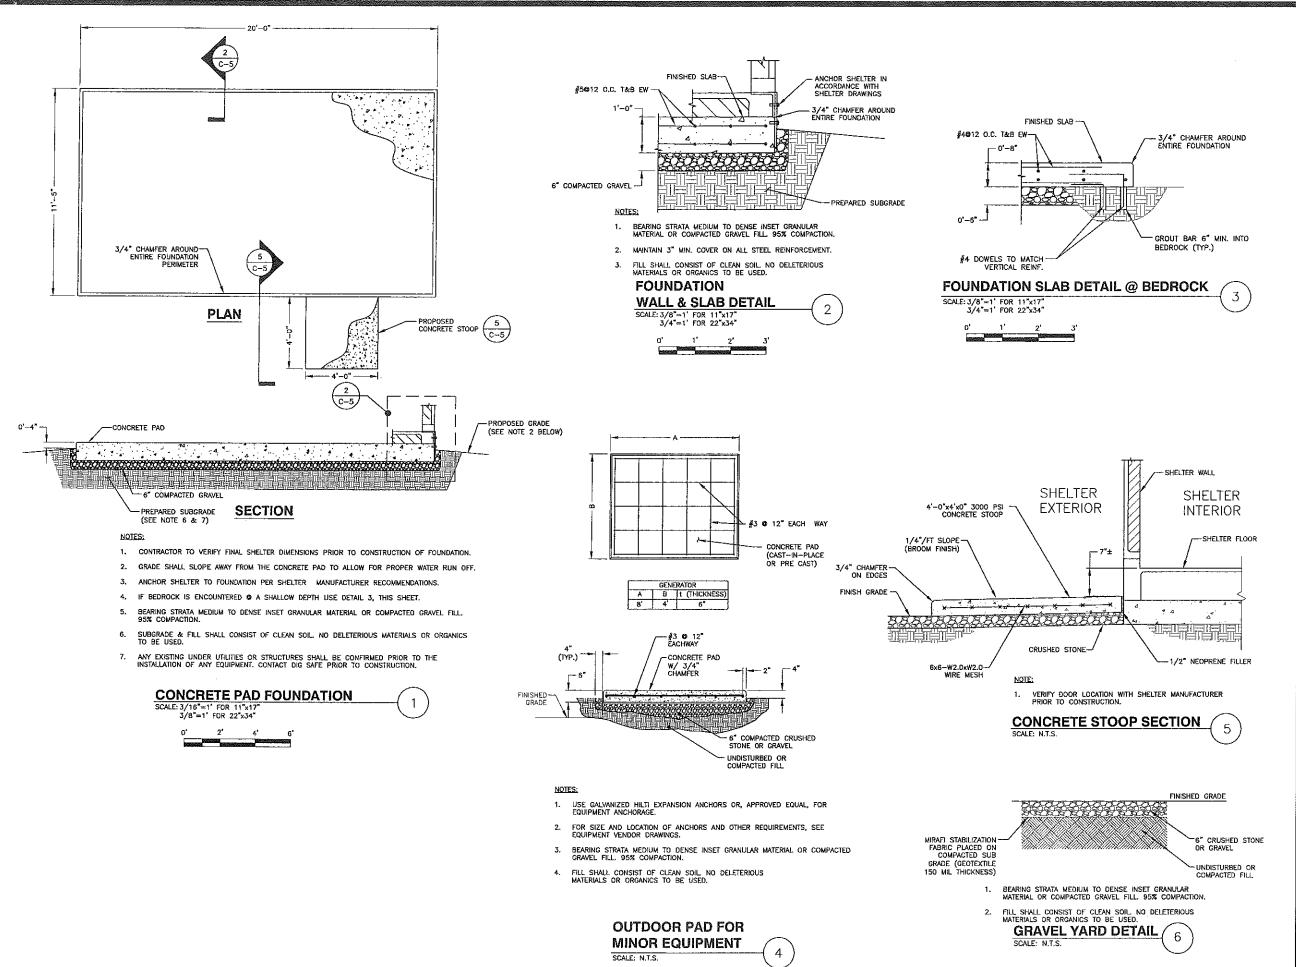

22 KEEWAŸDIN DRIVE SALEM, NH 03079

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Dewberry*

Dewberry Engineers, Inc.
Lead BUMMER STREET
(0TH FLOOR)
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DRAWN BY: JIM

REVIEWED BY: DAS

CHECKED BY: PPB

PROJECT NUMBER: 50003936

JOB NUMBER: 50041016

SITE ADDRESS


25 PEARL STREET PORTLAND, ME 04101

SHEET TITLE


CONSTRUCTION DETAILS—III


SHEET NUMBER

C-5

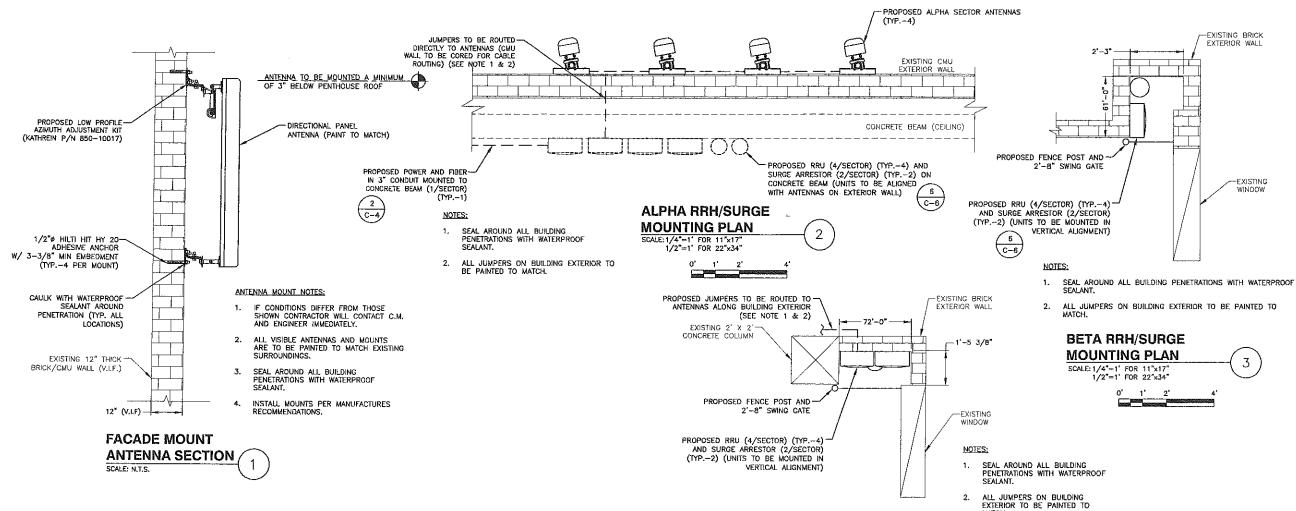

	ANTENNA AND COAXIAL CABLE BILL OF MATERIALS										
SECTOR	STATUS	COLOR CODE	ANTENNA	COAX CABLE FEED LOC	AZIMUTH (TRUE NORTH)	RAD CENTER	CABLE LENGTH	CABLE	MECHANICAL DOWNTILT	RRU	DIPLEXER
IA	PROPOSED	IR & IIR	POWERWAVE P6515XLHRR	воттом	TBD	79.5'	2 6 9 155'	FIBER	O*	(1) ERICSSON RRUS-11	_
IIA	PROPOSED	IIIR & IVR	POWERWAVE P65-15-XLH-RR	воттом	TBD	79.5'	-	FIBER	o•	(1) ERICSSON RRUS-11	-
IIA	PROPOSED	VR & VIR	POWERWAVE P65-15-XLH-RR	воттом	TBD	79.5'	-	FIBER	O'	(1) ERICSSON RRUS-11	-
IIIA	PROPOSED	VR & VIR	POWERWAVE P65-15-XLH-RR	воттом	TBD	79.5'	_	FIBER	o,	(1) ERICSSON RRUS11	-
ß	PROPOSED	18 1 36 181	POWERWAVE P65-15-XLH-RR	воттом	TBD	89.0'	2 👽 341'	FIBER	o,	(1) ERICSSON RRUS-11	-
IIB	PROPOSED	iiiB & IVB	POWERWAVE P6515XLHRR	воттом	TBD	89.0'	_	FIBER	o	(1) ERICSSON RRUS-11	_
IIIB	PROPOSED	VB & VIB	POWERWAVE P65-15-XLH-RR	воттом	TBD	89.0'	-	FIBER	o.	(1) ERICSSON RRUS-11	_
IIIB	PROPOSED	VB & VIB	POWERWAVE P6515XLHRR	воттом	TBD	89.0'	_	FIBER	0,	(1) ERICSSON RRUS-11	_
IG	PROPOSED	IG & IIG	POWERWAVE P65-15-XLH-RR	воттом	TBD	67.0'	2 © 387*	FIBER	0.	(1) ERICSSON RRUS-11	_
liG	PROPOSED	IIIG & IVG	POWERWAVE P65-15-XLH-RR	воттом	TBD	67.0"	-	FIBER	0,	(1) ERICSSON RRUS-11	<u></u>
IIIG	PROPOSED	VG &c VIG	POWERWAVE P65-15-XLH-RR	воттом	TBD	67.0'	_	FIBER	o,	(1) ERICSSON RRUS-11	_
IIIG	PROPOSED	VG & VIG	POWERWAVE P65-15-XLH-RR	воттом	OST	67.0'	_	FIBER	0.	(1) ERICSSON RRUS11	_
TOTAL QUAN.	-	-	12	- 1	-	_	1,766'	_	-	12	_

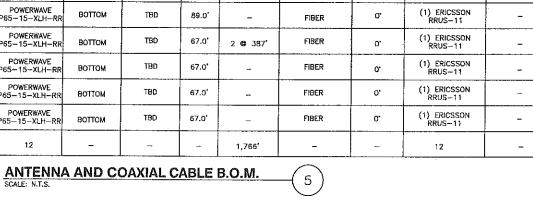

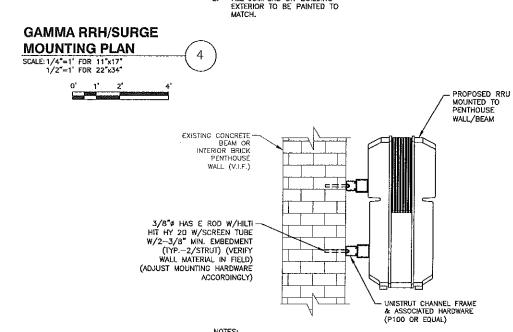

NOTES:

- CONTRACTOR TO SEAL & WEATHERPROOF ALL PENETRATIONS
- 2. INSTALL RRU'S PER MANUFACTURES RECOMMENDATIONS.
- CONTRACTOR SHALL VERIFY EXISTING CONDITION AND DEPTH OF EMBEDMENT AVAILABLE.
- MOUNTING TYPICAL FOR SURGE ARRESTOR. MOUNT ACCORDING TO MANUFACTURER SPECIFICATIONS

TYPICAL RRU MOUNTING DETAIL



550 COCHITUATE ROAD SUITES 13 & 14 FRAMINGHAM, MA 01701

CUSTOM HOUSE GARAGE **SITE NO.: ME2976**



22 KEEWAYDIN DRIVE SALEM, NH 03079

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	Α	04/06/11	FOR	COMMENT

Dewberry*


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	6.5.12
DRAWN BY:	JIM
REVIEWED BY:	DAS
CHECKED BY:	PPB
PROJECT NUMBER:	50003936
JOB NUMBER:	50041016
SITE ADDRESS	

25 PEARL STREET PORTLAND, ME 04101

SHEET TITLE

ANTENNA B.O.M. & ANTENNA DETAILS

SHEET NUMBER

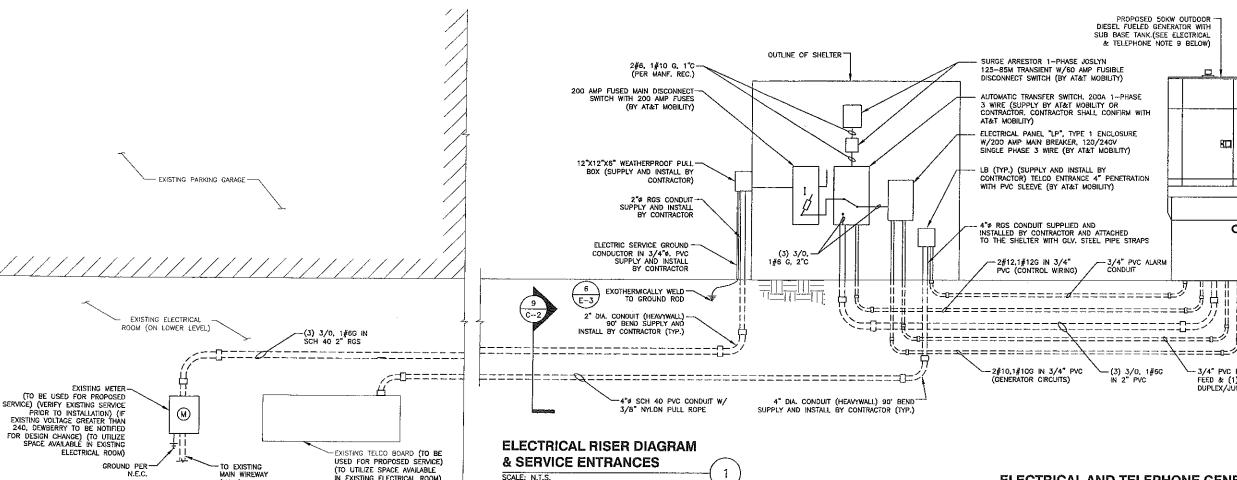

GENERAL ELECTRICAL NOTES

- ALL ELECTRICAL WORK SHALL BE DONE IN ACCORDANCE WITH ALL GOVERNING STATE, COUNTY AND LOCAL CODES, O.S.H.A., NEC, AT&T MOBILITY SPECIFICATIONS, AND THE SPECIFICATIONS DETAILED IN THESE PLANS.
- SUBMITTAL OF BID INDICATES CONTRACTOR IS COGNIZANT OF ALL JOB SITE CONDITIONS AND WORK TO BE PERFORMED UNDER THIS CONTRACT.
- CONTRACTOR SHALL PERFORM ALL VERIFICATION, OBSERVATION, TESTS, AND EXAMINATION WORK PRIOR TO THE ORDERING OF THE ELECTRICAL EQUIPMENT AND THE ACTUAL CONSTRUCTION. CONTRACTOR SHALL ISSUE A WRITTEN NOTICE OF ALL FINDINGS TO THE PROJECT MANAGER LISTING ALL MALFUNCTIONS, FAULTY EQUIPMENT, AND DISCREPANCIES.
- THESE PLANS ARE DIAGRAMMATIC ONLY, FOLLOW AS CLOSELY AS POSSIBLE. CONTRACTOR SHALL ENSURE THAT ACCESS TO EQUIPMENT IS MAINTAINED IN ACCORDANCE WITH MANUFACTURER SPECIFICATIONS AND ALL APPLICABLE CODES.
- EACH CONDUCTOR OF EVERY SYSTEM SHALL BE PERMANENTLY TAGGED IN EACH PANELBOARD, PULLBOX, J-BOX, SWITCH BOX, ETC., IN COMPLIANCE WITH OCCUPATIONAL SAFETY AND HEALTH ADMINISTRATION (OSHA)
- CONTRACTOR SHALL PROVIDE ALL LABOR, MATERIALS, INSURANCE, EQUIPMENT, INSTALLATION, CONSTRUCTION TOOLS, TRANSPORTATION, ETC., FOR A COMPLETE AND PROPERLY OPERATIVE SYSTEM, ENERGIZED THROUGHOUT AND AS INDICATED ON DRAWINGS, AS SPECIFIED HEREIN AND/OR AS OTHERWISE REQUIRED.
- ALL MATERIALS AND EQUIPMENT SHALL BE NEW AND IN PERFECT CONDITION WHEN INSTALLED AND SHALL BE OF THE BEST GRADE AND OF THE SAME MANUFACTURER THROUGHOUT FOR EACH CLASS OR GROUP OF EQUIPMENT, MATERIALS SHALL BE LISTED AND APPROVED BY UNDERWRITER'S LABORATORY AND SHALL BEAR THE INSPECTION LABEL "J" WHERE SUBJECT TO SUCH APPROVAL MATERIALS SHALL BE WITH APPROVAL MATERIALS SHALL BE WITH APPROVAL OF ALL GOVERNING BODIES HAVING JURISDICTION. MATERIALS SHALL BE MANUFACTURED IN ACCORDANCE WITH APPLICABLE STANDARDS ESTABLISHED BY ANSI, NEMA, IEEE, AND NFPA.
- 8. ALL CONDUIT INSTALLED MAY BE SURFACE MOUNTED UNLESS OTHERWISE NOTED.
- COMPLETE JOB SHALL BE GUARANTEED FOR A PERIOD OF ONE (1) YEAR AFTER THE DATE OF JOB ACCEPTANCE BY OWNER. ANY WORK, MATERIAL OR EQUIPMENT FOUND TO BE FAULTY DURING THAT PERIOD SHALL BE CORRECTED AT ONCE, UPON WRITTEN NOTFICENTION, AT THE EXPENSE OF THE CONTRACTOR.
- 10. ALL "CONDUIT ONLY" (C.O.) INSTALLATIONS SHALL HAVE A 14" PULL WIRE OR ROPE,
- 11. CONTRACTOR SHALL PROVIDE AT&T MOBILITY PROJECT MANAGER WITH ONE SET OF COMPLETE ELECTRICAL "AS INSTALLED" DRAWINGS AT THE COMPLETION OF THE JOB, SHOWING ACTUAL DIMENSIONS, ROUTINGS, AND CIRCUITS.
- ALL BROCHURES, OPERATING MANUALS, CATALOGS, SHOP DRAWINGS, ETC. SHALL BE TURNED OVER TO OWNER AT JOB COMPLETION.
- 13. POWER WIRE AND CABLE CONDUCTORS SHALL, BE COPPER #12 AWG MINIMUM UNLESS SPECIFICALLY NOTED OTHERWISE ON DRAWINGS. CONDUCTORS #10 AWG AND SMALLER SHALL BE SOLID.
- 14. ALL CONDUCTORS LARGER THAN \$10 AWG SHALL BE STRANDED COPPER WITH THWN 500V INSULATION, UNLESS NOTED OTHERWISE.
- ALL MATING SURFACES OF GROUND CONNECTIONS SHALL BE CLEANED SMOOTH AND COATED WITH ANTIOXIDANT PRIOR TO ATTACHMENT.
- 16. ALL GROUND CONNECTIONS BELOW GRADE MUST BE EXOTHERMICALLY WELDED (CAD WELD OR APPROVED EQUAL)
- 17. ALL EXTERIOR GROUNDING CONDUCTORS SHALL BE # 2 AWG SOLID TINNED BARE COPPER WIRE UNLESS NOTED OTHERWISE.
- 18. ALL CIRCUIT BREAKERS, FUSES AND ELECTRICAL EQUIPMENT SHALL HAVE AN INTERRUPTING RATING NOT LESS THE MAXIMUM SHORT CIRCUIT CURRENT TO WHICH THEY MAY BE SUBJECTED, AND A MINIMUM OF 10,000 A.I.C. COORDINATE SHORT CIRCUIT REQUIREMENTS WITH UTILITY COMPANY,
- 19. CONTRACTOR SHALL PATCH, REPAIR, AND PAINT ANY AREA THAT HAS BEEN DAMAGED IN THE COURSE OF THE ELECTRICAL WORK.

- 20, IN DRILLING HOLES INTO CONCRETE WHETHER FOR FASTENING OR ANCHORING PURPOSES. OR PENETRATIONS THROUGH THE FLOOR FOR CONDUIT RUNS, PIPE RUNS, ETC., IT MUST BE CLEARLY UNDERSTOOD THAT TENDONS AND/OR REINFORCING STEEL WILL NOT BE DRILLED INTO, CUT OR DAMAGED UNDER ANY CIRCUMSTANCES.
- 21. LOCATION OF TENDONS AND/OR REINFORCING STEEL ARE NOT DEFINITELY KNOWN AND, THEREFORE, MUST BE SEARCHED FOR BY APPROPRIATE METHODS AND EQUIPMENT VIA X-RAY OR OTHER DEVICES THAT CAN ACCURATELY LOCATE THE REINFORCING AND/OR STEEL TENDONS.
- 22. PENETRATIONS IN FIRE RATED WALLS SHALL BE SEALED IN ACCORDANCE WITH ALL APPLICABLE CODES.
- 23. ALL MATERIALS SHALL BE U.L. LISTED.
- CONDUIT:

 a. RIGID CONDUIT SHALL BE U.L. LABEL CALVANIZED ZINC COATED WITH ZINC INTERIOR AND SHALL BE USED WHEN INSTALLED IN OR UNDER CONCRETE SLABS, IN CONTACT WITH THE EARTH, UNDER PUBLIC ROADWAYS, IN MASONRY WALLS OR EXPOSED ON BUILDING EXTERIOR. RIGID CONDUIT IN CONTACT WITH EARTH SHALL BE 1/2 LAPPED WRAPPED WITH HUNTS WRAP PROCESS NO. 3. D. ELECTRICAL METALLIC TUBING SHALL HAVE U.L. LABEL FITTINGS SHALL BE GLAND RING COMPRESSION TYPE. EMT SHALL BE USED ONLY FOR INITERIOR RUNS.

 c. FLEXIBLE METALLIC CONDUIT SHALL HAVE U.L. LISTED LABEL AND MAY BE USED WHERE PERMITTED BY CODE. FITTINGS SHALL BE "JAKE" OR "SQUEEZE" TYPE, SEAL TIGHT FLEXIBLE CONDUIT. ALL CONDUIT SHALL HAVE FULL SIZE GROUND WIRE.

 d. CONDUIT RUNS MAY BE SURFACE MOUNTED IN CELLINGS OR WALLS UNLESS INDICATED DITHERWISE. CONDUIT SHALL RUN PARALLEL OR AT RIGHT ANGLES TO CELLING, FLOOR OR BEAMS. VERIFY EXACT ROUTING OF ALL EXPOSED CONDUIT WITH ENGINEER PRIOR TO INSTALLING.
- 25. ALL ELECTRICAL EQUIPMENT SHALL BE LABELED WITH PERMANENT ENGRAVED PLASTIC LABELS.
- 26. CONTRACTOR SHALL COORDINATE THE ELECTRICAL SERVICE WITH LANDLORD AND LOCAL UTILITY.
- 27. THE ENTIRE ELECTRICAL INSTALLATION SHALL BE GROUNDED AS REQUIRED BY NEC AND ALL APPLICABLE CODES.
- GROUNDING SYSTEM RESISTANCE SHALL NOT EXCEED 5 OHMS. IF THE RESISTANCE VALUE IS EXCEEDED, NOTIFY THE OWNER FOR FURTHER INSTRUCTION ON METHODS FOR REDUCING THE RESISTANCE VALUE. CONTRACTOR SHALL SUBMIT TO THE PROJECT MANAGER ALL TEST REPORTS AND ONE COMPLETE SET OF PRINTS SHOWING "INSTALLED WORK".
- 29. UPON COMPLETION OF WORK, CONDUCT CONTINUITY, AND FALL OF POTENTIAL GROUNDING TESTS FOR APPROVAL. SUBMIT TEST REPORTS TO PROJECT MANAGER. CLEAN PREMISES OF ALL DEBRIS RESULTING FROM WORK AND LEAVE WORK IN A COMPLETE AND
- 30. ALL EXPOSED GROUND WIRES ROUTED ALONG THE SIDE OF EQUIPMENT SHELTERS OR ROUTED OVER CONCRETE FOUNDATIONS OR OTHER EXISTING STRUCTURES SHALL BE INSTALLED IN PROPERLY ANCHORED 3/4" (MIN.) PVC CONDUIT.
- 31. CONTRACTOR SHALL NOT DISTURB EXISTING GROUNDING SYSTEM. ANY DAMAGE SHALL BE REPAIRED IMMEDIATELY AT NO ADDITIONAL COST.
- 32. ALL ELEMENTS OF ICE BRIDGE AND AT&T MOBILITY LITILITY BACKBOARD MUST BE BONDED AND JUMPERED TO GROUNDED COMPONENTS OF THESE SYSTEMS.
- 33. ALL INTERIOR CABLES AND WIRING SHALL BE NEATLY ROUTED IN OVERHEAD LADDER RACK AND FASTENED TO LADDER RACK WITH PLASTIC CABLE TIES.
- 34. ALL GROUNDING CONDUCTORS SHALL BE ROUTED DOWNWARDS FROM POINT OF ORIGIN TO TERMINATION POINT (GROUND BAR, GROUND RING, ETC.
- 35. GROUNDING CONDUCTORS SHALL NOT REVERSE DIRECTION (EXCEPT HALD & BURIED GROUND RINGS). OTHER EXCEPTIONS NEED TO BE APPROVED BY AT&T MOBILITY CONSTRUCTION MANAGER PRIOR TO INSTALLATION.
- 36. GROUNDING CONDUCTORS SHALL HAVE A MINIMUM BENDING RADIUS OF 8".
- ALL CONNECTIONS TO GROUND PLATES SHALL BE CAD WELDED TO THE CENTER OF THE PLATE. ALL DETAILS SHOWING CONNECTIONS TO GROUND RODS ARE ALSO VALID FOR SIMILAR CONNECTIONS TO GROUND PLATES.

ELECTRICAL AND TELEPHONE GENERAL NOTES:

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-3/4" PVC FOR 20A GFI

DUPLEX/JUNCTION BOX FEED

- FOLLOWING COMPLETION OF WORK, PROVIDE OWNER WITH AS-BUILT DRAWINGS SHOWING TELEPHONE AND ELECTRIC LOCATIONS.
- 2. WORK SHALL CONFORM TO THE NATIONAL ELECTRICAL CODE, NEC 2008.
- COORDINATE WITH UTILITY AND LOCAL ELECTRICAL INSPECTOR FOR FINAL POWER CONNECTION.
- UTILITY WILL SUPPLY METER. COORDINATE WITH UTILITY FOR METER TYPE AND INTERCONNECTION.
- ALL EXISTING UNDERGROUND LINES ON SITE TO BE LOCATED PRIOR TO CONSTRUCTION. CALL 1—888—DIG—SAFE PRIOR TO CONSTRUCTION.
- 6. SEAL ALL SERVICE ENTRANCES INTO SHELTER FOLLOWING INSTALLATION.
- SEE PAGE E-2 FOR GENERAL GROUNDING NOTES.
- B. COORDINATE WITH LOCAL TELEPHONE COMPANY FOR ALL ROUTING AND DESIGN.
- CONTRACTOR TO VERIFY CONTROL WIRING SIZE WITH GENERATOR MANUFACTURER PRIOR TO CONSTRUCTION.

NOTE: POWER SUPPLY SUBJECT TO CHANGE. CONFIRM SUPPLY. **ROUTING, AND DESIGN** WITH UTILITY COMPANY. CM. & LL.



550 COCHITUATE ROAD SUITES 13 & 14 FRAMINGHAM, MA 01701

CUSTOM HOUSE GARAGE **SITE NO.: ME2976**



22 KEEWAYDIN DRIVE SALEM, NH 03079

CC	ONSTRUCT	ION	DRAWINGS
0	06/05/12	FOR C	ONSTRUCTION
Ā	04/06/11		COMMENT



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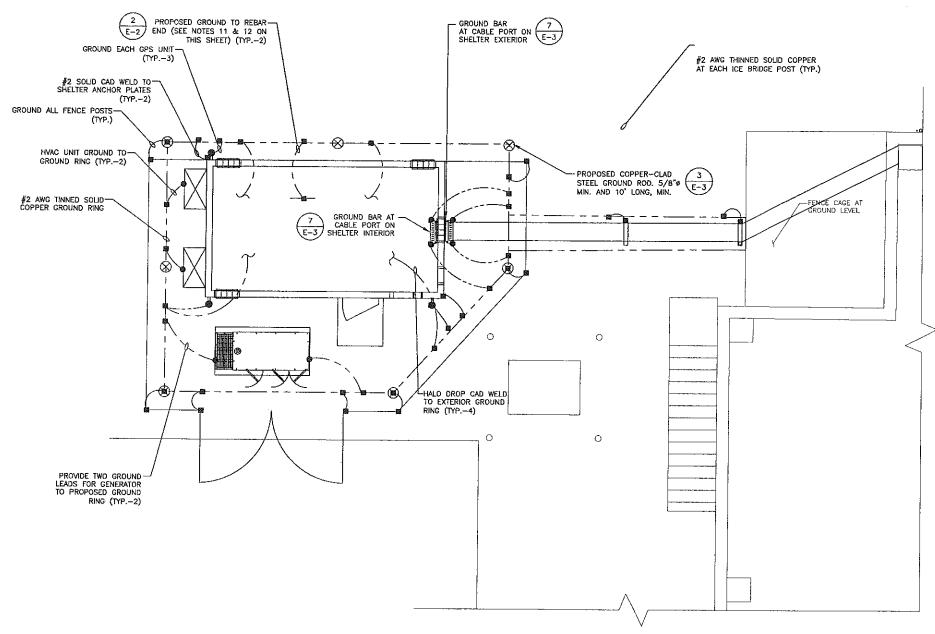
DRAWN BY:	J
REVIEWED BY:	DA
CHECKED BY:	PF
PROJECT NUMBER:	5000393
JOB NUMBER:	5004101

25 PEARL STREET PORTLAND, ME 04101

SHEET TITLE

ELECTRICAL RISER DIAGRAM

SHEET NUMBER



NOTES:

- 1. GROUND UTILITY METER PER N.E.C.
- CONTRACTOR TO VERIFY WITH AT&T MOBILITY C.M. FOR FINAL GROUND METHOD.

PARTIAL SCHEMATIC GROUNDING PLAN SCALE: N.T.S.

GROUND COPPER WIRE, SIZE AS NOTED

FUTURE GROUND RING (V.I.F.)

MECHANICAL GROUND CONNECTION

S/B*X10' COPPER CLAD STEEL GROUND ROD


EXOTHERMIC (CADWELL) CONNECTION

GROUNDING LEGEND

GROUND BAR

GROUNDING GENERAL NOTES

- 1. ALL DOWN CONDUCTORS AND GROUND THE RING CONDUCTOR SHALL BE #2 AWG, SOLID, BARE, TINNED COPPER, UNLESS OTHERWISE NOTED. ALL CONNECTIONS TO GROUND RING SHALL BE EXCTHERMICALLY WELDED. CONDUCTOR SHALL BE AT A MINIMUM DEPTH BELOW GRADE OF 18 INCHES OR TO LEDGE. MINIMUM BEND RADIUS SHALL BE 8 INCHES. CONDUCTOR SHALL BE AT LEAST 24 INCHES FROM ANY FOUNDATION, UNLESS OTHERWISE NOTED.
- GROUND RODS SHALL BE 5/8" DIAMETER COPPER CLAD, HARGER, T&B, ERICO, OR EQUIVALENT. TOP OF ROD SHALL BE A MINIMUM OF 18" BELOW GRADE. IF LEDGE IS ENCOUNTERED, INSTALL GROUND ROD AT AN ANGLE. ELECTRICAL METER GROUND ROD EXCEPTED.
- 3. WHERE MECHANICAL CONNECTIONS ARE SPECIFIED, BOLTED, COMPRESSION—TYPE, CLAMPS OR SPLIT—BOLT TYPE CONNECTORS SHALL BE USED.
- GRIND OFF GALVANIZING IN AFFECTED AREA. EXOTHERMICALLY WELD #2
 CONDUCTOR AT 6" ABOVE GRADE OR FOUNDATION, WHICHEVER IS HIGHER.
 COLD—GALV AFTER. EXOTHERMICALLY WELD OTHER END TO GROUND RING.
- . INSTALL GROUNDING KITS AT ANTENNA CENTERLINE, AND TOWER EXIT POINTS.
 GROUND COAX LINES. EXOTHERMICALLY WELD \$₹2 DOWN CONDUCTOR TO PLATES,
 RUN DOWN TOWER, AND TIE INTO GROUNDING SYSTEM.
- ALL GROUNDING WORK SHALL COMPLY WITH AT&T CONSTRUCTION CONTRACT STANDARDS. FOLLOWING COMPLETION OF WORK, GROUND SYSTEM MUST BE TESTED AND SHALL HAVE A RESISTANCE OF 5 OHMS OR LESS SUBMIT AN INDEPENDENT "FALL POTENTIAL" TESTING REPORT.
- ALL GROUNDING CONDUCTORS ON EXTERIOR WALL OF SHELTER SHALL BE INSTALLED IN 3/4" SCH 40 PVC CONDUIT TO 12" BELOW GRADE, ATTACH PVC WITH GALVANIZED "G" CLAMPS.
- 8. CONTRACTOR SHALL HAND-DIG IN AREAS AROUND EXISTING UTILITIES.
- NOTIFY CONSTRUCTION ENGINEER IF THERE ARE ANY DIFFICULTIES INSTALLING GROUNDING SYSTEM DUE TO SITE SOIL CONDITIONS.
- 10. GROUNDING RING IS SHOWN AS SCHEMATIC ONLY. IT IS DESIGNED WITHOUT BENEFIT OF RESISTIVITY TESTING AND DOES NOT NECESSARILY REPRESENT A GROUNDING SYSTEM TO MEET ANY SPECIFIC GROUND RESISTANCE.
- 11. PRIOR TO POURING CONCRETE, ALL REBAR LOCATED NEAR THE BOTTOM OF THE FOUNDATION SHALL BE BONDED TOGETHER TO FORM A SINGLE GROUNDING ELECTRODE, BY STEEL TIES OF OTHER EFFECTIVE MEANS APPROVED BY NEC 2005 AND STRUCTURAL ENGINEER, AND BONDED TO THE GROUND RING AS DETAILED IN THESE PLANS. (INSPECTION MAY BE REQUIRED PRIOR TO POURING CONCRETE AND MUST BE COORDINATED BY CONTRACTOR.)
- IN ACCORDANCE WITH NEC 2008 REQUIREMENTS, ALL GROUNDING ELECTRODES PRESENT ON SITE SHALL BE BONDED TOGETHER (REFERENCE 2008 NEC ARTICLE 250.50).
- 13. CAULK AND SEAL ALL NON-FACTORY SHELTER PENETRATIONS.

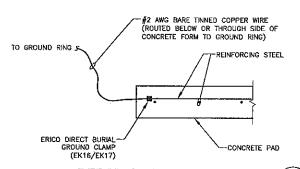

REBAR GROUNDING DETAIL
SCALE: N.T.S.

22 KEEWAYDIN DRIVE SALEM, NH 03079

CONSTRUCTION DRAWINGS

0 06/05/12 FOR CONSTRUCTION

Mobility
550 COCHITUATE ROAD

SUITES 13 & 14

FRAMINGHAM, MA 01701

CUSTOM HOUSE

GARAGE

SITE NO.: ME2976

Dewberry

A 04/06/11 FOR COMMENT

Dewberry Engineers, Inc.
289 SUMMER STREET
JOTHIH DOR
(REPSTON, MA 92210
PROCESS 17, 2655400
PROCESS 17, 2655410

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DRAWN BY: JIM

REVIEWED BY: DAS

CHECKED BY: PPB

PROJECT NUMBER: 50003936

JOB NUMBER: 50041016

SITE ADDRESS


25 PEARL STREET PORTLAND, ME 04101

SHEET TITLE

SCHEMATIC GROUNDING PLAN

SHEET NUMBER

E-2

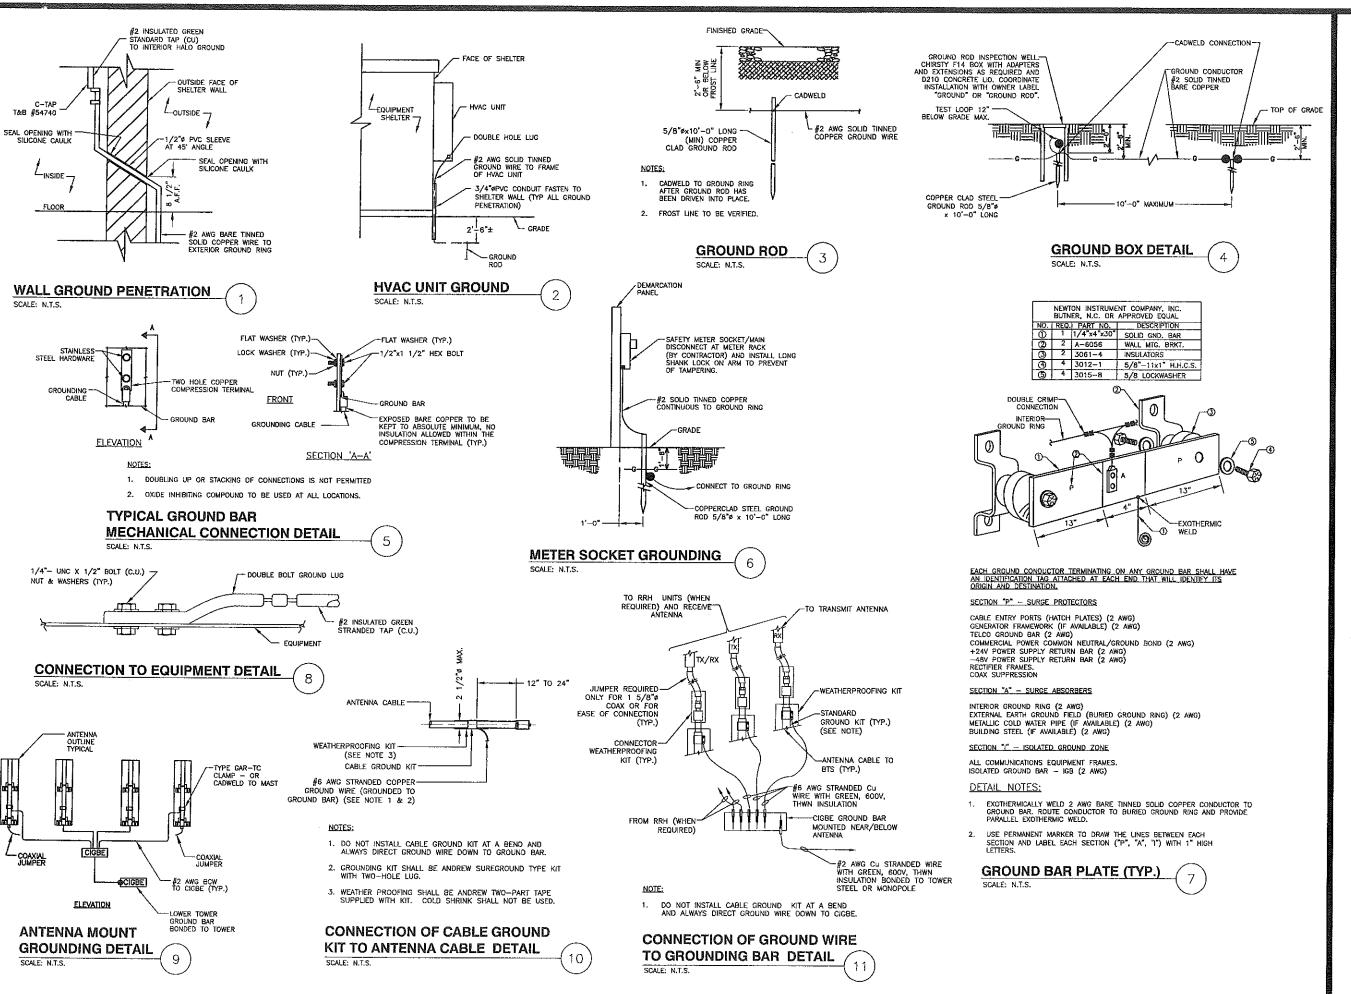

Eat&t Mobility

550 COCHITUATE ROAD SUITES 13 & 14 FRAMINGHAM, MA 01701

GARAGE SITE NO.: ME2976



22 KEEWAYDIN DRIVE SALEM, NH 03079

	CC	NSTRUCT	DRAWINGS	
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1	0		FOR	CONSTRUCTION
ı	Α	04/06/11	FOI	R COMMENT

Dewberry*

Dewberry Engineers, Inc. 200 SUMMER STREET LATH FLOOD BOSTON MA 102210 PHONE STA 585.9400 FAX 517.685.3310



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DRAWN BY:	JiM
REVIEWED BY:	DAS
CHECKED BY:	PPB
PROJECT NUMBER:	50003936
JOB NUMBER:	50041016
SITE ADDRESS	

25 PEARL STREET PORTLAND, ME 04101

SHEET TITLE

GROUNDING DETAILS

SHEET NUMBER

F-3

Barbara Barhydt - Re: AT&T Mobility Proposed Installation at 25 Pearl Street

From:

Peter Cooke <pcooke@wellmanassociates.net>

To:

Barbara Barhydt <BAB@portlandmaine.gov>

Date:

Tuesday, June 26, 2012 11:31 AM

Subject:

Re: AT&T Mobility Proposed Installation at 25 Pearl Street Attachments: Generac 50KW Diesel Generator Specifications 2011.pdf

Thanks Barbara

Genset specs attached – last page has noise levels. AT&T uses the sound enclosure so 71 dB at 23 feet away.

We plan to head to the Building Dept next – they like to see your review as part of the application. We also wanted to include any modifications you may request as part of the plan set we file with them.

Peter Cooke 978.399.8600 (M)

From: Barbara Barhydt <BAB@portlandmaine.gov>

Date: Tuesday, June 26, 2012 10:58 AM

To: Peter Cooke <pcooke@wellmanassociates.net> Cc: Deb Andrews < DGA@portlandmaine.gov>

Subject: Re: AT&T Mobility Proposed Installation at 25 Pearl Street

Hi Peter:

I spoke with Deb this morning and she said that the site is outside of the district boundaries, thus it does not require Historic Preservation Review. I have added her on this e-mail to confirm.

I will finish my review when I receive the additional information. You will need to obtain a building permit, so you will want to submit an application to the Inspections Division if you have not done that already.

Thank you.

Barbara

Barbara Barhydt **Development Review Services Manager** Planning Division 389 Congress Street 4th Floor Portland, ME 04101 (207) 874-8699 Fax: (207) 756-8256

<u>bab@portlandmaine.gov</u>>>> Peter Cooke <<u>pcooke@wellmanassociates.net</u>> Tuesday, June 26, 2012 10:30 AM >>>

Thanks Barbara

I will pull together the specs and get them to you. Routine testing as you request will be no problem – that is our preference as well as the technician for the site is normally there during regular business hours anyway

We were unsure as to what historic review might be needed given the proximity to the Old Port area – have you determined whether a hearing with the Commission will be required? As you know, these sites require State Historic approval as a matter of course so we like to be able to tell them the status of local historic review when we can.

Peter Cooke 978.399.8600 (M)

From: Barbara Barhydt < BAB@portlandmaine.gov>

Date: Tuesday, June 26, 2012 10:08 AM

To: Peter Cooke cooke@wellmanassociates.net>

Subject: Re: AT&T Mobility Proposed Installation at 25 Pearl Street

Hi Peter:

Thank you for this information.

As I understand the proposal, there is a generator proposed. Is there any noise attenuation being proposed for the emergency generator and what are the projected noise levels? Please forward the specifications to me.

We do require that any routine testing of generators be done during regular weekday business hours, rather than at night or on weekends. That will be a condition of approval.

Thank you.

Barbara

Barbara Barhydt
Development Review Services Manager
Planning Division
389 Congress Street 4th Floor
Portland, ME 04101
(207) 874-8699

Fax: (207) 756-8256


<u>bab@portlandmaine.gov</u>>>> Peter Cooke <<u>pcooke@wellmanassociates.net</u>> Friday, June 22, 2012 9:56 AM >>>

Deb/Barbara

Per my telephone conversation with Deb today, place find the attached photo simulations and view shed analysis for the above referenced project that we thought would be helpful in your Administrative Authorization review. We also have a pdf of the plans submitted that I can forward if that is easier to review than the hard copy plans submitted.

Please call me with any questions or comments. Thank you.

Peter Cooke 978.399.8600 (M)

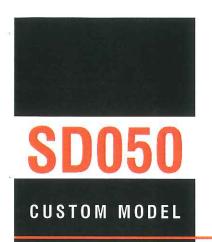




Industrial Diesel Generator Set

EPA Emissions Certification: Tier III

Standby Power Rating 50KW 60 Hz



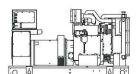







features

Generator Set .

- PROTOTYPE & TORSIONALLY TESTED
- **UL2200 TESTED**
- RHINOCOAT PAINT SYSTEM
- SOUND LEVEL 2 ENCLOSURE

Engine

- **EPA TIER CERTIFIED**
- INDUSTRIAL TESTED, GENERAC APPROVED
- POWER-MATCHED OUTPUT
- INDUSTRIAL GRADE

<u>Alternator</u>

- TWO-THIRDS PITCH
- CLASS H MATERIALS

- LAYER WOUND ROTOR & STATOR
- **DIGITAL 3-PHASE VOLTAGE CONTROL**

Controls

- **ENCAPSULATED BOARD W/ SEALED HARNESS**
- 4-20mA VOLTAGE-TO-CURRENT SENSORS
- SURFACE-MOUNT TECHNOLOGY
- **ADVANCED DIAGNOSTICS & COMMUNICATIONS**

benefits

- PROVIDES A PROVEN UNIT **ENSURES A QUALITY PRODUCT**
- IMPROVES RESISTANCE TO ELEMENTS
- 71dbA @ 7 METERS (23FT)
- **ENVIRONMENTALLY FRIENDLY**
- **ENSURES INDUSTRIAL STANDARDS**
- ENGINEERED FOR PERFORMANCE
- IMPROVES LONGEVITY AND RELIABILITY
- **ELIMINATES HARMFUL 3RD HARMONIC**
- IMPROVES COOLING
- HEAT TOLERANT DESIGN
- **FAST AND ACCURATE RESPONSE**
- EASY, AFFORDABLE REPLACEMENT
- **NOISE RESISTANT 24/7 MONITORING**
- PROVIDES VIBRATION RESISTANCE
- HARDENED RELIABILITY















SD050

application and engineering data

ENGINE SPECIFICATIONS

<u>General</u>					
Make	Iveco / FPT				
EPA Emissions Compliance	Tier III				
EPA Emissions Reference	See Emissions Data She				
Cylinder #	4				
Type	Diesel				
Displacement - L (cu. in.)	4.5	(274)			
Bore - mm (in.)	105	(4.1)			
Stroke - mm (in.)	132	(5.2)			
Compression Ratio	17	.5:1			
Intake Air Method	Turboo	harged			
Cylinder Head Type	2 V	alve			
Piston Type	Alum	ninum			
Crankshaft Type	Forge	d Steel			
Engine Block Type	Cast Iron /	Wet Sleeve			

Engine Governing

Governor	Electronic Isochronous
Frequency Regulation (Steady State)	+/- 0.25%

Lubrication System

Oil Pump Type	Gear			
Oil Filter Type	Full Flow			
Crankcase Capacity - L (gal)(qts)	13.6 (3.6) (14.4)			

Cooling System

Cooling System Type	Closed				
Water Pump	Belt Driven Centrifugal				
Fan Type	Pusher				
Fan Blade Number	2538 (10)				
Fan Diameter (in.)	26				
Coolant Heater Wattage	1500				
Coolant Heater Standard Voltage	120				

Fuel System

Fuel Type	Ultra Low Sulfur Diesel Fuel
Fuel Specifications	ASTM
Fuel Filtering (microns)	5
Fuel Inject Pump Make	Standyne
Fuel Pump Type	Engine Driven Gear
Injector Type	Mechanical
Engine Type	Direct Injection
Fuel Supply Line - mm (in.)	1/4 inch Npt
Fuel Return Line - mm (in.)	1/4 inch Npt

Engine Electrical System

System Voltage	12VDC
Battery Charging Alternator	90 Amp
Battery Size (at 0 oC)	Optima Redtop
Battery Group	34
Battery Voltage	12VC
Ground Polarity	Negative

ALTERNATOR SPECIFICATIONS

Standard Model	390			
Poles	4			
Field Type	Revolving			
Insulation Class - Rotor	H HANDE			
Insulation Class - Stator	Н			
Total Harmonic Distortion	< 3.5%			
Telephone Interference Factor (TIF)	< 50			
Standard Excitation	PMG			
Bearings	Single Sealed Cartridge			
Coupling	Direct, Flexible Disc			
Load Capacity - Standby	100%			
Load Capacity - Prime	100%			
Prototype Short Circuit Test	Y			

Voltage Regulator Type	
Number of Sensed Phases	
Regulation Accuracy (Steady State)	

Digital	
All	
+/- 0.25%	

CODES AND STANDARDS COMPLIANCE (WHERE APPLICABLE)

NFPA 99

NFPA 110

ISO 8528-5

ISO 1708A.5

ISO 3046

BS5514 **SAE J1349**

DIN6271

IEEE C62.41 TESTING

NEMA ICS 1

Standby - Applicable for a varying emergency load for the duration of a utility power outage with no overload capability. (Max. load factor = 70%) Prime - Applicable for supplying power to a varying load in lieu of utility for an unlimited amount of running time. (Max. load factor = 80%) A 10% overload capacity is available for 1 out of every

3 of 5

operating data (60Hz)

SD050

POWER RATINGS (kW)

Single-Phase 120/240VAC @1.0pf

Three-Phase 120/208VAC @0.8pf

Three-Phase 120/240VAC @0.8pf

Three-Phase 277/480VAC @0.8pf

Three-Phase 346/600VAC @0.8pf

STANDBY

50	Amps:	208
	Amps:	
20	Amps:	-
	Amps:	
(m)	Amps:	

NOTE: Generator output limited to 200A.

STARTING CAPABILITIES (sKVA)

sKVA vs. Voltage Dip

	480VAC				208/240VAC								
Alternator*	<u>kW</u>	10%	15%	20%	25%	30%	35%	10%	15%	20%	25%	30%	35%
Standard	50	-	No.			-		26	39	52	65	77	90
Upsize 1				-		2		120	TOP STA	-		-	
Upsize 2		2		÷		-	THE STATE OF	125		-		-	

*All Generac Industrial alternators utilize Class H insulation materials. Standard alternator provides less than or equal to Class B temperature rise. Upsize 1 provides less than or equal to Class B temperature rise. Upsize 2 provides less than or equal

FUEL

Fuel Consumption Rates

Fuel Pump Lift - in (m)

36(.9)

STANDBY

Percent Load	gph	lph
25%	1.52	5.75
50%	2.33	8.82
75%	3.08	11.65
100%	4.15	15.71

COOLING

Coolant System Capacity - Gal (L)

4.5 (17.44)

Maximum Radiator Backpressure 1.5" H₂O Column

STANDBY

		017111001
Coolant Flow per Minute	gpm (lpm)	32.7(123.8)
Heat rejection to Coolant	BTU/min	123,000
Inlet Air	cfm (m3/min)	6,360 (180.0)
Max. Operating Radiator Air Temp	F° (C°)	122(50)
Max. Operating Ambient Temperature	F° (C°)	122(50)

COMBUSTION AIR REQUIREMENTS

Intake Flow at Rated Power

STANDBY

cfm (m3/min) 247 (7.00)

EXHAUST

Exhaust Outlet Size (Open Set)

	3,0"
-	Maximum Backpressure (Post-Silencer)
	1.5" Hg

STANDBY

Exhaust Flow (Rated Output)	cfm (m3/hr)	534(906.7)
Maximum Backpressure	inHg (Kpa)	1.5 (5.1)
Exhaust Temp (Rated Output)	°F (°C)	930(498.8)

ENGINE

STANDBY

Rated Engine Speed	rpm	1800
Horsepower at Rated kW	hp	93
Temperature Deration		Consult Factory
Altitude Deration	THE PARTY OF THE PARTY OF	Consult Factory

^{*} CA units include aftertreatment

INDUSTRIAL

Std

Std

standard features and options

SD050



Genset Vibration Isolation Factory Testing Std Extended warranty Std Padlockable Doors Std Steel Enclosure (Enclosed Models) Std O Remote Emergency Shutdown Opt

ENGINE SYSTEM

<u>General</u> Oil Drain Extension

GENERATOR SET



Std

Std

Std

Air Cleaner	Std
 Industrial Exhaust Silencer (Open Sets, ship loose) 	Std
Critical Exhaust Silencer (Enclosed Sets)	Std
Stainless steel flexible exhaust connection	Std
■ Fuel System	
Primary Fuel Filter with Water Separator	Std
Elevible Fuel Lines	Ctd

Cooling System

UL142 Fuel Tank, 48 Hr Runtime

2 Gal Overflow Containment with Alarm

120VAC Coolant Heater (3-wire connection cord)	Std
● 50%/50% Coolant	Std
Level 1 Guarding (Open Sets)	Std
Closed Coolant Recovery System	Std
UV/Ozone resistant hoses	Std
Factory-Installed Radiator	Std
Radiator Drain Extension	Std
Fan guard	Std
Radiator duct adapter (Open Sets)	Std

Engine Electrical System

Battery charging alternator	Sto
Battery cables	Sto
Battery tray	Sto
75W 120VAC Battery heater	Sto
 Solenoid activated starter motor 	Sto
■ 10A UL float/equalize battery charger	Sto
Weather Resistant electrical connections	Sto
Duplex GFCI Convenience Outlet	Sto

ALTERNATOR SYSTEM



Std

ULZZUU GENProtect'''
100% Rated 200A Main Line Circuit Breaker

CONTROL SYSTEM



Control Panel	
Digital H Control Panel - Dual 4x20 Display	Std
Programmable Crank Limiter	Std
 7-Day Programmable Exerciser (requires H-Transfer Switch) 	Std
Special Applications Programmable PLC	Std
RS-232	Std
RS-485	Std
All-Phase Sensing DVR	Std
Full System Status	Std
Utility Monitoring (Req. H-Transfer Switch)	Std
 2-Wire Start Compatible 	Std
Power Output (kW)	Std
Power Factor	Std
Reactive Power	Std
All phase AC Voltage	Std
All phase Currents	Std
Oil Pressure	Std
Coolant Temperature	Std
Coolant Level	Std
Low Fuel Pressure Indication	Std
Engine Speed	Std
Battery Voltage	Std
Frequency	Std
 Date/Time Fault History (Event Log) 	Std
UL2200 GENprotect™	Std
O Low-Speed Exercise	Opt
 Isochronous Governor Control 	Std
-40deg C - 70deg C Operation	Std
Weather Resistant Electrical Connections	Std
Audible Alarms and Shutdowns	Std
Not in Auto (Flashing Light)	Std
On/Off/Manual Switch	Std
E-Stop (Red Mushroom-Type)	Std
Remote E-Stop (Break Glass-Type, Surface Mount)	425
Remote E-Stop (Red Mushroom-Type, Surface Mount)	2
Remote E-Stop (Red Mushroom-Type, Flush Mount)	=
NFPA 110 Level I and II (Programmable)	Std

Alarms (Programmable Tolerances, Pre-Alarms and Shutdowns) Low Fuel

	W Luci	311
Oi	l Pressure (Pre-programmed Low Pressure Shutdown)	Sto
Co	polant Temperature (Pre-programmed High Temp Shutdo	Sto
Co	polant Level (Pre-programmed Low Level Shutdown)	Sto
E n	gine Speed (Pre-programmed Overspeed Shutdown)	Sto
No.	oltage (Pre-programmed Overvoltage Shutdown)	Ct

Other Options


Battery Voltage


Remote Communication - RS232

Single Side Service




dimensions, weights and sound levels

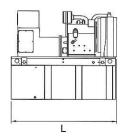


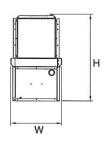

OPEN SET

		TANK	SIZE					
	RUNTIME HOURS	CAPACITY (GAL)	TANK VOLUME	L	w	н	WT	dBA*
0		-		ж			-	The state of
C	- 6	1197	-	×	(4)	<u> </u>	100	
C	-	72	(4)	-			121	
C				2	-	2	- 2	84
C	-		(A)	- 4	140	-	-	04
	48	210	210	76	38	87	3400	
0		-	540	¥	-	-	141	1 /
0	-	-			747	-	-	

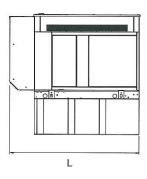

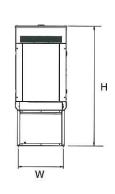

LEVEL 2 SOUND ENCLOSURE TANK SIZE

L	RUNTIME HOURS	CAPACITY (GAL)	TANK VOLUME	Ľ.	W	н	WT	dBA*
1	700			=	141	-	-	
[250		-		(#)	-		
	()	200	340	4	929		147	Marie .
L	(4)		-	-	-	Ψ.	140	71
L	-	PH.	190	-	*	-		11
Ĺ	48	210	210	94.8	38	99	3935	10
П	10-1	200	740	~	140	-	(4)	

*Required gallons based on 100% of standby rating. Weights consider steel enclosure and are without fuel in tank. Sound levels measured at 23ft (7m) and does not account for ambient site conditions.

YOUR FACTORY RECOGNIZED GENERAC INDUSTRIAL DEALER

Specification characteristics may change without notice. Dimensions and weights are for preliminary purposes only. Please consult a Generac Power Systems Industrial Dealer for detailed installation drawings.

