100 MIDDLE STREET LOBBY RENOVATIONS

100 MIDDLE STREET

ABBREVATIONS

FRMG

FT

FWC

GB

GWB

HD WD

HDR

HM

нт

HDWE

HORZ

INSUL

INT

LOC

MAS

MAX

MECH

MFGR

MIN

MISC

MRGE

MO

NIC

NO

NOM

NTS

OA

OC

OD

OF

PTD

OPNG OPP

PAINT

PAINTED

MR

MB

INT

Μ

ALUM OR A

AWP

ACT

BIT

BM

BOT

BRG

BRK

CAB

CB

CC

CJ

CL CLG

CMU

CONC

CONT

CONS

CT

DF

DBL

DIA

DIM

DNA

DTL

DWG

FA

FF

EJ

EL ELEC

ELEV

EMHO

EQ

EW

EWC

FXP

EXT

FDN

FFE

FIN

FL

FIN FL OR F

FIN GR

FD

FE

EXIT OR (E)

CONTR

ALUMINUM ACOUSTICAL WALL PANEL ACOUSTICAL CEILING TILE BITUMINOUS BENCH MARK BOTTOM BEARING BRICK CARPET CABINT CHALK BOARD CENTER TO CENTER CONCRETE HARDENER CONTROL JOINT CENTER LINE CEILING CONCRETE MASONRY UNITS CONCRETE CONTINUOUS CONSTRUCTION CONTRACTOR CERAMIC TILE DOUBLE DRINKING FOUNTAIN DIAMETER DIMENSION DOES NOT APPLY DFTAIL DRAWING EAST EACH EACH FACE EXPANSION JOINT ELEVATION ELECTRICAL ELEVATOR ELECTROMAGNETIC HOLD OPEN MTL EQUAL EACH WAY ELECTRIC WATER COOLER EXISTING EXPANSION EXTERIOR FLOOR DRAIN FOUNDATION FIRE EXTINGUISHER FINISH FLOOR ELEVATION FINISH FINISH FLOOR


FIRE RATING	ł
FRAMING	
FEET (FOOT)	l
FIELD VERIFY	I
FABRIC WALL COVERING	l
GRANITE	l
GAUGE	I
GALVANIZED	I
GRAB BARS	
GENERAL CONTRACTOR	
GYPSUM WALL BOARD	I
HANDICAP	
HARDWOOD	
HEADER	
HARDWARE	
HOLLOW METAL	
HORIZONTAL HEIGHT	i
INSIDE DIAMETER	i i
INSIDE FACE	Č
INCHES	Ģ
INSULATION	
INTERIOR	
INTERIOR	
LOCATION	ġ
MARBLE	
MASONRY	;
MAXIMUM	-
MARKER BOARD	-
MECHANICAL	-
MANUFACTURER	-
MINIMUM	
MISCELLANEOUS	-
MASONRY OPENING	
MOP RECEPTOR	
MOISTURE REST. GYP. BRD.	
METAL	1
NORTH	,
NOT APPLICABLE NOT IN CONTACT	,
NUMBER	,
	,
NOMINAL NOT TO SCALE	,
OVERALL	,
ON CENTER	Ň
OUTSIDE DIAMETER	
OPENING	
OPPOSITE	
OUTSIDE FACE	

PLATE PLYWOOD PANEL PRESSURE TREATED PAPER TOWEL AND WASTE DISP PARTITION ROOF DRAIN REFER REFRIGERATOF REINFORCED REQUIRED ROOM ROUGH OPENING SOUTH SHOWER CURTAIN SOAP DISPENSER SCHEDULE SECTION SHEET SIMILAR SANITARY NAPKIN DISPOSAL SQUARE SYNTHETIC SPORTS SURFACE STANDARD STEEL STRUCTURAL SHEET VINYL TEMPERED (GLASS) TACK BOARD THICKNESS TOP OF TOP OF BEAM TOP OF MASONRY TOP OF WALL TOILET PAPER DISPENSER TYPICAL UNLESS NOTED OTHERWISE VAPOR BARRIER VINYL COMPOSITION TILE VERTICAL VINYL WALL COVERING WEST WITH WATER CLOSET WOOD

LEGEND

Room name

101 (101) $\langle 1 \rangle$ WINDOW TYPE EW6 ACT GWB DEMO LABEL COLUMN LINE LABEL A101 A101

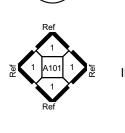

ELEVATION

PROJECT DIRECTORY

NA

FINISH GRADE

FLOOR

OWNER: ALBANY ROAD 10 HIGH STREET SUITE 700 BOSTON, MA 02110 617-279-2365

SITE/CIVIL ENGINEER: OWNER:

ARCHITECT: GAWRON TURGEON ARCHITECTS 29 BLACK POINT ROAD SCARBOROUGH, MAINE 04074 207-883-6307

SITE/CIVIL ENGINEER:

CONSTRUCTION MANAGER TBD

MECHANICAL ENGINEER DESIGN / BUILD

STRUCTURAL ENGINEER: NA

ELECTRICAL ENGINEER: DESIGN BUILD

PORTLAND, MAINE

ROOM LABEL

DOOR TAG

WALL TYPE

CEILING LABEL

BUILDING ELEVATION

- BUILDING SECTION

- WALL SECTION

- DETAIL SECTION

INTERIOR ELEVATION

GENERAL NOTES

ANY DISCREPANCIES TO THE ARCHITECT. CONTRACTOR SHALL PROCEED WITH THE WORK ONLY AFTER DISCREPANCY HAS BEEN RESOLVED WITH THE ARCHITE 2. DO NOT ALTER OR F ENETRATE ANY EXISTING STRUCTURAL ELEMENTS, EXTERIOR WALL COMPONENTS, OR FIRE RATED WALLS 3. THE LOCATIONS OF DOORS NOT DIMENSIONED SHALL BE 6 INCHES FROM ADJACENT WAL 4. THE BUILDING SHALL BE CONSTRUCTED TO CONFORM WITH ALL APPLICABLE CODES INCLUDING, BU NOT LIMITED TO, THE LATEST EDITIONS OF IBC, BOCA, NFPA 101, & ANSI 5. ALL WOOD IN CONTACT WITH CONCRETE SHALL BE PRESSURE PRESERVATIVE TREATED & ALL CONNECTIONS TO BE STAINLESS STEEL. 6. CONTRACTOR SHALL WORK FROM GIVEN DIMENSIONS AND LARGE SCALE DETAILS ONLY. DO NOT SCALE THE DRAWINGS. 7. EXISTING BUILDING COMPONENTS WHICH ARE AFFECTED BY NEW WORK AND DEMOLITION, OR WHICH MAY BE DAMAGED BY THE CONTRACTOR OR ANY SUBCONTRACTORS SHALL BE REPLACED OR RESTORED TO ORIGINAL CONDITION AND COLOR BY METHODS DESCRIBED IN THIS CONTRACT OR AS APPROVED BY THE ARCHITECT. THE GENERAL CONTRACTOR SHALL SEAL, PATCH AND FILL ANY FLOOR AND/OR WALL PENETRATIONS DUE TO DEMOLITION/CONSTRUCTION. 8. INSTALL BLOCKING BEHIND ALL SURFACE APPLIED FIXTURES, TRIM, CABINETS, COUNTER TOPS, AND GRAB BARS WHEN MOUNTED ON STUD WALLS. 9. CONTRACTOR SHALL VERIFY SIZE AND LOCATION OF EXISTING MECHANICAL AND PLUMBING ELEMENTS. CONTRACTOR SHALL RENOVATE EXISTING ALARM SYSTEM TO MAINTAIN CONFORMANCE TO NFPA 13 & 101. CONTRACTOR SHALL VERIFY SIZE & LOCATION OF ALL ELECTRICAL SERVICES AND EQUIPMENT. 10. INSTALL MOISTURE RESISTANT GYPSUM BOARD IN LAVATORIES, JANITOR CLOSETS, AND ALL OTHER HIGH HUMIDITY AREAS. 11. FINISHES: FINISHES OTHER THEN THE STANDARD FINISHES ARE ALL INDICATED ON THE DRAWINGS, CEILING FINISHES ARE SHOWN ON THE REFLECTED CEILING PLANS AND ALL OTHER FINISHES ARE SHOWN ON THE INTERIOR FINISH LEGEND AND SCHEDULE AND/OR INTERIOR ELEVATIONS, FINISHES INDICATED FOR A PARTICULAR ROOM OR SPACE ARE APPLICABLE FOR THE ENTIRE ROOM OR SPACE, UNLESS OTHERWISE NOTED. 12. ALL EXPOSED SURFACES ARE TO BE PAINTED, WHETHER OR NOT INDICATED ON THE DRAWINGS, EXCEPT AS FOLLOWS: WHERE SPECIAL COATINGS ARE INDICATED; PREFINISHED ITEMS, CONCEALED SURFACES, OPERATING PARTS, AND LABELS. IF PREFINISHED, PAINTING THE FOLLOWING: EXPOSED MECHANICAL DUCTWORK, WALL DIFFUSERS, GRILLES AND LOUVERS, ROOF TOP MECHANICAL EQUIPMENT, AND SPEAKER GRILLES. FINISHED METAL SURFACES, EXCEPT AS LISTED ABOVE. SEE SPECIFICATIONS ON DRAWINGS IDENTIFYING THE TYPES OF PAINTS AND SPECIALTY COATINGS TO BE USED IN ACCORDANCE WITH MATERIAL BEING PAINTED OR COATED. 13. BUILDING INSULATION: PROVIDE AS INDICATED ON WALL DETAILS AND IN ACCORDANCE WITH PARTITION TYPES, WHETHER OR NOT SHOWN IN DETAILS AND DRAWINGS. FOR DRAWING CLARITY, INSULATION MAY NOT BE SHOWN, EVEN IF IT IS PROVIDED. 14. CONTRACTOR SHALL SUBMIT SAMPLES OF ALL INTERIOR FINISHES FOR ARCHITECT'S REVIEW. 15. THE DESIGN AND INSTALLATION OF THE HVAC AND PLUMBING SYSTEMS, ELECTRICAL AND FIRE PROTECTION SYSTEMS, AND STRUCTURAL SYSTEMS SHALL BE PROVIDED THROUGH A DESIGN/BUILD CONTRACT UNDER THE GENERAL CONTRACTOR. 16. GENERAL CONTRACTOR SHALL SUPPLY POWER AND COORDINATION TO THE TENANT SUPPLIED SYSTEMS FURNITURE. 17. GENERAL CONTRACTOR SHALL SUPPLY POWER AND CONDUITS WITH PULL-STRINGS FOR DATA AND TELEPHONE TO ALL POWER POLES FOR THE OWNER SUPPLIED WORKSTATIONS. THE DESIGN AND INSTALLATION OF THE DATA AND TELEPHONE SYSTEMS SHALL BE THE RESPONSIBILITY OF THE TENANT. GENERAL CONTRACTOR TO PROVIDE

THE GENERAL CONTRACTOR SHALL VERIFY ALL EXISTING CONDITIONS AND DIMENSIONS, AND REPORT

CONDUIT WITH PULL-STRINGS TO ALL LOCATIONS RECEIVING DATA AND TELEPHONE. 18. GENERAL CONTRACTOR SHALL CONDUCTED A PRE-DEMOLITION MEETING WITH ALL SUBCONTRACTORS, OWNER'S REPRESENTATIVE AND ARCHITECT ON SITE PRIOR TO COMMENCENCEMENT OF ANY DEMOLITION.

19. GENERAL CONTRACTOR SHALL CONDUCTED A PRE-CONSTRUCTION MEETING WITH ALL SUBCONTRACTORS, OWNER'S REPRESENTATIVE AND ARCHITECT ON SITE PRIOR TO COMMENCENCEMENT OF NEW WORK.

20. PRIOR TO REMOVAL OF ANY CONSTRUCTION, CONTRACTOR SHALL PERFORM SELECTIVE DEMOLITON TO IDENTIFY ANY OBSTACLES THEY MAY IMPEDED PLACEMENT OF PROPOSED CONSTRUCTION

CODE NOTES

NO CODE CHANGES ANTICIPATED

- 1. NO CHANGE OF USE
- 2. NO CHANGE OF CONSTRUCTION TYPE 3. NO CHANGES TO EGRESS PATHS
- 4. NO CHANGES TO OCCUPANCY LOAD
- 5. EMERGENCY LIGHTING & FIXTURES TO REMAIN
- **INTERIOR FINISHES:**
- LOBBIES & CORRIDORS CLASS A OR B EXIST WALLS & CEILING - CLASS A
- OTHER SPACES CLASS A OR B . INTERIOR FLOOR FINISHED - NOT LESS THAN •
 - CLASS II


13


14








CONSTRUCTION BOUNDRY

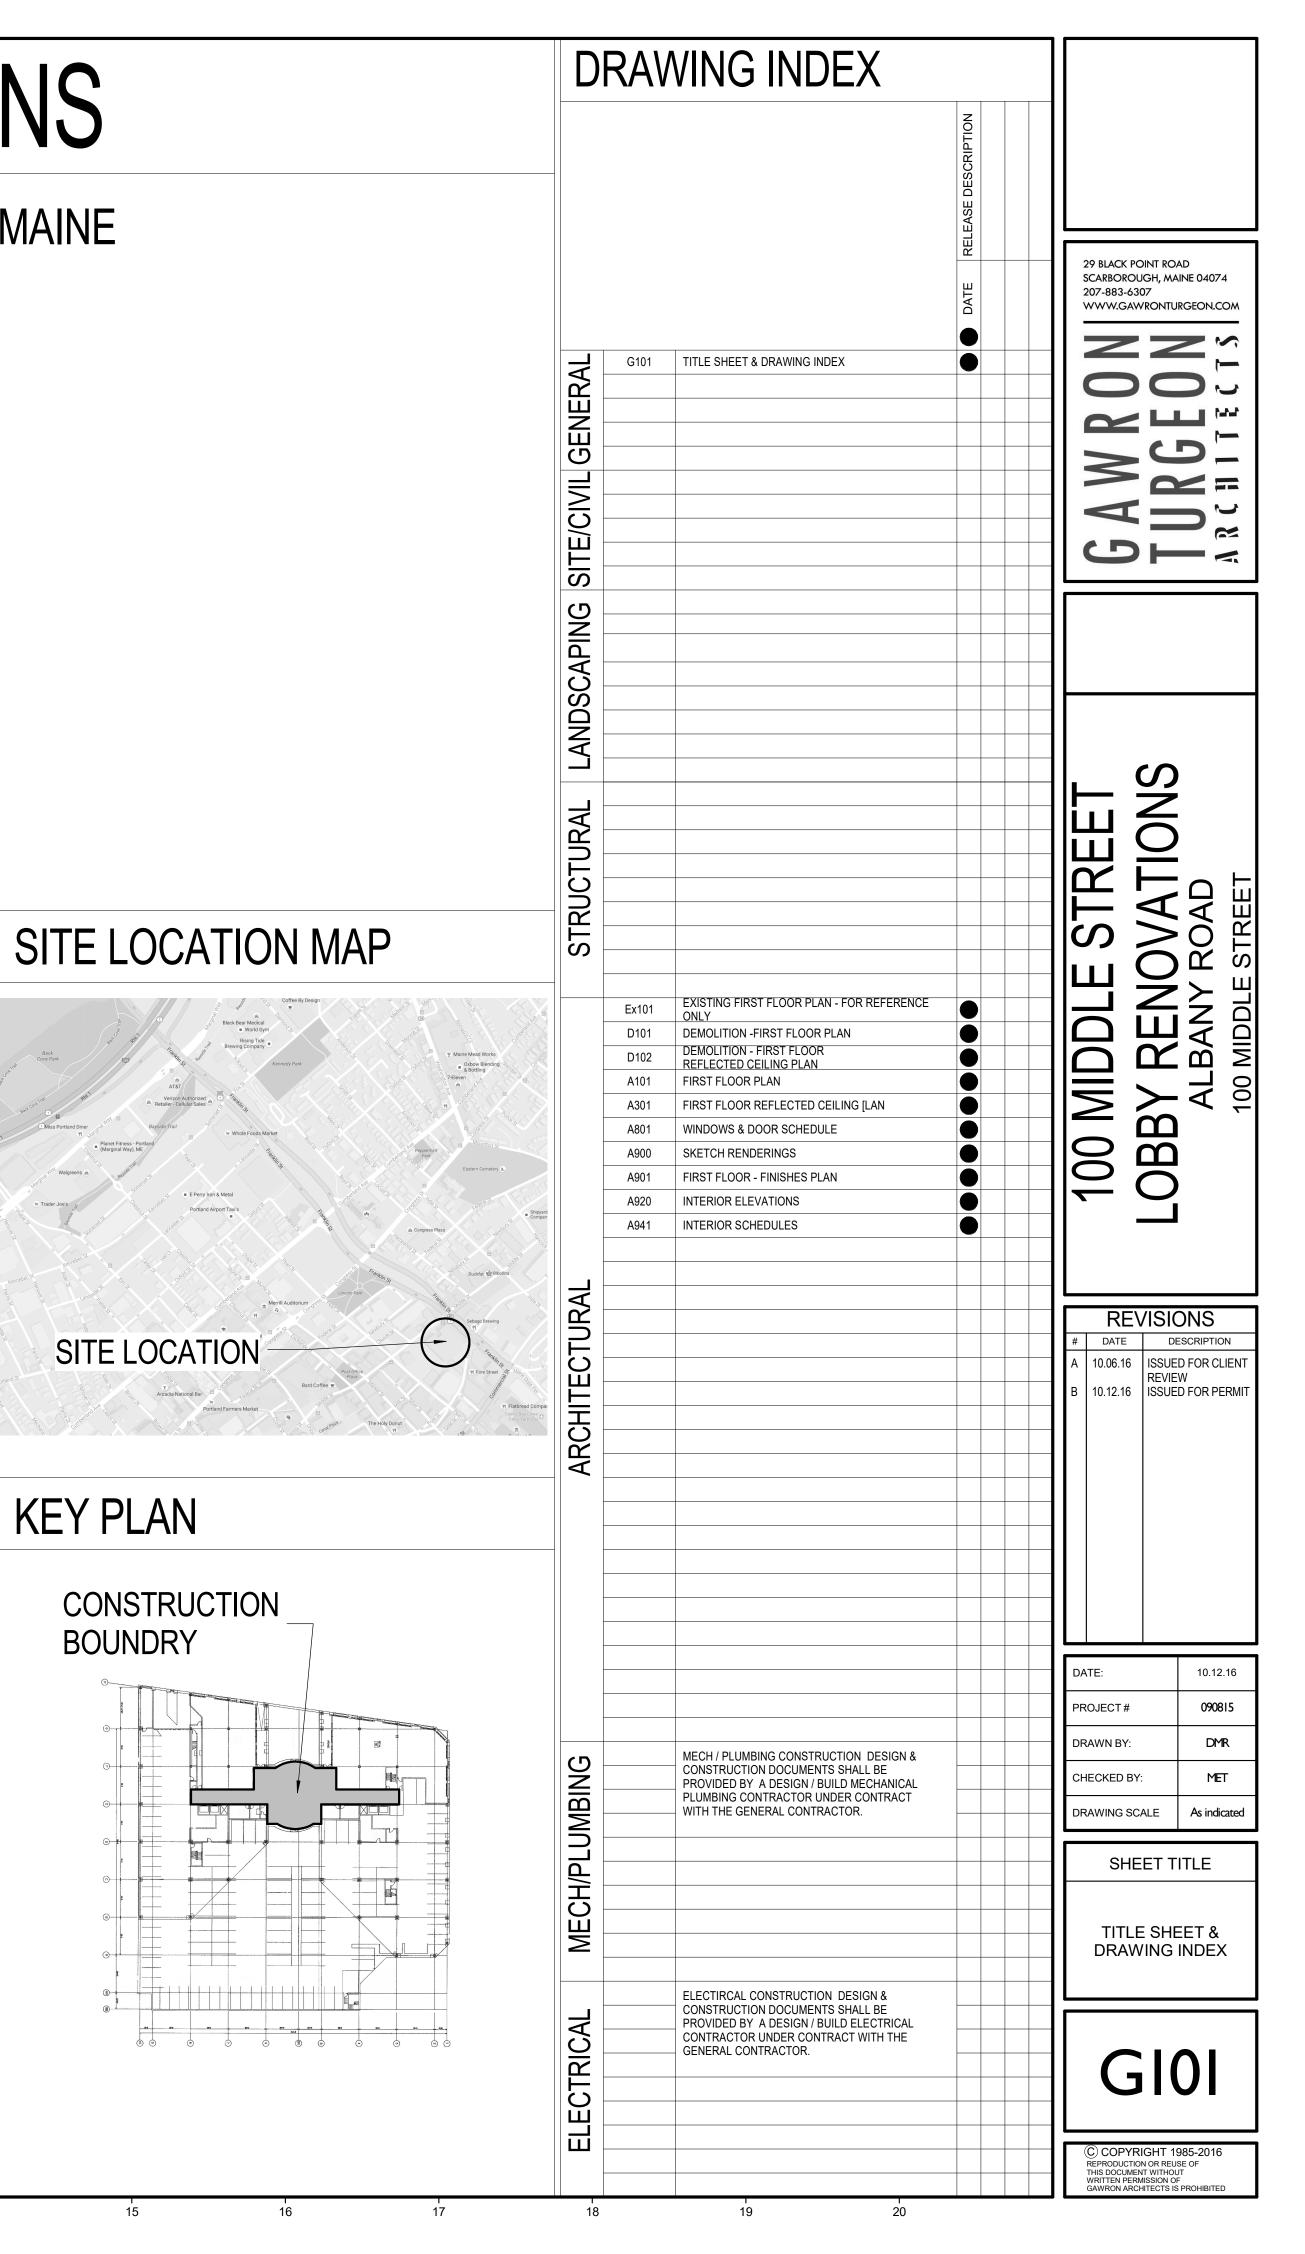


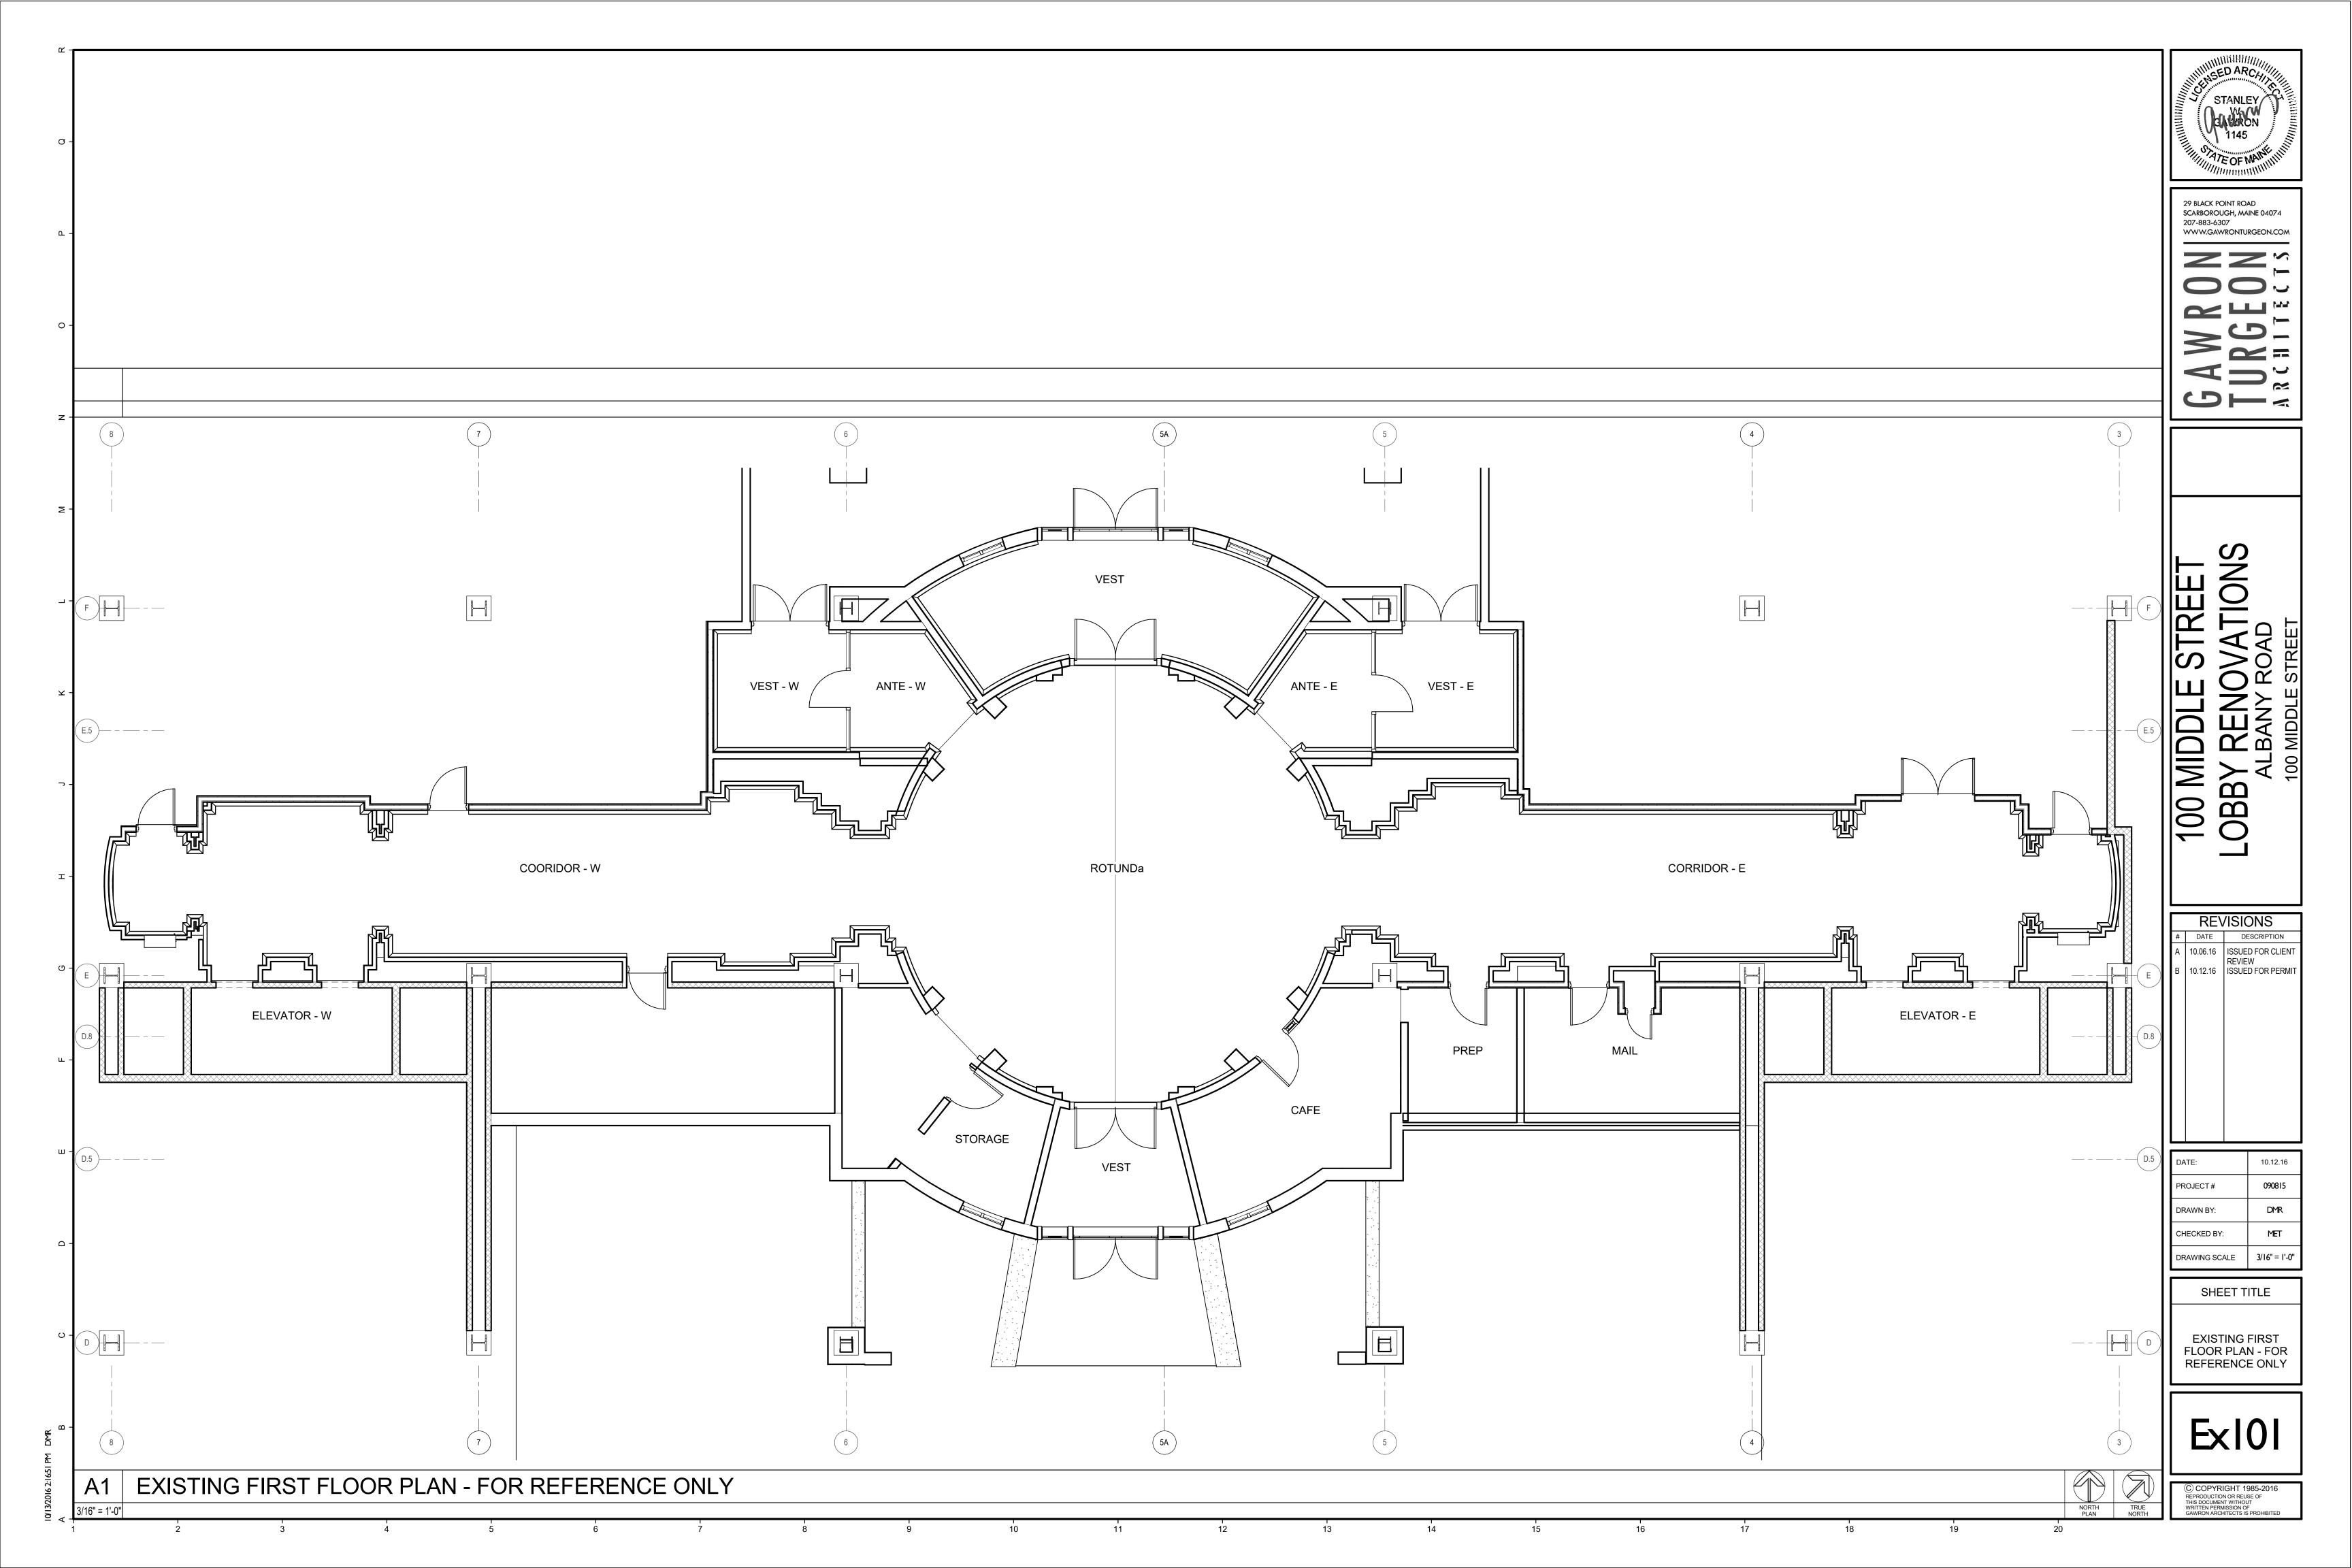

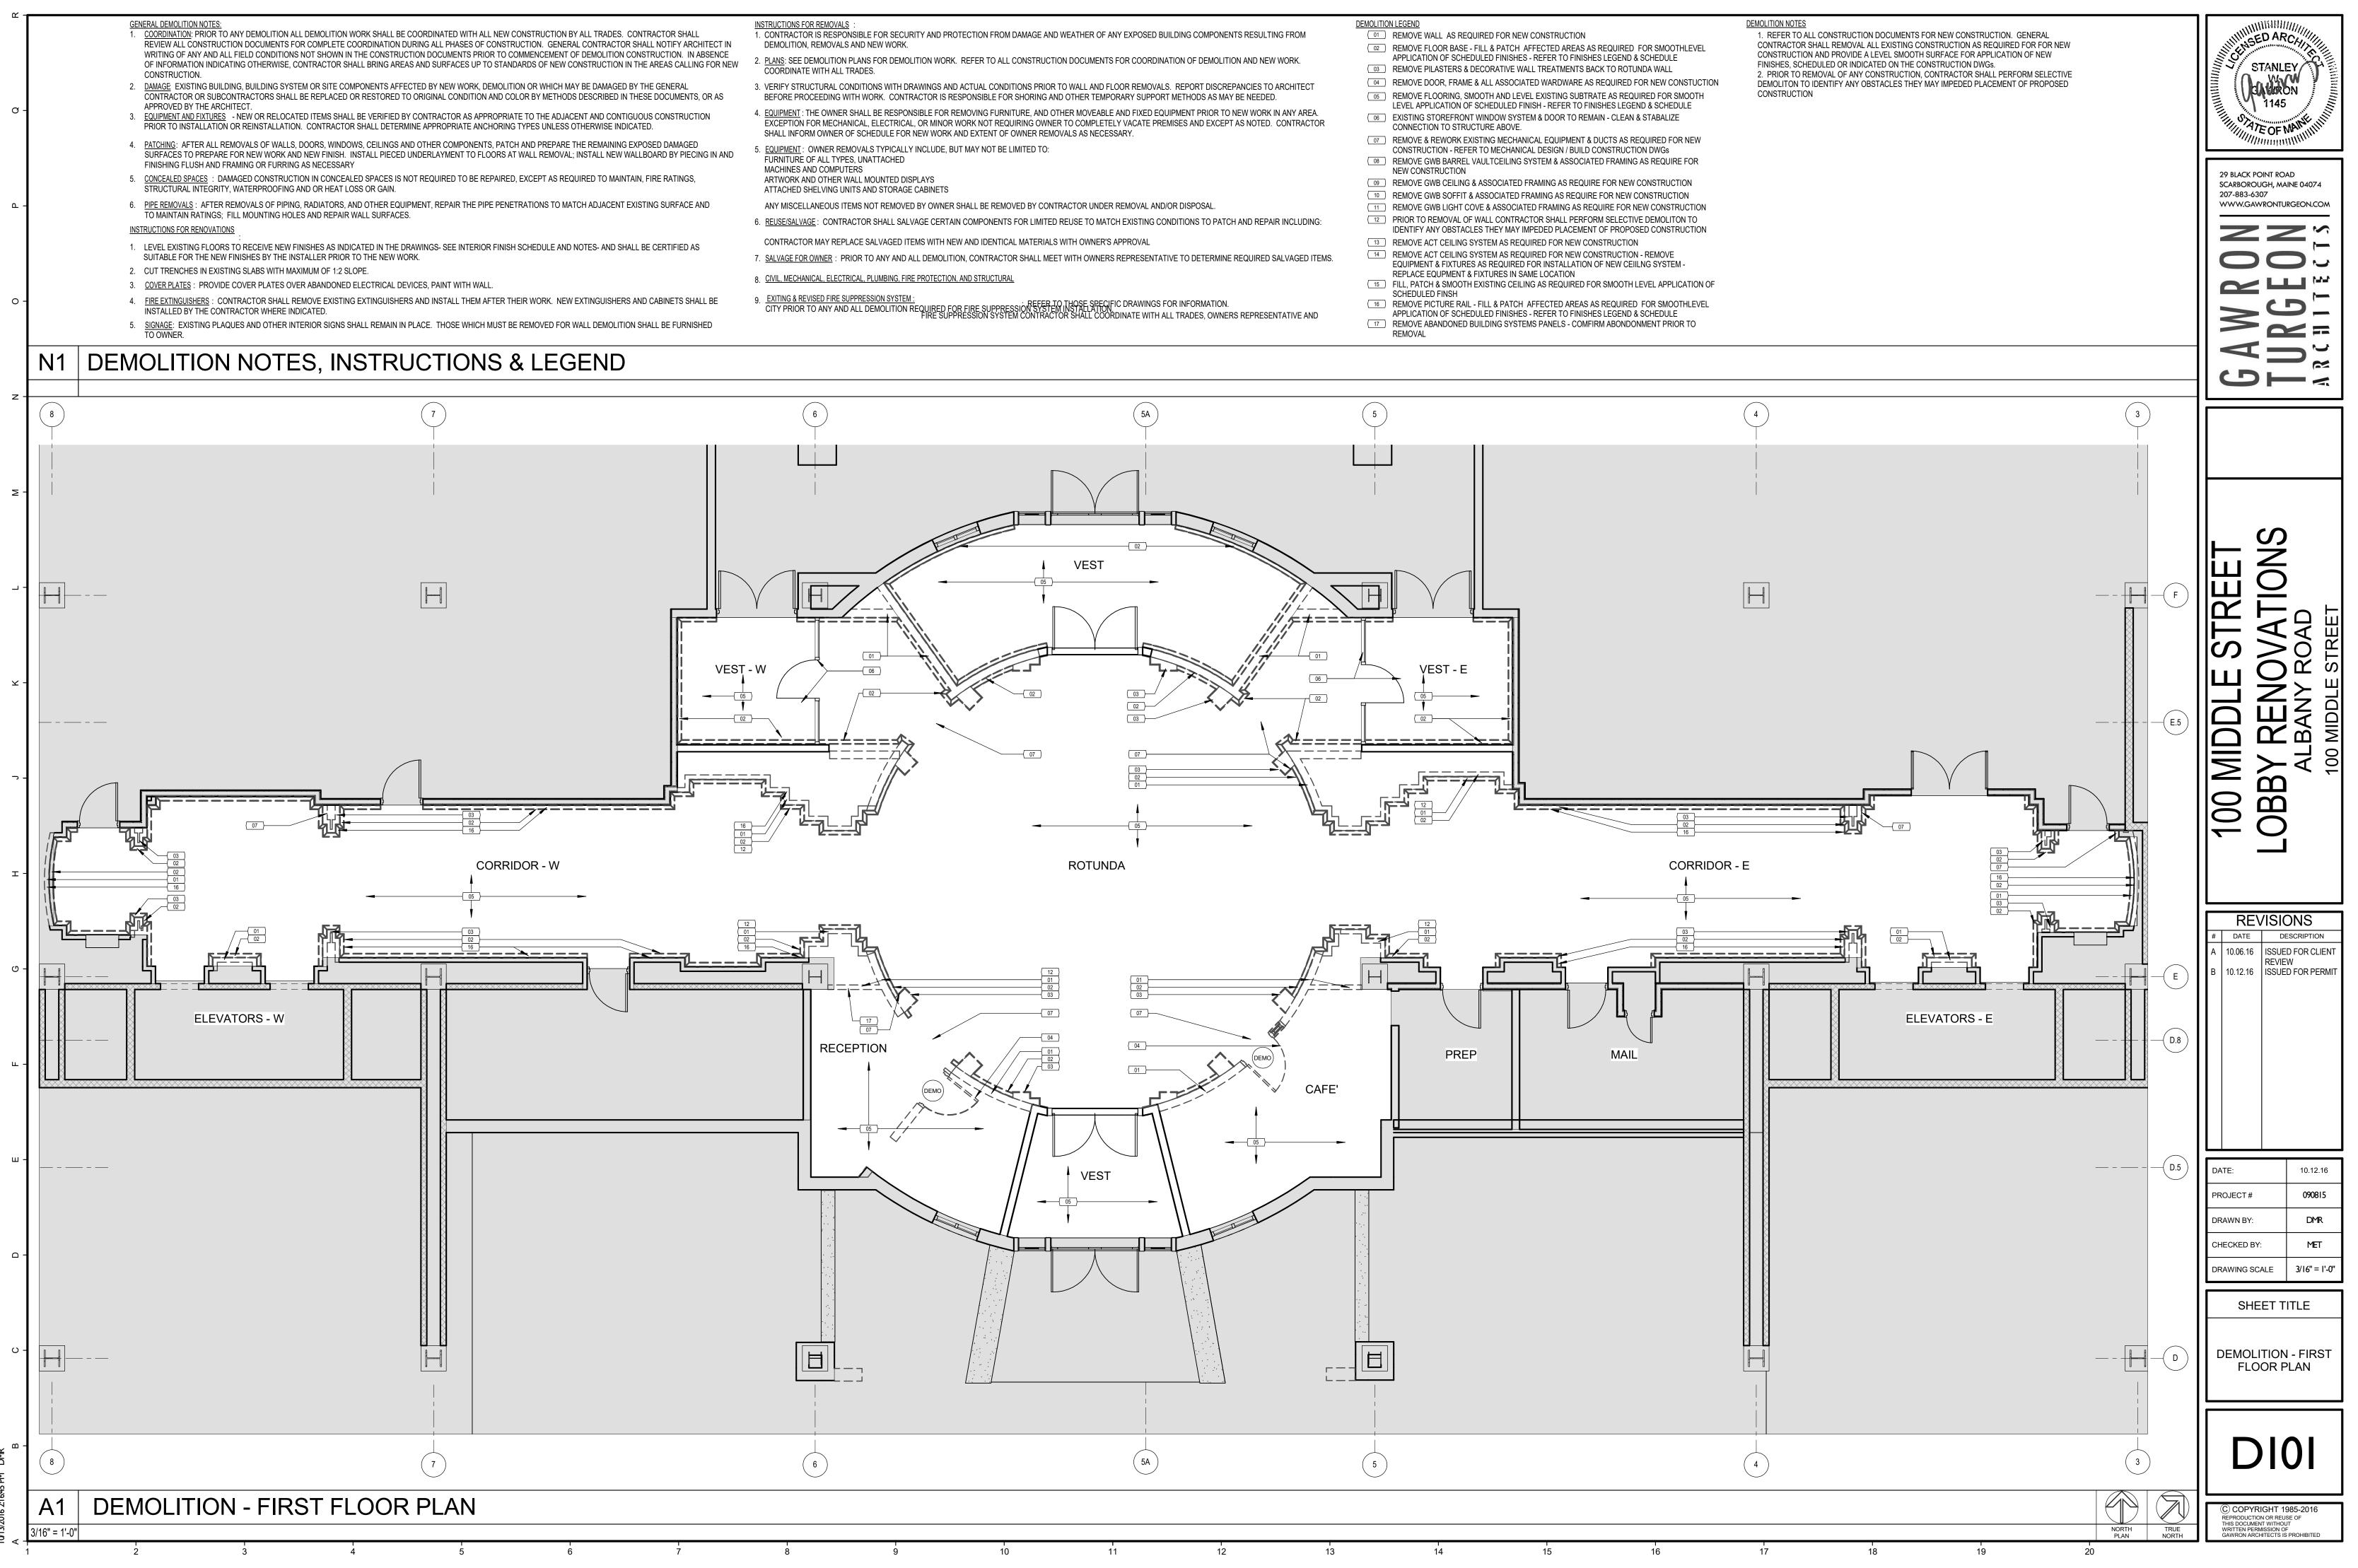


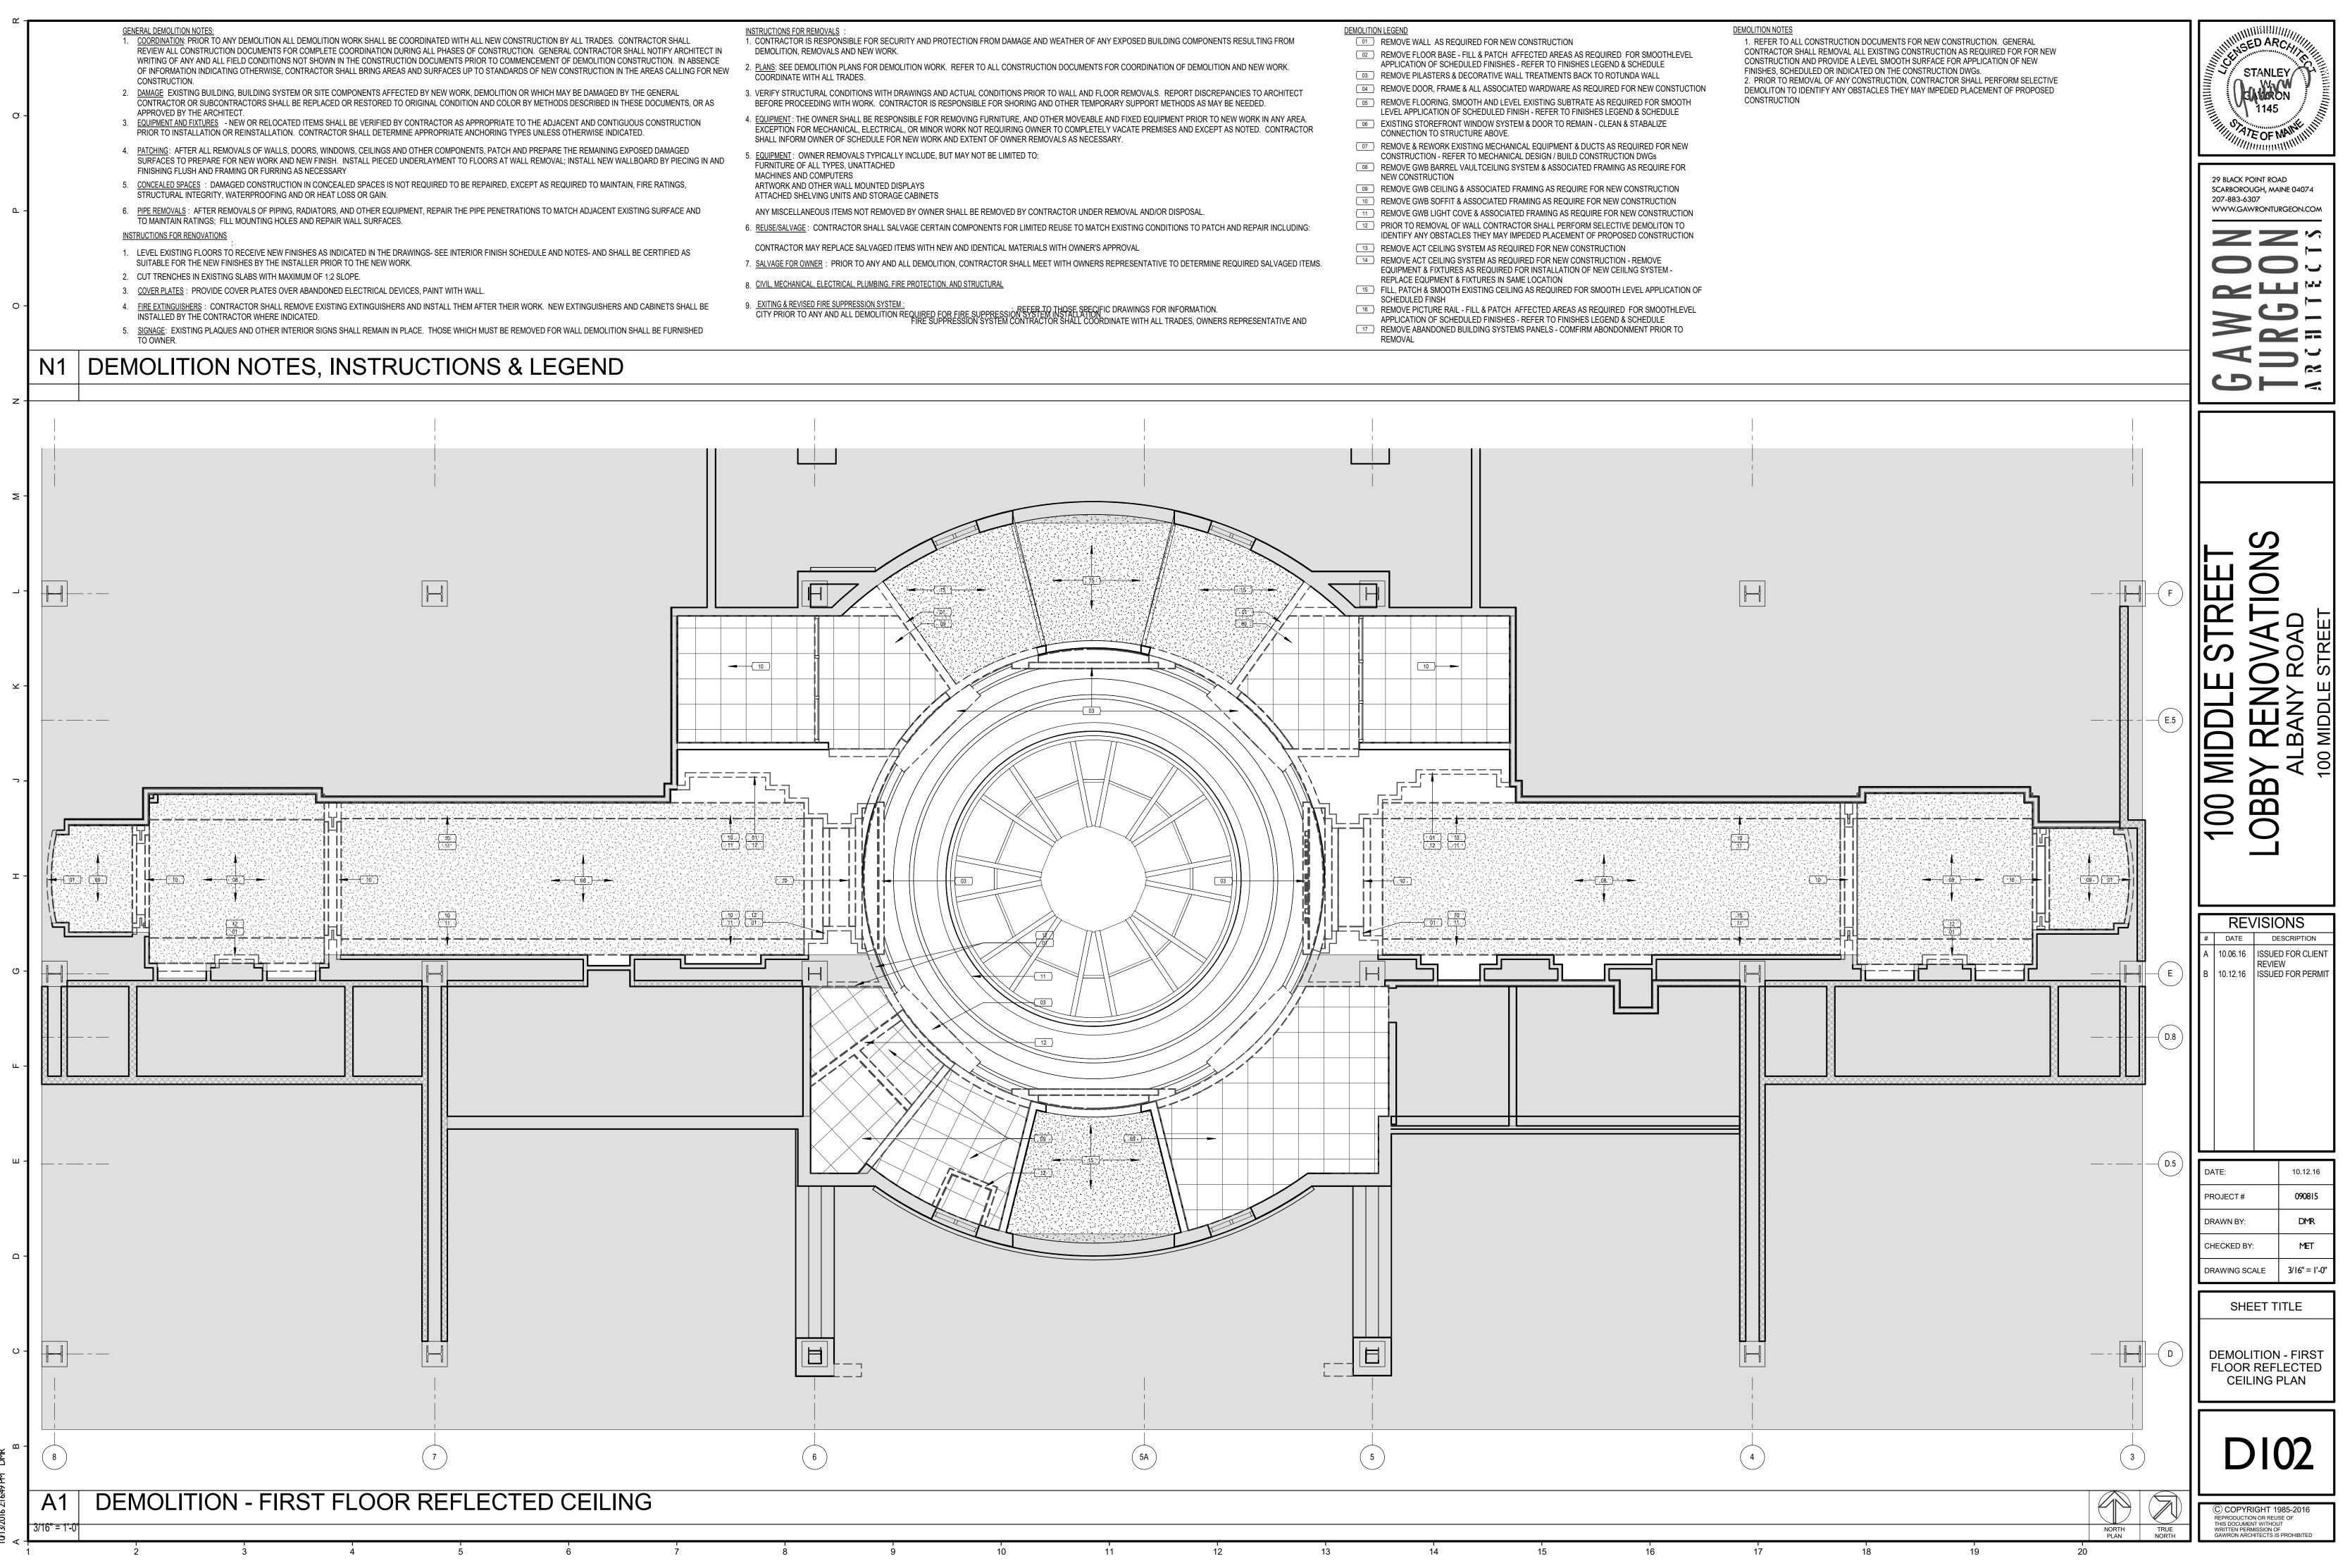


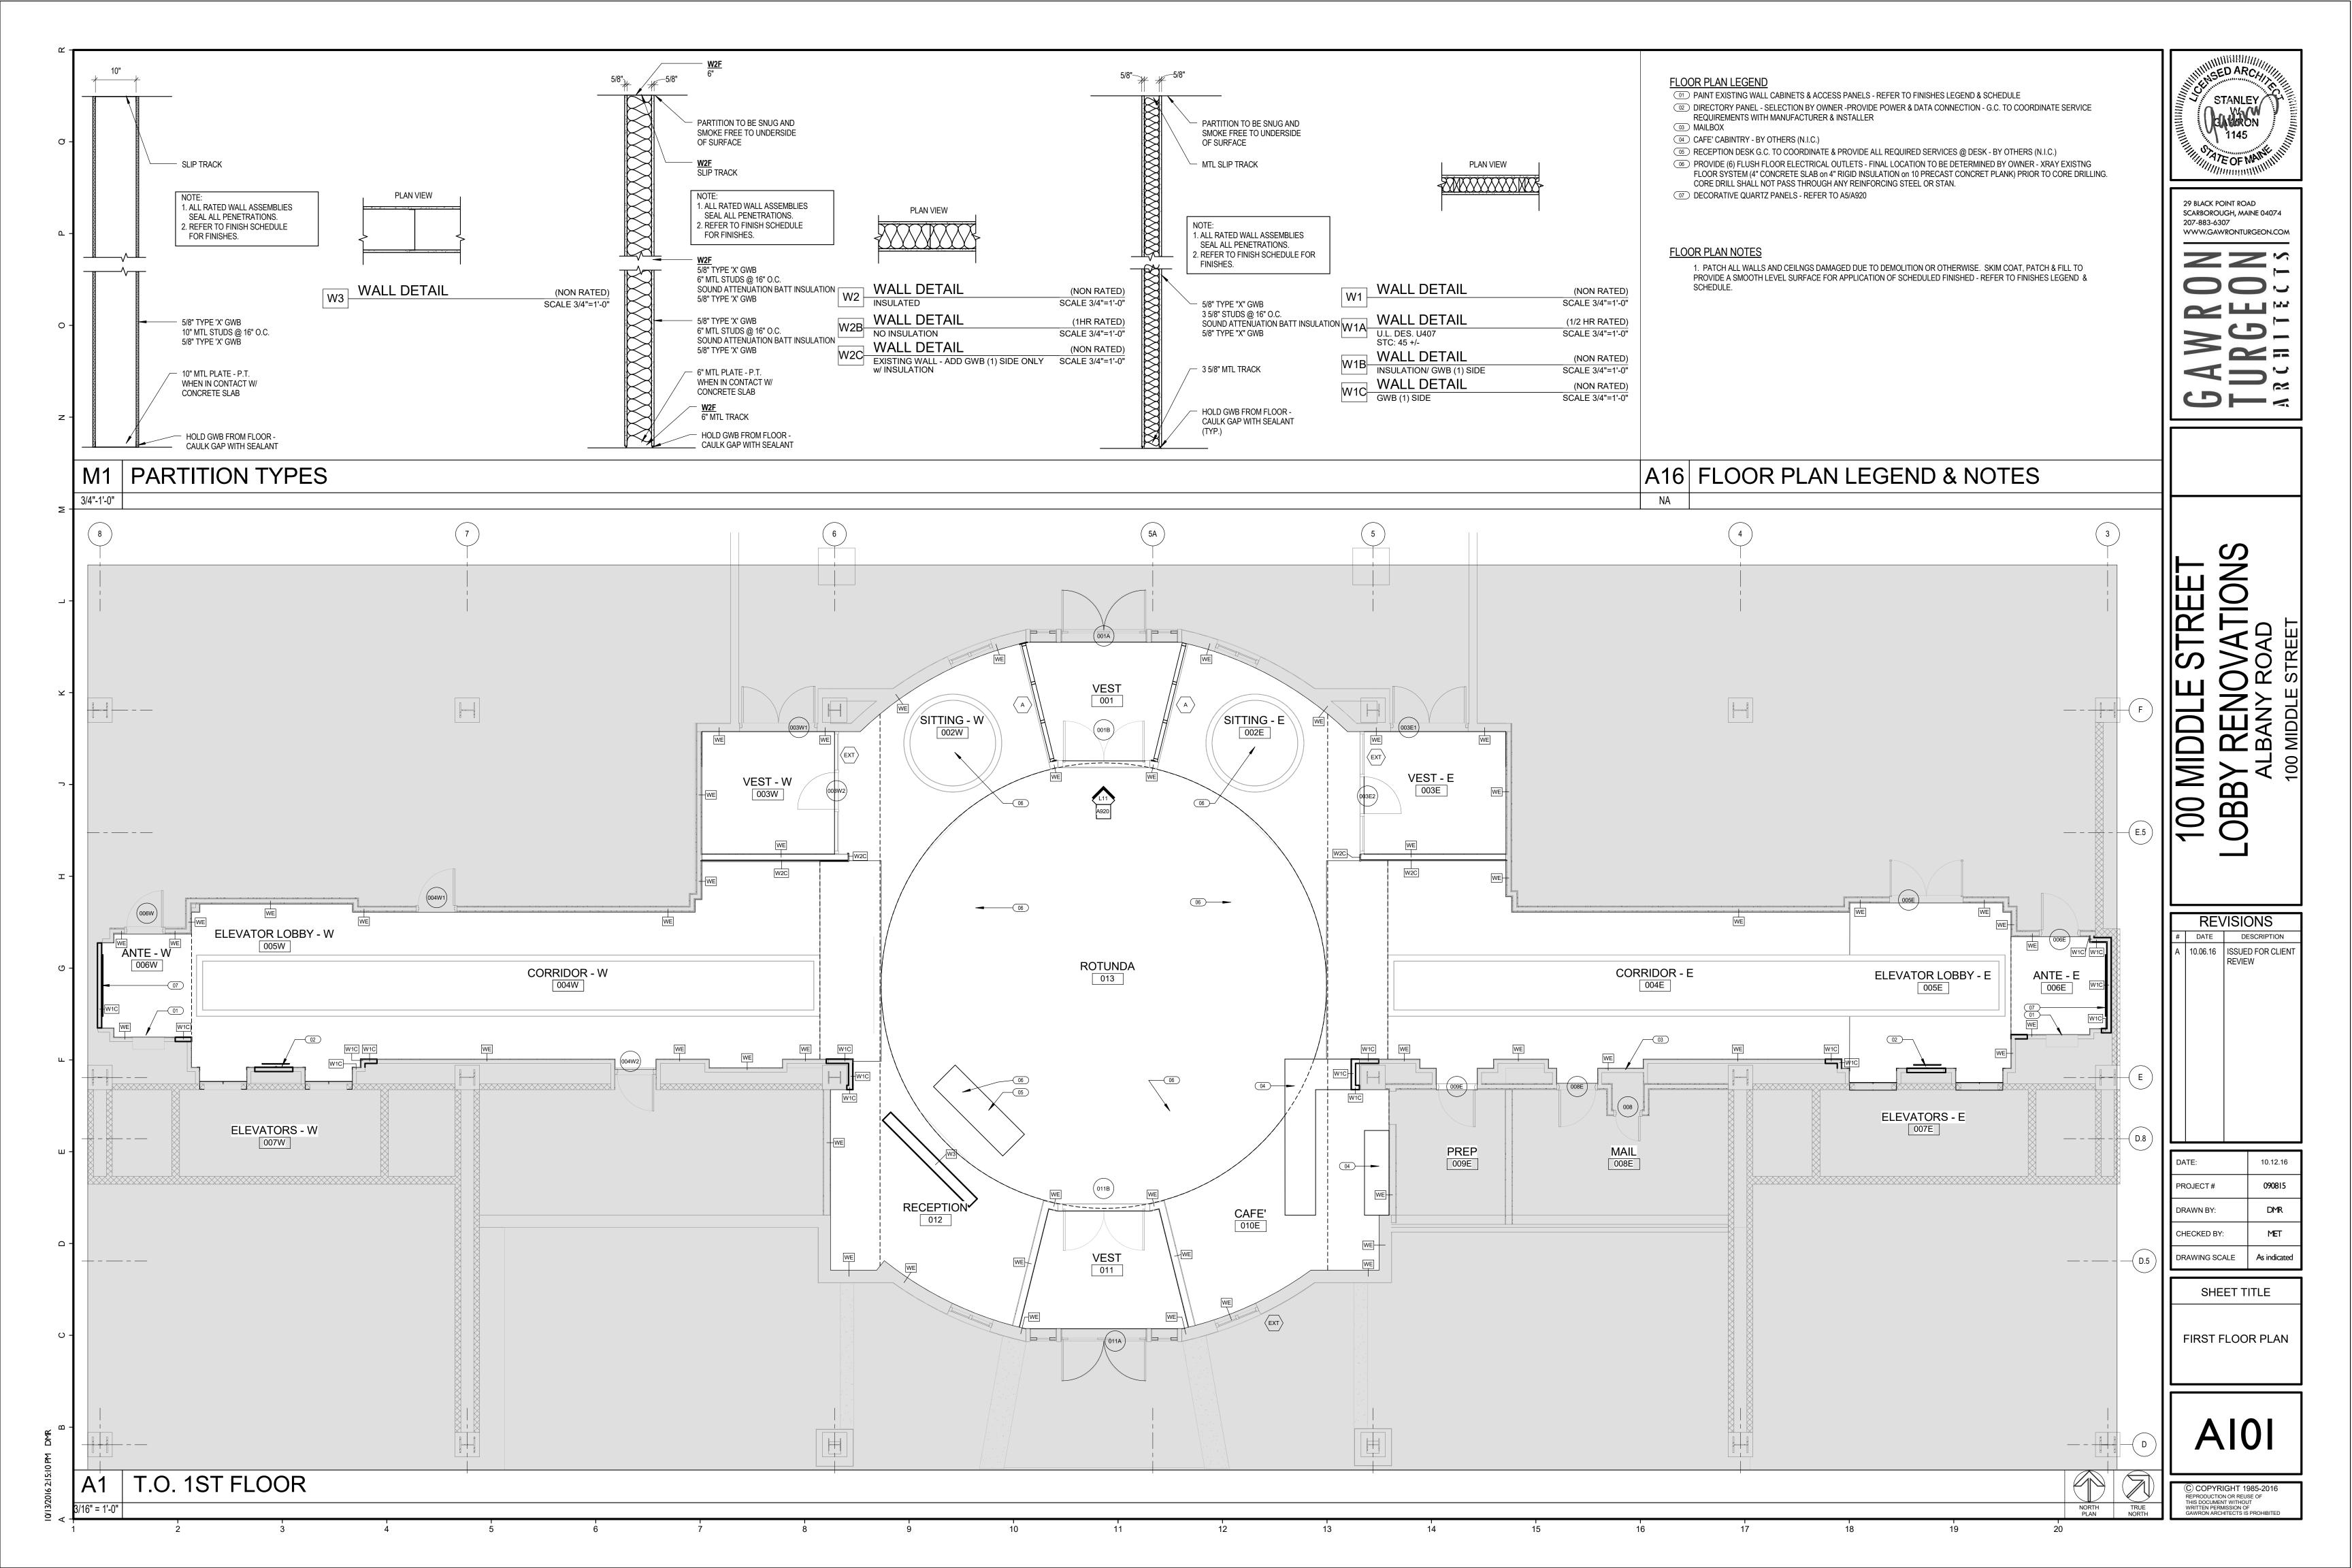


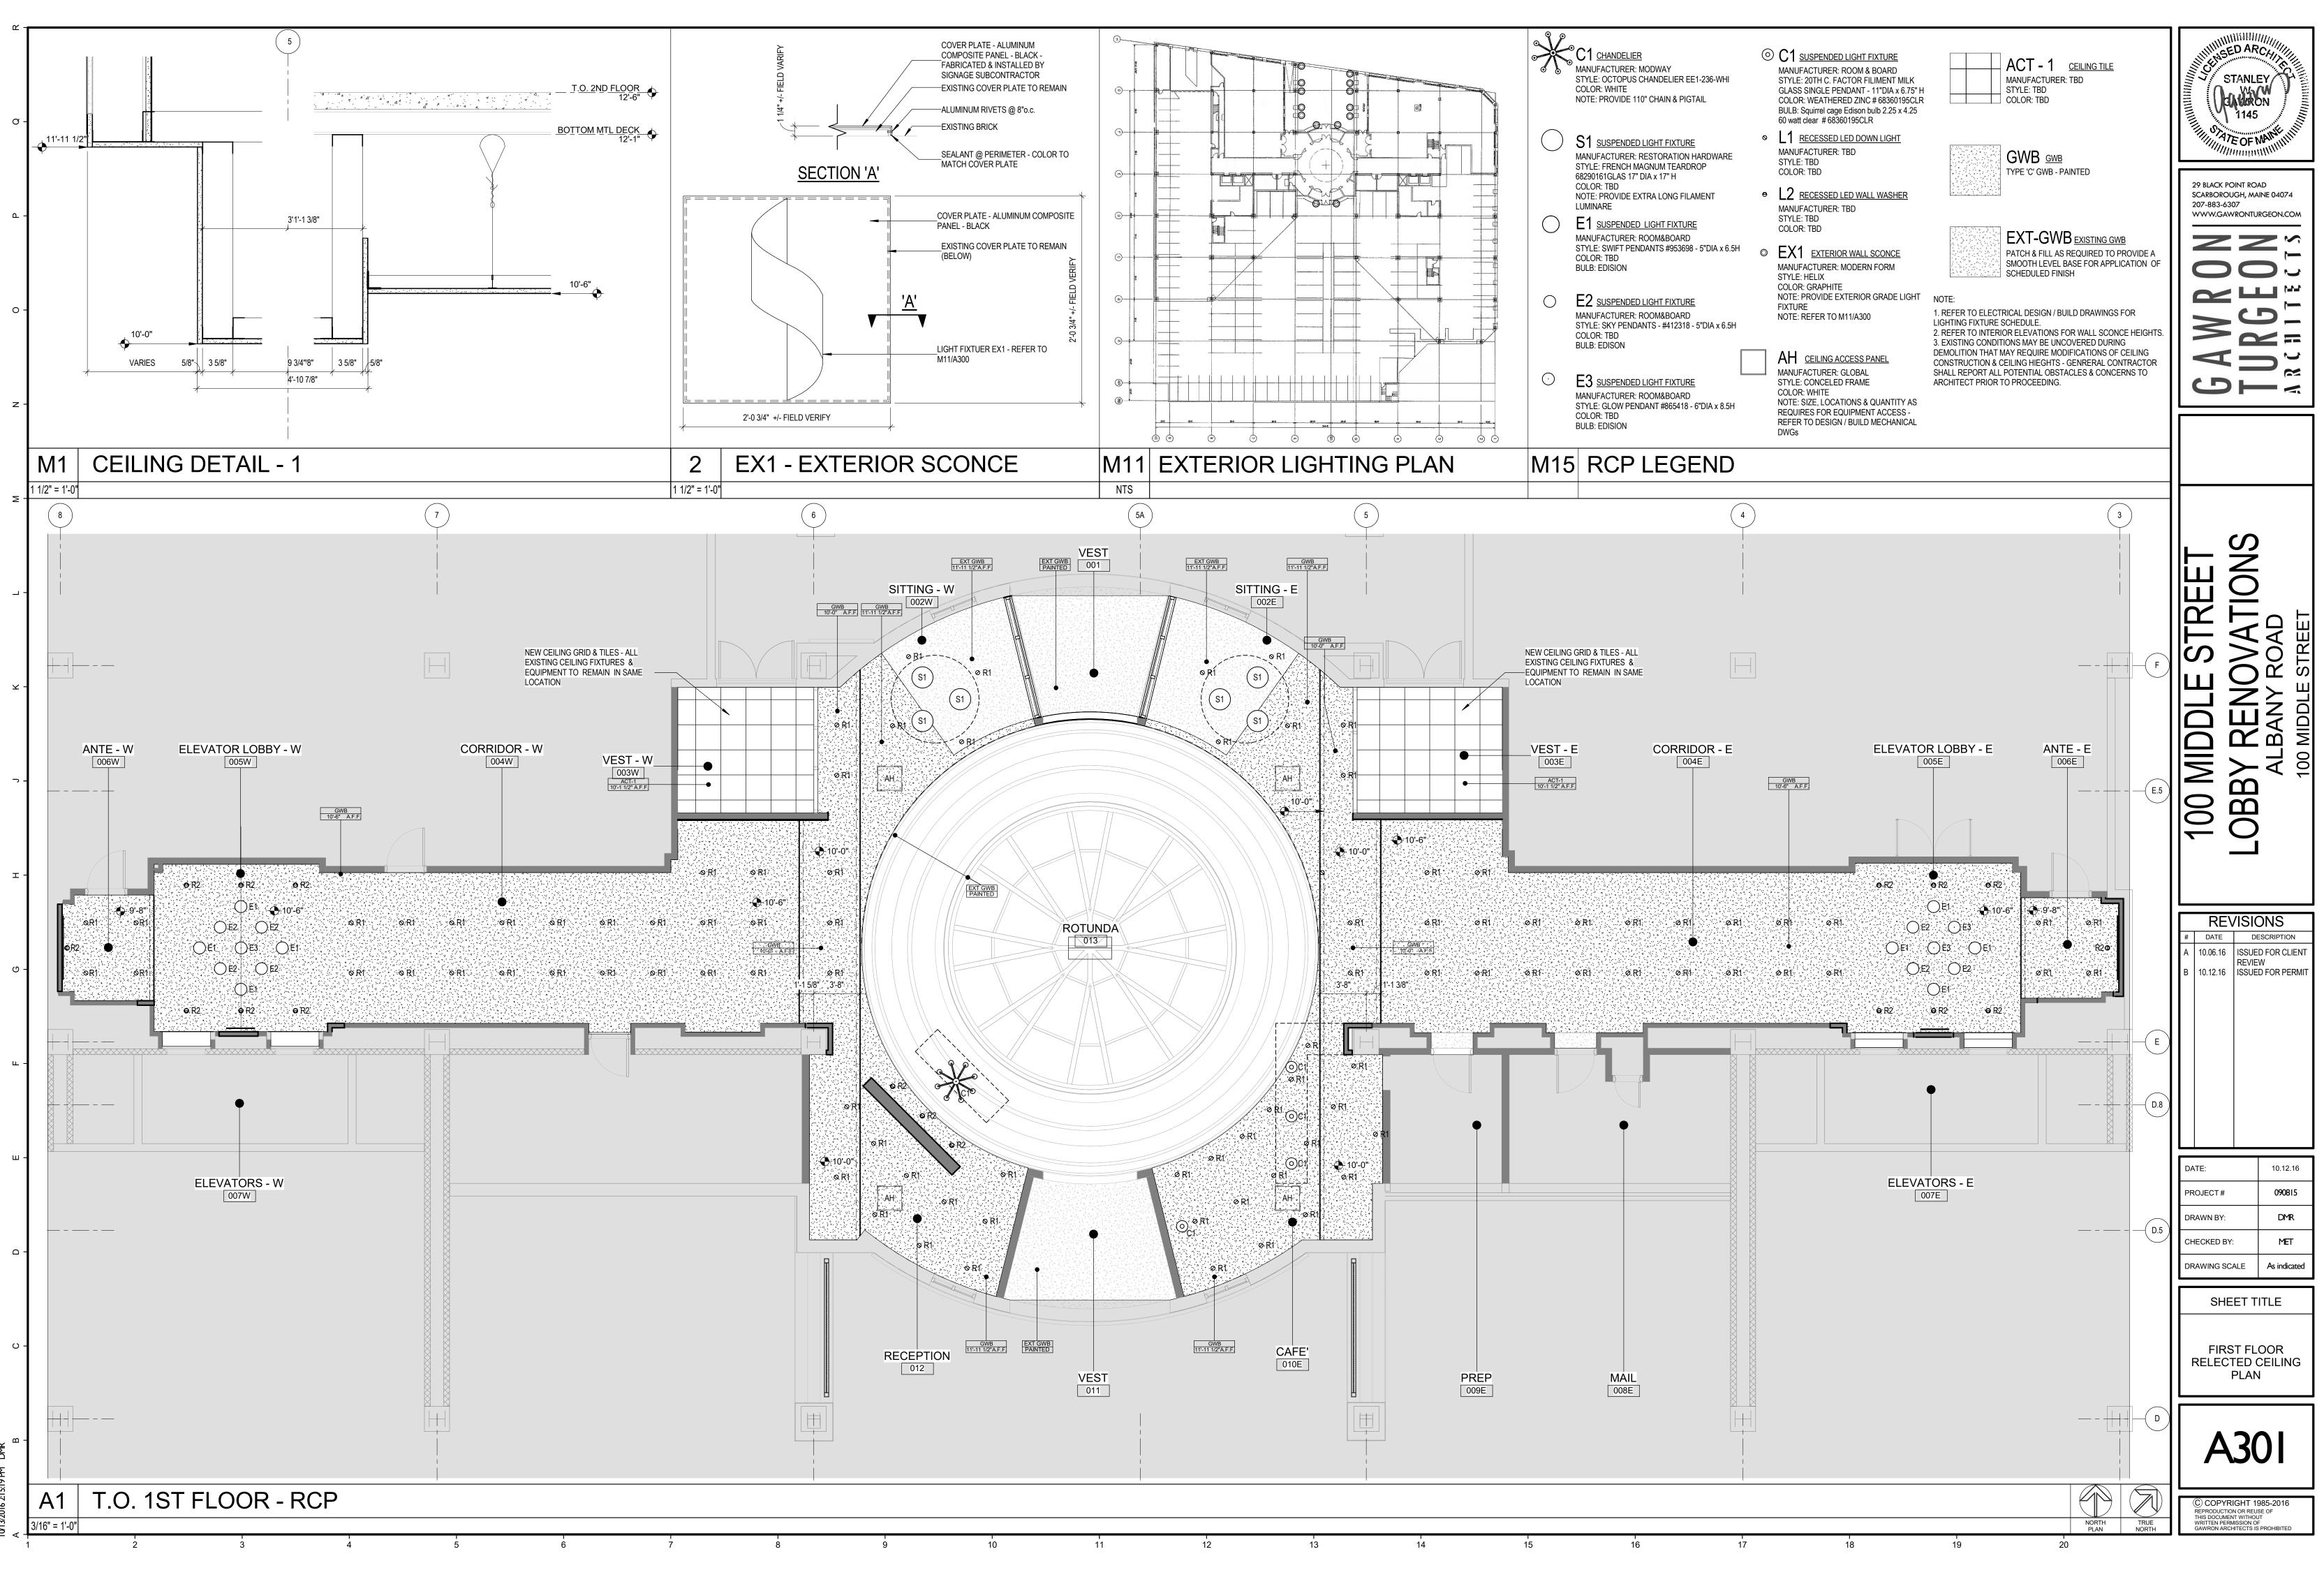


										EHO	ELECTRIC HOLD O		R SCHEDULE A	BBREVATION) (SOLID)
				DOOI	R SCHE	DULE				HM	HOLLOW METAL		FA FACTORY F EMP TEMPERED		WG S STAIN	
											METAL		THK THICKNESS		P PAINT	
				DOOR					FI DETAILS	RAME S				SILL CONDITI		
	NO		HGT. THICKNESS	MAT.	FINISH	REMARKS	TYPE	MAT.	HEAD J			REMARKS	MAT.	SILL	HEIGHT	RATIN
	001A 001B	6'-0"	6'-8" 0'-1 3/8" 6'-8" 0'-1 3/8"	WOOD WOOD	CLR POLY CLR POLY	NOTE 1 NOTE 1		WOOD WOOD		CLR	POLY	NOTE 1 NOTE 1		NEW ALUM.		NO CHA
	003E1 003E2 003W1	3'-0"	7'-0" 0'-1 3/4" 7'-0" 0'-1 3/4" 7'-0" 0'-1 3/4"	ALUM ALUM ALUM	KYNAR KYNAR KYNAR	NOTE 2 NOTE 2 NOTE 2	 	ALUM ALUM WOOD		KY	NAR	NOTE 2 NOTE 2 NOTE 2		NEW ALUM. NEW ALUM.		NO CHA NO CHA NO CHA
	003W2 004W1	3'-0"	7'-0" 0'-1 3/4" 7'-0" 0'-1 3/4"	ALUM	KYNAR CLR POLY	NOTE 2 NOTE 2 NOTE 1		ALUM		KY	NAR	NOTE 2 NOTE 1				NO CHA NO CHA
	004W2 005E	3'-0" 6'-0"	7'-0" 0'-1 3/4" 7'-0" 0'-1 3/4"	WOOD MTL / GLASS	CLR POLY NA	NOTE 1 NOTE 2		WOOD MTL		CLR N	POLY IA	NOTE 1 NOTE 2				NO CHA NO CHA
	006E 006W 008	3'-0"	7'-0" 0'-1 3/4" 7'-0" 0'-1 3/4" 7'-0" 0'-1 1/2"	HM HM	PAINT PAINT NA	NOTE 3 NOTE 3 NO WORK		HM HM NA		PA	JNT	NOTE 3 NOTE 3 NO WORK				NO CHA NO CHA NO CHA
	008E 009E	3'-0"	7'-0 0'-1 1/2 7'-0" 0'-1 3/4" 7'-0" 0'-1 3/4"	NA HM HM	PAINT PAINT	NOTE 3 NOTE 3	 	WOOD WOOD		CLR	POLY	NOTE 2 NOTE 1				NO CH/ NO CH/
	011A 011B	5'-0" 5'-0"	6'-8"0'-1 3/8"6'-8"0'-1 3/8"	WOOD WOOD	CLR POLY CLR POLY	NOTE 1 NOTE 1		WOOD WOOD		CLR CLR	POLY POLY	NOTE 1 NOTE 1		NEW ALUM. 		NO CH
	DEMO DEMO		7'-0" 0'-1 3/4" 6'-8" 0'-1 3/4"	DEMO DEMO	DEMO DEMO	NOTE 4 NOTE 4		DEMO DEMO				NOTE 4 NOTE 4				NO CH/ NO CH/
	DOOR S	CHEDULE NOTES:														
			OOD SURFACES IN PREPARATIO				SURFACES & APPLY CLE/	AR POLY PER MA	ANUFACTURERS IN	NSTRUCTIONS	- REFER TO FINISHI	ES SCHEDUL	E			
			IES ON DOOR & FRAMES - TOUC				ACES & APPLICATION OF	PAINT SHALL BI	E AS PER MANUFA	CTURER'S INS	TRUCTIONS - REFE	R TO FINISH	ES SCHEDULE			
			ASSOCIATED HARDWARE AS RE													
1 DOOR S	SCHEDUULE															

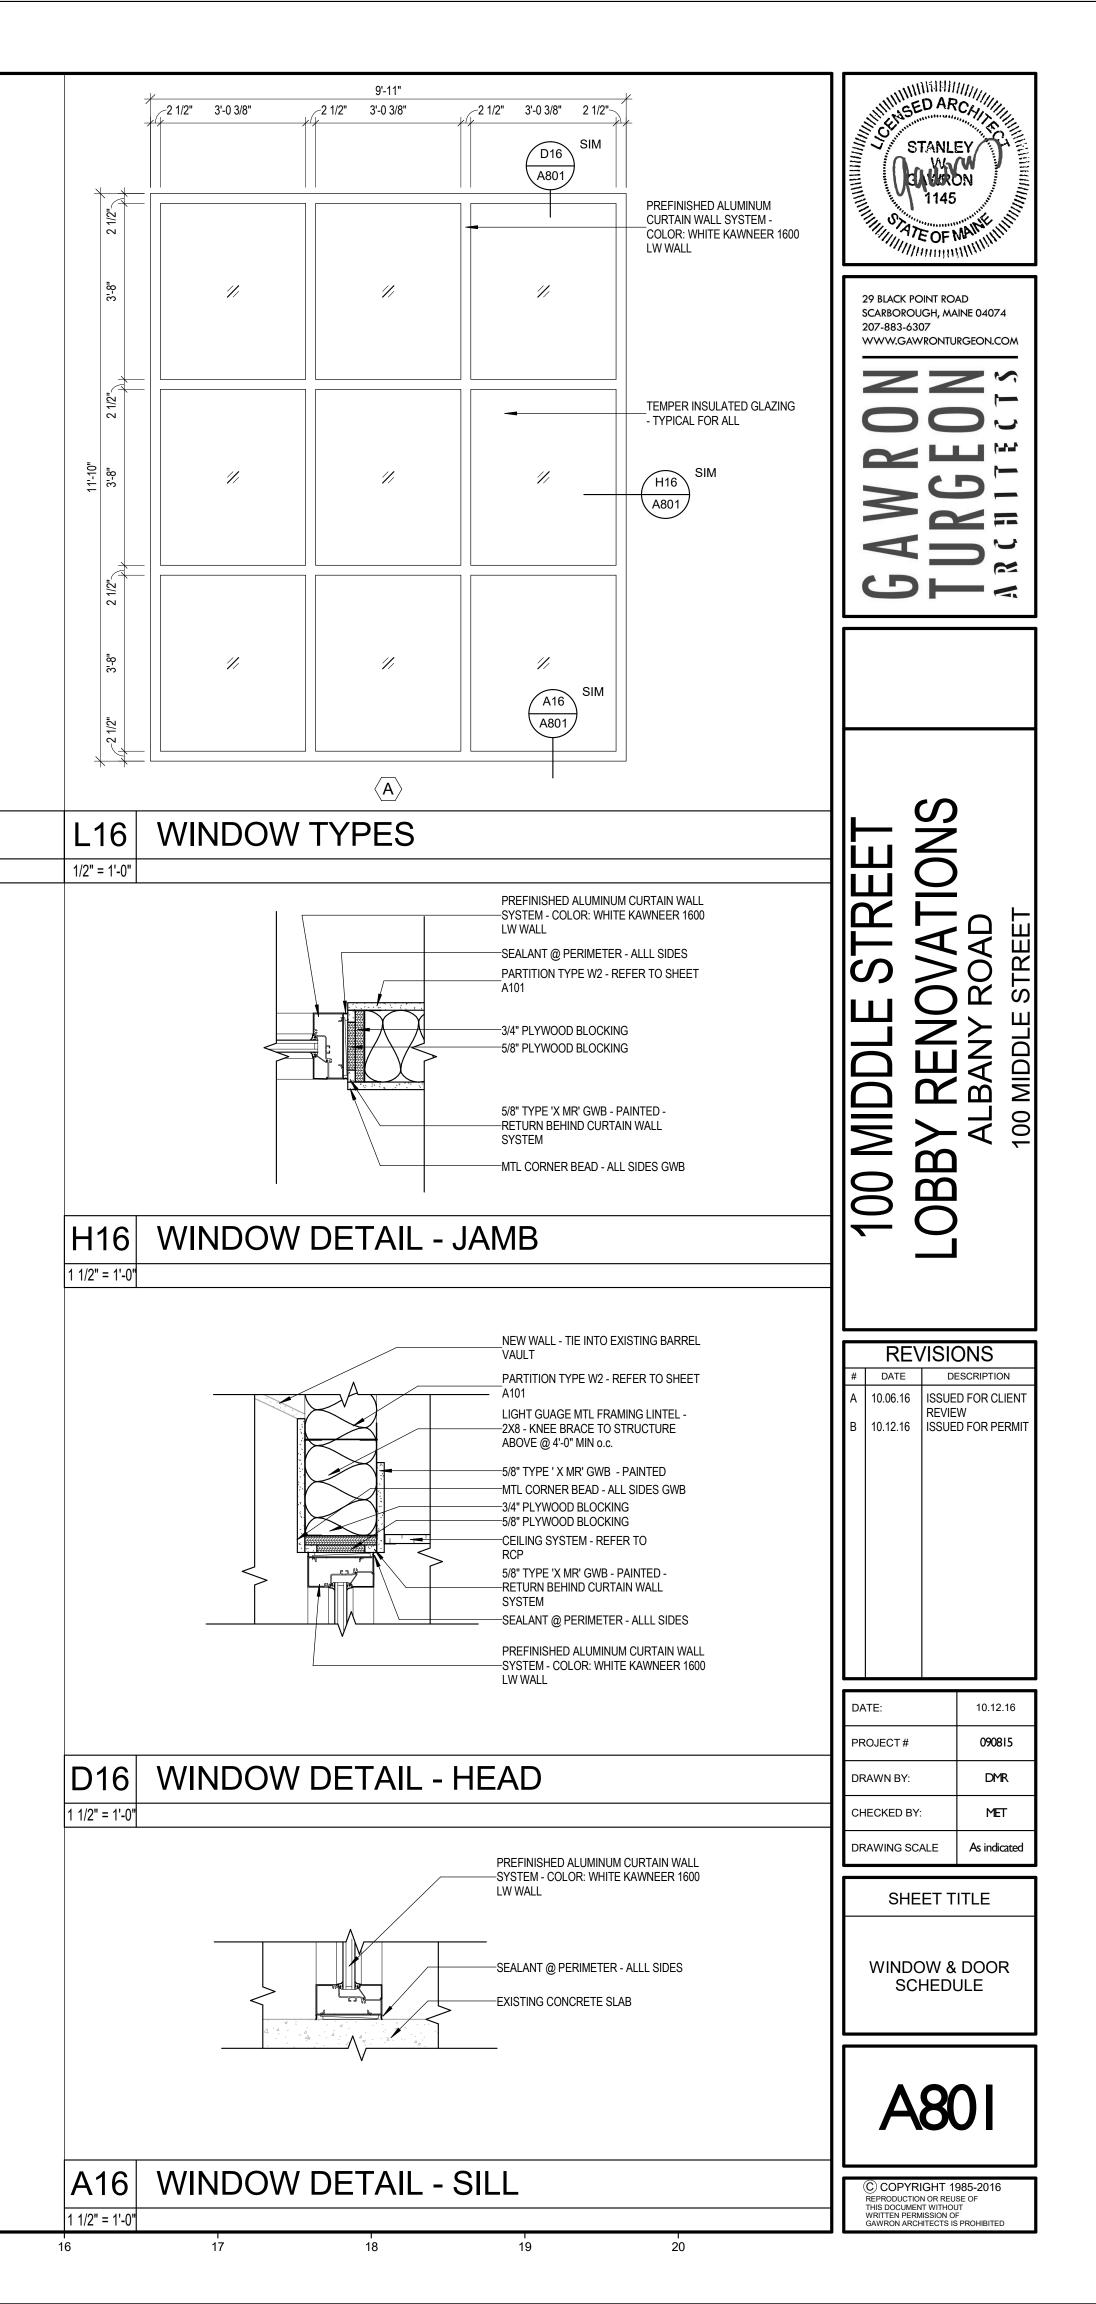

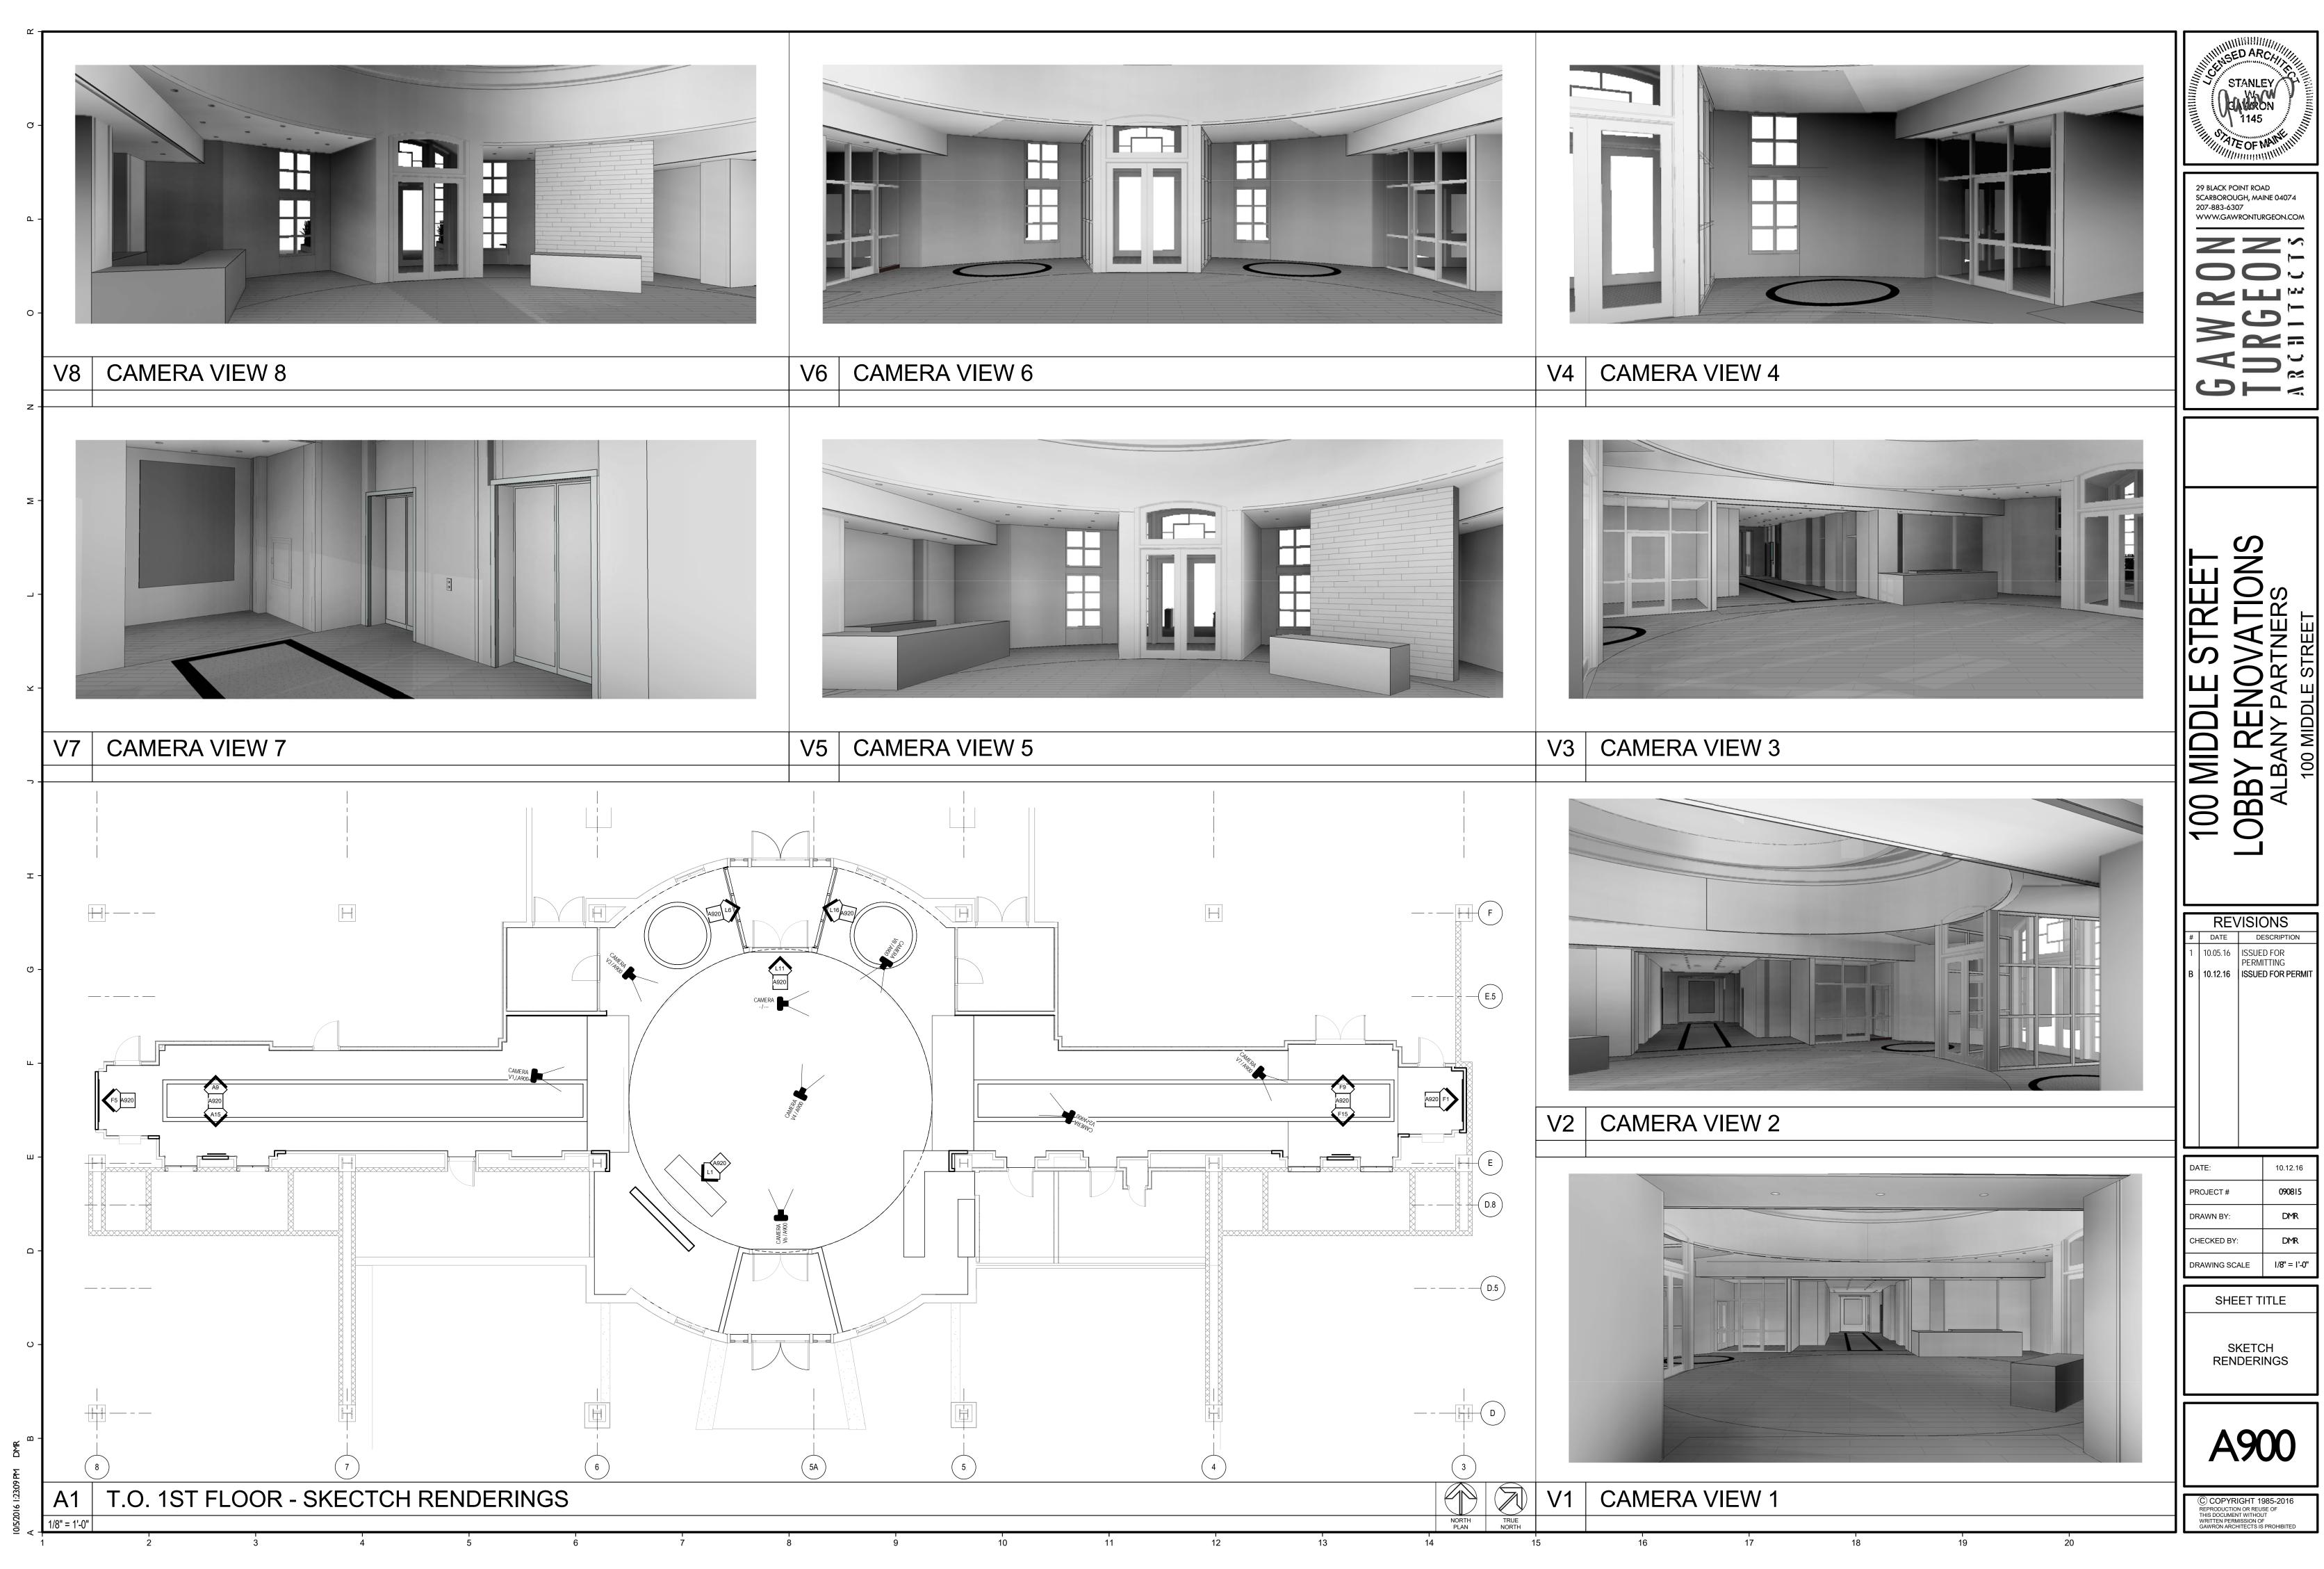

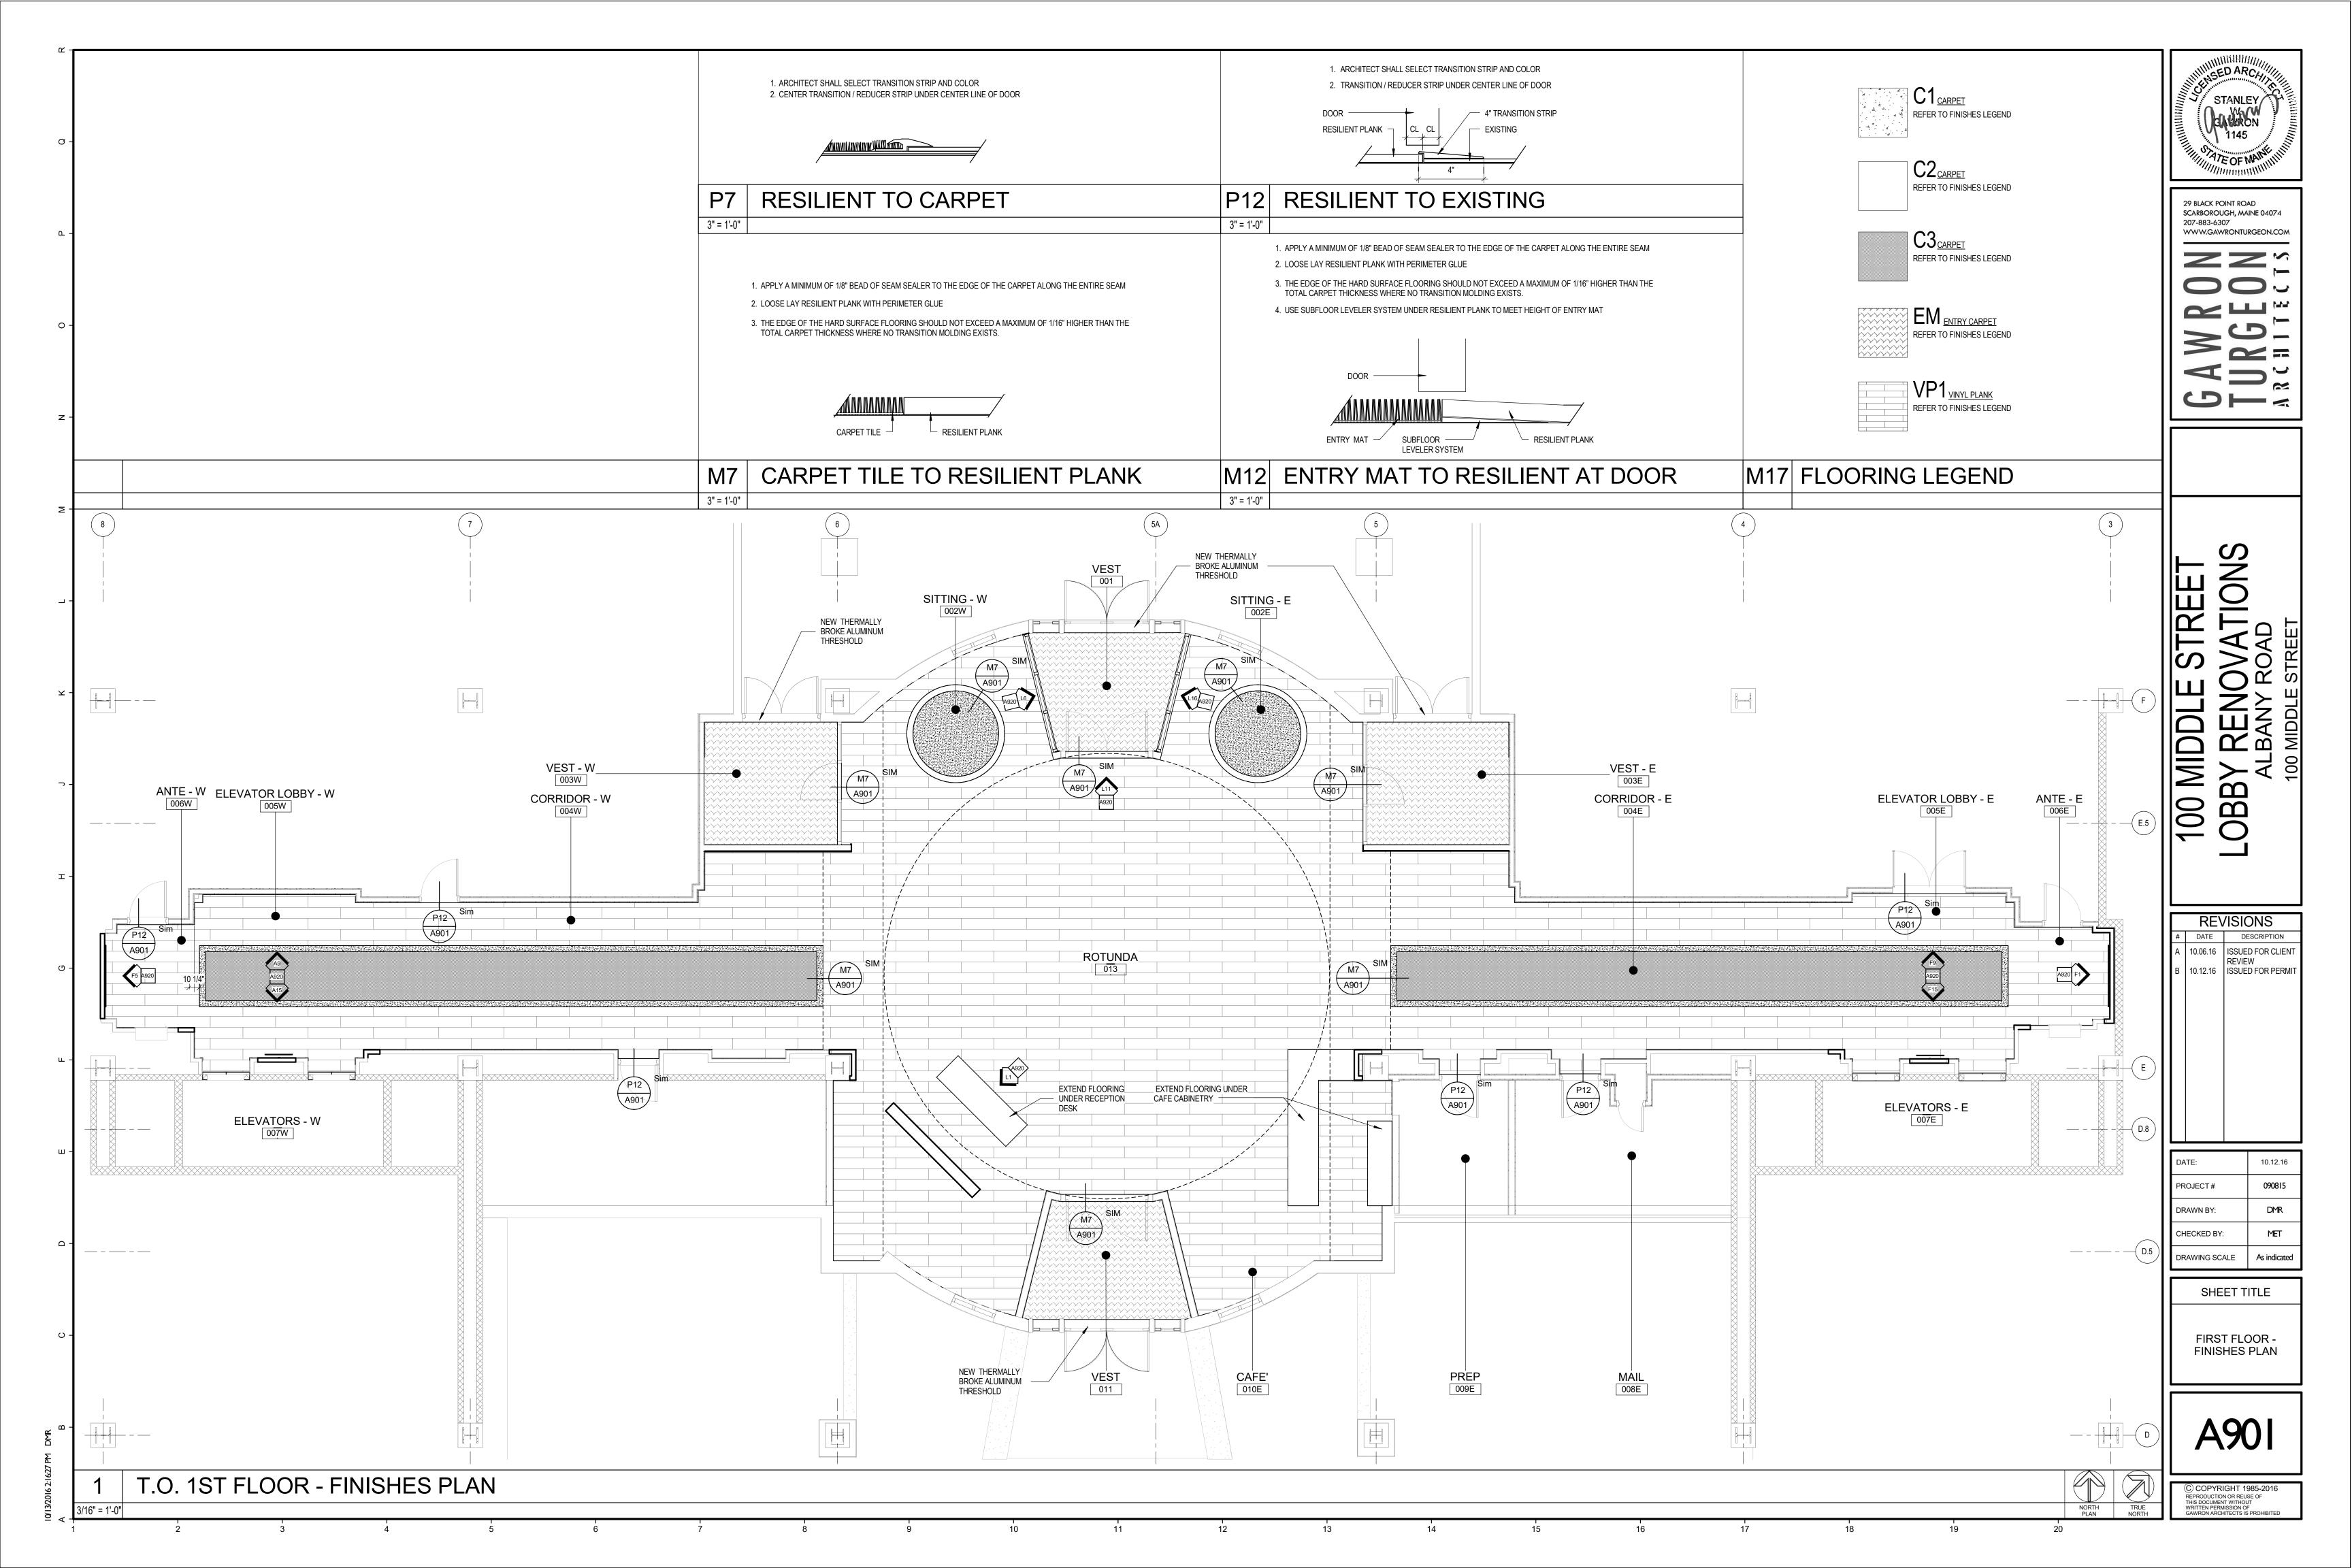

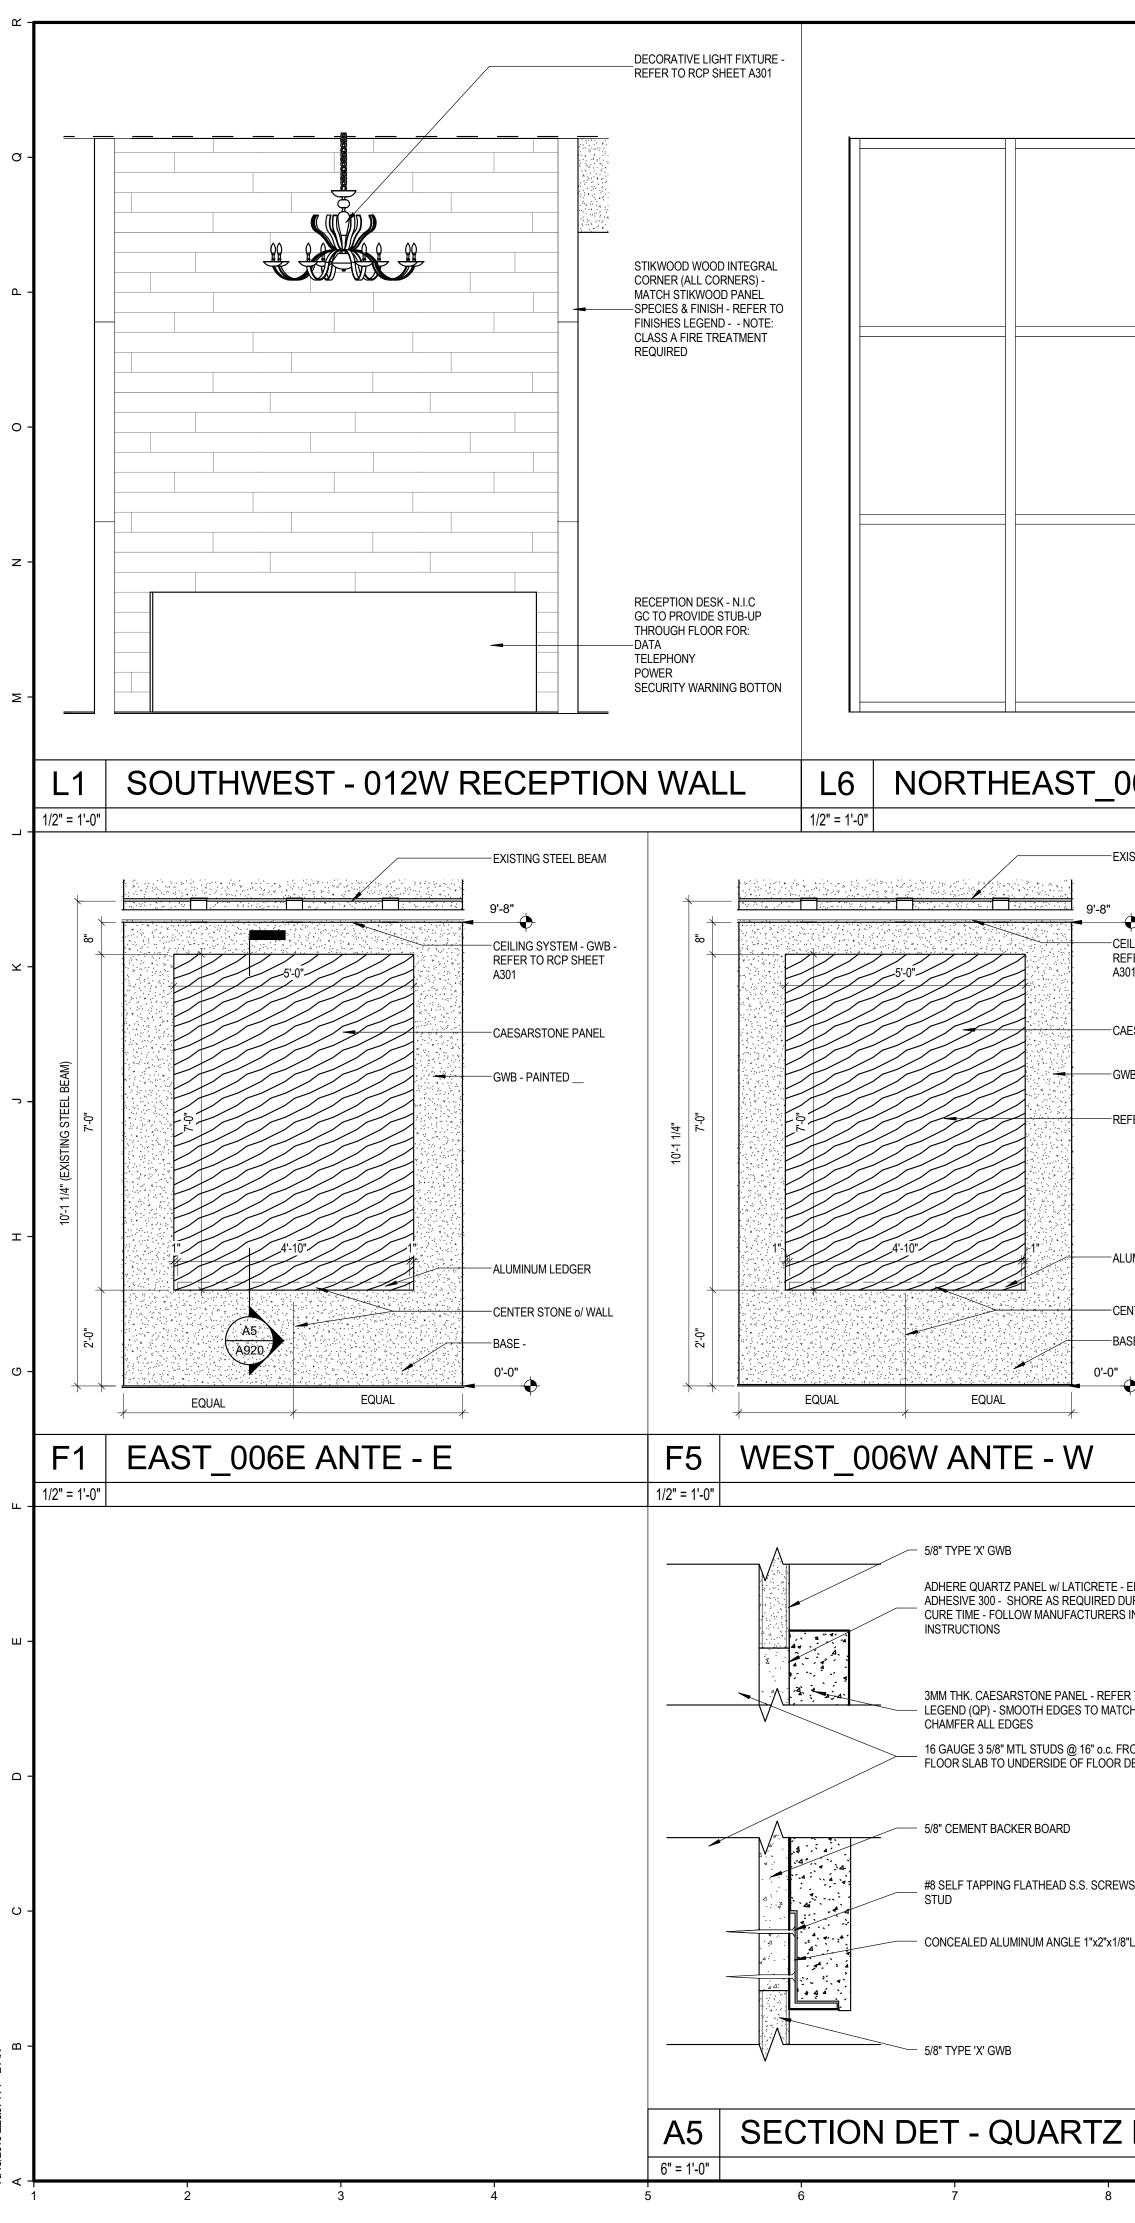

PREFINISHED ALUMINUM CURTAIN WALL SYSTEM- COLOR: WHITE KAWNEER 100 UW WALL TEMPER INSULATED GLAZING - TYPICAL FOR ALL GWB - PAINTED	PREFINSHED ALUMINUM CURTAIN WALL SYSTEM - COLOR WINNEER 1600 LW WALL REFINISH DOOR & TRANSOM - REFER TO DOOR SCHEDULE TEMPER INSULATED GLAZING - TYPICAL FOR ALL GWB - PAINTED	29 BLACK POINT ROAD SCARBOROUGH, MAINE 04074 207-883-6307 WWW.GAWRONTURGEON.COM
DO2W SITTING - W L11 NORTH - 013 ROTUNDA	FLOOR BASE - TBD FLOOR BASE - TBD L16 NORTHWEST_002E SITTING - E	ONS
INSTING STEEL BEAM	SUSPENDED LIGHT FIXTURES - REFER TO REFLICED CELING PLAN- TO REFLICED CELING PLAN- TO REFLICE CELING PLAN- TO BE DETERMINED IN THE FIELD OWB - PAINTED LED DIRECTORY - PROVIDE SERVICES AS PROVINEED - OWNER TO PROVIDE DIRECTORY ELEVATOR DOOR, FRAME & CAB REMOVATIONS BY ELEVATOR CONTRACT - G.C. TO COORDINATE ALL REQUIREMENTS WIELEVATOR CONTRACTOR ELEVATOR CALL BY ELEVATOR CONTRACTOR ELEVATOR CALL BY ELEVATOR CONTRACTOR ELEVATOR CALL BY ELEVATOR CONTRACTOR HEREONERS SERVICES - ALL REQUIREMENTS WIELEVATOR CONTRACTOR - ELEVATOR CALL BY ELEVATOR CONTRACTOR - ELEVATOR BY ELEVATOR - CONTRACTOR - ELEVATOR BALE - TED	Align Didentities Image: Stress of the stress of
F9 NORTH_005E ELEVATOR LOBBY - E 1/2" = 1'-0"	F15 SOUTH_005E ELEVATOR LOBBY - E 1/2" = 1'-0"	
INSTALLATION INSTA	SUSPENDED LIGHT FIXTURES - REFER TO REFLECTO CELING PLAN HEIGHT SUSPENDED ABOVE FLOOR TO BE DETERMINED IN THE FIELD GWB - PAINTED LED DIRECTORY - PROVIDE SERVICES AS REQUIRED - OWNER TO PROVIDE DIRECTORY ELEVATOR DOOR, FRAME & CAB RENOVATIONS BY ELEVATOR CONTRACT OR UNDER SEPARATE CONTRACT 0. C. TO COORDINATE ALL REQUIREMENTS WELEVATOR CONTRACT OR UNDER SEPARATE CONTRACT 0. C. TO COORDINATE ALL REQUIREMENTS WELEVATOR CONTRACT OR CONTRACT OR CONTRACT OR CONTRACT OR CONTRACT OR CONTRACT OR CONTRACT OR CONTRACTOR HELEVATOR CALL BY ELEVATOR CONTRACTOR HELEVATOR CALL BY ELEVATOR CONTRACTOR FLOOR BASE - TBD	DATE: 10.12.16 PROJECT # 090815 DRAWN BY: DMR CHECKED BY: MET DRAWING SCALE As indicated SHEET TITLE INTERIOR ELEVATIONS
PANEL A9 NORTH_005W ELEVATOR LOBBY - W 1/2" = 1'-0" 1/2" = 1'-0" 9 10 11 12 13 14	A15 SOUTH_005W ELEVATOR LOBBY - W 1/2" = 1'-0" 16 15 16 16 17 18 19 20	© COPYRIGHT 1985-2016 REPRODUCTION OR REUSE OF THIS DOCUMENT WITHOUT WRITTEN PERMISSION OF GAWRON ARCHITECTS IS PROHIBITED

RESILIENT FLOORING

SUBMITTALS

A. Provide Samples: For each type of product indicated. Samples shall be in form of manufacturer's color charts consisting of the following:

- 1. Welding Bead: Color charts consisting of strips of welding bead showing full range of colors available for each manufacturer.
- 2. Resilient Accessories: Color charts consisting of strips of resilient base showing the
- full range of colors available for each product exposed to view. B. Test Results: Provide results of specified alkalinity and adhesion tests, calcium chloride moisture tests, and relative humidity test specified. Include manufacturer's written moisture requirements for each resilient flooring type specified.

SEQUENCING AND SCHEDULING

A. Do not install flooring over concrete slabs until slabs have cured and are sufficiently dry to bond with adhesive as determined by manufacturer's recommended bond and moisture test.

EXTRA MATERIALS

A. Furnish extra materials described below that match products installed and that are packaged with protective covering for storage and identified with labels describing contents. 1. Floor PlankTile: Furnish 1 box of each type, color, and pattern of floor tile installed.

INSTALLATION MATERIALS

A. Concrete Slab Primer: Nonstaining type as recommended by flooring manufacturer. B. Trowelable Leveling and Patching Compounds: Latex-modified, Portland cement based or blended hydraulic cement based formulation provided or approved by resilient product manufacturer for applications indicated.

1. Product: Ardex; SD-F Feather Finish.

C. Latex Adhesives (Cements): Premium Grade, water-resistant type recommended by manufacturer to suit resilient products and substrate conditions indicated.

1. Provide spray adhesive for VCT.

2. Adhesive shall be compatible with radiant heat systems. E. Epoxy Adhesive: Two-part epoxy compound recommended by vinyl floor tile manufacturer.

EXAMINATION

- A. Examine substrates, with Installer present, for compliance with requirements for installation tolerances, moisture content, and other conditions affecting performance. 1. Verify that finishes of substrates comply with tolerances and other requirements specified in other Sections and that substrates are free of cracks, ridges, depressions,
- scale, and foreign deposits that might interfere with adhesion of resilient products. B. Proceed with installation only after unsatisfactory conditions have been corrected.

PREPARATION

A. Prepare substrates according to manufacturer's written recommendations to ensure adhesion of resilient products. B. Concrete Substrates: Verify that concrete slabs comply with ASTM F 710 and the

following: 1. Verify that substrates are dry and free of curing compounds, sealers, hardeners, and other materials whose presence would interfere with bonding of adhesive. Determine adhesion and dryness characteristics by performing bond and moisture tests recommended by flooring manufacturer, and with the specified requirements.

2. An independent testing agency shall perform alkalinity and adhesion tests, calcium chloride moisture tests, and relative humidity test. Testing shall be conducted as follows: a. Maintain a minimum temperature of 70 deg F in spaces to receive flooring for

at least 72 hours prior to and during the tests. b. Perform the tests at rate of not less than 1 test/1000 sq. ft. of floor area for

slabs-on-grade. c. Provide additional tests on floors after radiant heat has been in operation for

not less than 2 weeks. Perform tests while system is operating. 3. Alkalinity and Adhesion Testing: Perform tests recommended by manufacturer.

Proceed with installation only after substrates pass testing. 4. Moisture Testing:

a. Anhydrous Calcium Chloride Test: Perform tests in accordance with

recommendations of flooring manufacturer and ASTM F 1869, except area of CaCl² dish shall not be deducted.

b. Relative Humidity Test: Perform test using in situ probes, ASTM F 2170. 5. Proceed with installation only after substrates have maximum moisture-vaporemission rate of 3 lb of water/1000 sq. ft. in 24 hours, a maximum 75 percent relative

humidity level measurement, and manufacturer's requirements for alkalinity and adhesion are met.

C. Remove substrate coatings and other substances that are incompatible with adhesives and that contain soap, wax, oil, or silicone, using mechanical methods recommended by

manufacturer. Do not use solvents.

RESILIENT FLOOR COVERING INSTALLATION, GENERAL

A. Install in accordance with floor covering manufacturer's written instructions and requirements of this Section. B. Scribe, cut, and fit flooring to butt neatly and tightly to vertical surfaces and permanent

fixtures including built-in furniture, cabinets, pipes, outlets, edgings, door frames, thresholds, and nosings. C. Extend flooring into toe spaces, door reveals, closets, and similar openings. Extend

flooring to center of door openings, unless noted otherwise. D. Maintain reference markers, holes, and openings that are in place or marked for future cutting by repeating on floor covering as marked on substrates. Use chalk or other

nonpermanent, nonstaining marking device. E. Adhere floor coverings to substrates using a full spread of adhesive applied to substrate to produce a completed installation without open cracks, voids, raising and puckering at

joints, telegraphing of adhesive spreader marks, and other surface imperfections.

RESILIENT WALL BASE INSTALLATION

A. Apply wall base to walls, columns, pilasters, casework and cabinets in toe spaces, and other permanent fixtures in rooms and areas where base is required. Where toe space is less than 4-inches, cut down base to proper height.

B. Install straight base before installation of carpet. C. Install wall base in lengths as long as practicable without gaps at seams and with tops of

adjacent pieces aligned. D. Tightly adhere wall base to substrate throughout length of each piece, with base in

continuous contact with horizontal and vertical substrates.

E. Do not stretch wall base during installation. F. Job-Formed Corners:

1. Outside Corners: Use straight pieces of maximum lengths possible. Form without producing discoloration (whitening) at bends. Shave back of base at points where bends occur and remove strips perpendicular to length of base that are only deep enough to produce a snug fit without removing more than half the wall base

thickness. 2. Inside Corners: Use straight pieces of maximum lengths possible. Form by cutting an inverted V-shaped notch in toe of wall base at the point where corner is formed. Shave back of base where necessary to produce a snug fit to substrate.

3. Adhere base to substrate with contact adhesive 12 inches each side of outside corner to properly hold base in permanent proper position in tight contact with wall. Base shall run continuous around corners with butt joints 12 inches minimum for corner

G. Molded Resilient Wall Base: Inside and outside corners shall be miter cut and fitted using a compound miter saw in the field. Butts ends on running lengths to be mitered at 45 degrees.

RESILIENT ACCESSORY INSTALLATION

A. Resilient Molding Accessories: Butt to adjacent materials and tightly adhere to substrates throughout length of each piece. Install reducer strips at edges of floor coverings that would otherwise be exposed.

CLEANING AND PROTECTION

A. Perform the following operations immediately after completing resilient product

installation 1. Remove adhesive and other blemishes from exposed surfaces using cleaner

recommended by resilient products manufacturers.

2. Sweep and vacuum surfaces thoroughly. 3. Damp-mop surfaces to remove marks and soil.

a. Do not wash surfaces until after time period recommended by manufacturer.

A6 | FLOORING NOTES - CARPET

I

2. Exposed Edge Stripping and Accessory: 12-inch long Samples. moisture tests, and relative humidity tests. Include manufacturer's written moisture requirements for each carpet type specified. E. Adhesive Certificates: Carpet manufacturer shall certify that proposed adhesives are acceptable for use with carpet. F. Moisture Testing:

indicated on Drawings and in schedules.

1. Carpet: 12-inch square Sample.

a. Anhydrous Calcium Chloride Test: Tests shall be conducted in accordance with ASTM F 1869-02, except that the area of the CaCl² dish shall not be deducted. b. Relative Humidity Test: Conduct in accordance with ASTM F 2170.

1.04 QUALITY ASSURANCE A. Preinstallation Conference: Conduct conference at project site." Review specified moisture and humidity test results, alkalinity and adhesion tests, ambient conditions, ventilation procedures, installation process, adhesive application, seam sealing procedures and seam layouts.

EXTRA MATERIALS

CARPET

SUBMITTALS

recommendations

required. Label

for each type of substrate required.

A. Furnish extra materials described below, before installation begins, that match products installed and that are packaged with protective covering for storage and identified with labels describing contents. 1. Carpet Tile: Furnish one box of each type, color, pattern of carpet tile installed. 2. Carpet, Broadloom: Furnish not less than 10 linear feet for every 500 linear feet installed.

INSTALLATION ACCESSORIES

A. Concrete Slab Primer: Nonstaining type provided by or recommended by the carpet

manutacturer B. Trowelable Leveling and Patching Compounds: Latex-modified, cement-based formulation provided by or recommended by the carpet manufacturer, permitting a moisture emission rate up to 5 lb/1000 sq. ft. /24 hours. C. Adhesives: Premium grade, water-resistant, mildew-resistant, nonstaining type to suit products and subfloor conditions indicated, that complies with flammability requirements for installed carpet and that is recommended by the carpet manufacturer, permitting a moisture emission rate up to 5 lb/1000 sq. ft. /24 hours. 1. Adhesives shall be compatible with radiant heat systems. D. Seaming Cement: Adhesive product recommended by carpet manufacturer for butting cut

EXAMINATION

A. Concrete Subfloors: Verify that concrete slabs comply with ASTM F 710 and the following:

1. Slab substrates are dry and free of curing compounds, sealers, hardeners, and other materials that may interfere with adhesive bond. Determine adhesion and dryness characteristics by performing bond and moisture tests recommended by carpet manufacturer, and with the following specified requirements: 2. An independent testing agency shall perform alkalinity and adhesion tests, calcium chloride moisture tests, and relative humidity tests.

a. Perform tests on slabs to receive glue down carpet installation at rate of 1 test/1000 sq. ft. of floor area for slabs-on-grade. b. Maintain a minimum temperature of 70° F in spaces to be tested for at least 72

hours prior to and during the tests. c. Provide additional tests at floors after radiant heat has been in operation for

not less than 2 weeks. Perform tests while system is operating. 3. Alkalinity and Adhesion Testing: Shall result in pH range recommended by carpet and carpet tile manufacturers when subfloor is wetted with potable water and pHydrion paper is applied. Perform pH tests on concrete floors regardless of age or

grade level. 4. Proceed with installation only after substrates have maximum moisture-vaporemission rate of 3 lb of water/1000 sq. ft. in 24 hours, a maximum 75% relative humidity level measurement, and manufacturer's requirements for alkalinity and

adhesion are met.

5. Subfloors are free of cracks, ridges, depressions, scale, and foreign deposits of any kind.

PREPARATION

A. Level subfloor within 1/4-inch in 10 feet, non-cumulative, in all directions using product recommended by manufacturer. Sand or grind protrusions, bumps, and ridges. 1. Use leveling and patching compounds to fill cracks, holes, and depressions in

subfloor as recommended by carpet manufacturer. B. Remove coatings, including curing compounds, and other substances that are incompatible with adhesives and that contain soap, wax, oil, or silicone, without using solvents. Use mechanical methods recommended in writing by the carpet manufacturer.

C. Broom and vacuum clean substrates to be covered immediately before installing carpet. After cleaning, examine substrates for moisture, alkaline salts, carbonation, or dust. Proceed with installation only after unsatisfactory conditions have been corrected. D. Concrete Subfloor Preparation: Apply concrete slab primer, according to manufacturer's

directions, where recommended by the carpet manufacturer. 3.03 INSTALLATION A. Direct-Glue-Down Installation: Comply with CRI 104, Section 9, "Direct Glue-Down

Installation. B. Extend carpet into toe spaces, door reveals, closets, open-bottomed obstructions, removable

flanges, alcoves, and similar openings. 3.04 CLEANING AND PROTECTION

A. Perform the following operations immediately after installing carpet: 1. Remove excess adhesive, seam sealer, and other surface blemishes using cleaner

2. Remove yarns that protrude from carpet surface.

NA

recommended by carpet manufacturer.

INTERIOR FINISH LEGEND 090815

100 MIDDLE STREET LOBBY

CODE	MATERIAL	MANUFACTURER	PRODUCT STYLE & COLOR	FINISH
ACT-1	ACOUSTIC CEILING SYSTEM	ARMSTRONG	CIRRUS - 24IN x 24IN BEVELED TEGULAR 9/16 - WHITE	
B1	BASE MOULDING	JOHNSONITE	REVEAL 6" HIGH - COLOR: SANDALWOOD	
C1	CARPET	SHAW FLOORING	DRIFT - COLOR: FLOURISH	
C2	CARPET	SHAW FLOORING	SCULPT - TILE 5T007 - COLOR - 83515	TBD
C3	CARPET	SHAW FLOORING	SLAB - TILE 33518 - COLOR TBD	TBD
CAB1	CABINETS	NIC	NIC	NIC
CAB COUNTER	COUNTER TOPS	NIC	NIC	NIC
СР	CLEAR POLYURETHANE	TBD		SATIN
EM	ENTRY MAT	J & J FLOORING GROUP	INTELLIGENCE #1841	
EX - GWB	PAINTED GYPSUM BOARD	SHERWIN WILLIAMS	CEILING BRIGHT WHITE - SW7007	FLAT
GWB	PAINTED GYPSUM BOARD	SHERWIN WILLIAMS	CEILING BRIGHT WHITE - SW7007	FLAT
P1	PAINT	DONALD KAUFMAN COLOR	DK51	MATT
P2	PAINT	DONALD KAUFMAN COLOR	DK64	TBD
P3	PAINT	DONALD KAUFMAN COLOR	DK51	PERL
P4	PAINT	DONALD KAUFMAN COLOR	DK51	PERL
QP	QUARTZ PANEL	CAESARSTONE	STATUARIO NUVO	
SF	ALUMINUM STOREFRONT WALL SYSTEM	KAWNEER	601T - COLOR: WHITE	KYNAR
VP1	VINYL FLOORING	MOHAWK GROUP	HOT & HEAVY - SECOYA - KEW GARDENS 142	
WD	WOOD	STIKWOOD	RECLAIMED WEATHERED WOOD	

J10 INTERIOR FINISH LEGEND NA

														ABBRE	EVATIONS		
							FINIS 0908 LE STF	16				C G N/A P PL R SC SF SS ST	CARPET GROUT NOT APPLICABLE PAINT PLASTIC LAMINA RESILENT/ RUBB SEALED CONCRE SQUARE FEET SOLID SURFACE/ STAGE CURTAIN	TE ER/ RUBBER TREAD TE	SYD SQUARE YARD(S) T TILE TBS TO BE SELECTED VCB VINYL COVE BASE VCT VINYL COMPOSITION TILE CAB CABINETS WC PAPER TB TILE BASE WD WOOD QT QUARTZ TILE	A 10.06.16 ISSL	DESCRIPTION JED FOR CLI IEW
SA FLOOR		WALLS - CODE ORDER: ABOVE CHAIRRAIL/ FLOOR BELOWCHAIRRAIL CODE ORDER: PRIMARY /			_	COUNTERTOP / WORKSURFACE / TRIM CABINETS											
OM #	ROOM NAME		RY OR ACCENT	NORTH WALL	EAST WALL	SOUTH WALL	WEST WALL	CEILING	BASE	DOOR FRAMES	DOOR(S)	DOOR & WINDOW MOULDING	HORIZONTA L PLANE	VERTICAL PLANE	REMARKS		
ST FLC							-										
	VEST SITTING - E	NOTE: A NOTE: A	NA NA	P1	P1	P1	P1		B1 B1						REFER TO SHEET A901 & A941 REFER TO SHEET A901 & A941	DATE:	10.12.
						FI		EX-GWB	DI						CEFER TO SHEET A901 & A941		0908
																PROJECT #	
	SITTING - W	NOTE: A	NA	P1	P1	P1	P1	GWB / EX-GWB	B1					NOTE: A - F	REFER TO SHEET A901 & A941		
	SITTING - W VEST - E	NOTE: A	NA NA	P1	P1 P1	P1 P1	P1 P1	GWB / EX-GWB ACT-1	B1 B1					NOTE: A - F	REFER TO SHEET A901 & A941	DRAWN BY:	DM
	SITTING - W VEST - E VEST - W	NOTE: A NOTE: A NOTE: A	NA NA NA	P1 P1	P1 P1	P1 P1	P1 P1	GWB / EX-GWB ACT-1 ACT-1	B1					NOTE: A - F NOTE: A - F	REFER TO SHEET A901 & A941 REFER TO SHEET A901 & A941		D
	SITTING - W VEST - E VEST - W CORRIDOR - E	NOTE: A NOTE: A NOTE: A NOTE: A	NA NA NA NA	P1 P1 P1 P1	P1	P1	P1 P1 P1 P1 P1 P1	GWB / EX-GWB ACT-1 ACT-1 GWB	B1 B1					NOTE: A - F NOTE: A - F NOTE: A - F	REFER TO SHEET A901 & A941 REFER TO SHEET A901 & A941 REFER TO SHEET A901 & A941	DRAWN BY: CHECKED BY:	DN
	SITTING - W VEST - E VEST - W	NOTE: A NOTE: A NOTE: A	NA NA NA	P1 P1	P1 P1 P1	P1 P1 P1 P1	P1 P1 P1	GWB / EX-GWB ACT-1 ACT-1 GWB GWB	B1					NOTE: A - F NOTE: A - F NOTE: A - F NOTE: A - F	REFER TO SHEET A901 & A941 REFER TO SHEET A901 & A941	DRAWN BY:	
	SITTING - W VEST - E VEST - W CORRIDOR - E CORRIDOR - W ELEVATOR LOBBY - E ELEVATOR LOBBY - W	NOTE: A NOTE: A NOTE: A NOTE: A NOTE: A NOTE: A NOTE: A	NA NA NA NA NA NA NA NA	P1 P1 GWB / EX-GWB ACT-1 ACT-1 GWB GWB GWB GWB GWB	B1 B1 B1 B1 B1 B1					NOTE: A - F NOTE: A - F	REFER TO SHEET A901 & A941 REFER TO SHEET A901 & A941	DRAWN BY: CHECKED BY:	DN
	SITTING - W VEST - E VEST - W CORRIDOR - E CORRIDOR - W ELEVATOR LOBBY - E ELEVATOR LOBBY - W ANTE - E	NOTE: A NOTE: A NOTE: A NOTE: A NOTE: A NOTE: A NOTE: A NOTE: A	NA NA NA NA NA NA NA NA NA	P1 P1 P1 P1 P1 P1 P1 P1 P1 P1	P1 P1 P1 P1 P1 P1 P1 P1 P2	P1 P1 P1 P1 P1 P1 P1 P1 P1 P1	P1 P1 P1 P1 P1 P1 P1 P1 P1 P1	GWB / EX-GWB ACT-1 ACT-1 GWB GWB GWB GWB GWB	B1 B1 B1 B1 B1 B1 B1					NOTE: A - F	REFER TO SHEET A901 & A941 REFER TO SHEET A901 & A941	DRAWN BY: CHECKED BY:	Dh ME As ind
	SITTING - W VEST - E VEST - W CORRIDOR - E CORRIDOR - W ELEVATOR LOBBY - E ELEVATOR LOBBY - W ANTE - E ANTE - W	NOTE: A NOTE: A NOTE: A NOTE: A NOTE: A NOTE: A NOTE: A NOTE: A NOTE: A	NA NA NA NA NA NA NA NA NA NA	P1	P1 P1 P1 P1 P1 P1 P1 P1 P2 P1	P1	P1 P1 P1 P1 P1 P1 P1 P1 P1 P1 P2	GWB / EX-GWB ACT-1 ACT-1 GWB GWB GWB GWB GWB GWB GWB	B1 B1 B1 B1 B1 B1 B1 B1 B1					NOTE: A - F NOTE: A - F	REFER TO SHEET A901 & A941 REFER TO SHEET A901 & A941	DRAWN BY: CHECKED BY: DRAWING SCALE	Dh Mi As ind
	SITTING - W VEST - E VEST - W CORRIDOR - E CORRIDOR - W ELEVATOR LOBBY - E ELEVATOR LOBBY - W ANTE - E	NOTE: A NOTE: A NOTE: A NOTE: A NOTE: A NOTE: A NOTE: A NOTE: A	NA NA NA NA NA NA NA NA NA	P1 P1 P1 P1 P1 P1 P1 P1 P1 P1	P1 P1 P1 P1 P1 P1 P1 P1 P2	P1 P1 P1 P1 P1 P1 P1 P1 P1 P1	P1 P1 P1 P1 P1 P1 P1 P1 P1 P1	GWB / EX-GWB ACT-1 ACT-1 GWB GWB GWB GWB GWB GWB GWB GWB NOTE 1	B1 B1 B1 B1 B1 B1 B1					NOTE: A - F	REFER TO SHEET A901 & A941 REFER TO SHEET A901 & A941	DRAWN BY: CHECKED BY: DRAWING SCALE	Dh Mi As ind
	SITTING - W VEST - E VEST - W CORRIDOR - E CORRIDOR - W ELEVATOR LOBBY - E ELEVATOR LOBBY - W ANTE - E ANTE - W ELEVATORS - E ELEVATORS - W MAIL	NOTE: A NOTE: A	NA NA NA NA NA NA NA NA NA NA NA NA NA N	P1 P1 P1 P1 P1 P1 P1 P1 NOTE 1 NW	P1 P1 P1 P1 P1 P1 P1 P1 P1 NOTE 1 NOTE 1 NW	P1 P1 P1 P1 P1 P1 P1 P1 NOTE 1 NW	P1 P1 P1 P1 P1 P1 P1 P1 P1 NOTE 1 NW	GWB / EX-GWB ACT-1 ACT-1 GWB GWB GWB GWB GWB GWB GWB NOTE 1 NOTE 1 NW	B1 B1 B1 B1 B1 B1 NOTE 1 NW					NOTE: A - F	REFER TO SHEET A901 & A941 REFER TO SHEET A901 & A941	DRAWN BY: CHECKED BY: DRAWING SCALE	As ind
	SITTING - W VEST - E VEST - W CORRIDOR - E CORRIDOR - W ELEVATOR LOBBY - E ELEVATOR LOBBY - W ANTE - E ANTE - W ELEVATORS - E ELEVATORS - W MAIL PREP	NOTE: A NOTE: A	NA NA NA NA NA NA NA NA NA NA NA NOTE 1 NOTE 1 NA NA NA	P1 P1 P1 P1 P1 P1 P1 P1 NOTE 1 NW NW	P1 NOTE 1 NW NW	P1 P1 P1 P1 P1 P1 P1 P1 NOTE 1 NW NW	P1 P1 P1 P1 P1 P1 P1 P1 P1 NOTE 1 NW NW	GWB / EX-GWB ACT-1 GWB GWB GWB GWB GWB GWB GWB NOTE 1 NOTE 1 NW NW	B1 B1 B1 B1 B1 B1 NOTE 1 NW NW					NOTE: A - F NOTE: A - F	REFER TO SHEET A901 & A941 REFER TO SHEET A901 & A941	DRAWN BY: CHECKED BY: DRAWING SCALE	As indi TITLE
	SITTING - W VEST - E VEST - W CORRIDOR - E CORRIDOR - W ELEVATOR LOBBY - E ELEVATOR LOBBY - W ANTE - E ANTE - W ELEVATORS - E ELEVATORS - W MAIL	NOTE: A NOTE: A	NA NA NA NA NA NA NA NA NA NA NA NA NA N	P1 P1 P1 P1 P1 P1 P1 P1 NOTE 1 NW	P1 P1 P1 P1 P1 P1 P1 P1 P1 NOTE 1 NOTE 1 NW	P1 P1 P1 P1 P1 P1 P1 P1 NOTE 1 NW	P1 P1 P1 P1 P1 P1 P1 P1 P1 NOTE 1 NW	GWB / EX-GWB ACT-1 ACT-1 GWB GWB GWB GWB GWB GWB NOTE 1 NOTE 1 NW NW SWB GWB GWB	B1 B1 B1 B1 B1 B1 NOTE 1 NW					NOTE: A - F NOTE: A - F	REFER TO SHEET A901 & A941 REFER TO SHEET A901 & A941	DRAWN BY: CHECKED BY: DRAWING SCALE SHEET	
	SITTING - W VEST - E VEST - W CORRIDOR - E CORRIDOR - W ELEVATOR LOBBY - E ELEVATOR LOBBY - W ANTE - E ANTE - W ELEVATORS - E ELEVATORS - E ELEVATORS - W MAIL PREP CAFE'	NOTE: A NOTE: A	NA NA NA NA NA NA NA NA NA NA NA NOTE 1 NOTE 1 NA NA NA NA NA	P1 P1 P1 P1 P1 P1 P1 P1 P1 NOTE 1 NW NW P1	P1 P1 P1 P1 P1 P1 P1 P1 P1 NOTE 1 NW NW P1	P1 P1 P1 P1 P1 P1 P1 P1 P1 NOTE 1 NW NW P1	P1 NOTE 1 NW NW P1	GWB / EX-GWB ACT-1 GWB GWB GWB GWB GWB GWB NOTE 1 NOTE 1 NU NW GWB GWB / EX-GWB	B1 B1 B1 B1 B1 B1 NOTE 1 NW B1					NOTE: A - F NOTE: A - F	REFER TO SHEET A901 & A941 REFER TO SHEET A901 & A941	DRAWN BY: CHECKED BY: DRAWING SCALE SHEET	As ind TITLE

A. Product Data: For each type of product indicated. Include manufacturer's written data on physical characteristics, durability, and fade resistance. Include installation

B. Provide Samples: For each of the following products and for each color and texture each Sample with manufacturer's name, material description, color, pattern, and designation

C. Test Results: Provide results of specified alkalinity and adhesion tests, calcium chloride

edges at backing to form secure seams and to prevent pile loss at seams.

3. Vacuum carpet using commercial machine with face-beater element.

					anna anna anna anna anna anna anna ann
	29 BLACK POINT ROAD SCARBOROUGH, MAINE 04074				
	С	CARPET	SYD	SQUARE YARD(S)	207-883-6307 WWW.GAWRONTURGEON.COM
	G	GROUT	Т	TILE	WWWWW.GAWKONTOKGEON.COM
	N/A	NOT APPLICABLE	TBS	TO BE SELECTED	
	Р	PAINT	VCB	VINYL COVE BASE	NN
	PL	PLASTIC LAMINATE	VCT	VINYL COMPOSITION TILE	
	R	RESILENT/ RUBBER/ RUBBER TREAD	CAB	CABINETS	
	SC	SEALED CONCRETE	WC	PAPER	
	SF	SQUARE FEET	TB	TILE BASE	
	SS	SOLID SURFACE/ NATURAL STONE	WD	WOOD	
	ST	STAGE CURTAIN	QT	QUARTZ TILE	$>$ \bigcirc -
		REMARKS & NO	TES		
 9/16" SUPRA FINE GR		REMARKS & NO	IES		
 9/10 SUPRAFINE GR	RID				
 CIRCLE INLAY					
BORDER @ INLAY (TO		ERMINED)			
 RUNNERS IN COORIE		,			
	(STALLATION w/ CABINET INSTALLER & PROVID	E ALL REQUIF	RED SERVICES w/ OWNERS REPRESENTATIVE	
NIC - GC TO COORDI	NATE INS	TALLATION w/ COUTNERTOP INSTALLER & O	WNERS REPR	ESENTATIVE	
EXISTING WOOD DO	OR & FRA	AME FINISH - PREPARE SURFACES & APPLY PE	ER MANUFAC	TURER'S INSTRUCTIONS	
EXISTING GWB CEILI	NG - PRE	PARE SUFFACE FOR SMOOTH LEVEL APPLICA	TION OF PAIN	JT	
1					

EDARO

STANLE

 \sim

 \mathbf{m}

MIDD

3 MM THICKNESS

HM DOORS

HM DOOR FRAMES

OOSE LAYED PROVIDE: CLASS A FIRE TREATMENT, MATCHING 12" CORNERS