

DISPLAY THIS CARD ON PRINCIPAL FRONTAGE OF WORK CITY OF PORTLAND

Please Read
Application And
Notes, If Any,
Attached

BUILDING DEPARTMENT

PERMIT

PERMIT ISSUED

This is to certify that Middle Street Office Tower A/T
has permission to Interior alterations to create a video teleconference room
AT 100 Middle St CBI # 29 E006001 NOV - 5

provided that the person or persons, firm or corporation accepting this permit shall comply with all of the provisions of the Statutes of Maine and of the Ordinances of the City of Portland regulating the construction, maintenance and use of buildings and structures, and of the application on file in this department.

City of Portland

Apply to Public Works for street line and grade if nature of work requires such information.

Notification of inspection must be given and written permission procured before this building or part thereof is lathed or otherwise worked-in. 24 HOUR NOTICE IS REQUIRED.

A certificate of occupancy must be procured by owner before this building or part thereof is occupied.

OTHER REQUIRED APPROVALS

Fire Dept. CAPT. J. [Signature]
Health Dept. _____
Appeal Board _____
Other _____
Department Name _____

[Signature]
Director, Building & Inspection Services

PENALTY FOR REMOVING THIS CARD

City of Portland, Maine - Building or Use Permit Application

389 Congress Street, 04101 Tel: (207) 874-8703, Fax: (207) 874-8716

Permit No: 10-1301	Issue Date:	CBI: 029 E006001
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Location of Construction: 100 Middle St - <i>floor #2</i>	Owner Name: Middle Street Office Tower A	Owner Address: 100 Middle St	Phone:
Business Name: Bank of America	Contractor Name: TBA	Contractor Address: Portland	Phone:
Lesser/Buyer's Name:	Phone:	Permit Type: Alterations - Commercial	Zone: <i>B-3</i>

Past Use: Commercial / Bank of America	Proposed Use: Commercial / Bank of America: Interior alterations to create a video-teleconference room.	Permit Fee: \$870.00	Cost of Work: \$85,000.00	CEO District: 1
Proposed Project Description: Interior alterations to create a video-teleconference room.		FIRE DEPT: <input checked="" type="checkbox"/> Approved <input type="checkbox"/> Denied <i>*See Conditions</i>	INSPECTION: Use Group: <i>B</i> Type: <i>2</i> <i>TBC 2003</i>	
		Signature: <i>(KL)</i>	Signature: <i>(Signature)</i>	
PEDESTRIAN ACTIVITIES DISTRICT (P.A.D.)				
Action: <input type="checkbox"/> Approved <input type="checkbox"/> Approved w/Conditions <input type="checkbox"/> Denied				
Signature: _____ Date: _____				

Permit Taken By: GG	Date Applied For: 10/14/2010	Zoning Approval		
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<p>1. This permit application does not preclude the Applicant(s) from meeting applicable State and Federal Rules.</p> <p>2. Building permits do not include plumbing, septic or electrical work.</p> <p>3. Building permits are void if work is not started within six (6) months of the date of issuance. False information may invalidate a building permit and stop all work..</p>	<p>Special Zone or Reviews</p> <input type="checkbox"/> Shoreland <input type="checkbox"/> Wetland <input type="checkbox"/> Flood Zone <input type="checkbox"/> Subdivision <input type="checkbox"/> Site Plan <input type="checkbox"/> Major <input type="checkbox"/> Minor <input type="checkbox"/> MME	<p>Zoning Appeal</p> <input type="checkbox"/> Variance <input type="checkbox"/> Miscellaneous <input type="checkbox"/> Conditional Use <input type="checkbox"/> Interpretation <input type="checkbox"/> Approved <input type="checkbox"/> Denied	<p>Historic Preservation</p> <input checked="" type="checkbox"/> Not in District or Landmark <input type="checkbox"/> Does Not Require Review <input type="checkbox"/> Requires Review <input type="checkbox"/> Approved <input type="checkbox"/> Approved w/Conditions <input type="checkbox"/> Denied
	<p>Date: <i>(Signature)</i> <i>10/19/10</i></p>	Date: _____	Date: <i>(Signature)</i>

PERMIT ISSUED

NOV - 5

City of Portland

CERTIFICATION

I hereby certify that I am the owner of record of the named property, or that the proposed work is authorized by the owner of record and that I have been authorized by the owner to make this application as his authorized agent and I agree to conform to all applicable laws of this jurisdiction. In addition, if a permit for work described in the application is issued, I certify that the code official's authorized representative shall have the authority to enter all areas covered by such permit at any reasonable hour to enforce the provision of the code(s) applicable to such permit.

SIGNATURE OF APPLICANT

ADDRESS

DATE

PHONE

City of Portland, Maine - Building or Use Permit

389 Congress Street, 04101 Tel: (207) 874-8703, Fax: (207) 874-8716

Permit No: 10-1301	Date Applied For: 10/14/2010	CBL: 029 E006001
-----------------------	---------------------------------	---------------------

Location of Construction: 100 Middle St	Owner Name: Middle Street Office Tower A	Owner Address: 100 Middle St	Phone:
Business Name: Bank of America	Contractor Name: TBA	Contractor Address: Portland	Phone:
Lessee/Buyer's Name	Phone:	Permit Type: Alterations - Commercial	

Proposed Use: Commercial / Bank of America: Interior alterations to create a video-teleconference room.	Proposed Project Description: Interior alterations to create a video-teleconference room.
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Dept: Zoning Status: Approved Reviewer: Marge Schmuckal Approval Date: 10/18/2010
 Note: Ok to Issue: ✓

Dept: Building Status: Approved with Conditions Reviewer: Tammy Munson Approval Date: 11/05/2010
 Note: Ok to Issue: ✓

- 1) All penetrations through rated assemblies must be protected by an approved firestop system installed in accordance with ASTM 814 or UL 1479, per IBC 2003 Section 712.
- 2) Separate permits are required for any electrical, plumbing, sprinkler, fire alarm HVAC systems, heating appliances, including pellet/wood stoves, commercial hood exhaust systems and fuel tanks. Separate plans may need to be submitted for approval as a part of this process.

Dept: Fire Status: Approved with Conditions Reviewer: Capt Keith Gautreau Approval Date: 10/26/2010
 Note: Ok to Issue: ✓

- 1) Fire Alarm system shall be maintained.
If system is to be off line over 4 hours a fire watch shall be in place.
Dispatch notification required 874-8576.
- 2) Sprinkler protection shall be maintained.
Where the system is to be shut down for maintenance or repair, the system shall be checked at the end of each day to insure the system has been placed back in service.
- 3) Emergency lights are required to be tested at the electrical panel on the same circuit as the lighting for the area they serve
- 4) Fire extinguishers required. Installation per NFPA 10
- 5) Emergency lights and exit signs are required. Emergency lights and exit signs are required to be labeled in relation to the panel and circuit.
- 6) The Fire alarm and Sprinkler systems shall be reviewed by a licensed contractor(s) for code compliance.
Compliance letters are required.
- 7) All construction shall comply with City Code Chapter 10.
- 8) This permit is being approved on the basis of the plans submitted. Any deviation from the plans would require amendments and approval.

PERMIT ISSUED

NOV - 5

City of Portland

BUILDING PERMIT INSPECTION PROCEDURES

**Please call 874-8703 or 874-8693 (ONLY)
or email: buildinginspections@portlandmaine.gov**

With the issuance of this permit, the owner, builder or their designee is required to provide adequate notice to the City of Portland Inspection Services for the following inspections. Appointments must be requested 48 to 72 hours in advance of the required inspection. The inspection date will need to be confirmed by this office.

- **Please read the conditions of approval that is attached to this permit!! Contact this office if you have any questions.**
- **Permits expire in 6 months, if the project is not started or ceases for 6 months.**
- **If the inspection requirements are not followed as stated below additional fees may be incurred due to the issuance of a "Stop Work Order" and subsequent release to continue with construction.**

 X **Framing/Rough Plumbing/Electrical: Prior to Any Insulating or drywalling**

 X **Final inspection required at completion of work.**

The project cannot move to the next phase prior to the required inspection and approval to continue, REGARDLESS OF THE NOTICE OR CIRCUMSTANCES.

IF THE PERMIT REQUIRES A CERTIFICATE OF OCCUPANCY, IT MUST BE PAID FOR AND ISSUED TO THE OWNER OR DESIGNEE BEFORE THE SPACE MAY BE OCCUPIED.

PERMIT ISSUED

NOV - 5

City of Portland



CITY OF PORTLAND, MAINE

Department of Building Inspections

Original Receipt

Oct. 14 20 10

Received from RT Development Building Products Co.

Location of Work 100 Middle St. Portland

Cost of Construction \$ _____ Building Fee: _____

Permit Fee \$ _____ Site Fee: _____

Certificate of Occupancy Fee: _____

Total: 1359

Building (1L) Plumbing (15) _____ Electrical (12) _____ Site Plan (30) _____

Other _____

CEL: 0298006

Check # 1359 Total Collected 1359

No work is to be started until permit issued.
Please keep original receipt for your records.

Taken by: [Signature]

WHITE - Applicant's Copy
YELLOW - Office Copy
PINK - Permit Copy



CITY OF PORTLAND, MAINE
Department of Building Inspections

Original Receipt

Oct. 14 2010

Received from RT Doolen, a Doolen Brothers Co.
Location of Work 100 Middle St. Floor 02

Cost of Construction \$ _____ Building Fee: _____

Permit Fee \$ _____ Site Fee: _____

Certificate of Occupancy Fee: _____

Total: \$70.00

Building (1L) Plumbing (15) _____ Electrical (12) _____ Site Plan (U2) _____

Other _____

CBL: 029 E 006

Check #: 1357 Total Collected: \$70.00

**No work is to be started until permit issued.
Please keep original receipt for your records.**

Taken by: J. Gault typed over

WHITE - Applicant's Copy
YELLOW - Office Copy
PINK - Permit Copy

10/14/10 James
815 688 8018



General Building Permit Application

If you or the property owner owns real estate or personal property taxes or user charges on any property within the City, payment arrangements must be made before permits of any kind are accepted.

Location/Address of Construction: <u>100 Middle Street - Floor 02</u>		
Total Square Footage of Proposed Structure/Area <u>381 SF</u>		Square Footage of Lot
Tax Assessor's Chart, Block & Lot Chart# <u>089</u> Block# <u>2</u> Lot# <u>006</u>	Applicant * <u>must</u> be owner, Lessee or Buyer* Name <u>JAMES MATTHEWS FOR BANK OF AMERICA</u> Address <u>13400 RIVERSIDE DR #202</u> City, State & Zip <u>SHERMAN OAKS CA 91423</u>	Telephone: <u>818 786 8960</u>
Lessee/DBA (If Applicable) <u>BANK OF AMERICA</u>	Owner (if different from Applicant) Name <u>100 MIDDLE ST</u> Address <u>PORTLAND ME 04101</u> City, State & Zip <u>300 432 1000</u>	Cost Of Work: \$ <u>85000</u> C of O Fee: \$ _____ Total Fee: \$ _____
Current legal use (i.e. single family) <u>Business</u> If vacant, what was the previous use? <u>N/A</u> Proposed Specific use: <u>EXIST - BUSINESS</u> Is property part of a subdivision? <u>N/A</u> If yes, please name _____ Project description: <u>Interior alterations to create a video-conferencing room.</u>		
Contractor's name: <u>'TO BE DETERMINED'</u>		
Address: _____		
City, State & Zip _____		Telephone: _____
Who should we contact when the permit is ready: _____		Telephone: _____
Mailing address: _____		

Received by mail 10/14/10 GO

Please submit all of the information outlined on the applicable Checklist. Failure to do so will result in the automatic denial of your permit.

In order to be sure the City fully understands the full scope of the project, the Planning and Development Department may request additional information prior to the issuance of a permit. For further information or to download copies of this form and other applications visit the Inspections Division on-line at www.portlandmaine.gov, or stop by the Inspections Division office, room 315 City Hall or call 874-8703.

I hereby certify that I am the Owner of record of the named property, or that the owner of record authorizes the proposed work and that I have been authorized by the owner to make this application as his/her authorized agent. I agree to conform to all applicable laws of this jurisdiction. In addition, if a permit for work described in this application is issued, I certify that the Code Official's authorized representative shall have the authority to enter all areas covered by this permit at any reasonable hour to enforce the provisions of the codes applicable to this permit.

Signature: [Signature] Date: 10-8-10

This is not a permit; you may not commence ANY work until the permit is issued



Certificate of Design Application

From Designer:

Nelco Architecture, Inc

Date:

Sept. 23, 2010

Job Name:

Bank of America - Telepresence Room

Address of Construction:

100 Middle Street - Floor 02

2003 International Building Code

Construction project was designed to the building code criteria listed below:

Building Code & Year 2003 IBC Use Group Classification (s) B

Type of Construction EXIST TO REMAIN

Will the Structure have a Fire suppression system in Accordance with Section 903.3.1 of the 2003 IRC YES (EXIST FIREPLINK)

Is the Structure mixed use? NO If yes, separated or non separated or non separated (section 302.3)

Supervisory alarm System? N/A Geotechnical/Soils report required? (See Section 1802.2) N/A

Structural Design Calculations

N/A Submitted for all structural members (106.1 - 106.11)

Design Loads on Construction Documents (1603)

Uniformly distributed floor live loads (7605.11, 1807)

Floor Area Use	Loads Shown

Wind loads (1603.1.4, 1609)

- _____ Design option utilized (1609.1.1, 1609.6)
- _____ Basic wind speed (1809.3)
- _____ Building category and wind importance Factor, I_w (table 1609.5, 1609.5)
- _____ Wind exposure category (1609.4)
- _____ Internal pressure coefficient (ASCF 7)
- _____ Component and cladding pressures (1609.1.1, 1609.6.2.2)
- _____ Main force wind pressure (7605.1.1, 1609.6.2.1)

Earth design data (1603.1.5, 1614-1623)

- _____ Design option utilized (1614.1)
- _____ Seismic use group ("Category")
- _____ Spectral response coefficients, S_D & S_L (1615.1)
- _____ Site class (1615.1.5)

- _____ Live load reduction
- _____ Roof live loads (1603.1.2, 1607.11)
- _____ Roof snow loads (1603.7.3, 1608)
- _____ Ground snow load, P_g (1609.2)
- _____ If $P_g > 10$ psf, flat-roof snow load P_f
- _____ If $P_g > 10$ psf, snow exposure factor, C_e
- _____ If $P_g > 10$ psf, snow load importance factor, I_s
- _____ Roof thermal factor, C_t (1608.4)
- _____ Sloped roof snowload, P_s (1608.4)
- _____ Seismic design category (1616.3)
- _____ Basic seismic force resisting system (1617.6.2)
- _____ Response modification coefficient, R and deflection amplification factor, C_d (1617.6.2)
- _____ Analysis procedure (1616.6, 1617.5)
- _____ Design base shear (1617.4, 1617.5.1)

Flood loads (1803.1.6, 1612)

- _____ Flood Hazard area (1612.3)
- _____ Elevation of structure

Other loads

- _____ Concentrated loads (1607.4)
- _____ Partition loads (1607.5)
- _____ Misc. loads (Table 1607.8, 1607.6.1, 1607.7, 1607.12, 1607.13, 1610, 1611, 2404)



Commercial Interior & Change of Use Permit Application Checklist

All of the following information is required and must be submitted. Checking off each item as you prepare your application package will ensure your package is complete and will help to expedite the permitting process.

One (1) complete set of construction drawings must include:

Note: Construction documents for costs in excess of \$50,000.00 must be prepared by a Design Professional and bear their seal.

- Cross sections w/framing details
- Detail of any new walls or permanent partitions
- Floor plans and elevations
- Window and door schedules
- Complete electrical and plumbing layout.
- Mechanical drawings for any specialized equipment such as furnaces, chimneys, gas equipment, HVAC equipment or other types of work that may require special review
- Insulation R-factors of walls, ceilings, floors & U-factors of windows as per the IECC 2003
- Proof of ownership is required if it is inconsistent with the assessors records.
- Reduced plans or electronic files in PDF format are required if originals are larger than 11" x 17".
- Per State Fire Marshall, all new bathrooms must be ADA compliant.

Separate permits are required for internal and external plumbing, HVAC & electrical installations.

For additions less than 500 sq. ft. or that does not affect parking or traffic, a site plan exemption should be filed including:

- The shape and dimension of the lot, footprint of the existing and proposed structure and the distance from the actual property lines.
- Location and dimensions of parking areas and driveways, street spaces and building frontage.
- Dimensional floor plan of existing space and dimensional floor plan of proposed space.

A Minor Site Plan Review is required for any change of use between 5,000 and 10,000 sq. ft. (cumulatively within a 3-year period)

Fire Department requirements.

The following shall be submitted on a separate sheet:

- Name, address and phone number of applicant and the project architect.
- Proposed use of structure (NFPA and IBC classification)
- Square footage of proposed structure (total and per story)
- Existing and proposed fire protection of structure.
- Separate plans shall be submitted for
 - a) Suppression system
 - b) Detection System (separate permit is required)
- A separate Life Safety Plan must include:
 - a) Fire resistance ratings of all means of egress
 - b) Travel distance from most remote point to exit discharge
 - c) Location of any required fire extinguishers
 - d) Location of emergency lighting
 - e) Location of exit signs
 - f) NFPA 101 code summary
- Elevator shall be sized to fit an 80" x 24" stretcher.

For questions on Fire Department requirements call the Fire Prevention Officer at (207) 874-8405.

Please submit all of the information outlined in this application checklist. If the application is incomplete, the application may be refused.

In order to be sure the City fully understands the full scope of the project, the Planning and Development Department may request additional information prior to the issuance of a permit. For further information or to download copies of this form and other applications visit the Inspections Division on-line at www.portlandmaine.gov, or stop by the Inspections Division office, room 315 City Hall or call 874-8703.

Permit Fee: \$30.00 for the first \$1000.00 construction cost, \$10.00 per additional \$1000.00 cost

This is not a Permit; you may not commence any work until the Permit is issued.




Accessibility Building Code Certificate

Designer: Nelco Architecture, Inc

Address of Project: 100 Middle Street - Floor 02

Nature of Project: Interior alterations to create
a video-teleconference room.

The technical submissions covering the proposed construction work as described above have been designed in compliance with applicable referenced standards found in the Maine Human Rights Law and Federal Americans with Disability Act. Residential Buildings with 4 units or more must conform to the Federal Fair Housing Accessibility Standards. Please provide proof of compliance if applicable.

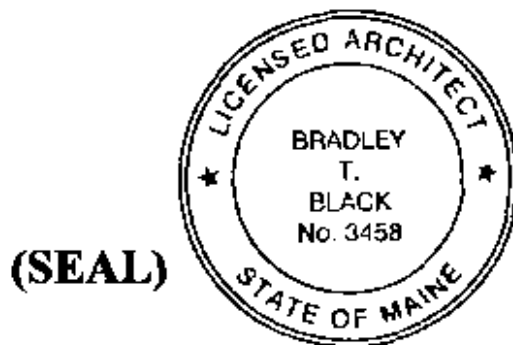

Signature: Bradley T. Black

Title: Managing Principal

Firm: Nelco Architecture, Inc.

Address: 1349 W. Peachtree St NE Suite 1300
Atlanta, GA 30309

Phone: 404.873.3697

For more information or to download this form and other permit applications visit the Inspections Division on our website at www.portlandmaine.gov



Certificate of Design


Date: 9-23-2010

From: Nelco Architecture, Inc.

These plans and / or specifications covering construction work on:

Bank of America - Telepresence Room
100 Middle Street - Floor 02

Have been designed and drawn up by the undersigned, a Maine registered Architect / Engineer according to the **2003 International Building Code** and local amendments.

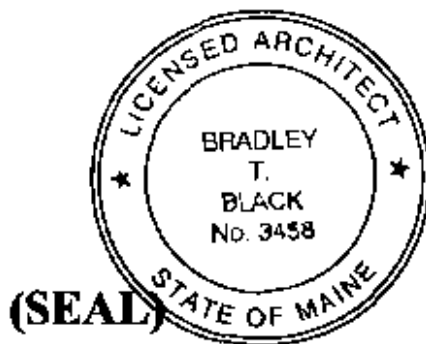

Signature: Bradley T. Black

Title: Managing Principal

Firm: Nelco Architecture, Inc.

Address: 1349 W. Peachtree St NE, Suite 1300
Atlanta, GA 30309

Phone: 404-873-3697

For more information or to download this form and other permit applications visit the Inspections Division on our website at www.portlandmaine.gov



CITY OF PORTLAND, MAINE

Department of Building Inspections

Original Receipt

Oct. 14 2010

Received from RT Dorley & Balfour Beatty Co

Location of Work 100 Middle St. floor 02

Cost of Construction \$ _____ Building Fee: _____

Permit Fee \$ _____ Site Fee: _____

Certificate of Occupancy Fee: _____

Total: 870.00

Building (IL) Plumbing (IS) _____ Electrical (I2) _____ Site Plan (U2) _____

Other _____

CBL: 029 E 006

Check #: 1357 Total Collected \$ 870.00

**No work is to be started until permit issued.
Please keep original receipt for your records.**


Taken by: [Signature] [Signature] Handed over receipt

WHITE - Applicant's Copy
YELLOW - Office Copy
PINK - Permit Copy

12/14/10 815 688 2018
James

NELSON

Nelson Architecture, Inc.
 1549 West Sanderson St., NE - Suite 1310
 Atlanta, GA 30309
 Phone: (404) 525-1100
 Fax: (404) 525-1100

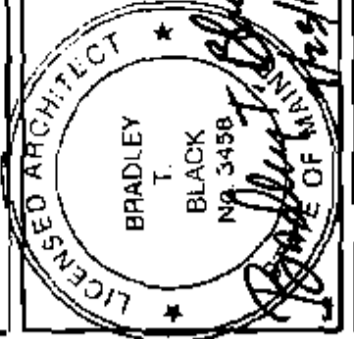

NELCO ARCHITECTURE, INC.
 12400 COURT RD.
 SUITE 513
 DALLAS, TX 75257
 PHONE: (972) 644-8830

SYSKA HENNESSY GROUP, INC.
 525 N. TRYON STREET
 CHARLOTTE, NC 28255
 PHONE: (704) 368-7911

Bank of America
 Construction

DATE	DESCRIPTION	BY

TELEPHONE ROOM - MEI-504-02-8045
 Floor 02
 100 Main St.
 Portland, ME 04101
 Project Title & Address

LIFE SAFETY PLAN AND
 BUILDING CODE DATA

Project No. 19-0004-00
 Drawing No. 14
 Scale No. 01
 Revision No. 01

AN-3

BUILDING CODE DATA



Name of Project: TELEPHONE ROOM RENOVATION
 Location: 100 MAIN ST., PORTLAND, ME 04101
 City/State: PORTLAND, ME 04101
 Address: 100 MAIN ST.
 Area of Building: 200 SQ. FT.
 Owner: SYSKA HENNESSY GROUP, INC.
 Architect: NELSON ARCHITECTURE, INC.
 Date of Construction: 1998
 Code Book: 2000 IBC

APPLICABLE CODES:

International Building Code (IBC) 2000
 Maine Building Code (MBC) 2000
 ASHRAE 90.1-2001

BUILDING INFORMATION:

Construction Type: Type III
 Occupancy: Office
 Height: 3 Stories
 Area: 2000 SQ. FT.

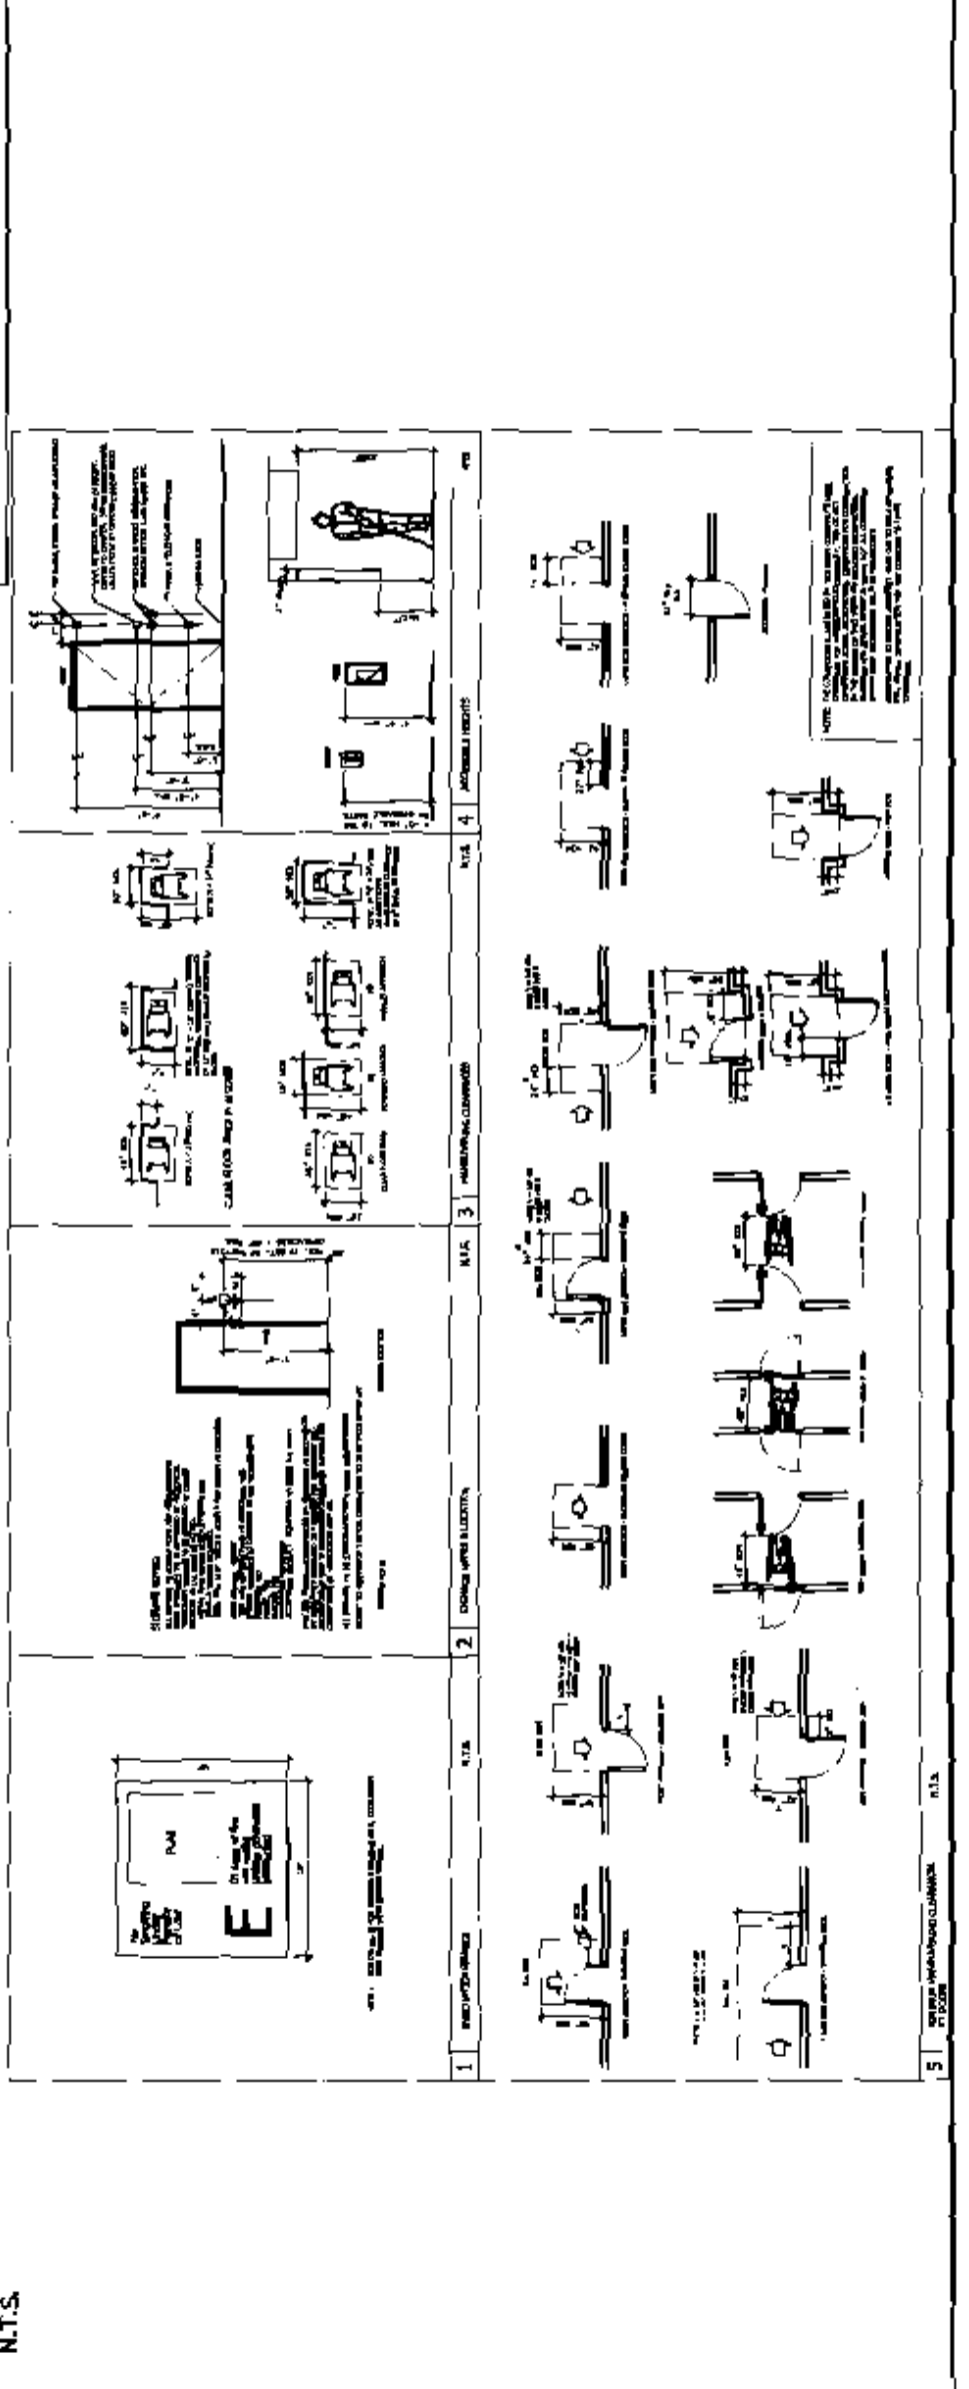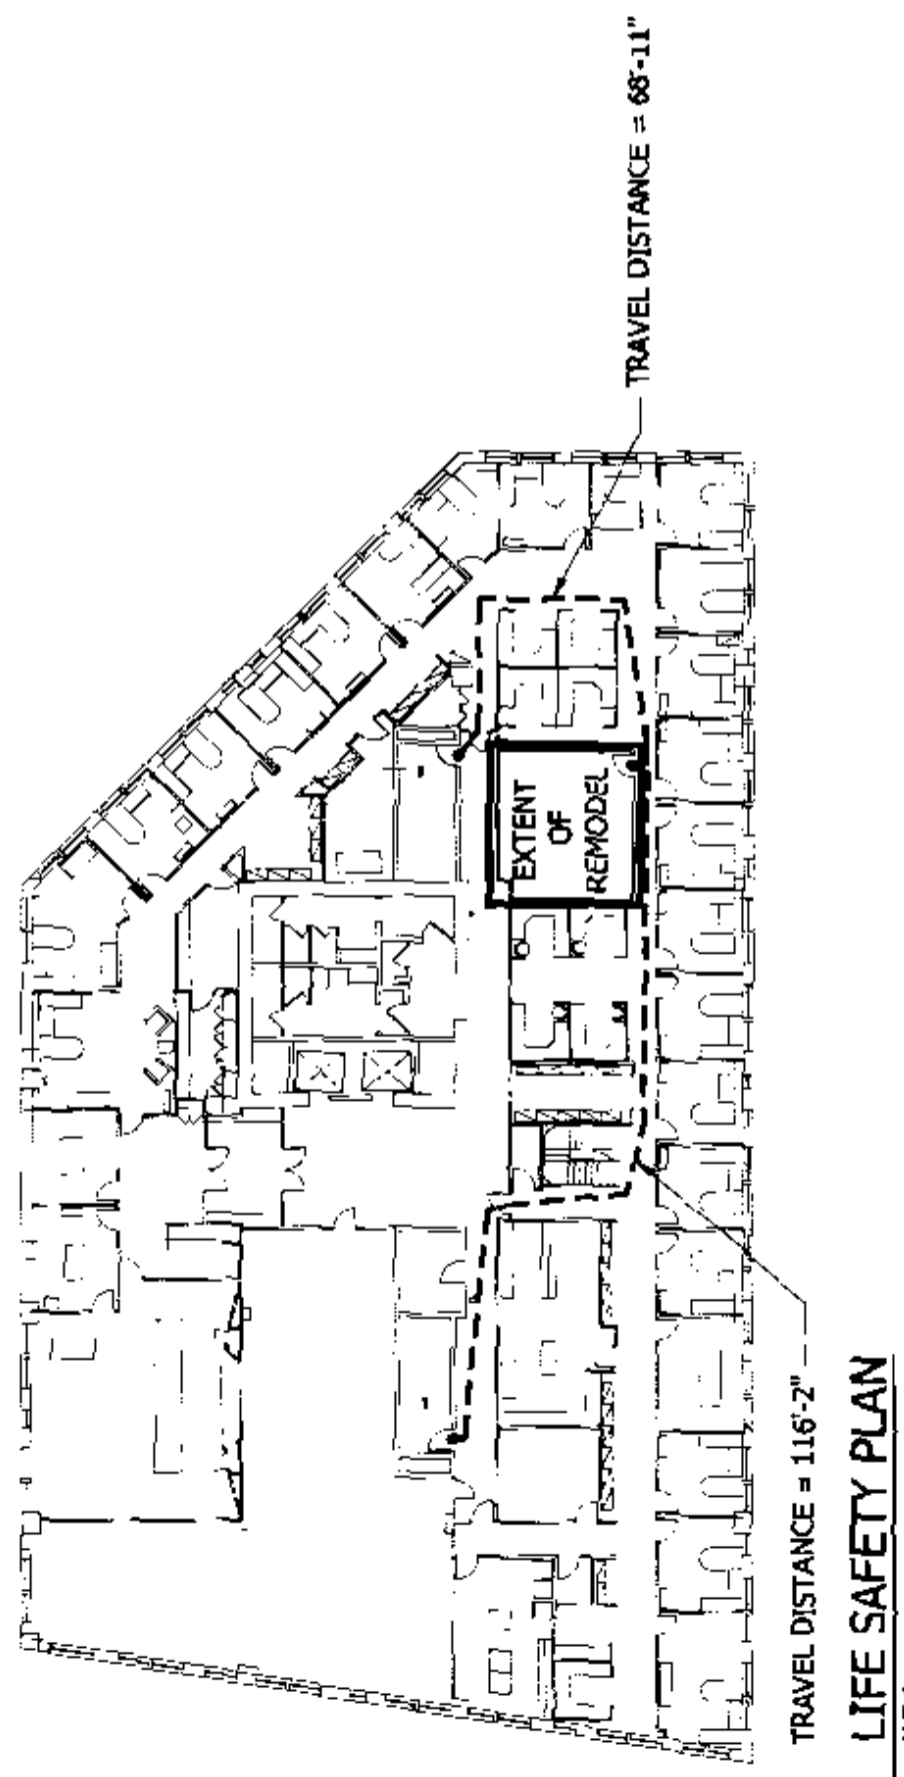

TRAVEL DISTANCE = 116'-2"
LIFE SAFETY PLAN
 N.T.S.



5
 WAITING CLERK
 N.T.S.

NEILSON
 Neilsen Architecture, Inc.
 a Reinhold affiliate
 1399 West Peachtree St. NE - Suite 1310D
 Atlanta, Ga 30309
 Phone: (404) 525-1100
 Fax: (404) 525-1110

LICENSED ARCHITECT
 BRADLEY T. BLACK
 No. 3458
 State of North Carolina
 12/23/10

NELCO ARCHITECTURE, INC.
 37400 COTT RD.
 SUITE 510
 DALLAS, TX 75257
 PHONE: (972) 644-8840
 Consultant


SYSKA HENNESSY GROUP, INC.
 525 N. TRYON STREET
 CHARLOTTE, NC 28203
 PHONE: (480) 388-7411
 SYSKA HENNESSY GROUP
 Consultant

Bank of America
 Banker Security
 Construction

DATE	BY	REVISION

FLOOR 02
 TELEPRESENCE ROOM - INET-504-02-EDAS
 100 MISCELLANEOUS
 PROJECT TITLE & ADDRESS

DEMOLITION PLAN
 A0-1
 Scale: 1/2" = 1'-0"


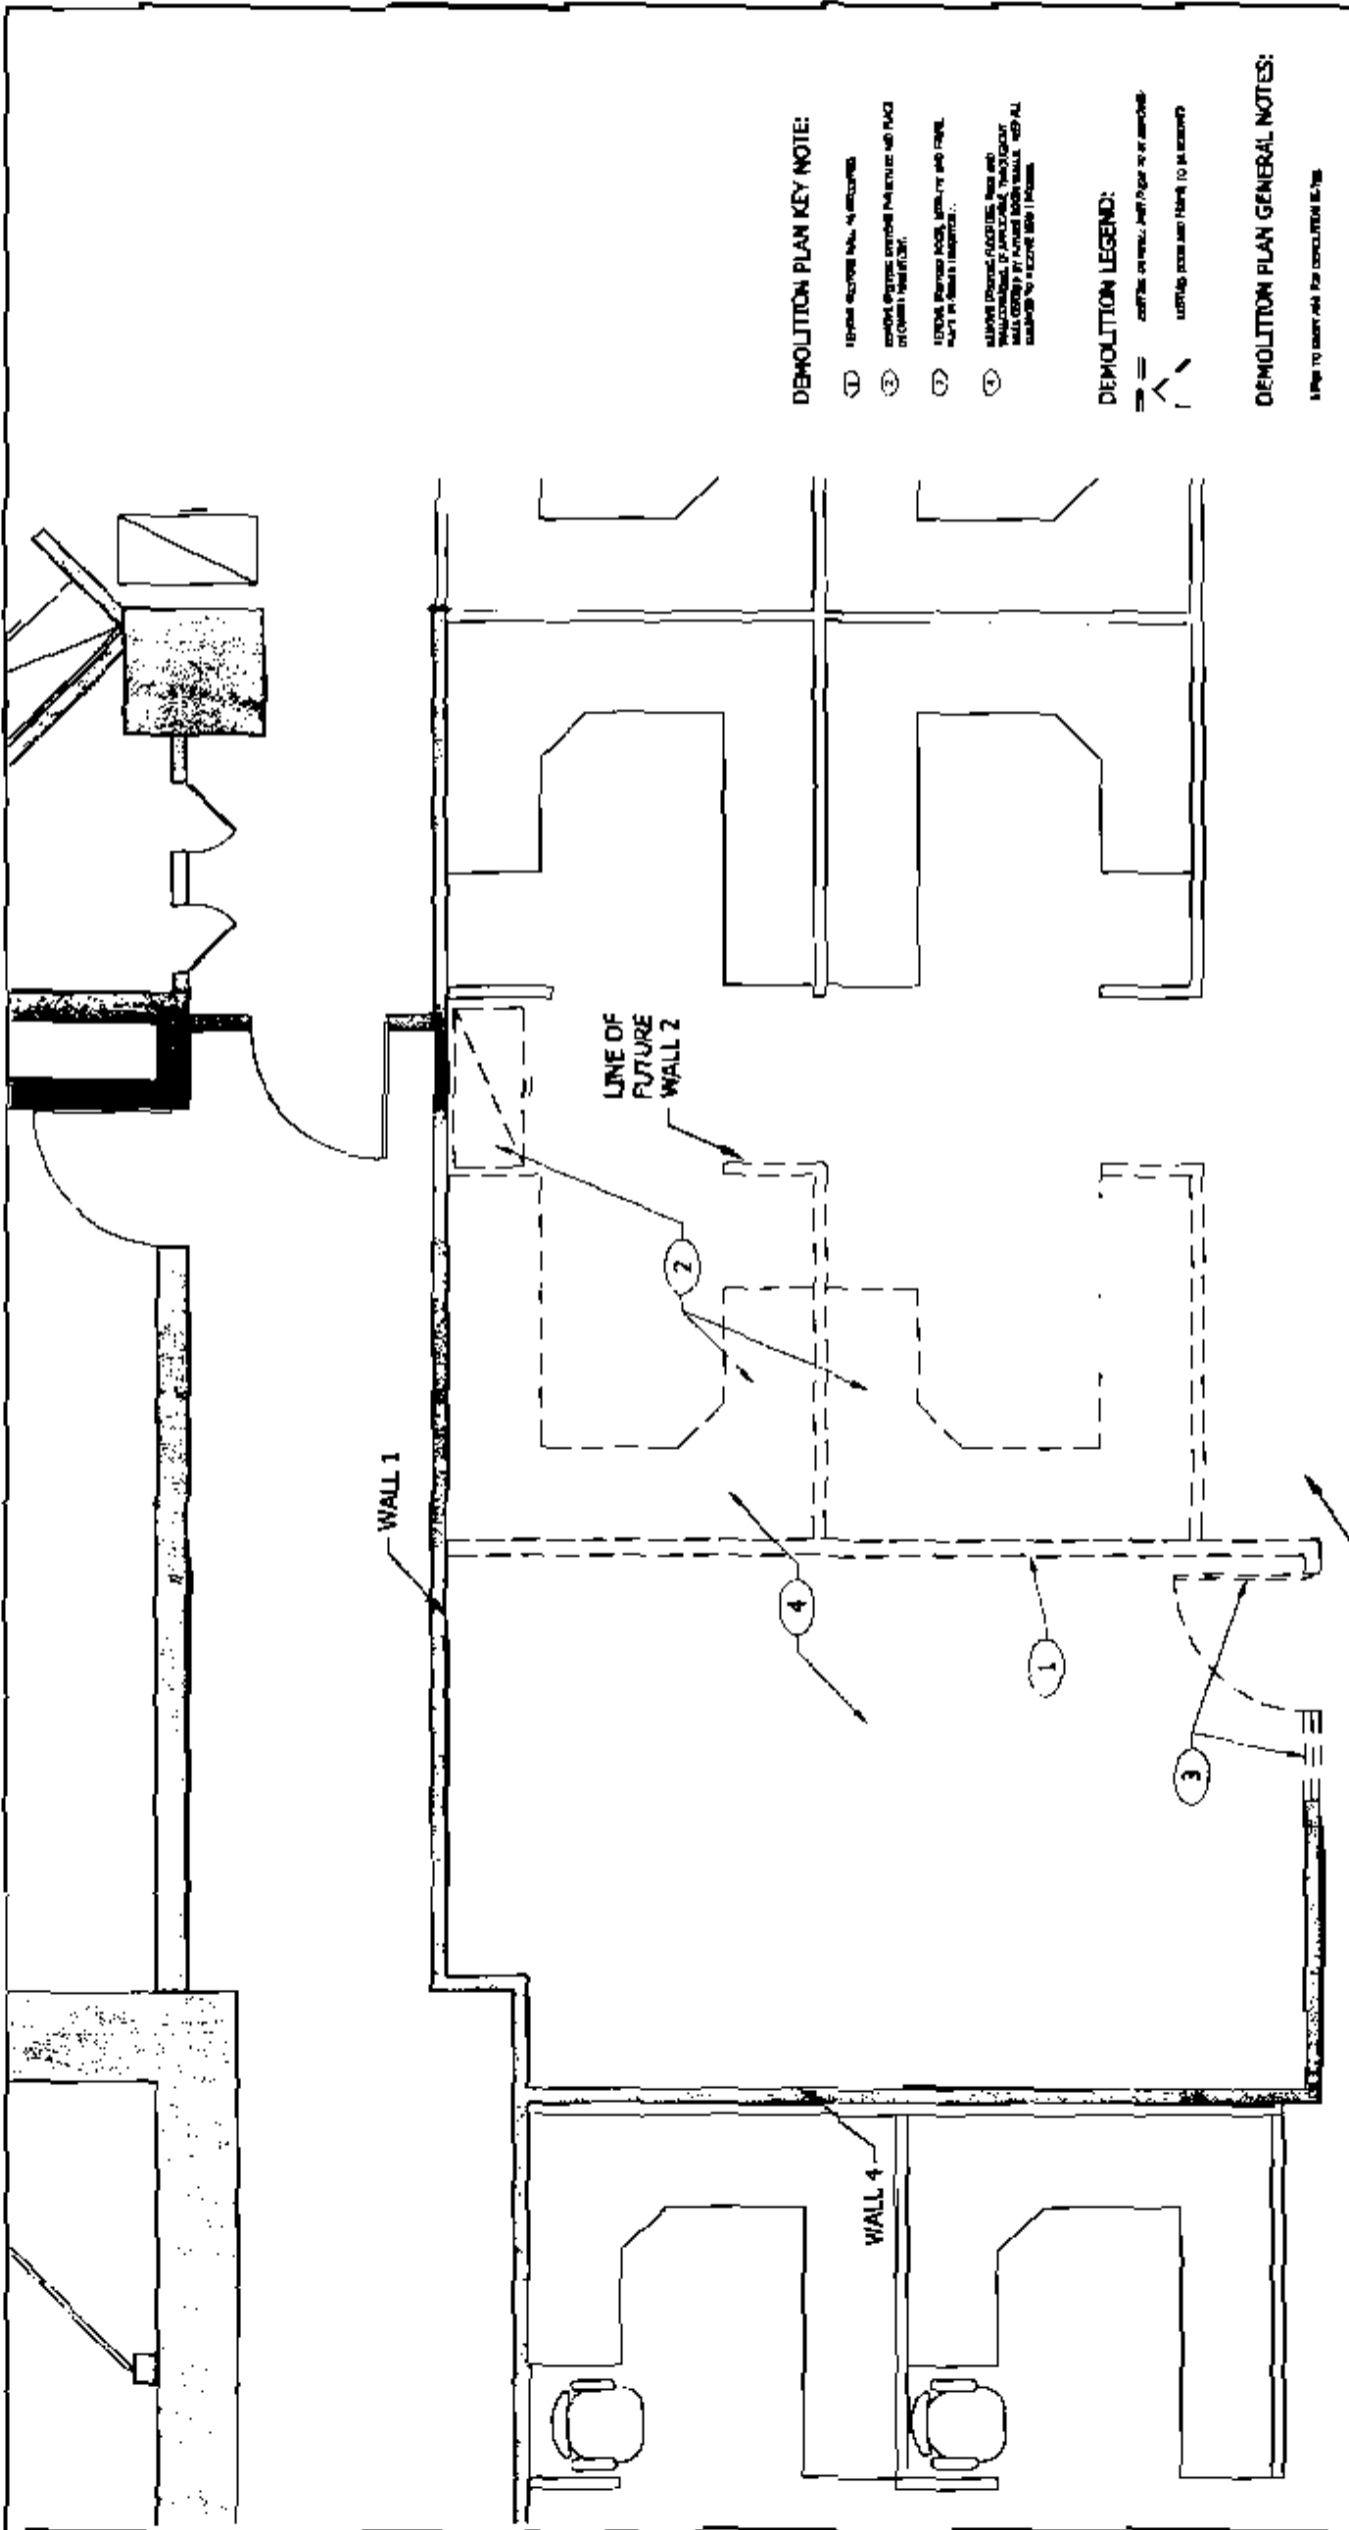


- DEMOLITION PLAN KEY NOTE:**
1. REMOVE EXISTING WALL AS SHOWN
 2. REMOVE EXISTING EXTERIOR PARTITION AND FACE OF CORNER WALL (R/W)
 3. EXISTING EXTERIOR WALL, INTERIOR AND FACE, REMOVE IN PLACE (R/W)
 4. REMOVE EXISTING EXTERIOR WALL AND INTERIOR WALL (R/W) AT FUTURE WALL 2 AND 3

- DEMOLITION LEGEND:**
- EXISTING WALL
 - - - - - LINE OF FUTURE WALL
 - EXISTING WALL TO REMAIN
 - EXISTING WALL TO REMAIN (R/W)

DEMOLITION PLAN GENERAL NOTES:

1. SEE TO BE MAINTAINED FOR DEMOLITION BY THE

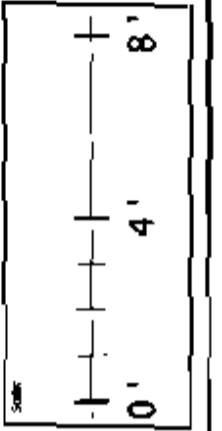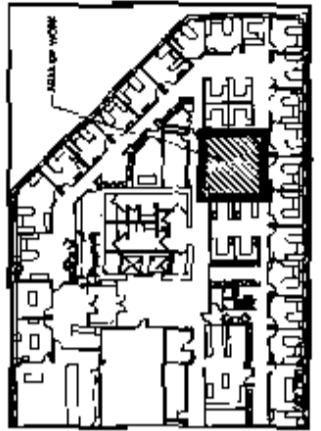


DEMOLITION PLAN
 1/2" = 1'-0"

1
 A0-1

NELSON

Nelson Architecture, Inc.
a licensed affiliate
1340 West Apalachee St. NE - Suite 1300
Atlanta, GA 30328
Phone: (404) 525-1800
Fax: (404) 525-1810

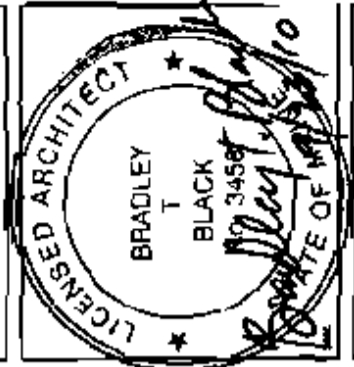

NELCO ARCHITECTURE, INC.
12400 COIT RD.
SUITE 510
DALLAS, TX 75257
PHONE: (972) 644-8838
CONTRACT NO.

SYSKA HENNESSY GROUP, INC.
523 N. TRYON STREET
CHARLOTTE, NC 28255
PHONE: (980) 388-3911
SYSKA HENNESSY
ARCHITECTS

Bank of America
Bank of America
Construction

DATE FOR PERMITTING	DATE FOR CONSTRUCTION	DATE FOR OCCUPANCY

TELEPRESENCE ROOM - ME1-504-02-EDAS
Floor 02
100 Middle St.
Portland, ME 04101
Project Title & Address:




REFLECTED CEILING
DEMOLITION PLAN
Sheet Title: 09.0023.10
Project No.: A0-2
Scale: 1/2" = 1'-0"
Date: 09.0023.10
Checked By: [Signature]
Drawn By: [Signature]

REFLECTED CEILING DEMO PLAN KEY NOTES:

- 1. EXISTING CEILING TO BE DEMOLISHED. SEE KEY PLAN FOR LOCATION OF WALLS AND CEILING. ALL CEILING TO BE DEMOLISHED TO EXPOSE STRUCTURE. SEE KEY PLAN FOR LOCATION OF WALLS AND CEILING.
 - 2. EXISTING CEILING TO BE DEMOLISHED. SEE KEY PLAN FOR LOCATION OF WALLS AND CEILING. ALL CEILING TO BE DEMOLISHED TO EXPOSE STRUCTURE. SEE KEY PLAN FOR LOCATION OF WALLS AND CEILING.
- REFLECTED CEILING LEGEND**
- 1. EXISTING CEILING TO BE DEMOLISHED
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 - 99. EXISTING CEILING TO BE DEMOLISHED
 - 100. EXISTING CEILING TO BE DEMOLISHED

REFLECTED CEILING DEMO NOTES:

1. SEE KEY PLAN FOR LOCATION OF WALLS AND CEILING.

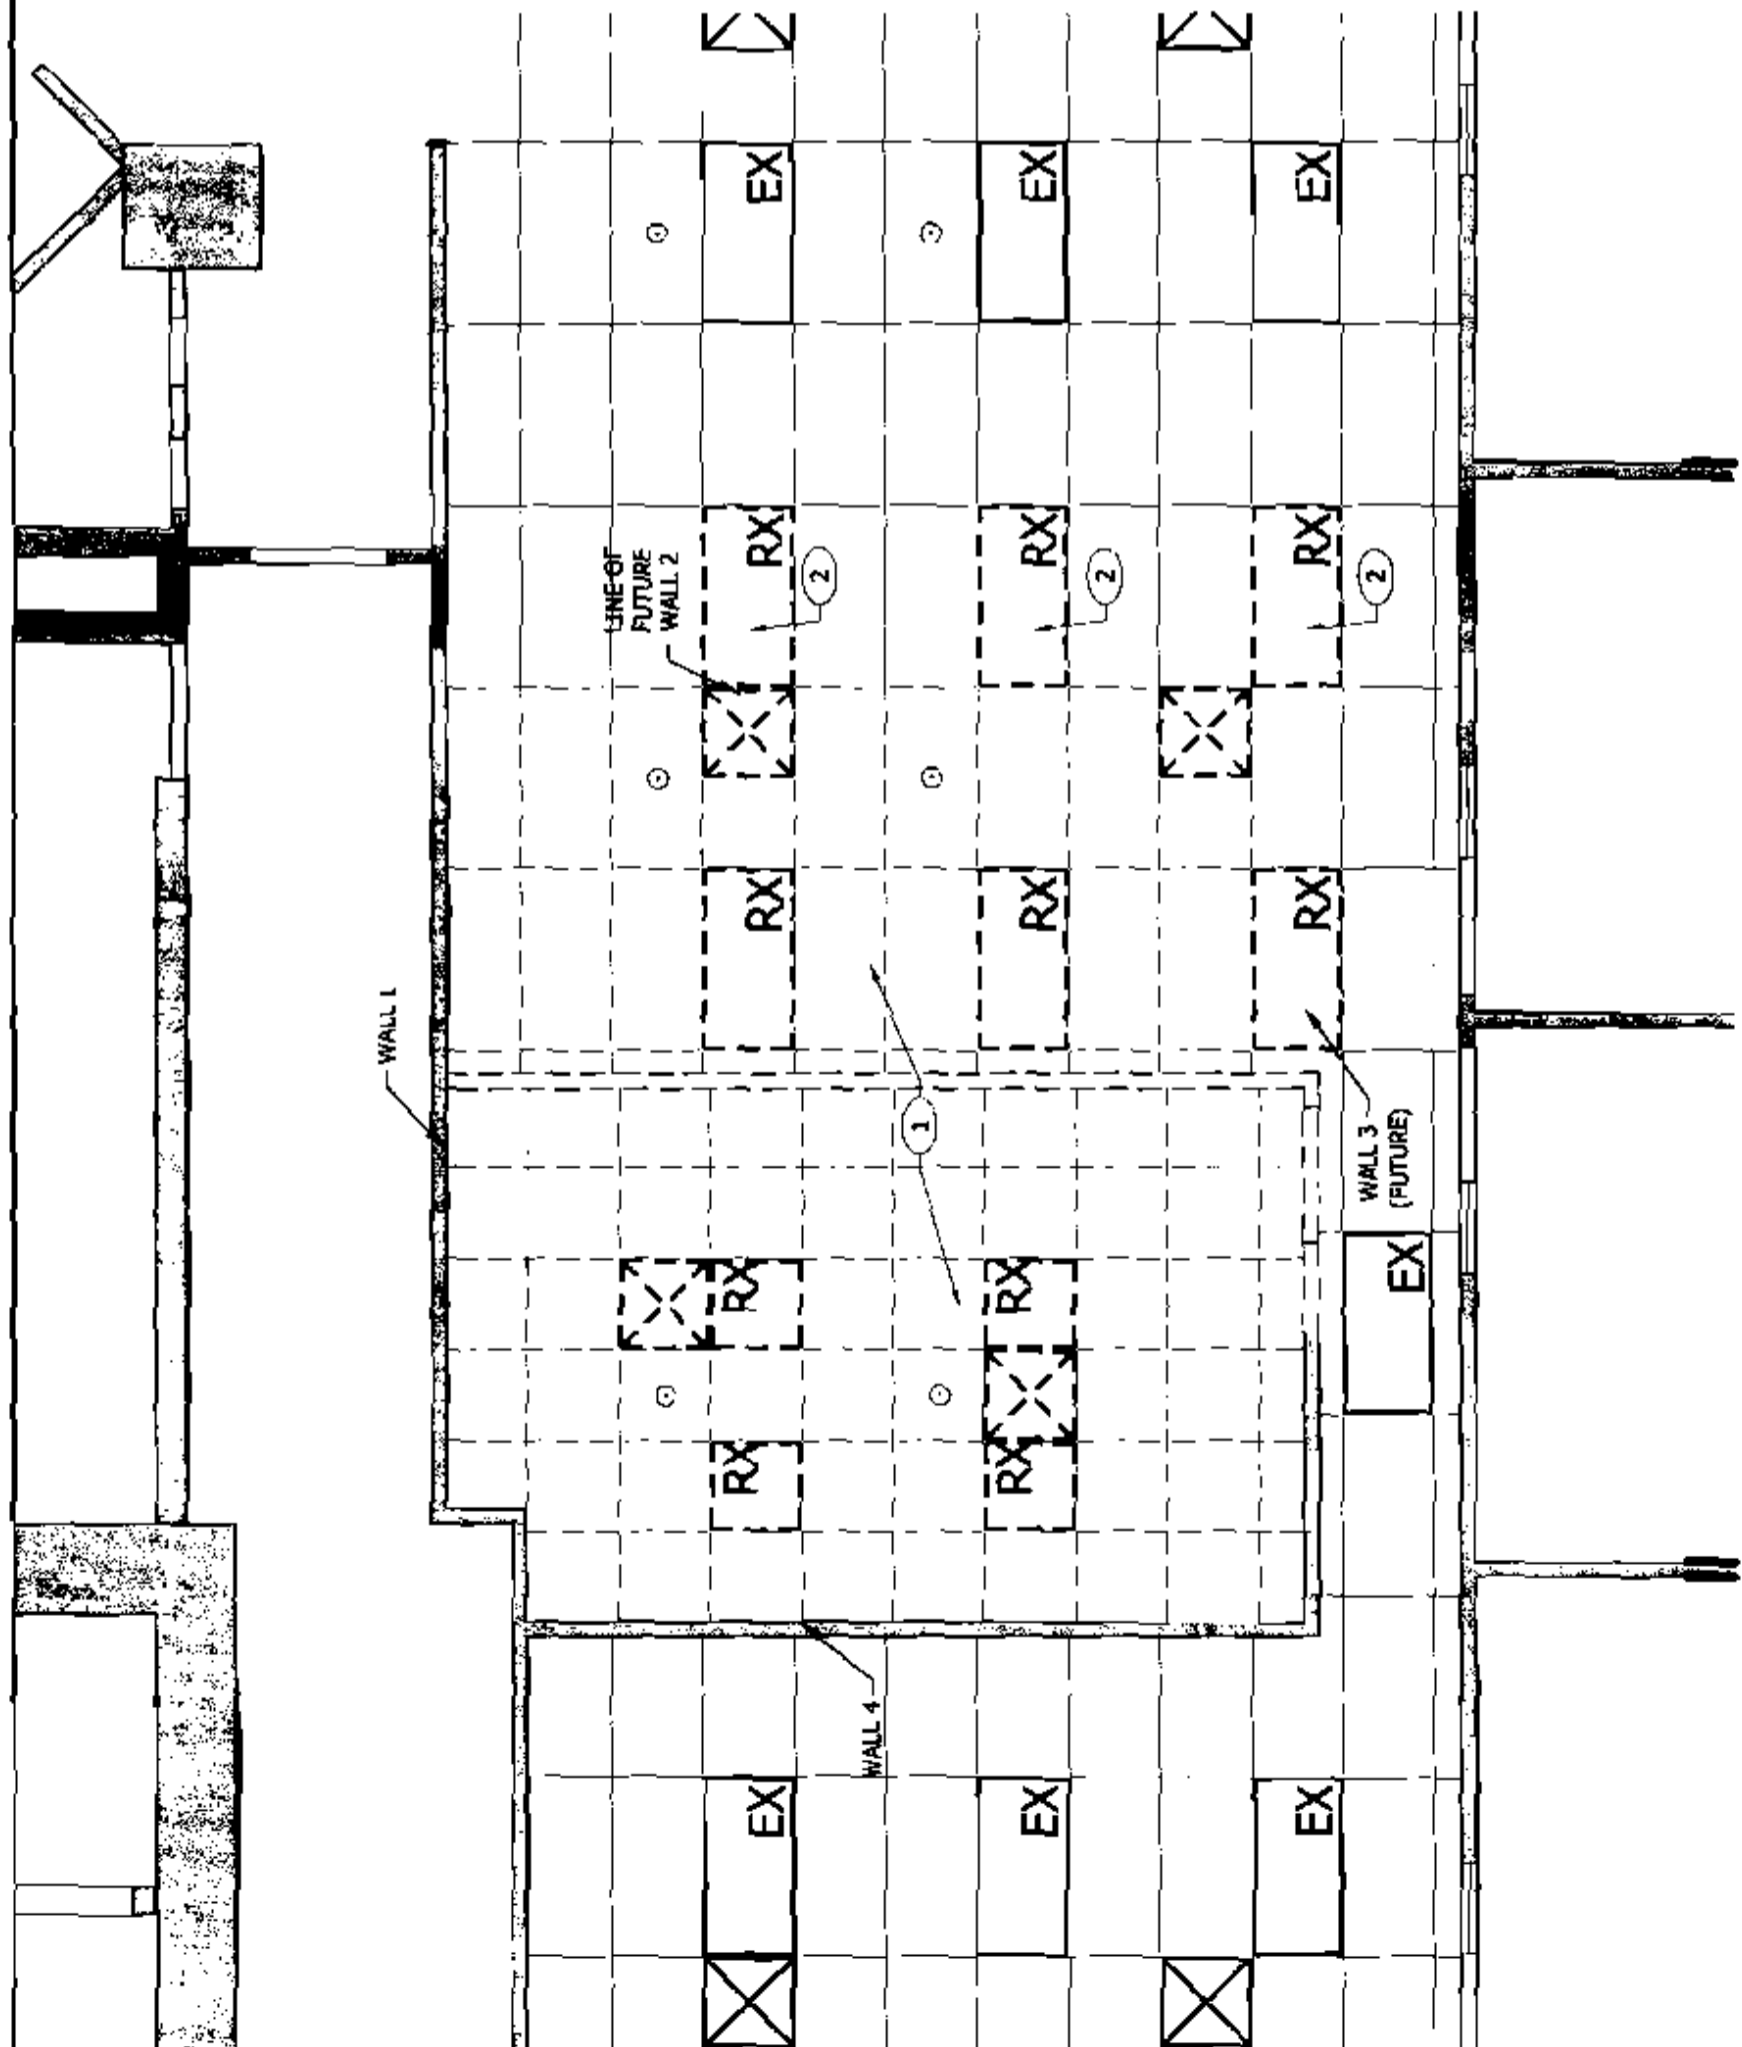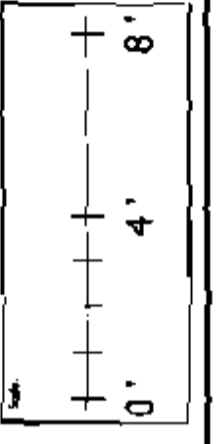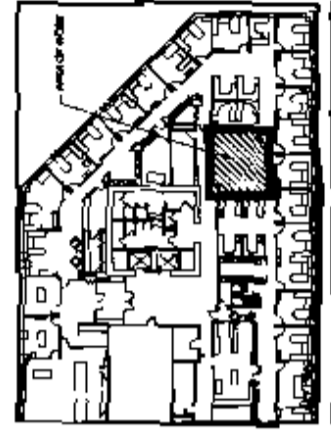

REFLECTED CEILING DEMOLITION PLAN
1/2" = 1'-0"

A0-2

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 BRADLEY T. BLACK
 No. 3457
 STATE OF GEORGIA

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 DALLAS, TX 75257
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 Consultant


SYSKA HENNESSY GROUP, INC.
 525 N. TRYON STREET
 CHARLOTTE, NC 28225
 PHONE: (908) 388-3911
 Consultant
 SYSKA HENNESSY GROUP

Bank of America
 Banker-Buildy
 Construction

PROJECT NO.	MEI-504-02-8045
DATE	07/20/04
SCALE	AS SHOWN
DESIGNED BY	BRADLEY T. BLACK
CHECKED BY	BRADLEY T. BLACK
DATE	07/20/04

Floor 02
 TELEPRESENCE ROOM - MEI-504-02-8045
 100 Middle St.
 Portland, ME 04101
 Project Title & Address



CONSTRUCTION PLAN
 Sheet Title:
 Proj. No.:
 Drawn By: BRADLEY T. BLACK
 Checked By: BRADLEY T. BLACK
 P.L.:
 A1-1
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CONSTRUCTION PLAN KEY NOTES:
 1. WALLS TO BE DEMOLISHED AND REBUILT WITH 5/8\"/>

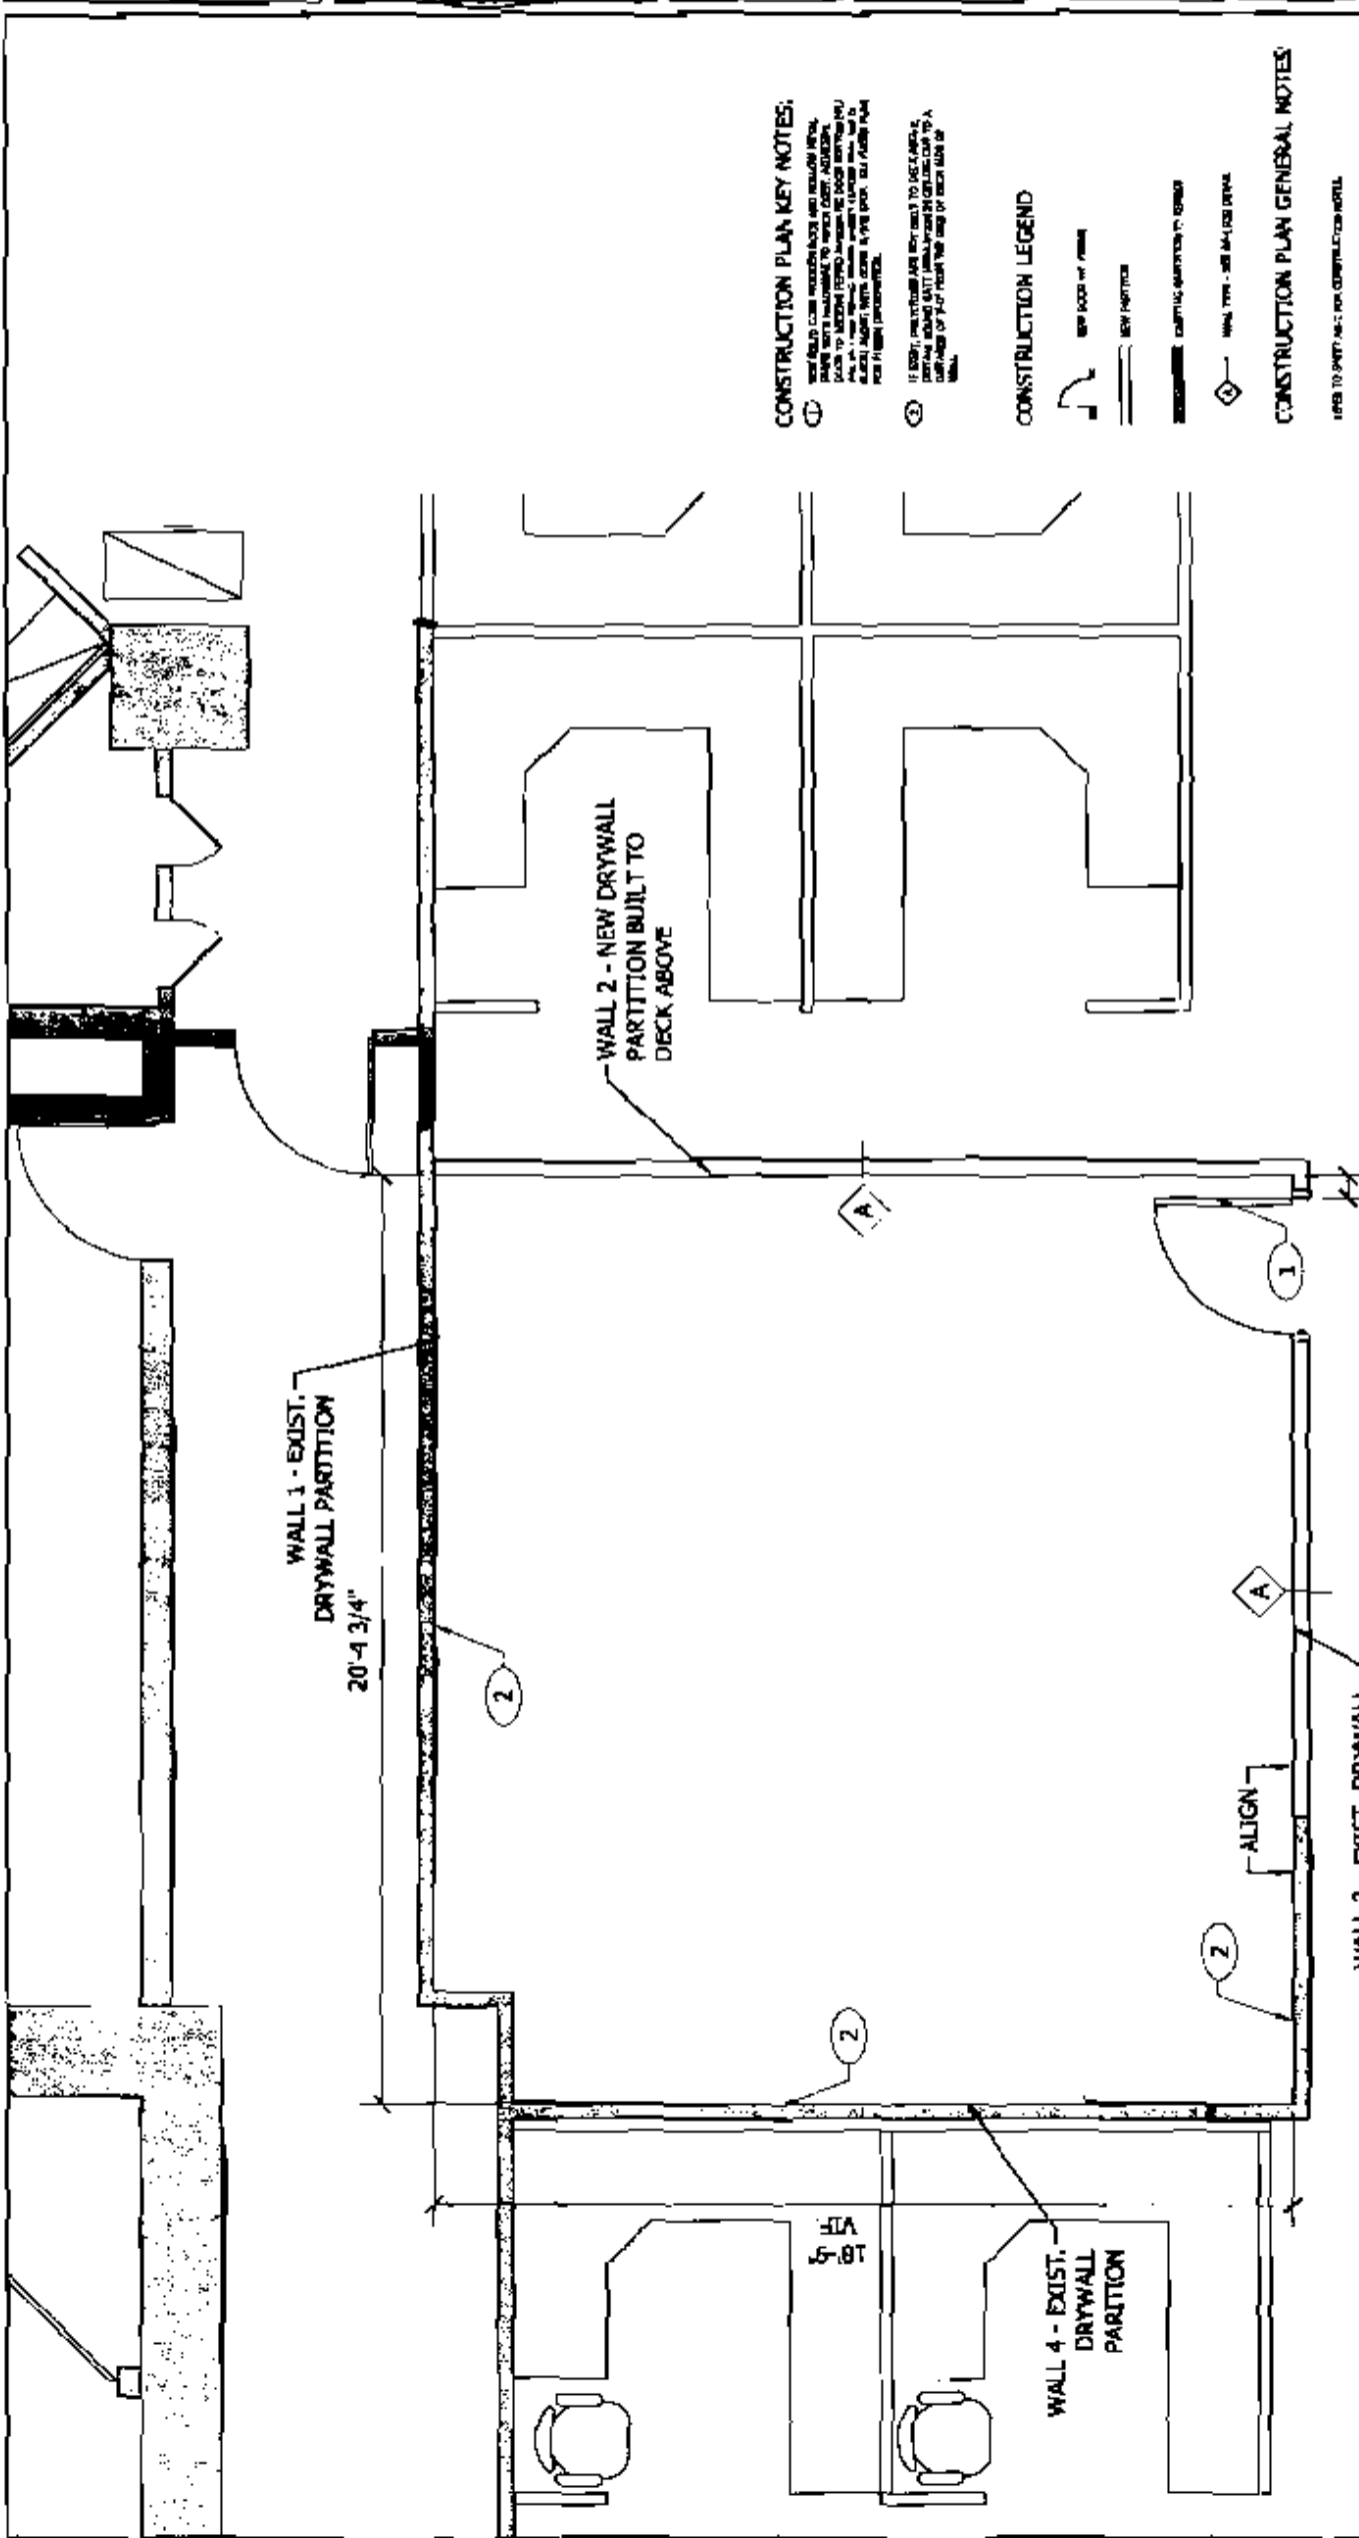- CONSTRUCTION LEGEND**
- NEW WALL OR PARTITION
 - EXIST. PARTITION
 - EXISTING PARTITION TO REMAIN
 - WALL TYPE - SEE SCHEDULE

CONSTRUCTION PLAN GENERAL NOTES
 1. REFER TO SHEET MEI-504-02-8045 FOR GENERAL NOTES




CONSTRUCTION PLAN
 1/2" = 1'-0"

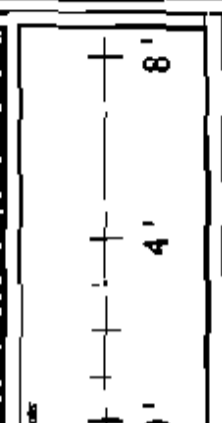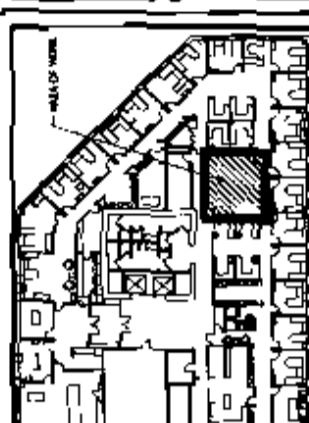1
 A1-1

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Contractor

SYSKA HENNESSY GROUP, INC.

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CHARLOTTE, NC 28255
PHONE: (980) 386-3911

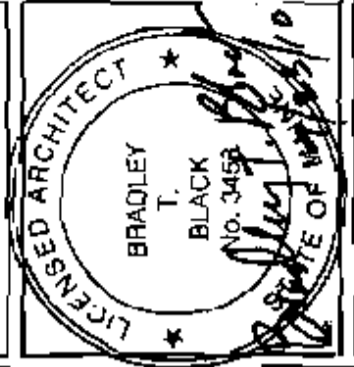SYSKA HENNESSY
architect



Bank of America
Construction

Client

Contract No.	0010250
Issue No.	1
Date	07/20/04
Project Name	TELEPRESENCE ROOM - MEI-504-02-EDAS
Project No.	0010250
Project Location	Portland, ME 04103

TELEPRESENCE ROOM - MEI-504-02-EDAS
Floor 02
100 Middle St.
Portland, ME 04103
Project Title & Address

REFLECTED CEILING PLAN

Drawn By: [blank]
Checked By: [blank]
Date: [blank]

A2-1




ALL DIMENSIONS AND LOCATIONS ARE TO FACE UNLESS OTHERWISE NOTED. THE PROJECT WILL BE CONSTRUCTED AND AS SHOWN. THE ARCHITECT SHALL BE RESPONSIBLE FOR THE ACCURACY OF ALL DIMENSIONS AND LOCATIONS. THE ARCHITECT SHALL BE RESPONSIBLE FOR THE ACCURACY OF ALL DIMENSIONS AND LOCATIONS. THE ARCHITECT SHALL BE RESPONSIBLE FOR THE ACCURACY OF ALL DIMENSIONS AND LOCATIONS.

REFLECTED CEILING PLAN KEY NOTES:

- 1. ALL NEW CEILING AND LIGHT FIXTURES TO BE INSTALLED IN ACCORDANCE WITH THE LATEST EDITIONS OF THE NATIONAL ELECTRICAL CODE (NEC) AND THE NATIONAL FIRE ALARM AND SIGNALING CODE (NFPA 72).
- 2. ALL EXISTING CEILING AND LIGHT FIXTURES TO BE REMOVED AND REINSTALLED IN ACCORDANCE WITH THE LATEST EDITIONS OF THE NATIONAL ELECTRICAL CODE (NEC) AND THE NATIONAL FIRE ALARM AND SIGNALING CODE (NFPA 72).
- 3. ALL EXISTING CEILING AND LIGHT FIXTURES TO BE REMOVED AND REINSTALLED IN ACCORDANCE WITH THE LATEST EDITIONS OF THE NATIONAL ELECTRICAL CODE (NEC) AND THE NATIONAL FIRE ALARM AND SIGNALING CODE (NFPA 72).
- 4. ALL EXISTING CEILING AND LIGHT FIXTURES TO BE REMOVED AND REINSTALLED IN ACCORDANCE WITH THE LATEST EDITIONS OF THE NATIONAL ELECTRICAL CODE (NEC) AND THE NATIONAL FIRE ALARM AND SIGNALING CODE (NFPA 72).

REFLECTED CEILING LEGEND

- Standard LED
- LED Linear - 2' x 4' recessed
- LED Linear - 4' x 8' recessed
- LED Linear - 6' x 12' recessed
- LED Linear - 8' x 16' recessed
- LED Linear - 10' x 20' recessed
- LED Linear - 12' x 24' recessed
- LED Linear - 14' x 28' recessed
- LED Linear - 16' x 32' recessed
- LED Linear - 18' x 36' recessed
- LED Linear - 20' x 40' recessed
- LED Linear - 22' x 44' recessed
- LED Linear - 24' x 48' recessed
- LED Linear - 26' x 52' recessed
- LED Linear - 28' x 56' recessed
- LED Linear - 30' x 60' recessed
- LED Linear - 32' x 64' recessed
- LED Linear - 34' x 68' recessed
- LED Linear - 36' x 72' recessed
- LED Linear - 38' x 76' recessed
- LED Linear - 40' x 80' recessed
- LED Linear - 42' x 84' recessed
- LED Linear - 44' x 88' recessed
- LED Linear - 46' x 92' recessed
- LED Linear - 48' x 96' recessed
- LED Linear - 50' x 100' recessed
- LED Linear - 52' x 104' recessed
- LED Linear - 54' x 108' recessed
- LED Linear - 56' x 112' recessed
- LED Linear - 58' x 116' recessed
- LED Linear - 60' x 120' recessed
- LED Linear - 62' x 124' recessed
- LED Linear - 64' x 128' recessed
- LED Linear - 66' x 132' recessed
- LED Linear - 68' x 136' recessed
- LED Linear - 70' x 140' recessed
- LED Linear - 72' x 144' recessed
- LED Linear - 74' x 148' recessed
- LED Linear - 76' x 152' recessed
- LED Linear - 78' x 156' recessed
- LED Linear - 80' x 160' recessed
- LED Linear - 82' x 164' recessed
- LED Linear - 84' x 168' recessed
- LED Linear - 86' x 172' recessed
- LED Linear - 88' x 176' recessed
- LED Linear - 90' x 180' recessed
- LED Linear - 92' x 184' recessed
- LED Linear - 94' x 188' recessed
- LED Linear - 96' x 192' recessed
- LED Linear - 98' x 196' recessed
- LED Linear - 100' x 200' recessed

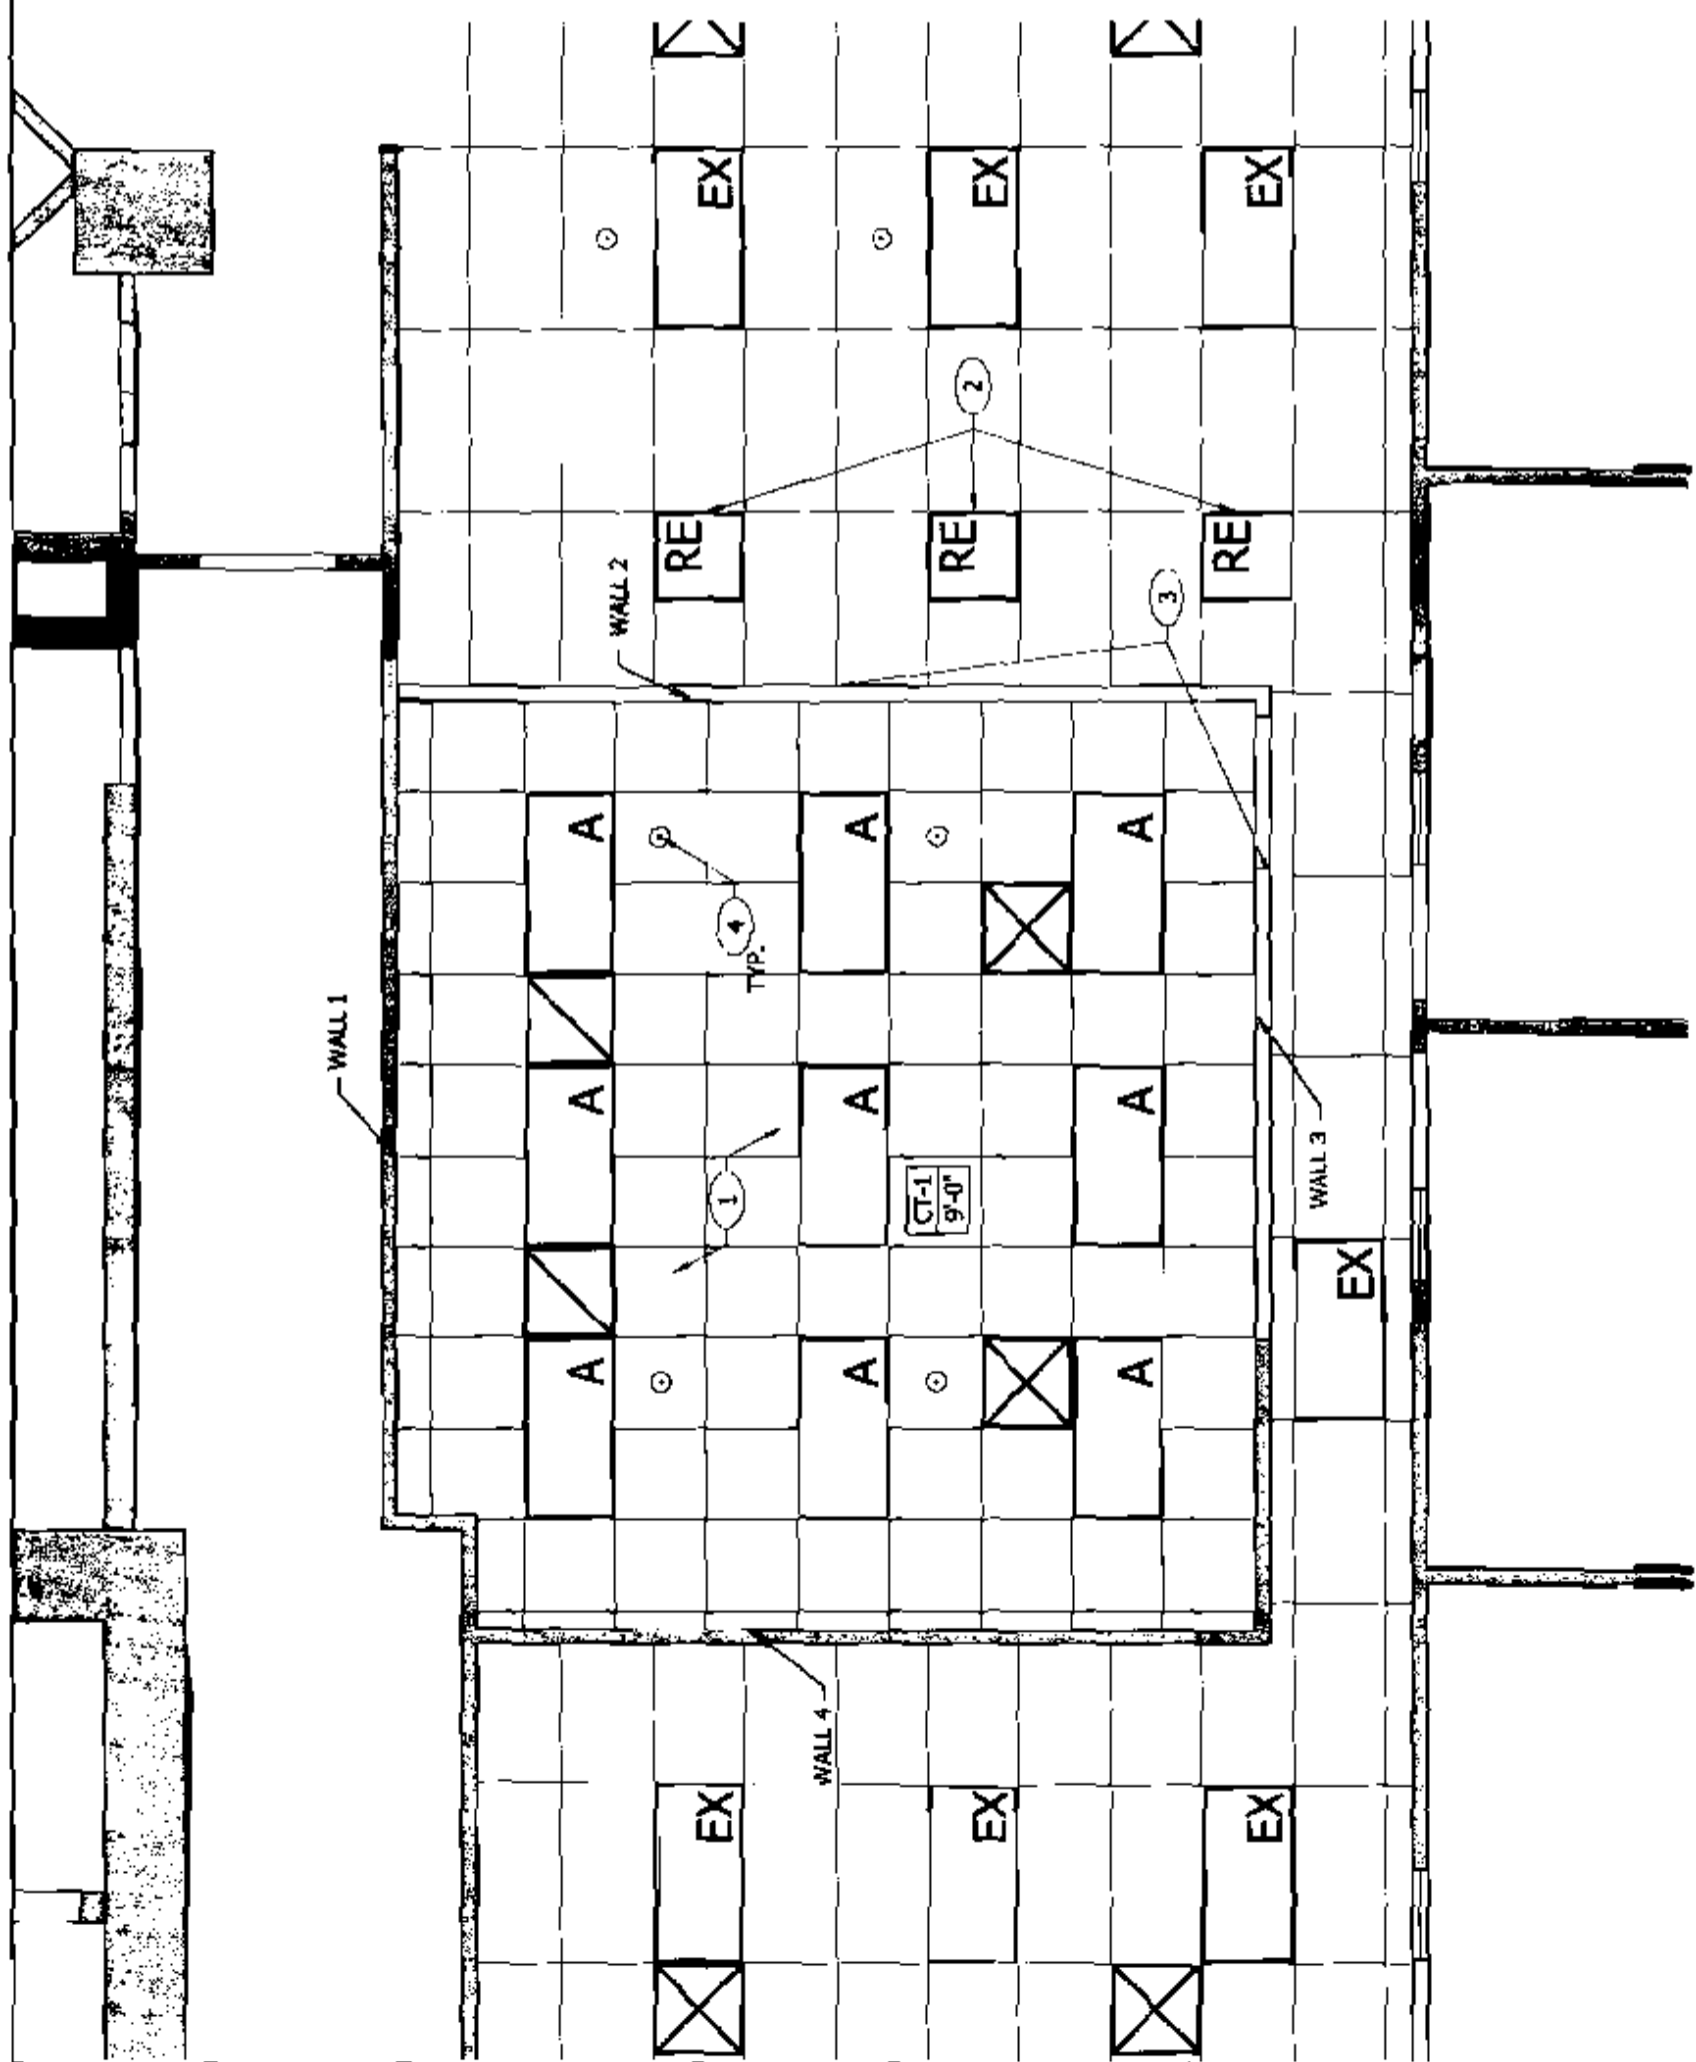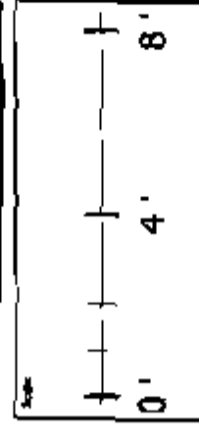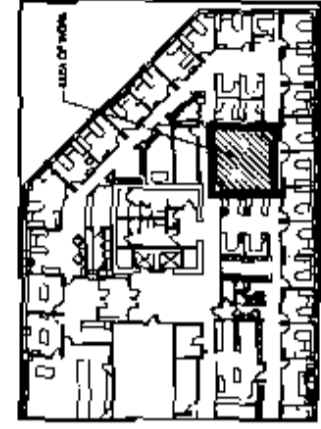


REFLECTED CEILING PLAN

1/2" = 1'-0"

A2-1

NELSON

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SYSKA HENNESSY GROUP, INC.
 925 N. TRYON STREET
 CHARLOTTE, NC 28255
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 Business Library
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Contract No.	10000000000000000000
Project Name	10000000000000000000
Client Name	10000000000000000000
Contractor	10000000000000000000
Architect	10000000000000000000
Interior Designer	10000000000000000000
Engineer	10000000000000000000
MEP Engineer	10000000000000000000
Structural Engineer	10000000000000000000
Electrical Engineer	10000000000000000000
Mechanical Engineer	10000000000000000000
Plumbing Engineer	10000000000000000000
Fire Protection Engineer	10000000000000000000
Transportation Engineer	10000000000000000000
Other	10000000000000000000

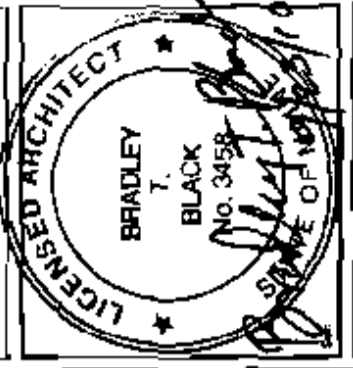TELEPRESENCE ROOM - ME1-504-02-0045
 FLOOR 02
 100 MARKET ST.
 PORTLAND, ME 04101
 Project Title & Address

FINISH PLAN & SCHEDULE

Sheet Title: A4-1
 Project No.:
 Drawn By: M.
 Checked By: C.
 P.L.
 Date: 10/1/00

CEILING TILE AND GRID

- CT-1 12" x 12" 1/2" Acoustic TELLURIA
 12" x 12" Grid
 1/2" Acoustic
 1/2" Acoustic
 1/2" Acoustic
 1/2" Acoustic

PAINT

- P-1 100% Acrylic Latex
 100% Acrylic Latex
 100% Acrylic Latex
 100% Acrylic Latex

BASE

- B-1 1/2" x 1/2" x 1/2" Acoustic
 1/2" x 1/2" x 1/2" Acoustic
 1/2" x 1/2" x 1/2" Acoustic
 1/2" x 1/2" x 1/2" Acoustic

CARPET

- C-1 1/2" x 1/2" x 1/2" Acoustic
 1/2" x 1/2" x 1/2" Acoustic
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FINISH KEY NOTES



1. FINISH KEY NOTES
2. FINISH KEY NOTES
3. FINISH KEY NOTES

FINISH SYMBOL LEGEND

- 1. FINISH SYMBOL LEGEND
- 2. FINISH SYMBOL LEGEND
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FINISH PLAN GENERAL NOTES

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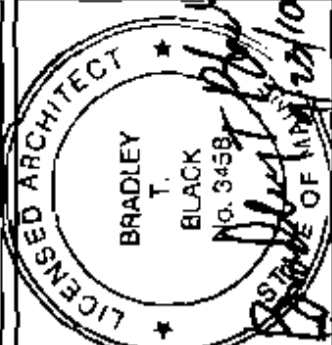


1
 A4-1
 FINISH PLAN
 1/2" = 1'-0"
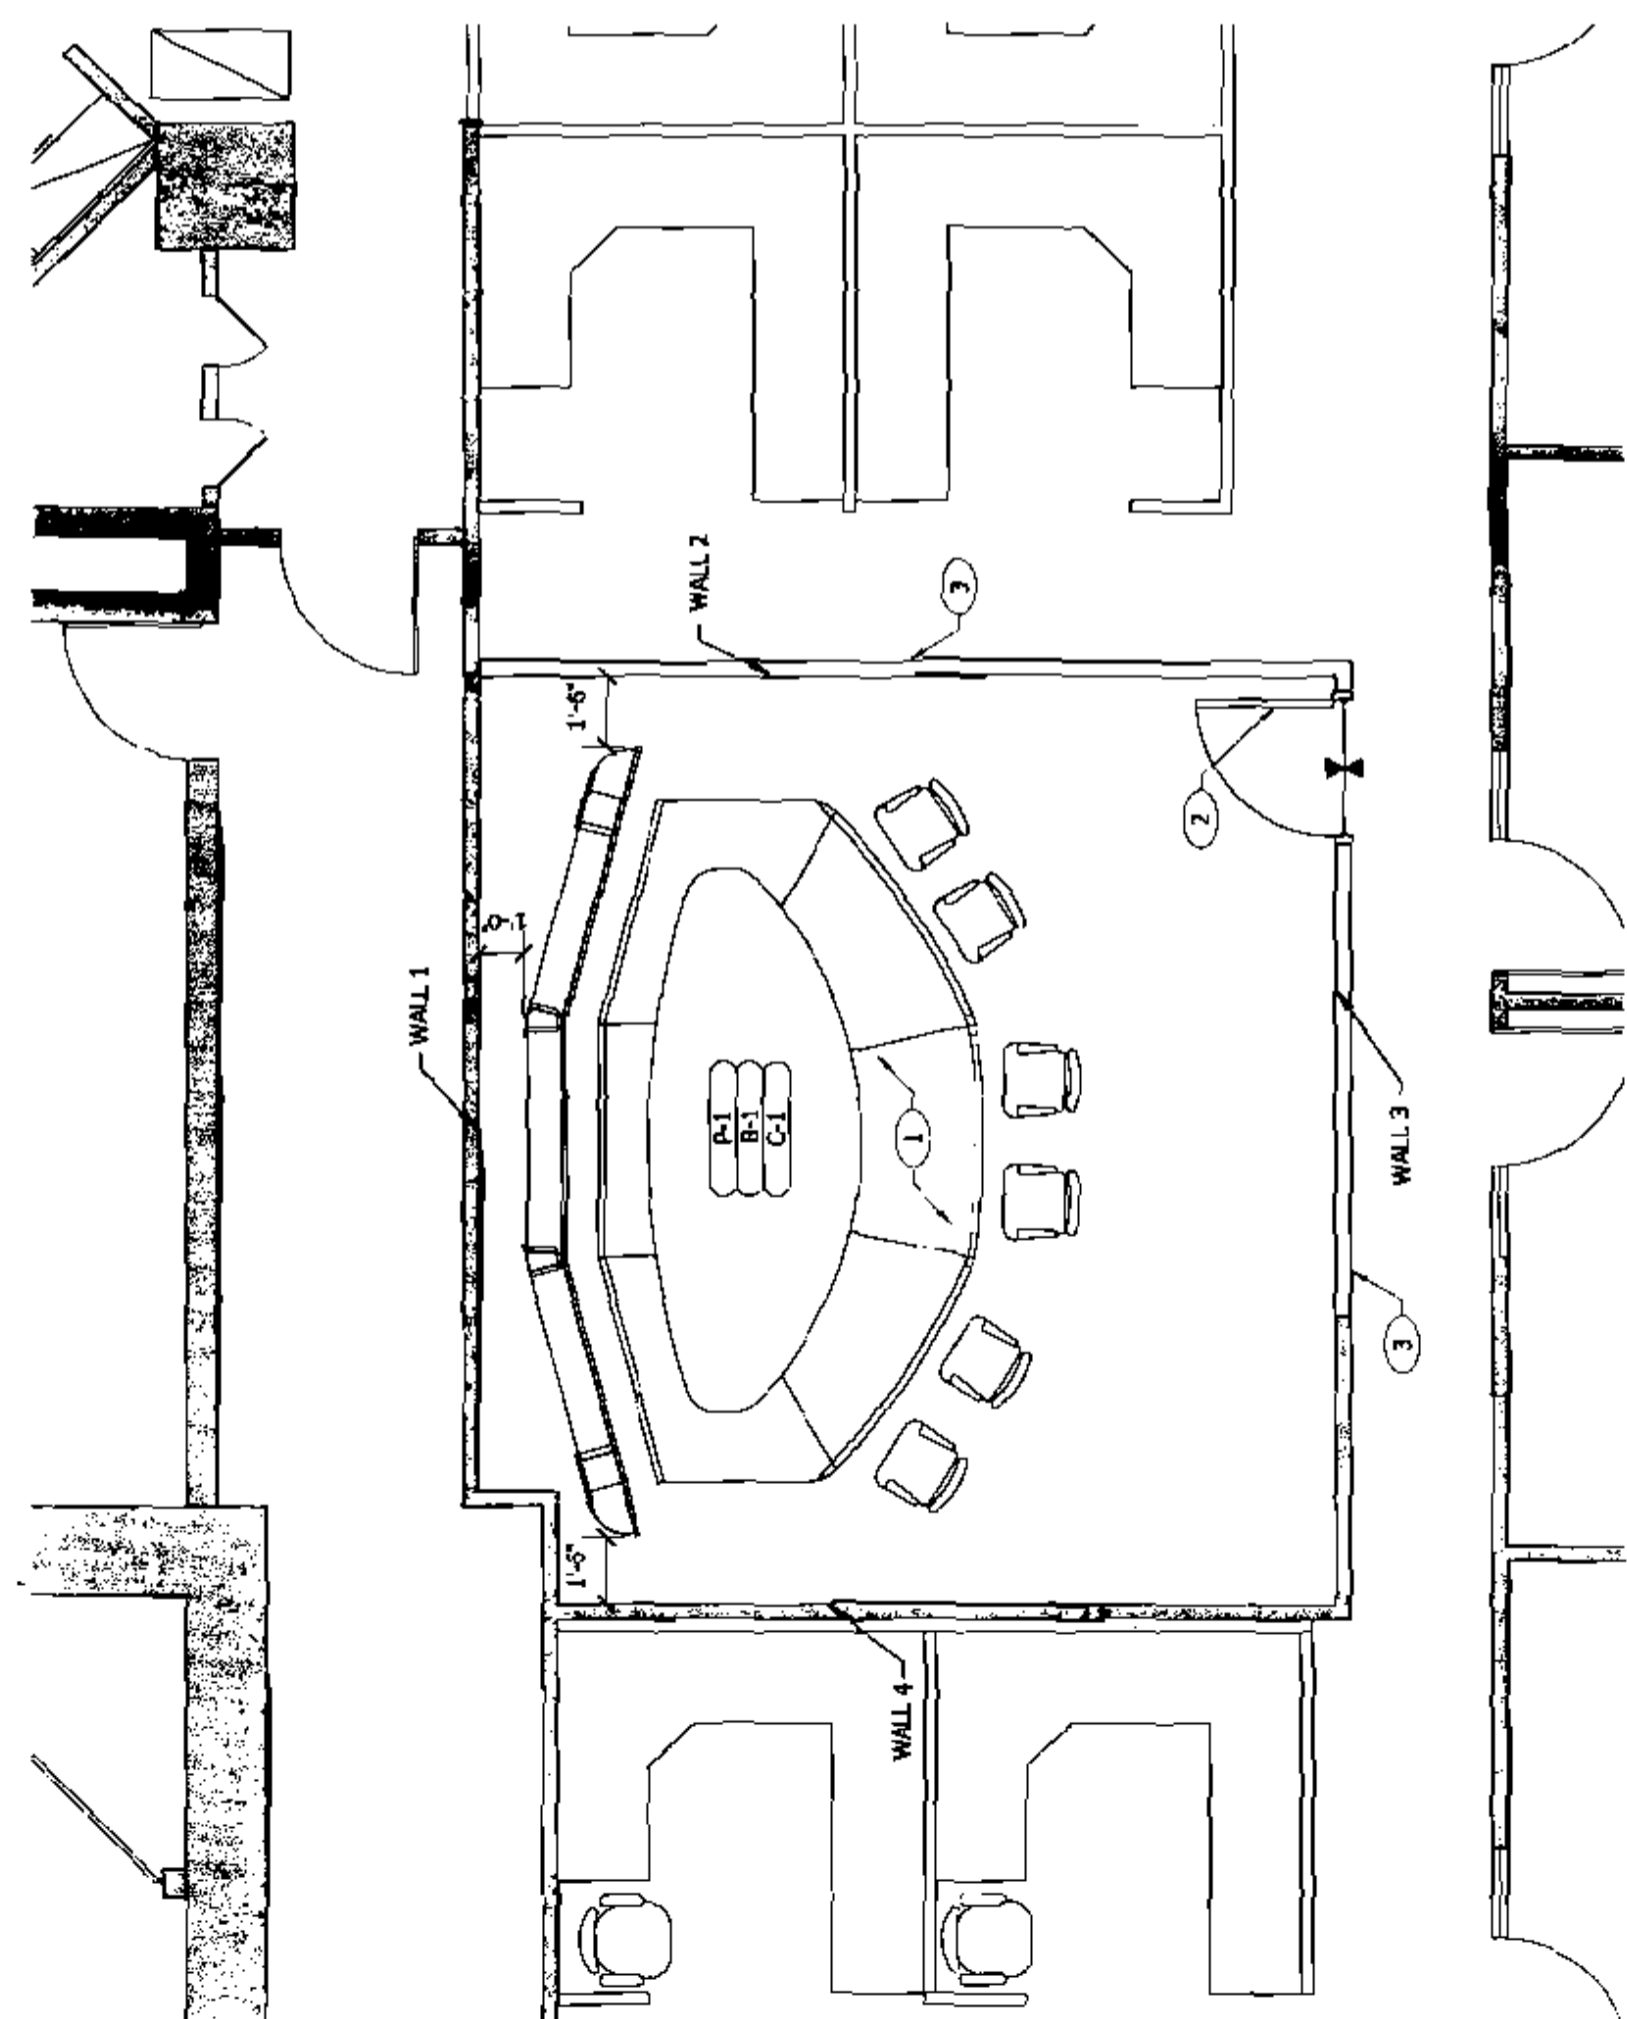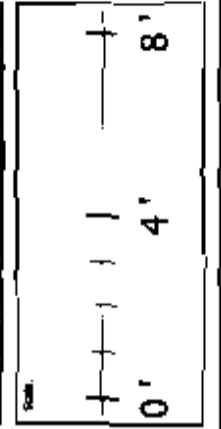
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SYSKA HENNESSY

Bank of America

Bank of America
Construction

1	2	3	4	5
1/2" = 1'-0"	1/2" = 1'-0"	1/2" = 1'-0"	1/2" = 1'-0"	1/2" = 1'-0"

TELEPRESENCE ROOM - ME1-S04-02-80A5

Floor 02
100 Middle St.
Portland, ME 04101
Project File # Address


PARTITION DETAILS

Sheet No. **A7-1**

Project No. 02-02820A

Scale: AS SHOWN

ALL DIMENSIONS AND CONSTRUCTION ARE TO FACE UNLESS OTHERWISE NOTED OR SPECIFIED. THE CONTRACTOR SHALL BE RESPONSIBLE FOR OBTAINING ALL NECESSARY PERMITS TO INSTALL PARTITIONS IN ACCORDANCE WITH ALL APPLICABLE CODES.

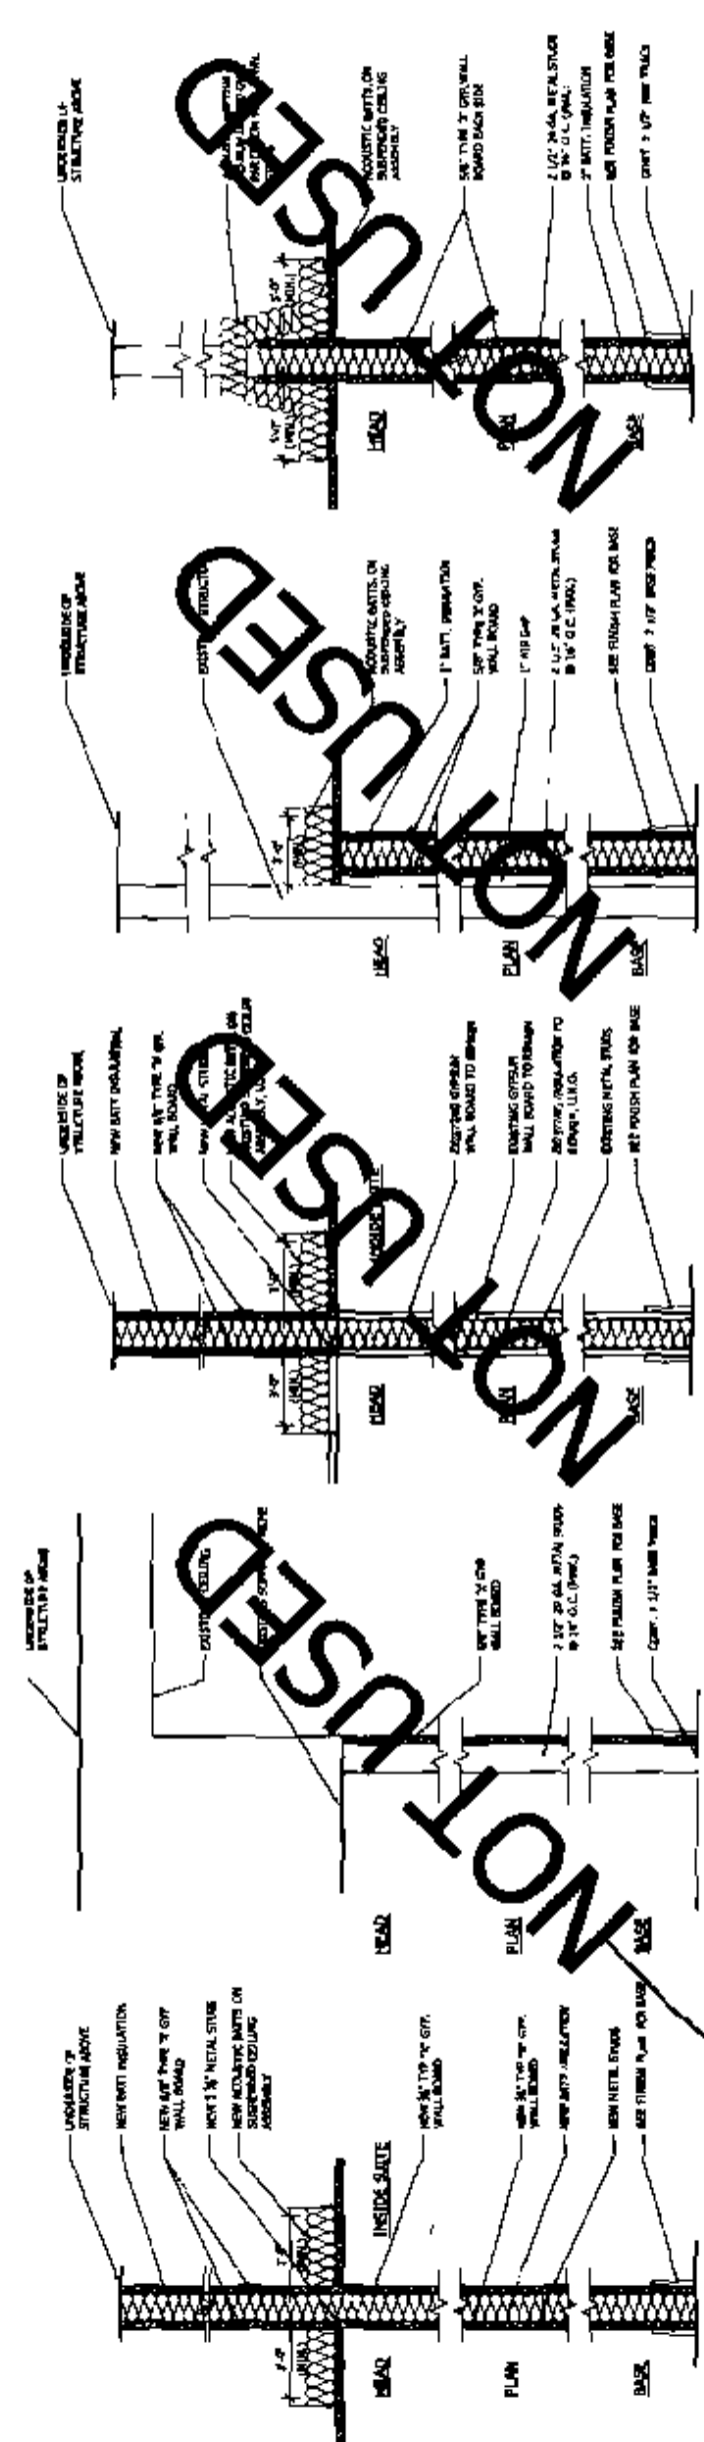


1 WALL TYPE A 1 1/2" = 1'-0" 1 A7-1

2 WALL TYPE B 1 1/2" = 1'-0" 2 A7-1

3 WALL TYPE C 1 1/2" = 1'-0" 3 A7-1

4 WALL TYPE D 1 1/2" = 1'-0" 4 A7-1

5 WALL TYPE E 1 1/2" = 1'-0" 5 A7-1

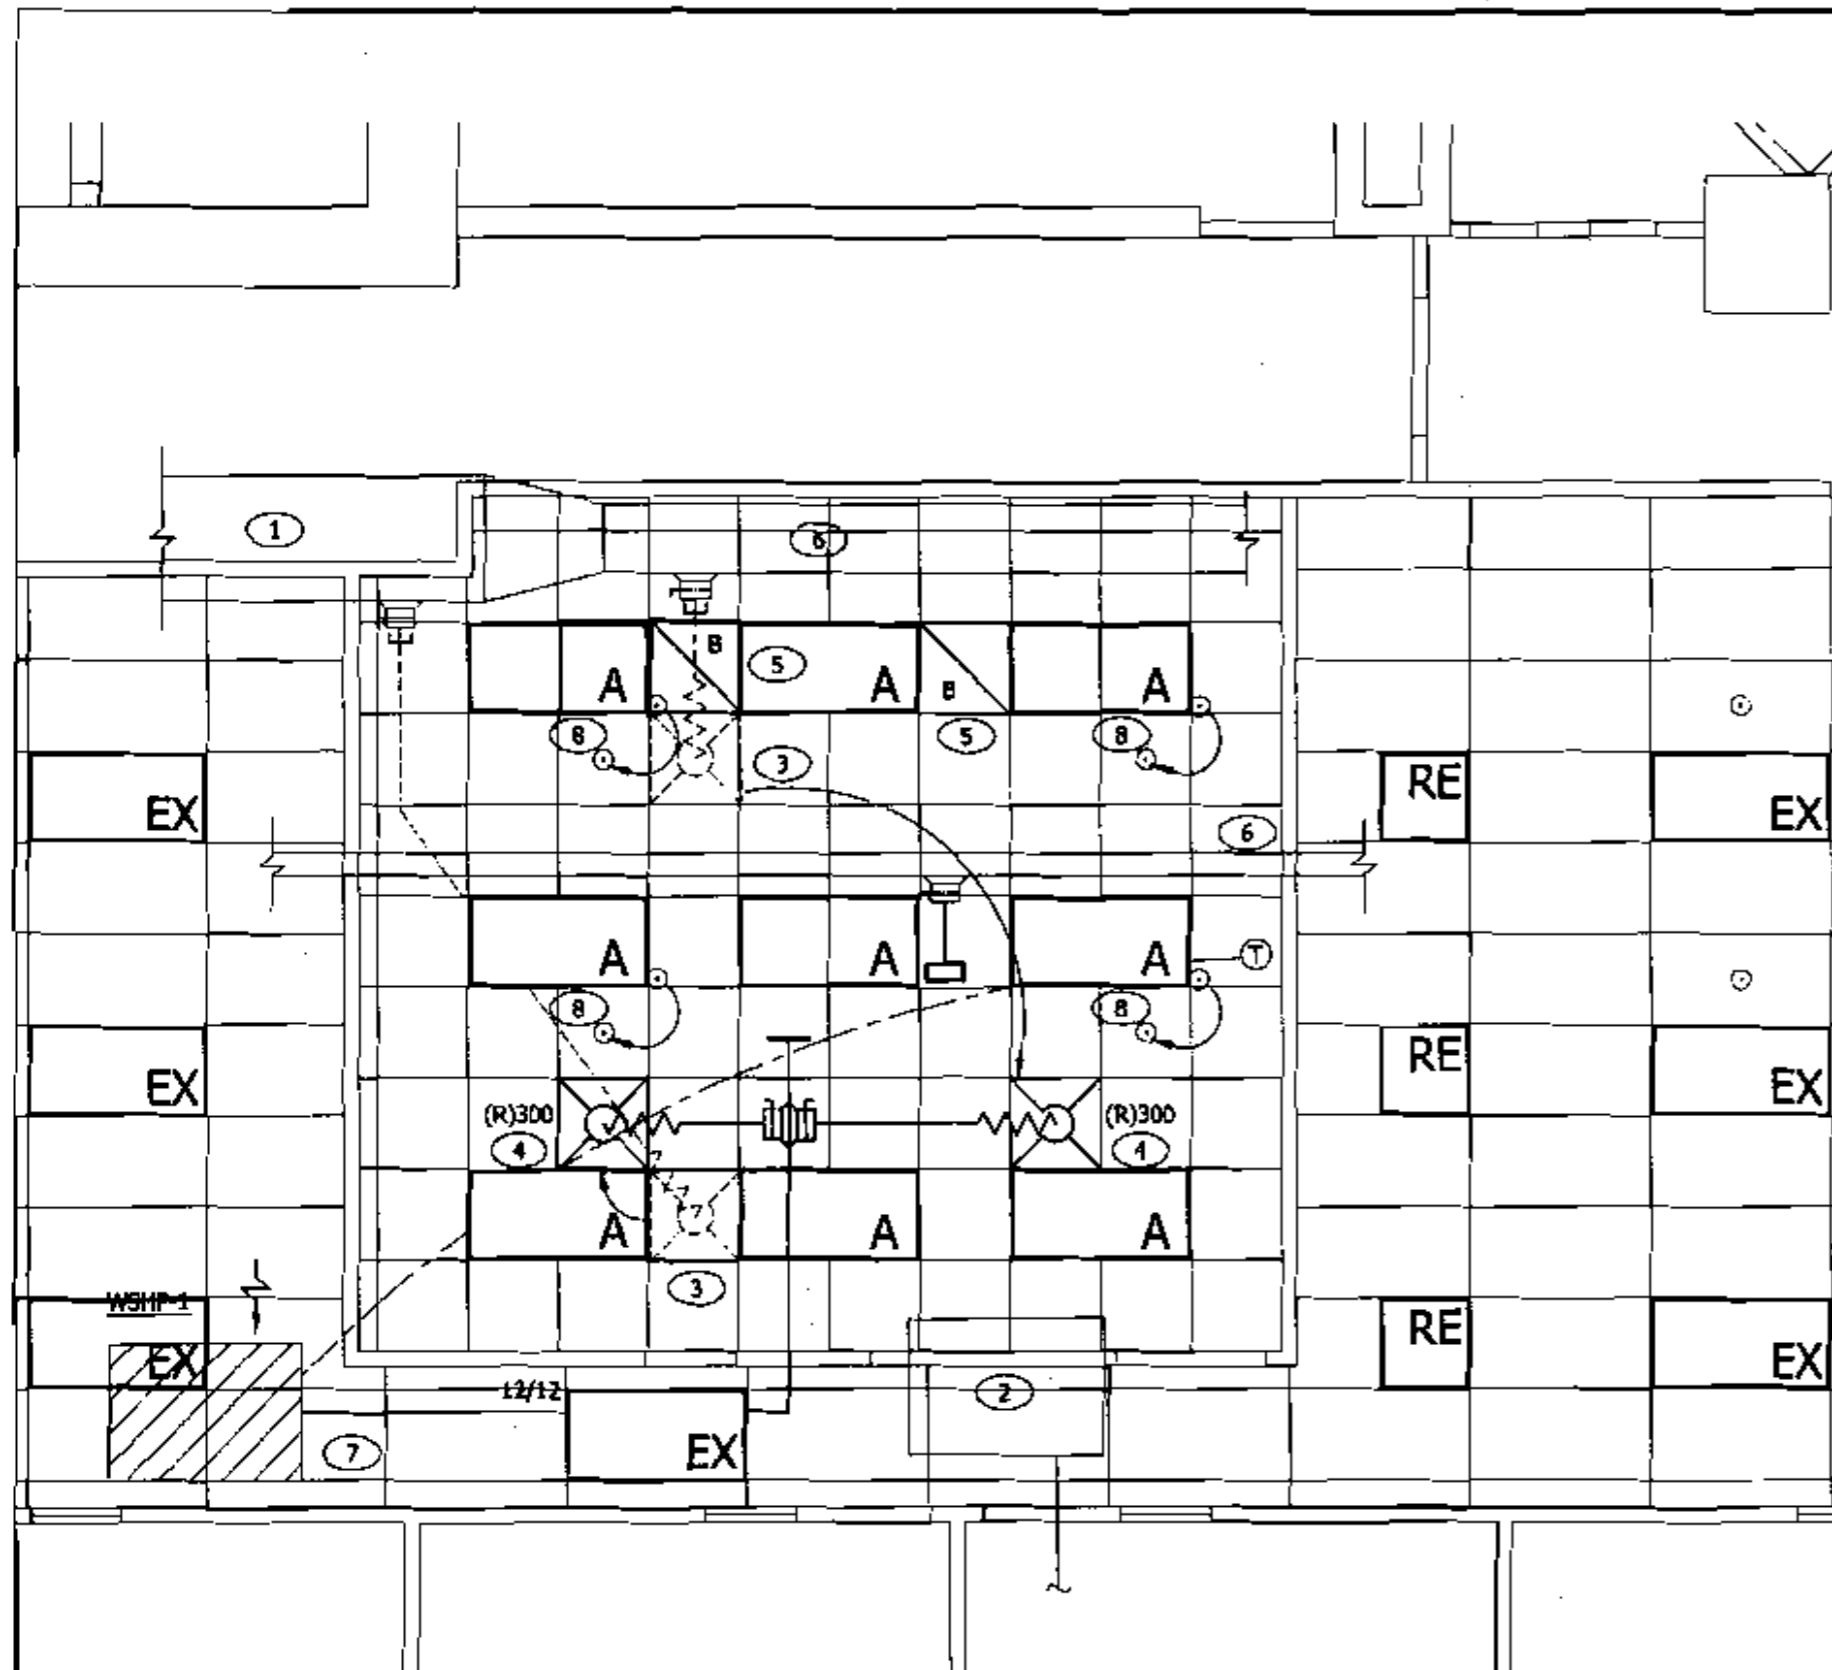

GENERAL NOTES:


1. THE DESIGN INTENT IS TO REUSE AS MUCH OF THE EXISTING HVAC SYSTEM AS POSSIBLE, VERIFY AND DOCUMENT EXISTING CONDITIONS.
2. REFER TO DRAWINGS M0-1 FOR MECHANICAL SPECIFICATIONS, AND M0-2 FOR SYMBOLS AND ABBREVIATIONS.
3. CONTRACTOR SHALL COORDINATE WITH ARCHITECTURAL PLANS TO DETERMINE MINIMUM HEIGHTS FOR DUCTWORK AND EQUIPMENT.
4. ALL EXISTING MECHANICAL EQUIPMENT WITHIN THE AREA OF RENOVATION TO BE REUSED SHALL BE THOROUGHLY CLEANED AND SERVICED TO NEW CONDITION.
5. THESE DRAWINGS WERE PRODUCED BASED ON "AS-BUILT" DRAWINGS FURNISHED BY THE OWNER. CONTRACTOR SHALL BECOME THOROUGHLY FAMILIAR WITH THE SITE PRIOR TO BID. ANY DEVIATIONS FROM DRAWINGS SHALL BE REPORTED TO THE ENGINEER PRIOR TO BEGINNING CONSTRUCTION.

KEYED NOTES:

- ① EXISTING WSHP AND ASSOCIATED DUCT SERVING ADJACENT AREA TO REMAIN. REBALANCE UNIT TO DISTRIBUTE AIR EVENLY TO REMAINING DIFFUSERS.
- ② EXISTING WSHP AND THERMOSTAT SERVING OUTSIDE SPACE TO REMAIN. VERIFY EXACT LOCATION AND RELOCATE AS REQUIRED IF IT INTERFERES WITH NEW CONSTRUCTION.
- ③ DISCONNECT EXISTING DIFFUSERS AND RELATED DUCT FROM APPROXIMATELY THIS LOCATION, CAP DUCT BRANCH AT MAIN. RELOCATE DIFFUSERS PER NOTE 4.
- ④ CONNECT RELOCATED SUPPLY DIFFUSERS TO NEW WSHP. REFER TO DETAIL AND SCHEDULE ON M1-2. COORDINATE PLACEMENT OF SUPPLY DIFFUSERS WITH ARCHITECTURAL CEILING PLAN.
- ⑤ INSTALL NEW TYPE 'B' RETURN GRILLE AND RETURN AIR BOOT. REFER TO DETAIL AND SCHEDULE ON M1-2.
- ⑥ EXISTING SUPPLY AIR DUCTWORK TO REMAIN AS IS.
- ⑦ NEW WSHP. CONNECT TO EXISTING CONDENSER WATER SUPPLY AND RETURN PIPING. REF SCHEDULE AND DETAIL ON M1-2.
- ⑧ RELOCATE EXISTING SPRINKLER HEADS TO CENTER OF CEILING TILES. SUB-CONTRACTOR TO BE RESPONSIBLE FOR RELOCATION.

1 MECHANICAL PLAN
1/4" = 1'-0"

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CHARLOTTE, NC 28255
PHONE: (980) 388-3913
Consultant: SYSKA HENNESSY

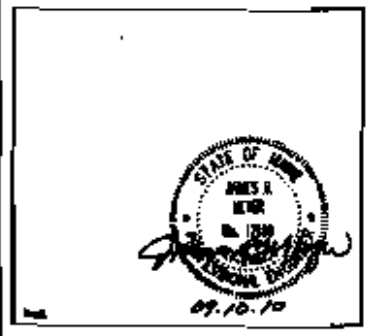Bank of America
Construction

DATE FOR CHECKING AND REVIEW	DATE FOR CHECKING AND REVIEW
REVISIONS	REVISIONS

TELEPRESENCE ROOM - ME 1-504-02-ED45
Floor 02
100 Middle St.
Portland, ME 04101
Project Title & Address:

MECHANICAL PLAN

Sheet Title: _____
 Plot No.: _____
 Date: 09/20/04 09.22.04
 Drawn By: _____
 Checked By: _____
 Title: _____
 Scale: _____

M1-1

ALL DIMENSIONS AND SPACING SHALL BE CHECKED AND VERIFIED ON SITE BY THE CONTRACTOR AND SUB-CONTRACTOR. THE PROJECT MANAGER SHALL BE KEPT ADVISED BY THE CONTRACTOR OF ANY DISCREPANCIES FOUND TO PROCEED WITH THE WORK.
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 4 Licensed architect
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 CHARLOTTE, NC 28255
 PHONE: (919) 388-0911
 SYSCA HENNESSY
 Consultant

Bank of America
 Bank of America
 Construction

DATE FOR ORDER AND ORDER NO.	REV.
DATE FOR REVIEW	REV.
DATE FOR REVISION	REV.
DATE FOR APPROVAL	REV.

REFERENCE ROOM - ME1-504-02-88AS
 FLOOR 02
 100 Middle St.
 Portland, ME 04101
 Project Title & Address

MECHANICAL SCHEDULES
 AND DETAILS

Sheet Title: _____
 File No.: ME1-504-02-88AS
 Sheet No.: _____
 Date: _____
 Scale: _____
M1-2

ALL MECHANICAL AND ELECTRICAL WORK IS TO BE INSTALLED AND TESTED IN ACCORDANCE WITH THE MECHANICAL AND ELECTRICAL CODES AND STANDARDS. THE CONTRACTOR SHALL BE RESPONSIBLE FOR OBTAINING ALL NECESSARY PERMITS AND APPROVALS FROM THE LOCAL AUTHORITIES. ALL WORK SHALL BE SUBJECT TO INSPECTION AND APPROVAL BY THE LOCAL AUTHORITIES.

AIR DEVICE SCHEDULE

DESCRIPTION	DESCRIPTION	MODEL NO.	TYPE	SIZE, IN.	REMARKS
1	CEILING PANEL	10" x 10"	GRID	1.3	
2	CEILING DIFFUSER	10" x 10"	DIFF	1.3	

NOTES:


- CEILING TO MATCH CEILING PANEL.
- CONTRACTOR IS RESPONSIBLE TO PROVIDE THE AIR DEVICE PANEL AND VOLUME TO MATCH THE AIR DEVICE PANEL AND VOLUME. PROVIDE THE AIR DEVICE PANEL AND VOLUME TO MATCH THE AIR DEVICE PANEL AND VOLUME.
- PROVIDE SHEET METAL PATTERN FOR DUCT CONNECTION.
- PROVIDE ATTENUATED RETURN DUCT. REFER TO M1-2.

WATER SOURCE HEAT PUMP UNIT


DESCRIPTION	TYPE AND SIZE	MANUFACTURER	MODEL NO.	MANUFACTURE AND MODEL NO.	REMARKS
1	WATER SOURCE HEAT PUMP	TRANE	WSHP	1000	
2	WATER SOURCE HEAT PUMP	TRANE	WSHP	1000	
3	WATER SOURCE HEAT PUMP	TRANE	WSHP	1000	
4	WATER SOURCE HEAT PUMP	TRANE	WSHP	1000	

NOTES:


- PROVIDE WATER MAIN REQUIRED FOR UNIT CONNECTION.
- PROVIDE WITH (1) 1/2" WATER MAIN CONNECTION.
- PROVIDE WITH (1) 1/2" WATER MAIN CONNECTION.
- PROVIDE WITH (1) 1/2" WATER MAIN CONNECTION.

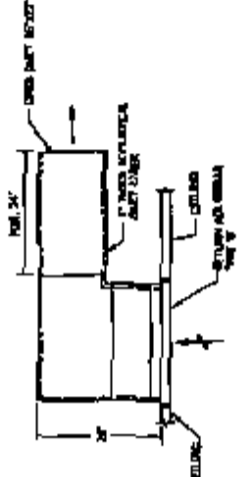

1 ATTENUATED RETURN AIR DUCT
 SCALE: NONE

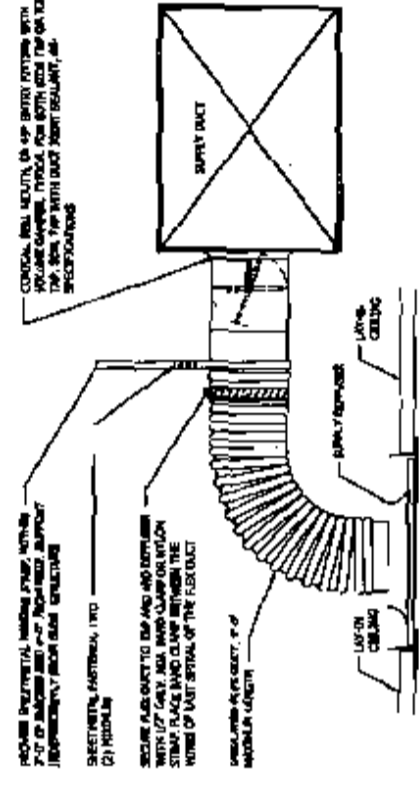

2 SUPPLY DIFFUSER DETAIL
 SCALE: NONE

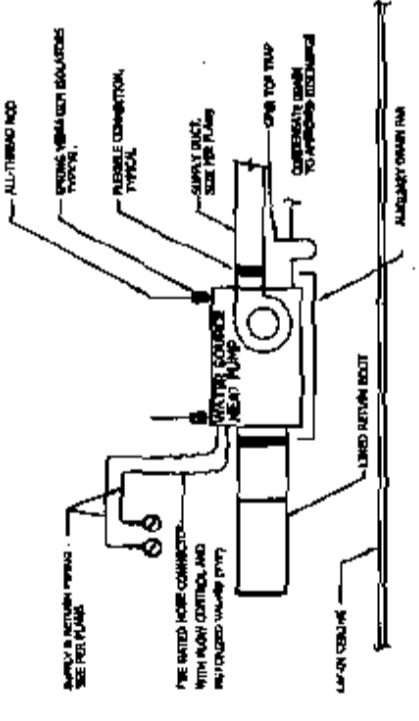

3 WATER SOURCE HEAT PUMP DETAIL
 SCALE: NONE

NELSON

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SYSKA HEINNESSY GROUP, INC.
525 N. TRYON STREET
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PHONE: (980) 398-7911
Contractor



Bank of America
Business Property
Construction

REVISIONS	DATE	BY	CHKD BY

TELEPRESENCE ROOM - PIEL-504-03-8845
Room 02
200 Middle St.
Portland, ME 04101
Project Title & Address

LIGHTING PLAN


Sheet No. 04-0004-01-021
Rev. No. 1/1
Checked By: JH
Date: 10/10/90

E2-1

ALL CONSTRUCTION SHALL BE IN ACCORDANCE WITH THE 1990 NATIONAL ELECTRICAL CODE (NEC) AND THE 1990 NATIONAL FIRE ALARM AND SIGNALING CODE (NFPA 72). THE PROJECT SHALL BE CONFORMED TO THE SPECIFICATIONS OF THE CONTRACT DOCUMENTS AND SHALL BE SUBJECT TO THE REVIEW AND APPROVAL OF THE LOCAL PERMITS OFFICE. ALL WORK SHALL BE IN ACCORDANCE WITH THE LOCAL PERMITS OFFICE. ALL WORK SHALL BE IN ACCORDANCE WITH THE LOCAL PERMITS OFFICE.

KEYED NOTES:

1. CONNECT TO EXISTING LIGHTING CIRCUIT CURRENTLY FEEDING THIS ROOM, PROVIDE NEW SWITCHING AS REQUIRED.
2. PROVIDE DUAL SWITCHING PER IEDC REQUIREMENTS.
3. EMERGENCY EGRESS FIXTURE, CONNECT TO NEAREST EGRESS LIGHTING CIRCUIT SERVING THIS AREA.
4. EXISTING 2X2 FIXTURE TO BE RELOCATED AS INDICATED.
5. CONNECT RELOCATED FIXTURE TO EXISTING LIGHTING CIRCUIT AND CONTROLS.
6. EXISTING FIXTURE TO REMAIN.

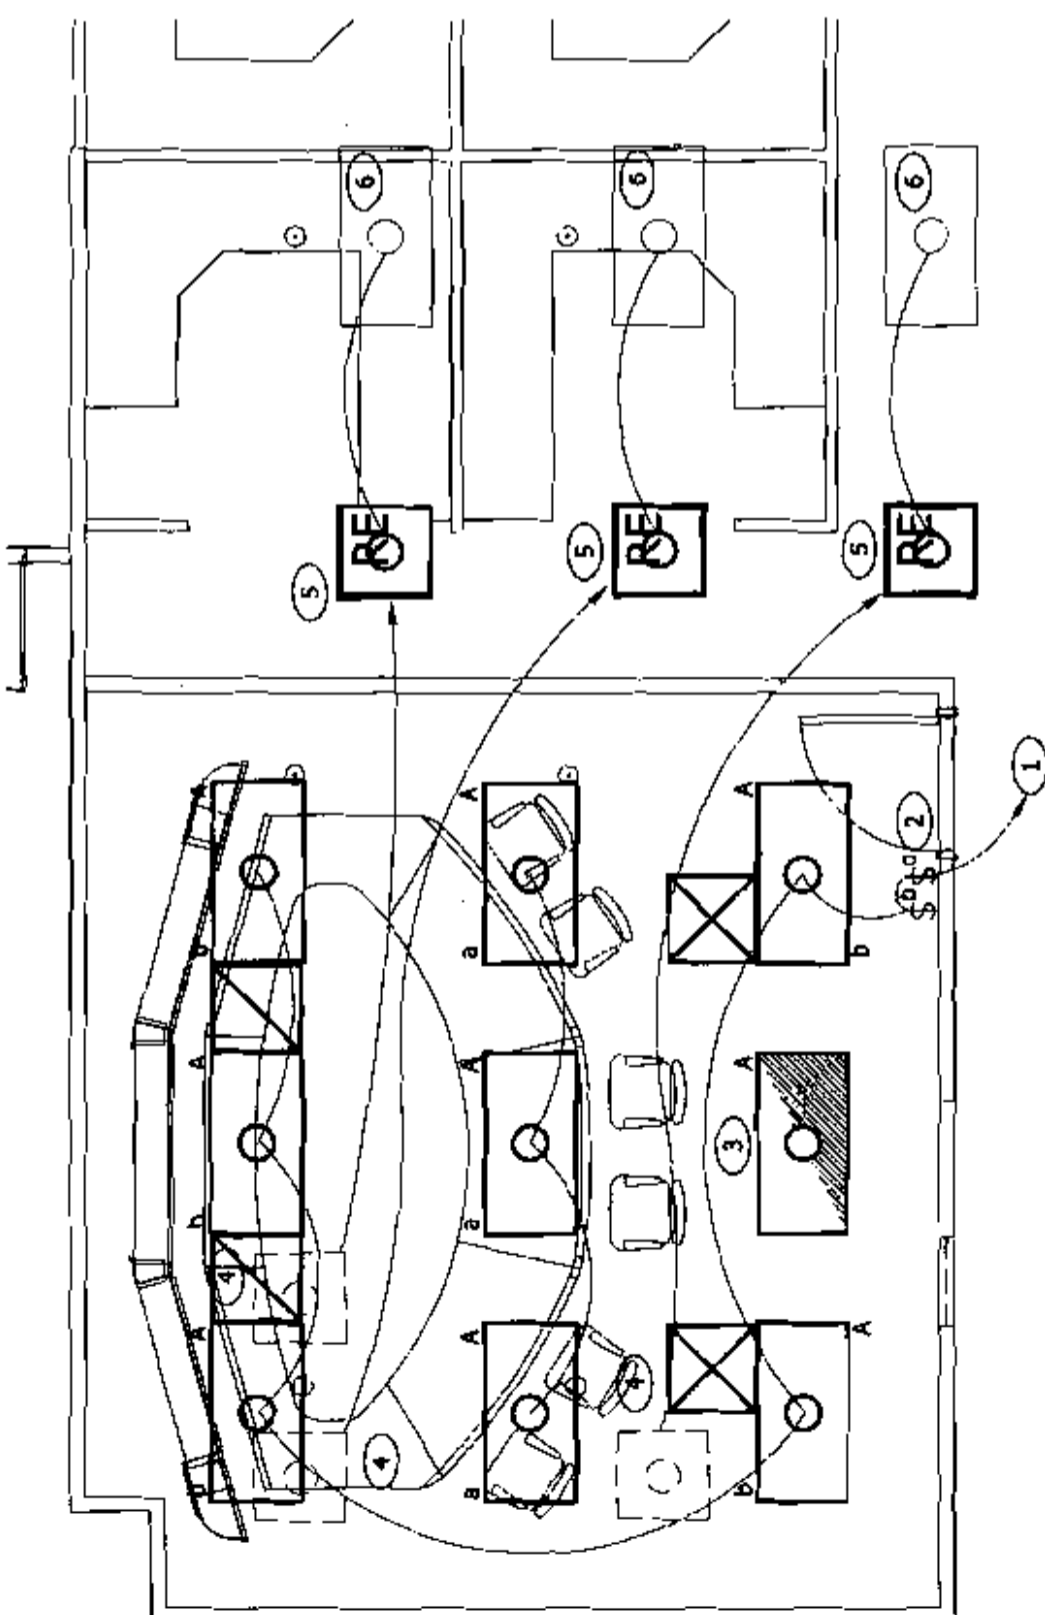

GENERAL NOTES:

1. DESIGN INTENT IS TO REUSE AS MUCH OF THE EXISTING LIGHTING AND CONTROLS AS POSSIBLE. VERIFY AND DOCUMENT EXISTING CONDITIONS.
2. REFER TO ARCHITECTURAL REFLECTED CEILING PLAN FOR EXACT LOCATIONS OF CEILING MOUNTED LIGHT FIXTURES.
3. REFER TO ED-4 & E4-1 FOR PANEL SCHEDULES, ELECTRICAL LEGEND, & ELECTRICAL RISER.
4. SWITCHES IN ROOM CONTROL FIXTURES IN ROOM UNLESS NOTED OTHERWISE.
5. NEW CIRCUIT BREAKERS INSTALLED IN EXISTING PANELS SHALL MATCH EXISTING PANEL MANUFACTURER AND AIC RATING. UPDATE PANELBOARD CIRCUIT DIRECTORIES TO REFLECT CHANGES.
6. LOWER CASE LETTER ADJACENT TO FIXTURE INDICATES SWITCH DESIGNATION.
7. ALL LIGHT SWITCHES SHALL BE LABELED WITH CIRCUIT NUMBER ON BACK OF COVER PLATE WITH A TYPED LABEL. LOCATIONS THAT REQUIRE MULTIPLE SWITCHES SHALL BE GROUDED IN ONE BOX UNDER A COMMON SWITCHPLATE. BOX SHALL BE DIVIDED AS NEC REQUIRES.
8. ALL WIREHOLD AND LIGHT FIXTURES SHALL BE PURCHASED THROUGH EDI - ELECTRICAL DISTRIBUTOR, INC. OFFICE PHONE: 704-372-3040 FAX: 704-377-6975 CONTACTS: MARTY JACKSON, DAVO BUDNICK, SEAN RICHARD

LIGHTING PLAN

1/2" = 1'-0"

LIGHTING FIXTURE SCHEDULE			REMARKS	
TYPE	MOUNTING/MANUFACTURER	CATALOG NUMBER	VOLT	
A	RECESSED ZUMTOBEL RCF	RCFU-24-2285- P-W-U	UNIV	2X4 INDIRECT LAMPS SHALL BE 4100 KELVIN WITH 82 CRI ELECTRONIC BALLAST

NOTE: NEC 410 - PROVIDE BALLAST DISCONNECTING MEANS IN FLUORESCENT FIXTURES AND OTHER FIXTURES THAT CONTAIN BALLAST(S).

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JAMES A. NELSON
REGISTERED PROFESSIONAL ARCHITECT
No. 17319
EXPIRES 12/31/2007

NELCO ARCHITECTURE, INC.
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SYSCA HENNESSY
Contractors

Bank of America
Building Materials
Construction
Client

DATE FOR PERMITS AND PERMIT	DATE FOR PERMITS AND PERMIT
DATE FOR PERMITS AND PERMIT	DATE FOR PERMITS AND PERMIT
DATE FOR PERMITS AND PERMIT	DATE FOR PERMITS AND PERMIT


TELEPRESENCE ROOM - NEL 504-02-0245
Floor 02
100 Middle St.
Portland, ME 04101
Project Title is Address

POWER/SYSTEMS PLAN

Sheet Title: _____
Page No.: _____
Drawn By: _____
Checked By: _____
Date: _____

E3-1

ALL WORKSHOWN AND EXISTING SHALL BE IN ACCORDANCE WITH THE NATIONAL ELECTRICAL CODE (NEC) AND ALL OTHER APPLICABLE CODES AND REGULATIONS. ALL WORKSHOWN SHALL BE IN ACCORDANCE WITH THE NATIONAL ELECTRICAL CODE (NEC) AND ALL OTHER APPLICABLE CODES AND REGULATIONS. ALL WORKSHOWN SHALL BE IN ACCORDANCE WITH THE NATIONAL ELECTRICAL CODE (NEC) AND ALL OTHER APPLICABLE CODES AND REGULATIONS.

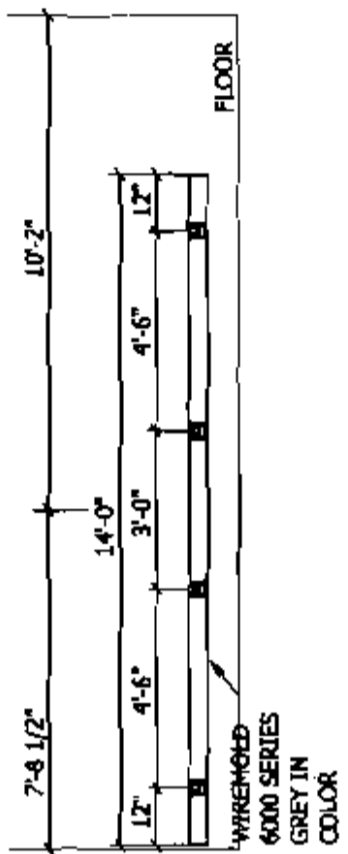

WIREMOLD DETAIL




2
E3-1

GENERAL NOTES:

1. REFER TO KEYED NOTES FOR ADDITIONAL INFORMATION.
2. REFER TO DRAWINGS ED-4, AND E4.1 FOR GENERAL NOTES, ELECTRICAL SYMBOLS, DETAILS, PANELBOARD SCHEDULES, AND RISER DIAGRAM.
3. REFER TO ED.3 FOR TYPICAL MOUNTING HEIGHTS OF DEVICES.
4. ALL LIGHT FIXTURES SHALL BE PURCHASED THROUGH EDI - ELECTRICAL DISTRIBUTOR, INC. OFFICE PHONE: 704-372-3040 FAX: 704-377-6975 CONTACTS: MARTY JACKSON, DAVID BUONICK, SEAN RICHARD.

KEYED NOTES:

- 1 NEW FIRE ALARM DEVICE TO MATCH BUILDING STANDARD.
- 2 CONNECT TO EXISTING PANEL 'PIC' LOCATED IN ELECTRICAL ROOM.
- 3 NEW WALL MOUNTED PHONE AT 48" AFF.
- 4 WIREMOLD 6000 SERIES WALL MOUNTED RACEWAY, GREY IN COLOR, WITH DEVICES AS INDICATED. PROVIDE 1 1/4" CONDUIT FROM ABOVE ACCESSIBLE CEILING WITH PULL STRING FOR DATA CONNECTIONS. REFER TO 02/E3-1.
- 5 NEW RECEPTACLE, PROVIDE GREY DEVICE AND FACE PLATE.
- 6 PROVIDE (2) CAT 6 CABLES TO THIS LOCATION.
- 7 PROVIDE (2) CAT 6 CABLE TO THIS LOCATION.

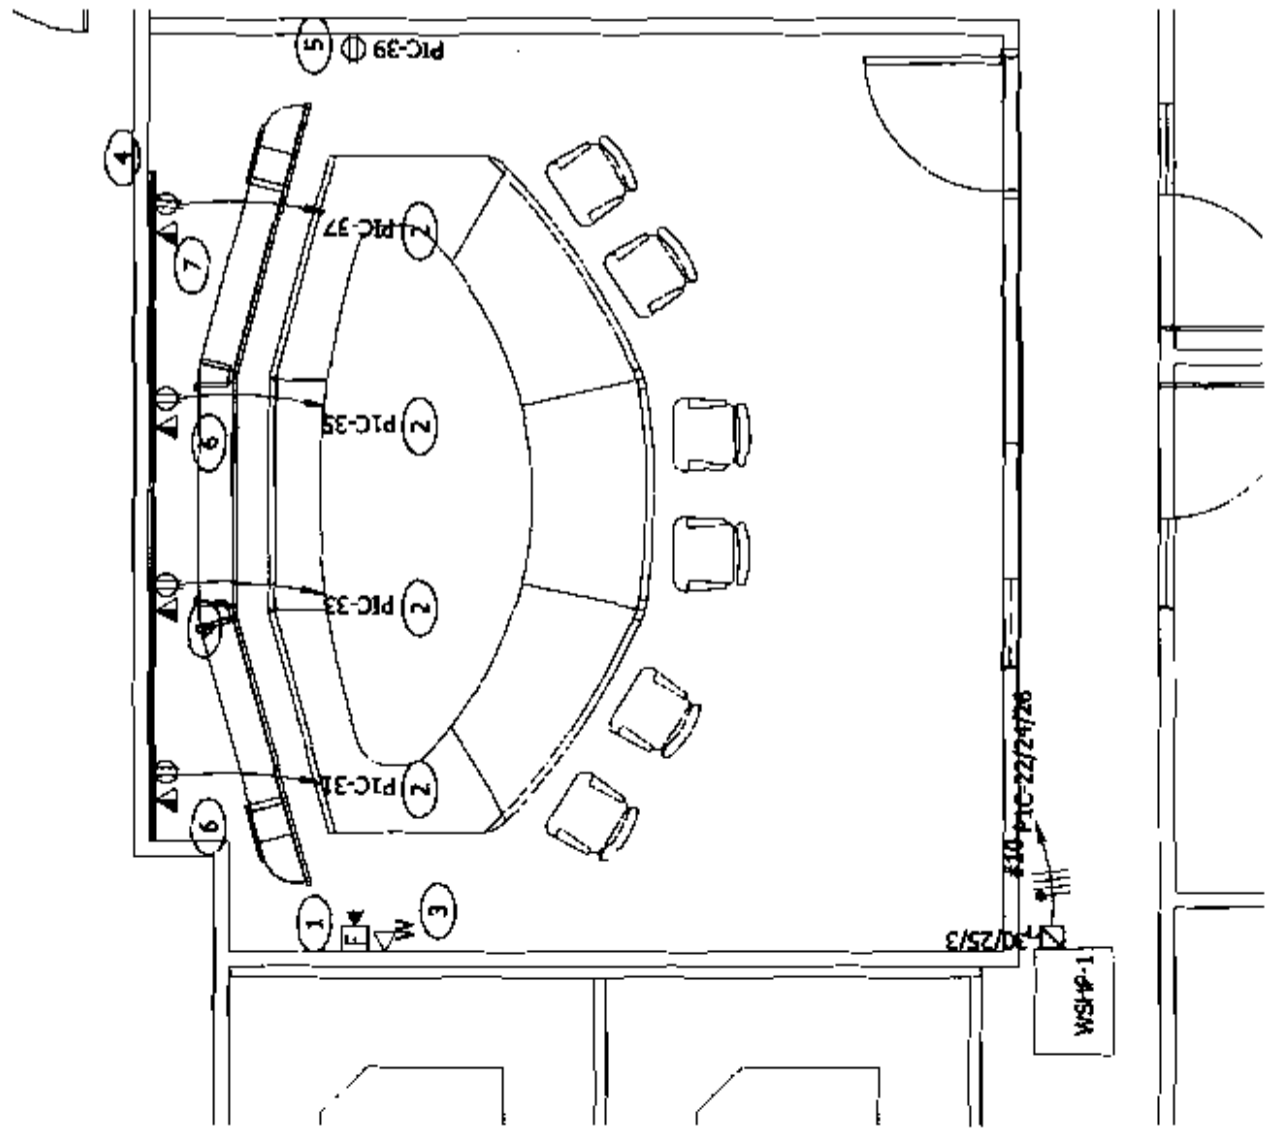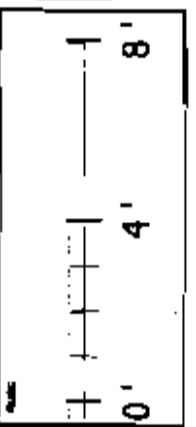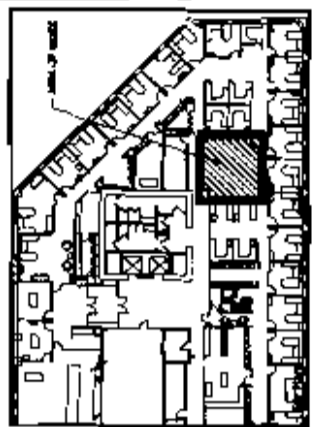

POWER/SYSTEM PLAN

1
E3-1
1/2"=1'-0"

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A licensed architect

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Contractor
SYSKA HENNESSY

Bank of America

Bank of America
Corporation

PROJECT FOR RISING AND RISING	DATE: 01/14/98
PREPARED BY: J. L. GIBSON	DATE: 01/14/98
CHECKED BY: J. L. GIBSON	DATE: 01/14/98
APPROVED BY: J. L. GIBSON	DATE: 01/14/98

TELEPRESENCE ROOM - ME1-504-02-6245

Page 02
100 Middle St.
Portland, ME 04101
Project no. 44-03-00

ELECTRICAL RISER AND PANEL SCHEDULE

Sheet Title

Drawn By: J. L. GIBSON

Checked By: J. L. GIBSON

Date: 01/14/98

E4-1

ALL DIMENSIONS AND CONDITIONS ARE TO BE VERIFIED BY THE CONTRACTOR AT THE SITE OF THE CONTRACT AND THE CONTRACTOR SHALL BE RESPONSIBLE FOR OBTAINING ALL NECESSARY PERMITS AND APPROVALS FROM THE LOCAL AUTHORITIES.

© 1998 NEILSON

EXISTING PANEL
RISER
2007/1/20/98
225'

3RD FLOOR

NOTE: ALL EQUIPMENT SCHEDULE IS EXISTING.

1 RISER DIAGRAM

SCALE: NONE

PANELBOARD NO: FIG 1
RISER DIAGRAM
DATE: 01/14/98
DRAWN BY: J. L. GIBSON
CHECKED BY: J. L. GIBSON
APPROVED BY: J. L. GIBSON

NO.	DESCRIPTION	TYPE	WIRE	TERMINAL	REMARKS
1	120V 15A	1	12	1	
2	120V 15A	1	12	1	
3	120V 15A	1	12	1	
4	120V 15A	1	12	1	
5	120V 15A	1	12	1	
6	120V 15A	1	12	1	
7	120V 15A	1	12	1	
8	120V 15A	1	12	1	
9	120V 15A	1	12	1	
10	120V 15A	1	12	1	
11	120V 15A	1	12	1	
12	120V 15A	1	12	1	
13	120V 15A	1	12	1	
14	120V 15A	1	12	1	
15	120V 15A	1	12	1	
16	120V 15A	1	12	1	
17	120V 15A	1	12	1	
18	120V 15A	1	12	1	
19	120V 15A	1	12	1	
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21	120V 15A	1	12	1	
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45	120V 15A	1	12	1	
46	120V 15A	1	12	1	
47	120V 15A	1	12	1	
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96	120V 15A	1	12	1	
97	120V 15A	1	12	1	
98	120V 15A	1	12	1	
99	120V 15A	1	12	1	
100	120V 15A	1	12	1	

PANELBOARD NO: FIG 1
RISER DIAGRAM
DATE: 01/14/98
DRAWN BY: J. L. GIBSON
CHECKED BY: J. L. GIBSON
APPROVED BY: J. L. GIBSON

2 PANEL SCHEDULE

SCALE: NONE