




## $2 \frac{\text{PARTIAL RAMP PLAN}}{3/8" = 1'-0"}$

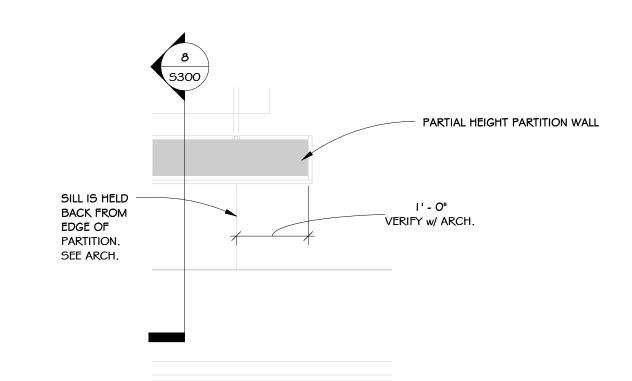

3 PARTIAL WALL FRAMING PLAN

3/4" = 1'-0"

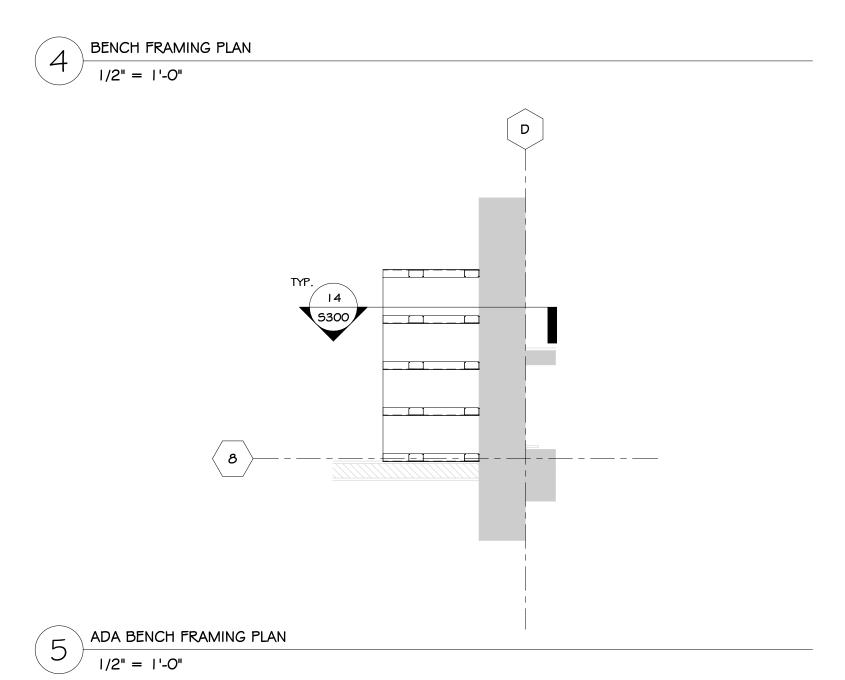

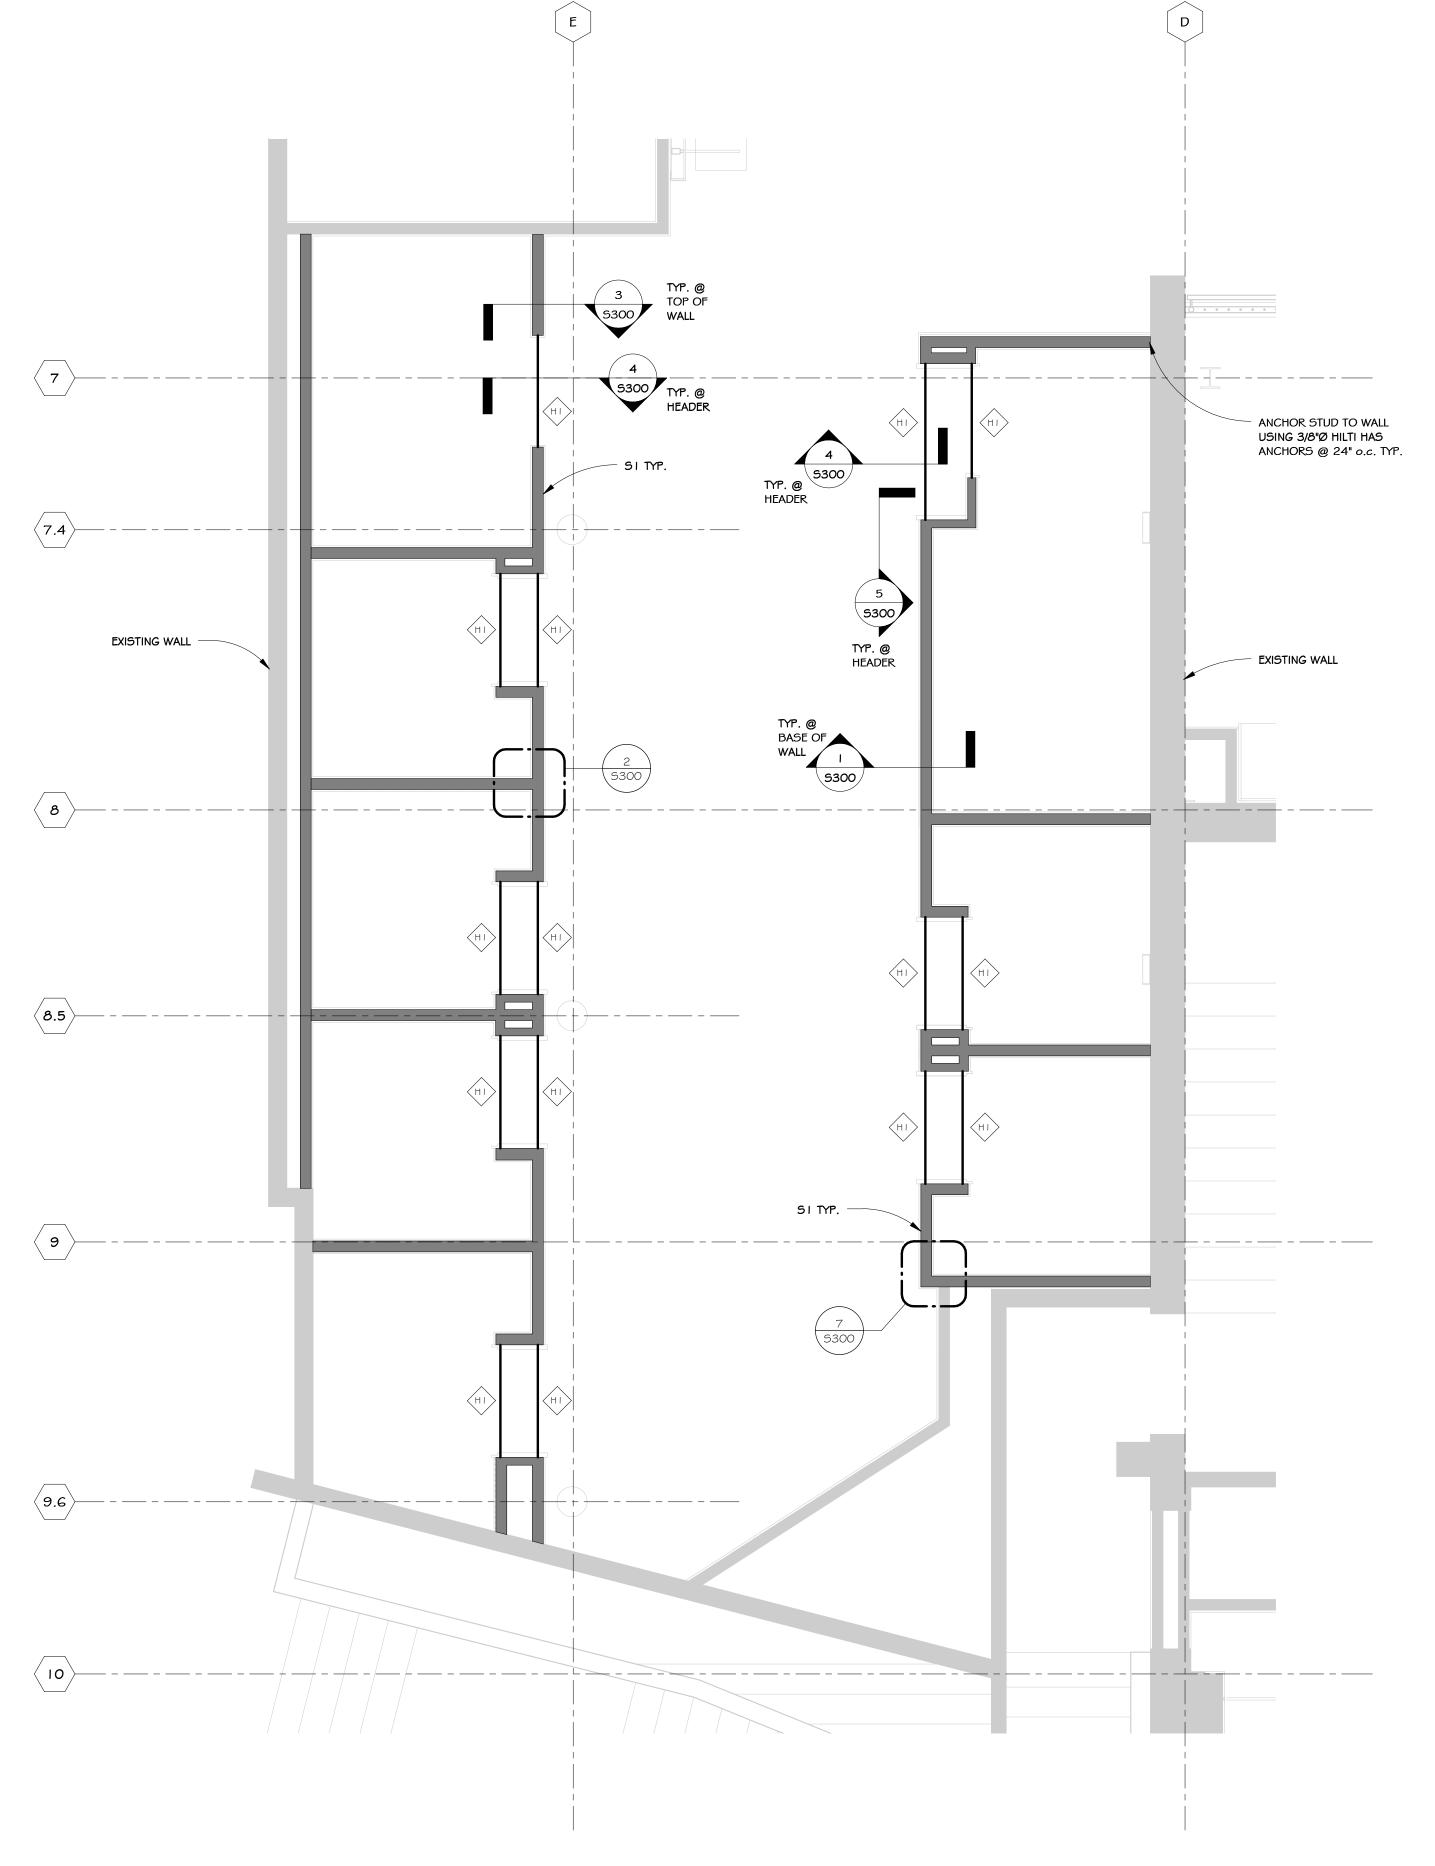

LIGHT GAGE HEADER SCHEDULE

SCREW MEMBERS TOGETHER  $w\!/\!\!/$  # 1 O TEK SCREWS @ 6" o.c. SEE 4-6/S300 FOR ADDITIONAL INFORMATION.

HEADER TYPE

(2) 6005 | 62-33 (20 GAGE)


## PARTIAL WALL FRAMING PLAN

## PLAN NOTES:

- I. "SI" DENOTES LIGHT- GAGE WALL. SEE SCHEDULE ON THIS SHEET.
- DENOTES BUILT-UP LIGHT-GAGE HEADER, SEE SCHEDULE ON THIS SHEET.
- VERIFY ALL DIMENSIONS W ARCH.

	WALL TYPES		
IARK	STUD TYPE	SPACING	MAX. WALL HEIGHT
31	3625   62-33 STEEL STUDS (20 GAGE)	16" o.c.	NA
52	6005   62-33 STEEL STUDS (20 GAGE)	16" o.c.	NA
	TRACK SECTIONS.  FASTEN GYP. BOARD SHEATHING TO STUDS w/ #6x   1/4" GYP.		
2.	FASTEN GYP. BOARD SHEATHING TO STUDS w/ #6x I 1/4" GYP.		
3.	COORDINATE WALL TYPES w/ ARCH.		
<b>1</b> .	SEE ARCH. DRAWINGS FOR STUD WALL SI IS NOT CONTINUOUS BOTH SIDES FOR FL CONTINUOUS 16 GA. HORIZ. BRIDGING @ BRIDGING TO STUDS WITH 16 GA. CLIP AI TO STUDS AND BRIDGING.	JLL HEIGHT O 24" o.c. VE	F WALL PROVIDE RT. ANCHOR

ENGINEER/SEAL:

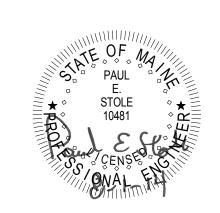

NewStudic Architecture

4431 Lake Avenue South
White Bear Lake, MN 55110

p: 651.207.5527 f : 651.207.8247 **NSA PROJECT NUMBER: 2013-99** 

ANTHROPOLOGIE

60 Pearl Street
Portland, ME 04101

STRUCTURAL ENGINEER:



7212 Metro Blvd
Edina, MN 55439
(952) 854-9302 tel
(952) 854-9690 fax
www.astmn.com

© PROPERTY OF ADVANCED STRUCTURAL TECHNOLOGIES.
THIS DOCUMENT MAY NOT BE USED OR COPIED WITHOUT
THE PRIOR WRITTEN CONSENT OF ADVANCED
STRUCTURAL TECHNOLOGIES.

DRAWN BY:AJM CHECKED BY: DCB

AST PROJECT NUMBER: ME 1001

07-11-2014

08-01-2014

PROJECT PHASE: <u>CD</u>

ISSUE / DATE:

100% CHECK SET

REVISION :

SHEET TITLE:
PARTIAL FRAMING
PLANS

SHEET NO:
S110