EXIT SIGN EXIT SIGN

Code Summary	Portland Food Co-op	
Project address:	290 Congress Street, Portland ME	
Project type:	Existing space fit out for retail grocery	
Square Foot	4,815 sf +/-	
Building code:	City of Portland IBC 2009	
	NFPA 101	
	Maine Human Rights Commission	
IBC		CODE REF.
Occupancy Type	M (Mercantile)	309.1
Occupant Load - Basement & Grade	3,278/30 gross = 109	1004.1.1
Occupant Load - Storage, Stockroom	1,300/300 gross = 4	
Occupant Load - Commercial Kitchen	237/200 gross = 1	
Occupant Load TOTAL Y Y Y Y	114 * * * * * * * * * * * * * * * * * *	· · · · γ
Construction Type	Type VB	\ >
Allowable Stories, Area	(Mercantile) Stories: 1, Area: 9,000	Table 503
Allow Area Increase	27,000 sf (increase by 300% b/c sprinklered)	506.3
Req'd Separation of Occupancies	Business/Mercantile to Business Mercantile: None	T508.4
		Y
Minimum # Exits	2 (under 501 occ.); for Assembly or Mercantile	T1021.1
Egress Width	.2(118) = 23.6", min. 44"	1105.1
Egress Door	Min. 32" clear	1008.1.1
Power-operated doors	Shall be capable of operating manually in emergency	1008.1.4.2
Door arrangement	48" min. betw. 2 doors + width of door swinging into space.	1008.1.8
<u> </u>	Swing in same direction or both away from space betw.	
	Horiz. Sliding power operated doors: min. 48" apart	
Common Path of Egress Travel	Not to exceed 75'-0"	1014.3
Exit Through Intervening Spaces	Not through kitchens or storage rooms	1014.2.4
	Stockroom ok in Use M	1014.2.4 exc. 2
Exit passageway	44" (if greater than 50 occupants)	1023.2
Exit Access Travel Dist	250' (with sprinkler from farthest point to exit)	1016.1
Minimum # Exits	2 (under 501 occ.); for Assembly or Mercantile	1014.1
Distance betw. Exits	IF SPRINKLER, doors not less than 1/3 of overall diagonal	1015.2.1.2
Aisles (Mercantile)	M: Not less than 36"	1017.2
· ····································	Non accessible aisle: 30" min. clear width	1017.3
Aisle Accessway (Mercantile)	M: At least 1 side of ea. Element in merchandise pod	1017.3
Common Path of Travel (Mercantile)	M: 30'-0" max from any point in merchandise pod	
	y	······································
Exit Discharge (Vestibule)	Max. 50% f exit enclosure permitted through vestibule.	1027.1.2
<u> </u>	Depth not > than 10'-0", length not > than 30'-0"	1027.1.2-2.2
^	Sap/from bidg/ng/negativ/af/appraved vince/alass in steal frapries/	1027/12/23/
Interior Wall & Ceiling Finishes	Class B (exit enclosures, passageways) & Class C (corridors, rooms,	T-803.9
-	enclosed spaces)	

UPC (Uniform Plumbing (Code)	· · · · · · · · · · · · · · · · · · ·	CODE	REF.	ン
D-1	W:	and an artist the Duilding Code!	T4 1 T		>
Determine Occupancy Type:		cordance with the Building Code" male, 50% female	T4-1 I	ntro	
	3070	marcy 30 % remarc	<u> </u>		
IBC Mercantile Occupancy:	114:	57 male, 57 female	-		7
Closest Match to Mercantile:	Potai	or Wholesale Stores	T4-1		>
Plumbing Fixture Count:				T4-1	
	w.c.: Female 2: 26-100 = 2				
		2 w.c. = 1 per each			7
	urinal: 1:26-100 = 1 drinking fountain: 1:31-150 = 1		-		>
	uiiik	ing foundam. 1.51 150 – 1	<u> </u>		5
Exception to Occupant Load:		e <i>approved</i> by the <i>building officia</i> l, the actual number of	IBC 10	004.1.1	
		pants for whom each occupied space, floor or building is			7
		nated, although less than those determined by calculation, shall rmitted to be used in the determination of the design <i>occupant</i>			>
	load.	Amiliated to be used in the determination of the design occupant			5
Design Occupant Load:	Employees: 5-7, estimated Customers: 40-45 estimated		By Arc		
	Cusic	inters. 40-43 estimated	,	tation with	>
Plumbing Fixtures to be provided:	w.c.:	Male = 1	buildin	ig official.	
	w.c.: Female = 1				
	lav: 1 per each drinking fountain: 0		T/1-1/1		
	GITTIN	ng rouncum. o		g official	>
			\bigvee	$\wedge \wedge \wedge \wedge$	<u> </u>
NFPA				CODE REF.	
Oscupancy Type		Mercanctile Class B		6 1 10	
Occupancy Type Subclassification		Class B (3,000 - 30,000 sf, under 3 floors)	6.1.10 36.1.4.2.1		
Subclassification		Class B (3,000 - 30,000 si, dilder 3 1100is)		30.1.4.2.1	
Occupancy Load: M Sales Area on Street		3.278/30 gross = 109		T-7.3.1.2	
		1,300/300 gross = 4		"	
Occupancy Load: Kitchen		237/100 gross = 2			
Occupant Load TOTAL		114			
N					
Number of Exits		2 min.		7.4.1.1., 36.2.3.1 T-7.3.3.1	
Egress Capacity: Level Components		.2"/person (115x.2=23") .3"/person (115x.3=34.5")		1-7.3.3.1	
Egress Capacity:Stairs Min. Door Width		32"		7.2.1.2.4	
Min. Corridor Width		36"		7.3.4.1	
Dead End Corridors		50'-0" max if sprinklered		36.2.5.1	
Common Path of Travel				26 2 5 2	
COLUMNO PATO OF ITAVAL		100'-0" if low hazard, sprinkler throughout		36.2.5.3	
Common rath of flaver				:	
		Not less than required width of exit, or 36" min		36.2.5.4	
Aisles Required Sep. btw. same occupar		Not less than required width of exit, or 36" min 0 Hour		36.2.5.4 T-6.1.14.4.1	1(b)

0 Hour/Not required if sprinklered throughout

locking, 44" main aisle, direct unobstructed

250'-0" if low hazard and sprinkler throughout

Class A or Class B (Comply with NFPA Sec.10.2)

accommodate 50% egress

If customer access only through 1 ext wall, must

Permitted through storerooms for 50% of egress, no

NOTE: ENTIRE TENANCY TO BE HAVE NFPA COMPLIANT SPRINKLER SYSTEM PROVIDED BY DEAN & ALLYN OF GRAY, MAINE.

KAPLAN THOMPSON

Corridor/Use Area Separation

Means of Egress

Travel Distance to Exits

Hood Vents comply with NFPA 96

ARCHITECTS 424 FORE ST., PORTLAND, ME 04101 207-842-2888 FAX:842-2828





36.3.6.1 (exc. 3)

36.2.5.7

36.2.5.11

36.2.6.2

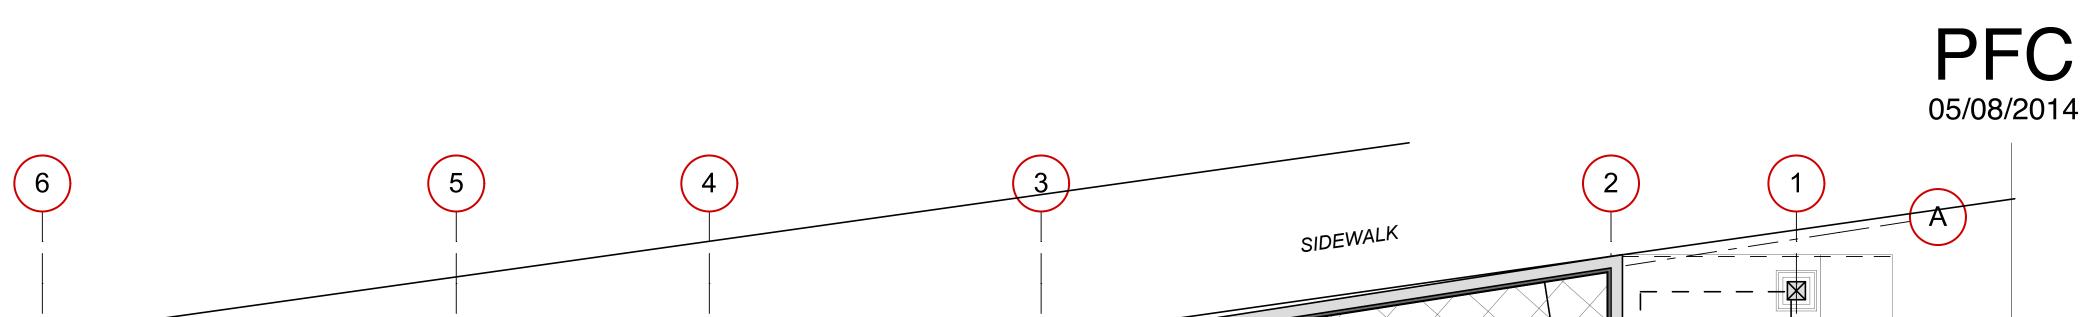


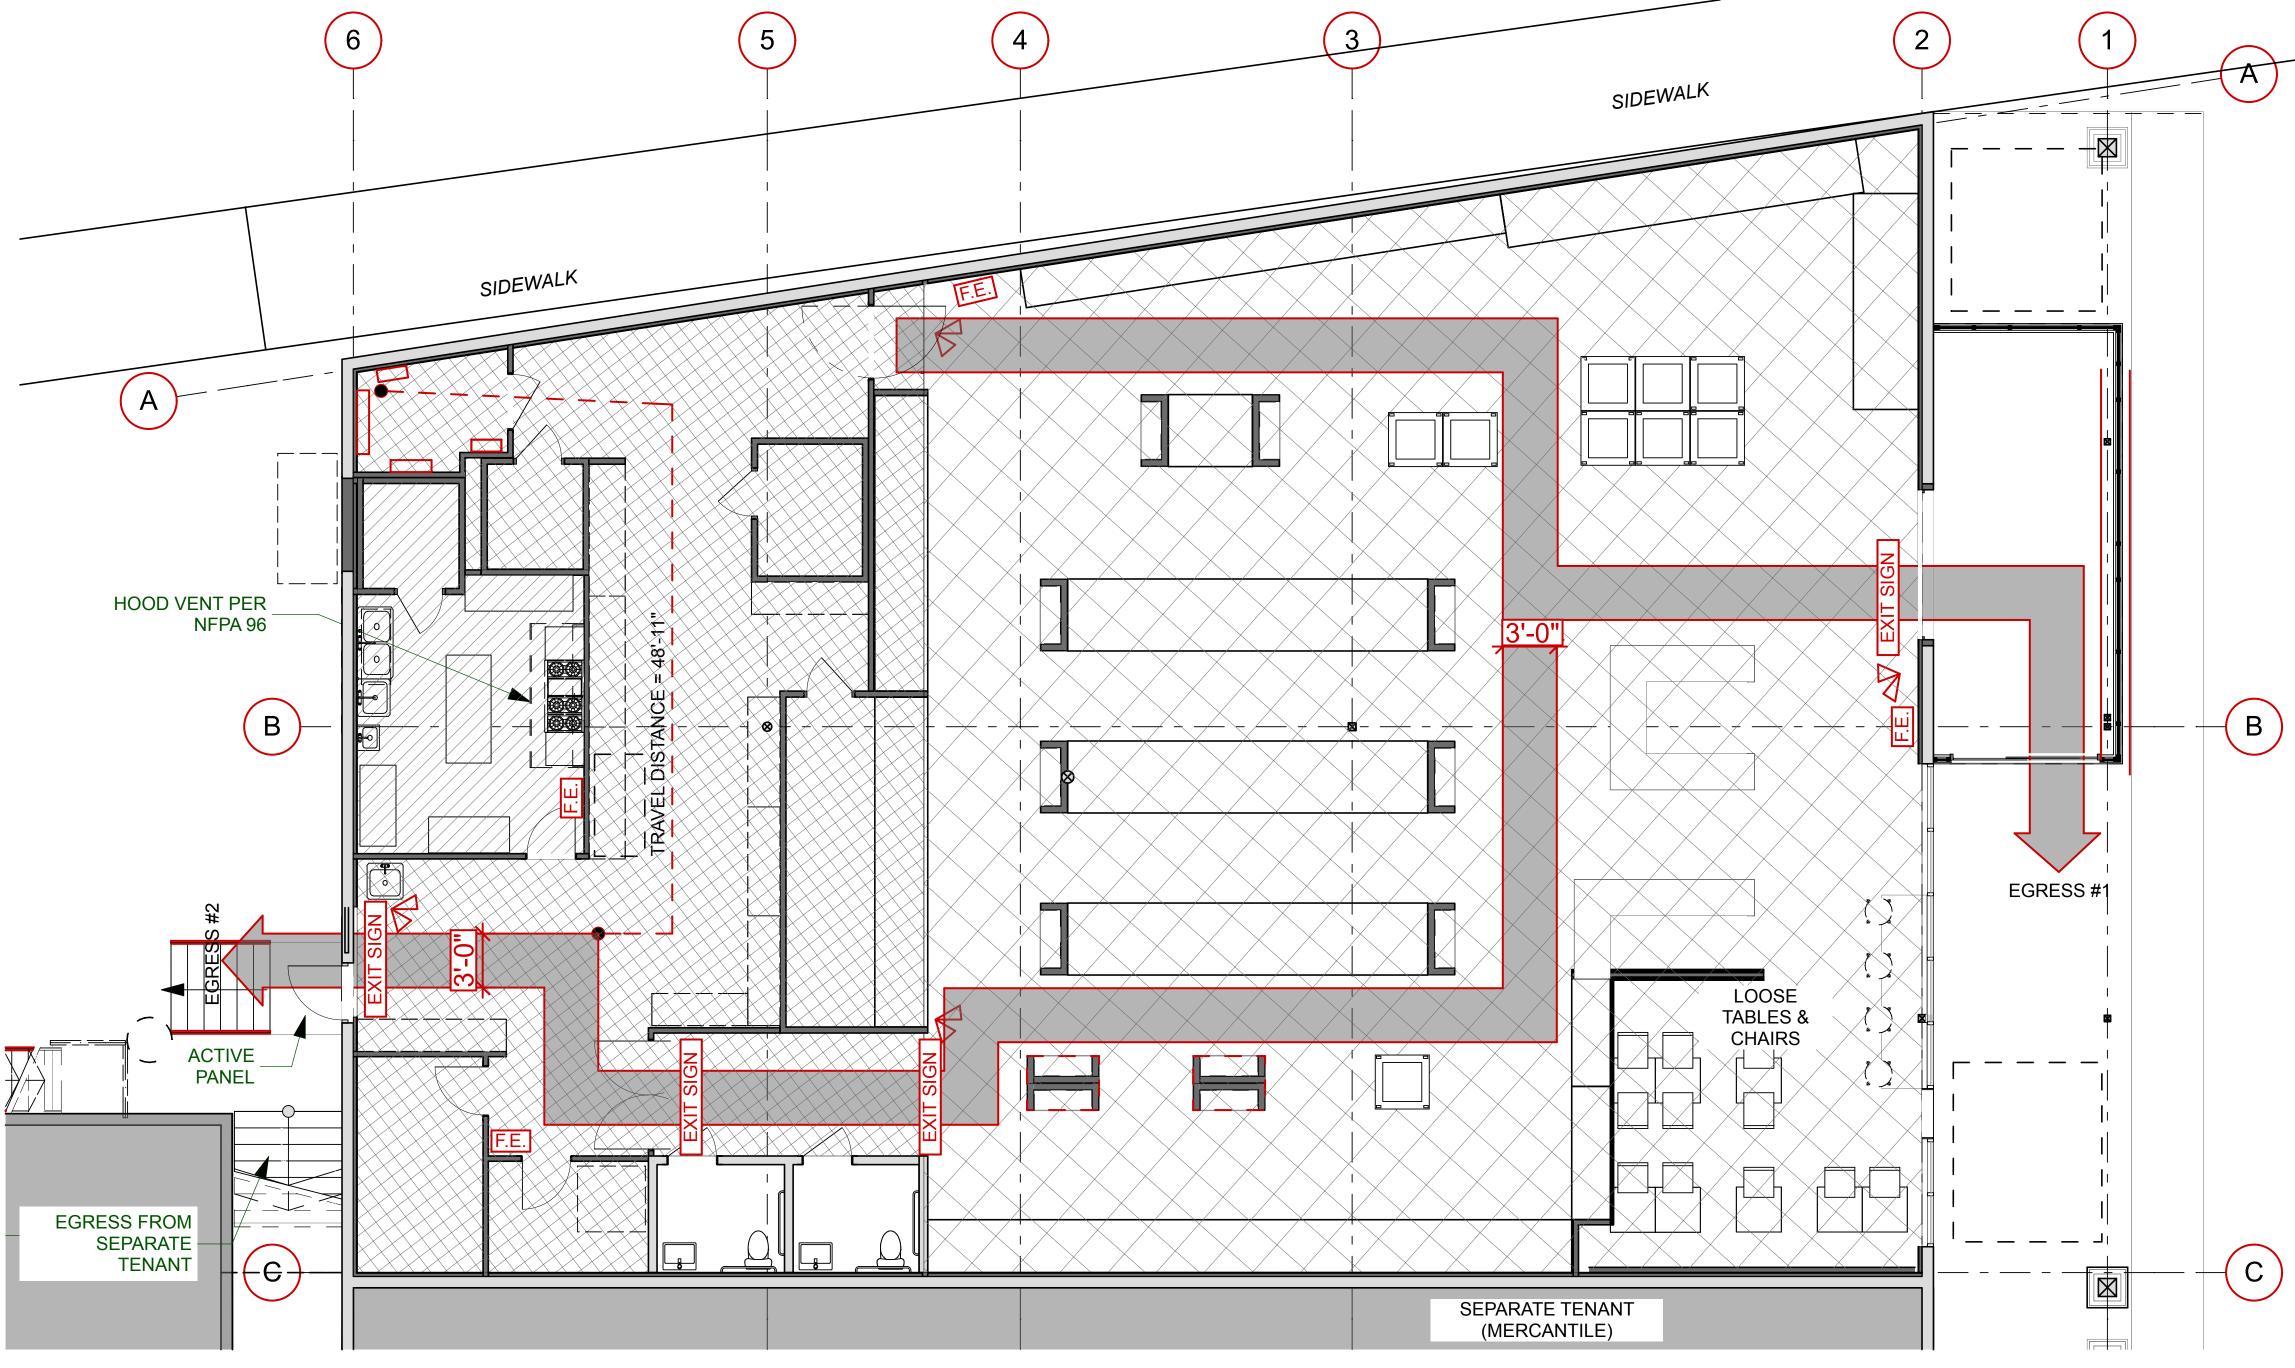

SUSPENDED FROM CEILING, TYP.

– 5/8" GWB EA. SIDE, TYP.


OCCUPANCY & LIFE SAFETY

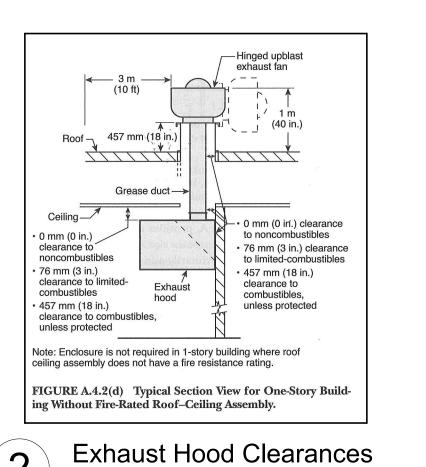

- 5/8" GWB EA. SIDE, TYP. MTL STUD WALL TO 8'-0", BRACED TO STRUCTURE BRACED TO STRUCTURE 3 Typical Int Partition Wall SCALE: 1 1/2"= 1'-0" Typical Int Partition Wall

SCALE: 1 1/2"= 1'-0"

- 5/8" GWD CLG. ON MTL. JOISTS

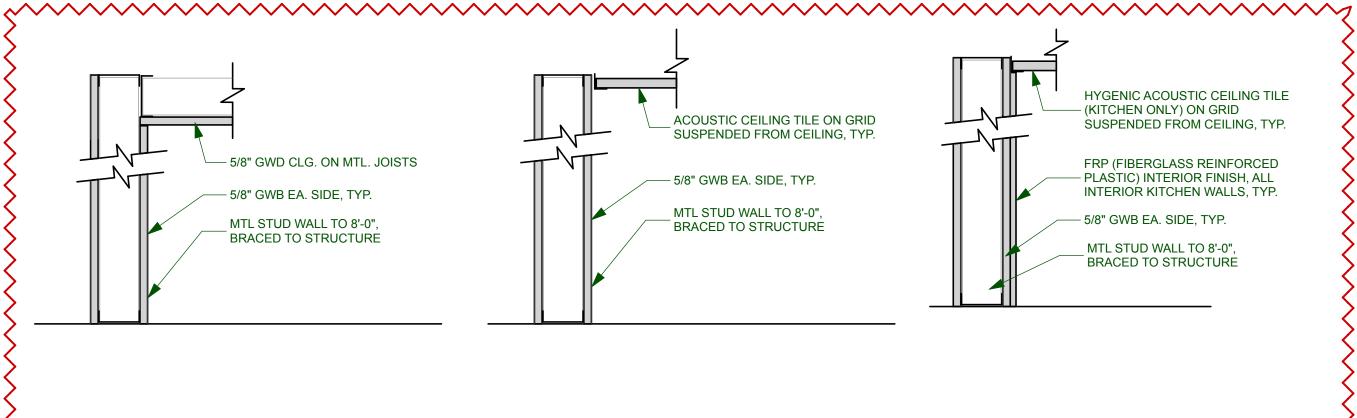

SCALE: 1 1/2"= 1'-0"

Typical Int Kitchen Wall

TOTAL SF = 4,815 SF MERCANTILE, GRADE 1:30 GROSS 3,278 SF/30 **= 109** MERCANTILE, STOCKROOM 1:300 GROSS 1,300 SF/30 **= 4** COMMERCIAL KITCHEN 1:200 GROSS 237 SF/200 **= 1 TOTAL OCCUPANCY = 114**

PERMIT APPLICATION 5.8.2014

PORTLAND FOOD CO-OP 290 CONGRESS ST

PORTLAND, MAINE

DRAWING: LIFE SAFETY PLANS Scale: As Noted DRAWN BY: RZT REVISED: May 8, 2014 May 8, 2014