


Mar 25, 2016 - 11:45am
 T:\02 Projects - Name\4001-4100\407110 Asylum Expansion 4 Renovation 5D-CAD2 Design\Drawings\Site\407110-SP101.dwg JobyRichards


- GRADING NOTES:**
- SEE NOTES G1 THROUGH G8 ON SHEET C-001 FOR ADDITIONAL GRADING INFORMATION.
 - PROPOSED GRADING SHOWN ON THIS PLAN IS BASED ON A TOPOGRAPHIC SURVEY PREPARED OWEN HASKELL INC. LAND SURVEYORS.
 - TEST PIT LOCATION AND INFORMATION PROVIDED BY S.W. COLE ENGINEERING INC.

- UTILITY NOTES:**
- SEE NOTES E1 THROUGH U8 ON SHEET C-001 FOR ADDITIONAL UTILITY INFORMATION.
 - SITE CONTRACTOR TO FIELD VERIFY ALL EXISTING UTILITIES PRIOR TO BEGINNING ANY PROPOSED WORK.
 - PROVIDE 4" MIN. RIGID INSULATION BETWEEN WATER LINE AND SANITARY SEWER LINE. EXTEND 8' IN ALL DIRECTIONS WHERE THEY CROSS.
 - DOMESTIC WATER DISTRIBUTION AND FIRE SUPPRESSION PIPING AND APPURTENANCES SHALL BE SUPPLIED AND INSTALLED BY SITE CONTRACTOR. ALL EXCAVATION AND BACKFILL REQUIRED FOR ANY PART OF THE WATER SUPPLY SYSTEM AND FIRE SUPPRESSION PIPING SHALL BE BY THE SITE CONTRACTOR. COORDINATE INSTALLATION OF PIPING WITH THE PLUMBING AND MECHANICAL CONTRACTORS. PIPING FOR NEW BUILDING SHALL BE SUPPLIED AND INSTALLED BY THE PLUMBING CONTRACTOR FROM THE BUILDING TO A COORDINATED POINT LOCATED 10' FROM THE BUILDING PENETRATION.

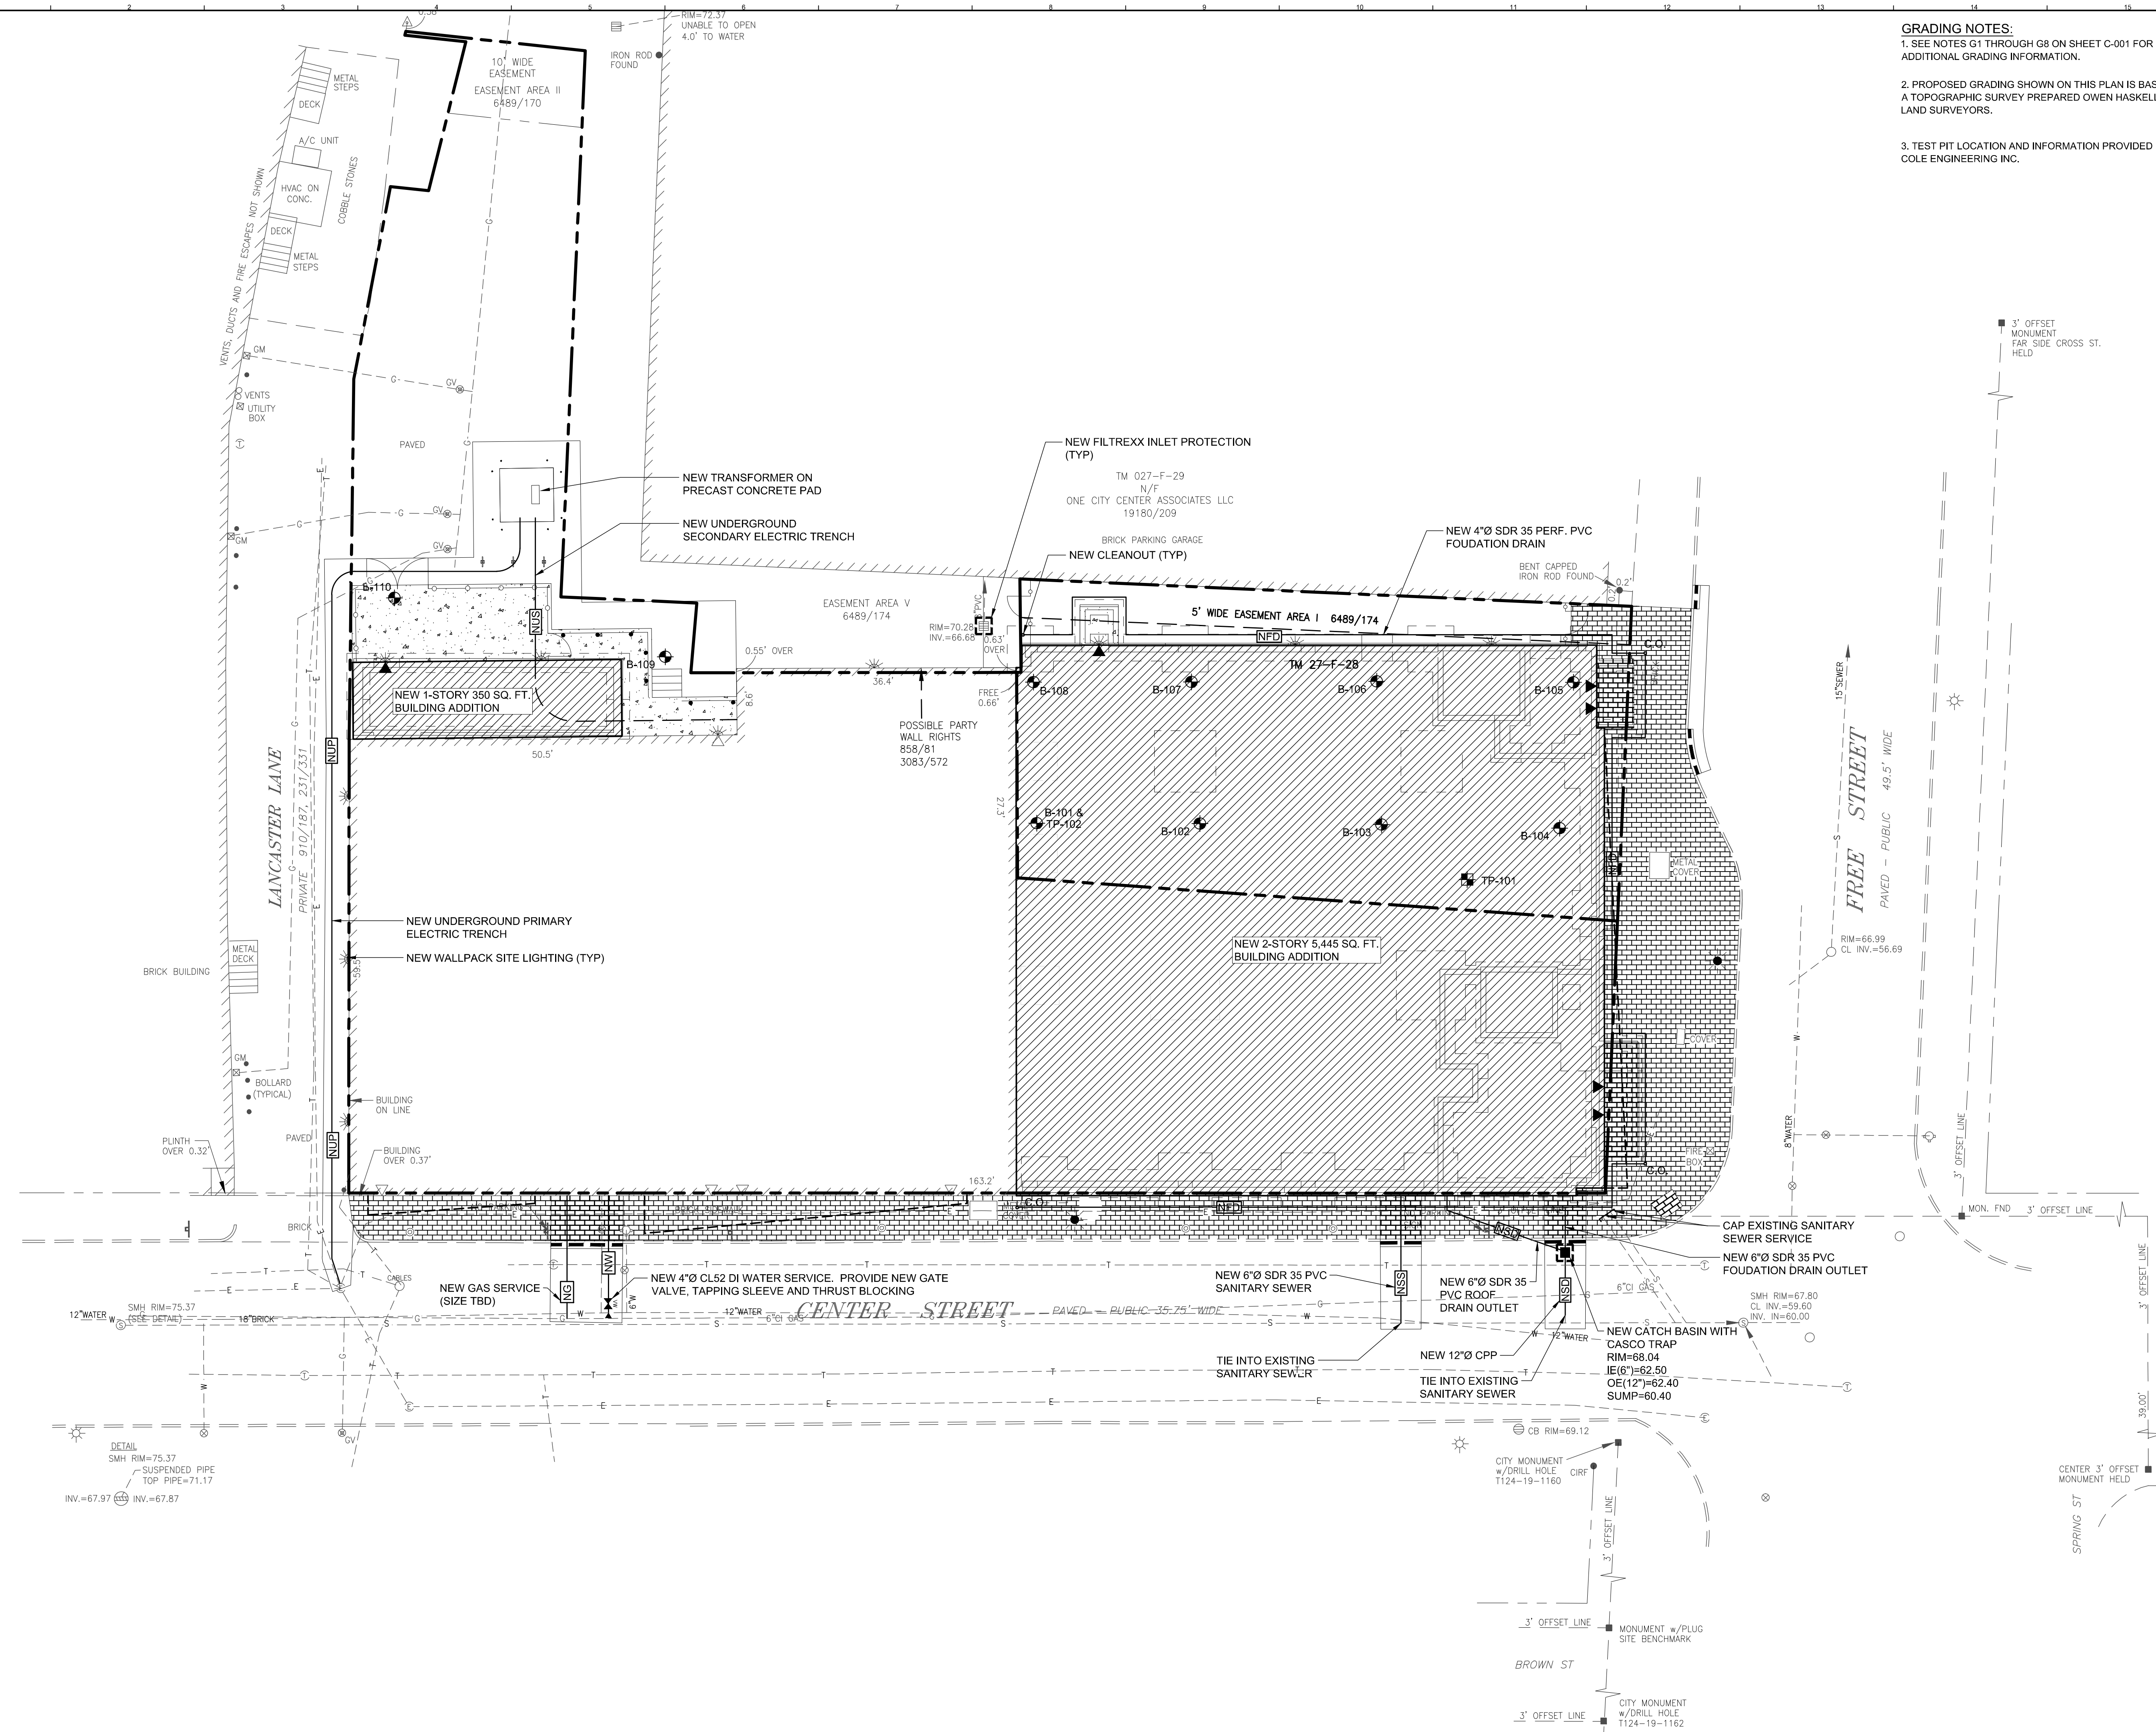

EXISTING	LEGEND	PROPOSED
☼	BUILDING LIGHTING	☼
☼	STREET LIGHTING	☼
●	BOLLARD	●
⊕	WATER SHUTOFF / GATE VALVE	⊕
⊕	PARKING METER	⊕
⊕	GAS VALVE	⊕
□	TRANSFORMER PAD	□
○	MANHOLE	○
○	SEWER MANHOLE	○
○	CATCH BASIN	○
○	FIRE HYDRANT	○
⊕	SIGN	⊕
⊕	FENCING	⊕
⊕	GUARD RAIL	⊕
⊕	PAVEMENT	⊕
⊕	SIDEWALK	⊕
⊕	GRANITE CURB	⊕
---	GAS SERVICE / MAIN	---
---	WATER SERVICE / MAIN	---
---	STORM DRAIN	---
---	FOOTING DRAIN	---
---	CLEANOUT	---
---	SANITARY SEWER	---
---	UNDERGROUND ELECTRIC	---
---	UNDERGROUND SECONDARY	---
---	UNDERGROUND PRIMARY	---
---	PROPERTY SETBACK	---
---	PROPERTY LINE	---
---	ABUTTING PROPERTY LINE	---

0	DD SUBMISSION	25 MAR 2016
REV.	DESCRIPTION	DATE

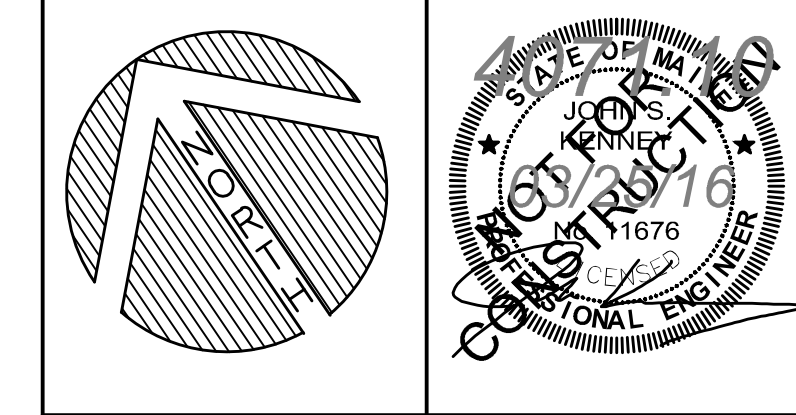

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 SARASOTA, FLORIDA 941-373-1383

ASYLUM

PROJECT: PORTLAND, MAINE

SITE GRADING EROSION CONTROL & UTILITY PLAN

SHEET TITLE:

WBRC CAD FILE: 407110-SP101.DWG

PROJECT No: 4071.10 GRAPHIC SCALE: 0' 1'

SCALE: 1"=10'

PM: JRB SHEET No:

DRAWN BY: JWB

AE OF RECORD: JSK

CG101