


DESIGN 8" CFM RAFTERS FOR 120 PSF ROOF SNOW LOAD AND 15 PSF DEAD LOAD


(2) COOLER COMPRESSORS ON WOOD SLEEPERS, 250-LBS EACH

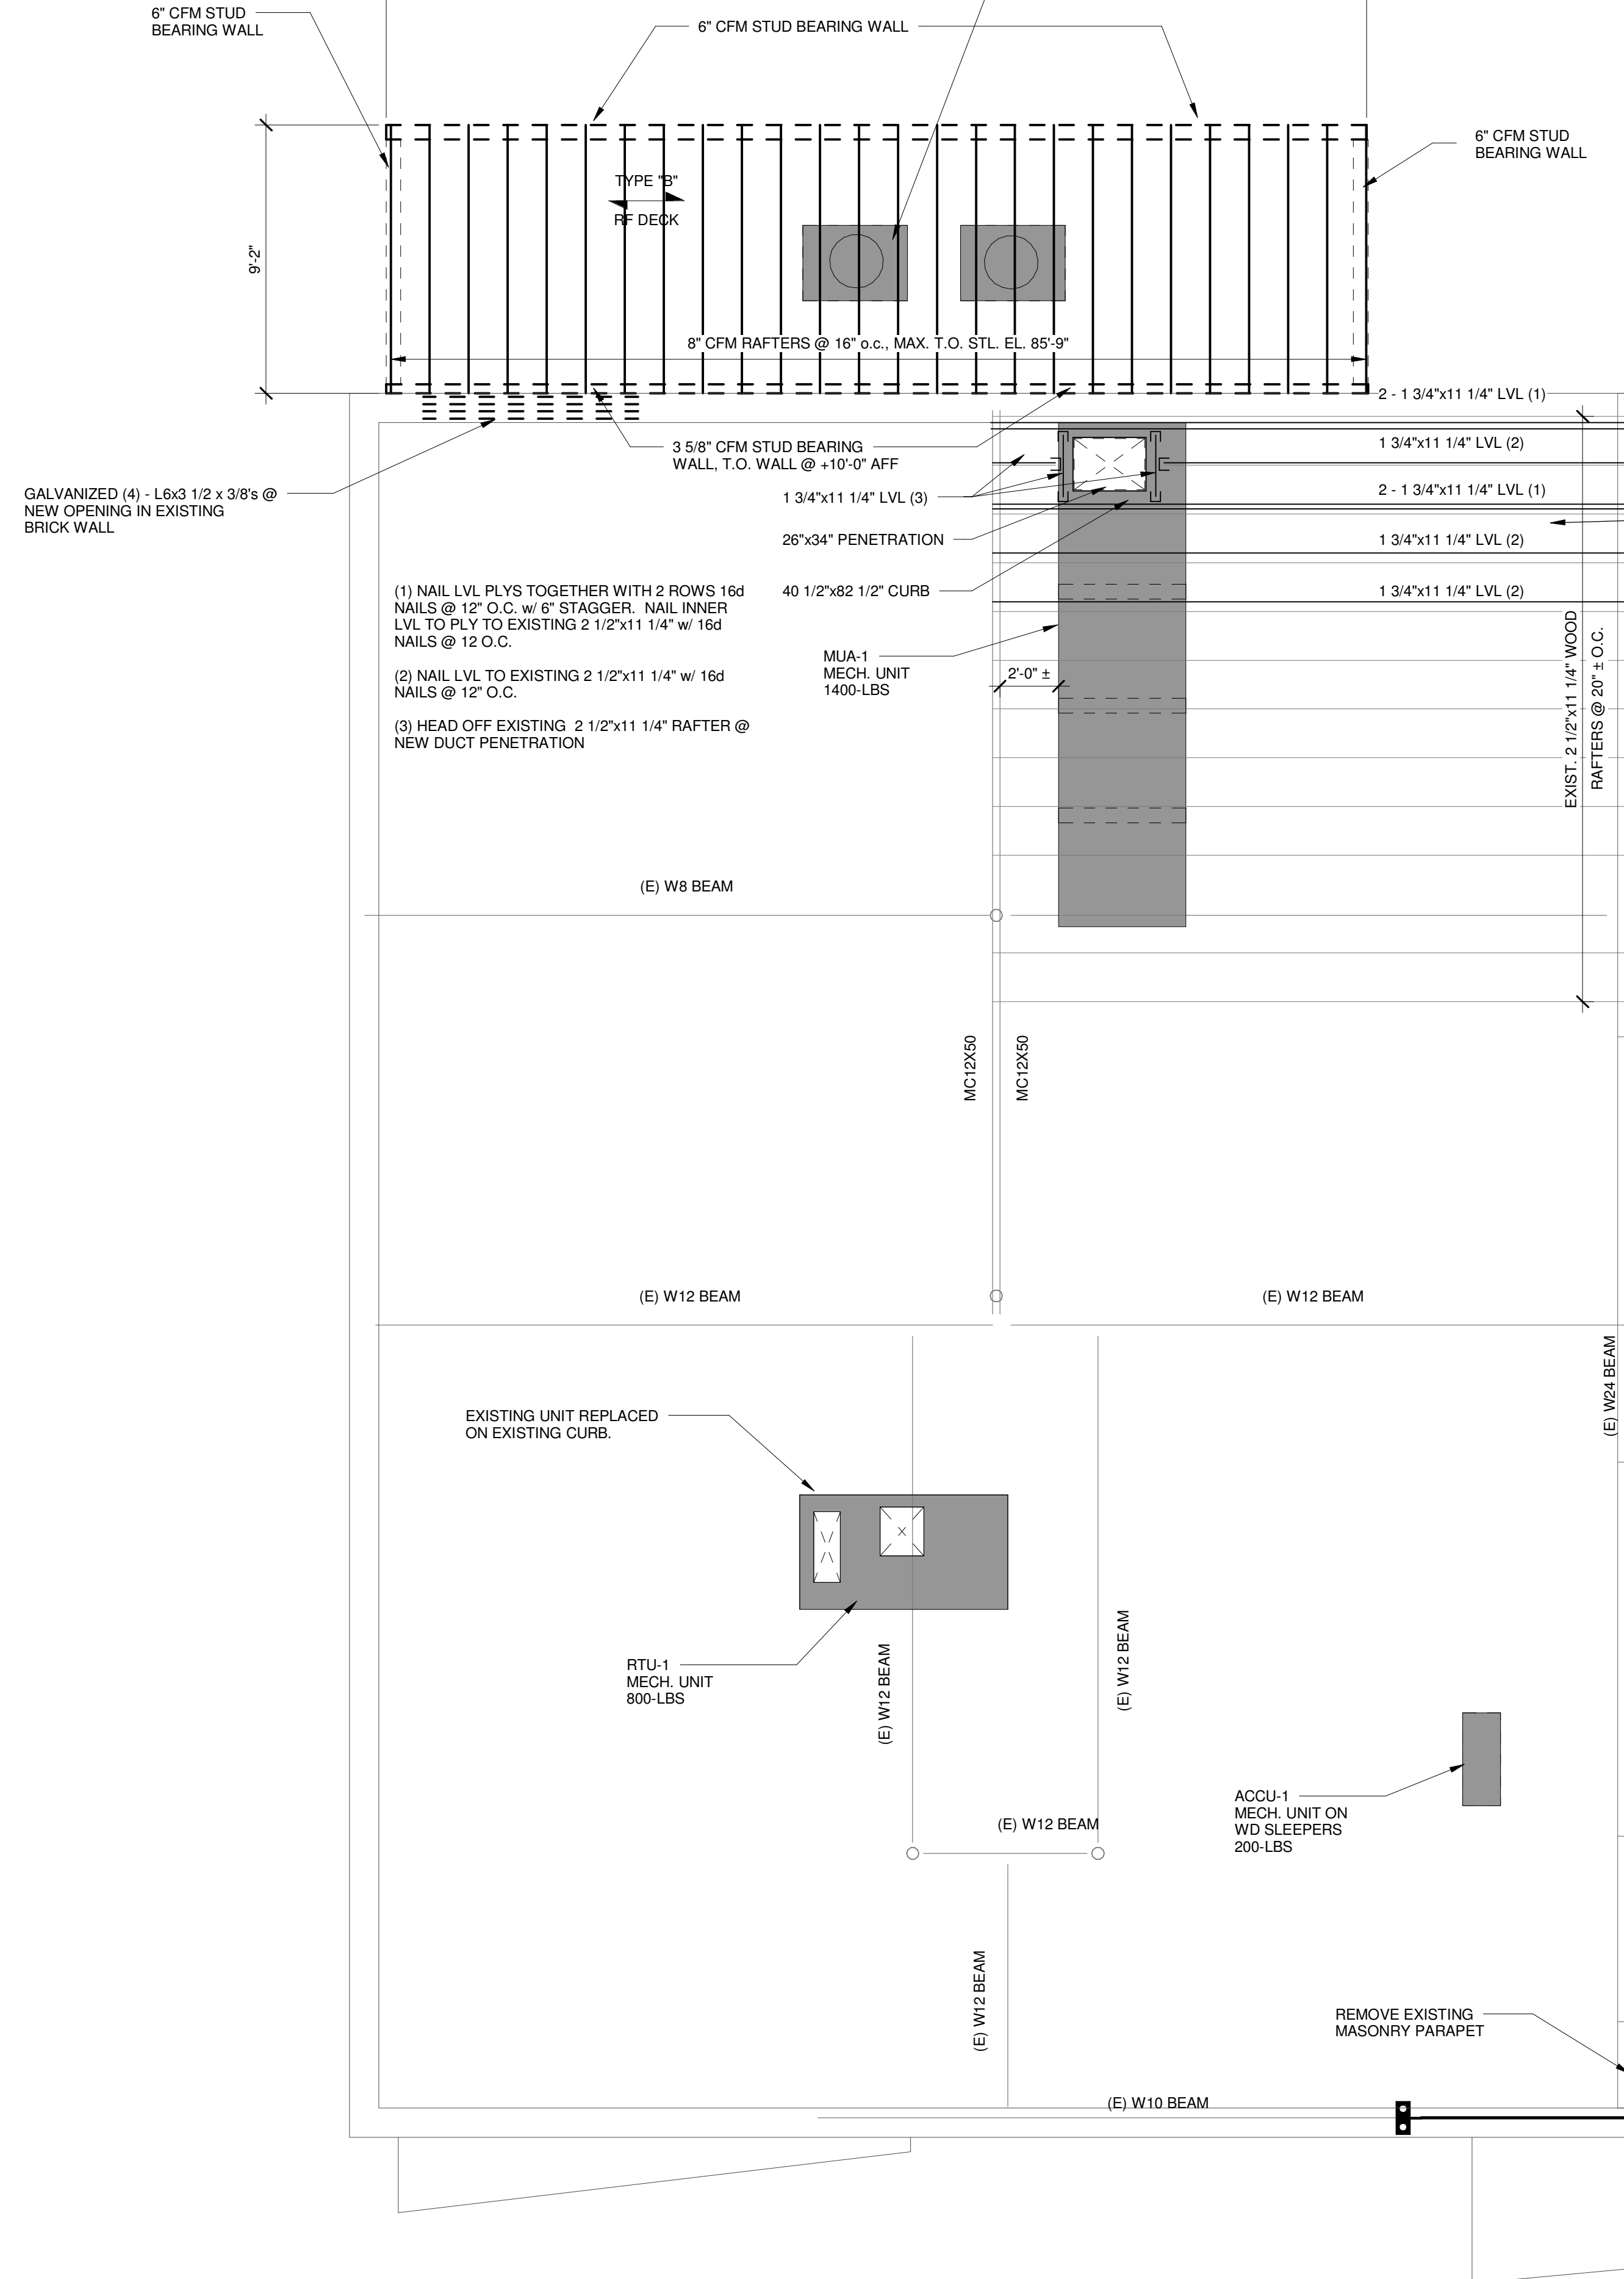

EXISTING ROOF OVERBUILD FRAMING PLAN NOTES:

- TOP OF STEEL = UNDERSIDE OF DECK
FIELD VERIFY ALL EXISTING TOP OF STEEL ELEVATIONS
T.O.S. @ EXISTING ROOF OVERBUILD = EL. 88'-10" +/-
- SPAN DIRECTION OF METAL DECK CONSTRUCTION INDICATED AS FOLLOWS:
TYPE "B" 18 GAGE 1.5" DEEP (TYPE "B") METAL ROOF DECK
RF DECK
- SPECIAL CONNECTIONS INDICATED AS FOLLOWS:
3.1 CANTILEVER BEAM SPLICE CONNECTION. SEE TYPICAL DETAIL.
3.2 INDICATES STEEL BEAM BEARING PLATE CONNECTION TO CONCRETE MASONRY WALL. SEE TYPICAL DETAIL.
- +ANGLE INDICATES CONT. L5x3-1/2x5/16 (LLH) SHOP WELDED TO BEAM FOR WALL ANCHORAGE, U.N.O. IN SECTIONS
+PLATE INDICATES FLAT OR BENT PLATE SHOP WELDED TO BEAM OR GIRT FOR ROOF EDGE OR EXTERIOR WALL SUPPORT. SEE SECTIONS FOR MORE INFORMATION
- ALL DECK OPENINGS MAY NOT BE SHOWN. REINFORCEMENT IS REQUIRED AT ALL METAL DECK PENETRATIONS AND MAY BE FITTED IN THE FIELD PER TYPICAL DETAILS. GC SHALL COORDINATE ALL PENETRATIONS WITH STRUCTURAL, STEEL AND METAL DECK SHOP DRAWINGS FOR APPROVAL. CONTRACTOR SHALL REFER TO ARCH. AND MEP DRAWINGS FOR SCOPE (INCL. SIZES, LOCATIONS, QUANTITIES) AND INCLUDE THIS WORK IN THEIR BASE BID.

KEYPLAN

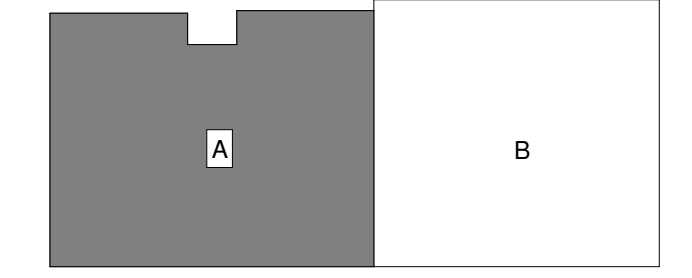

0	ISSUED FOR BID	06 JUNE 2016
REV.	DESCRIPTION	DATE

PROJECT NORTH

WBRC
ARCHITECTS • ENGINEERS
WWW.WBRCAE.COM
BANGOR, MAINE 207-947-4511
PORTLAND, MAINE 207-838-4511
SARASOTA, FLORIDA 941-556-0757

ASYLUM
EXISTING ROOF FRAMING PLAN - SEG A

SHEET TITLE		GRAPHIC SCALE 0" 1"
WBRC CAD FILE: C:\Users\jpc\Documents\407110 - ASYLUM DANCE CLUB - STRUCT_3060.dwg	PROJECT No: 4071.10	
SCALE: As indicated	PROJECT MANAGER: JRB	SHEET No: S-103A
DRAWN BY: ADG/RAD/JHW	CHECKED BY: JPC	