


K1 SPORTS BAR CANOPY FRAMING PLAN
1/4" = 1'-0"

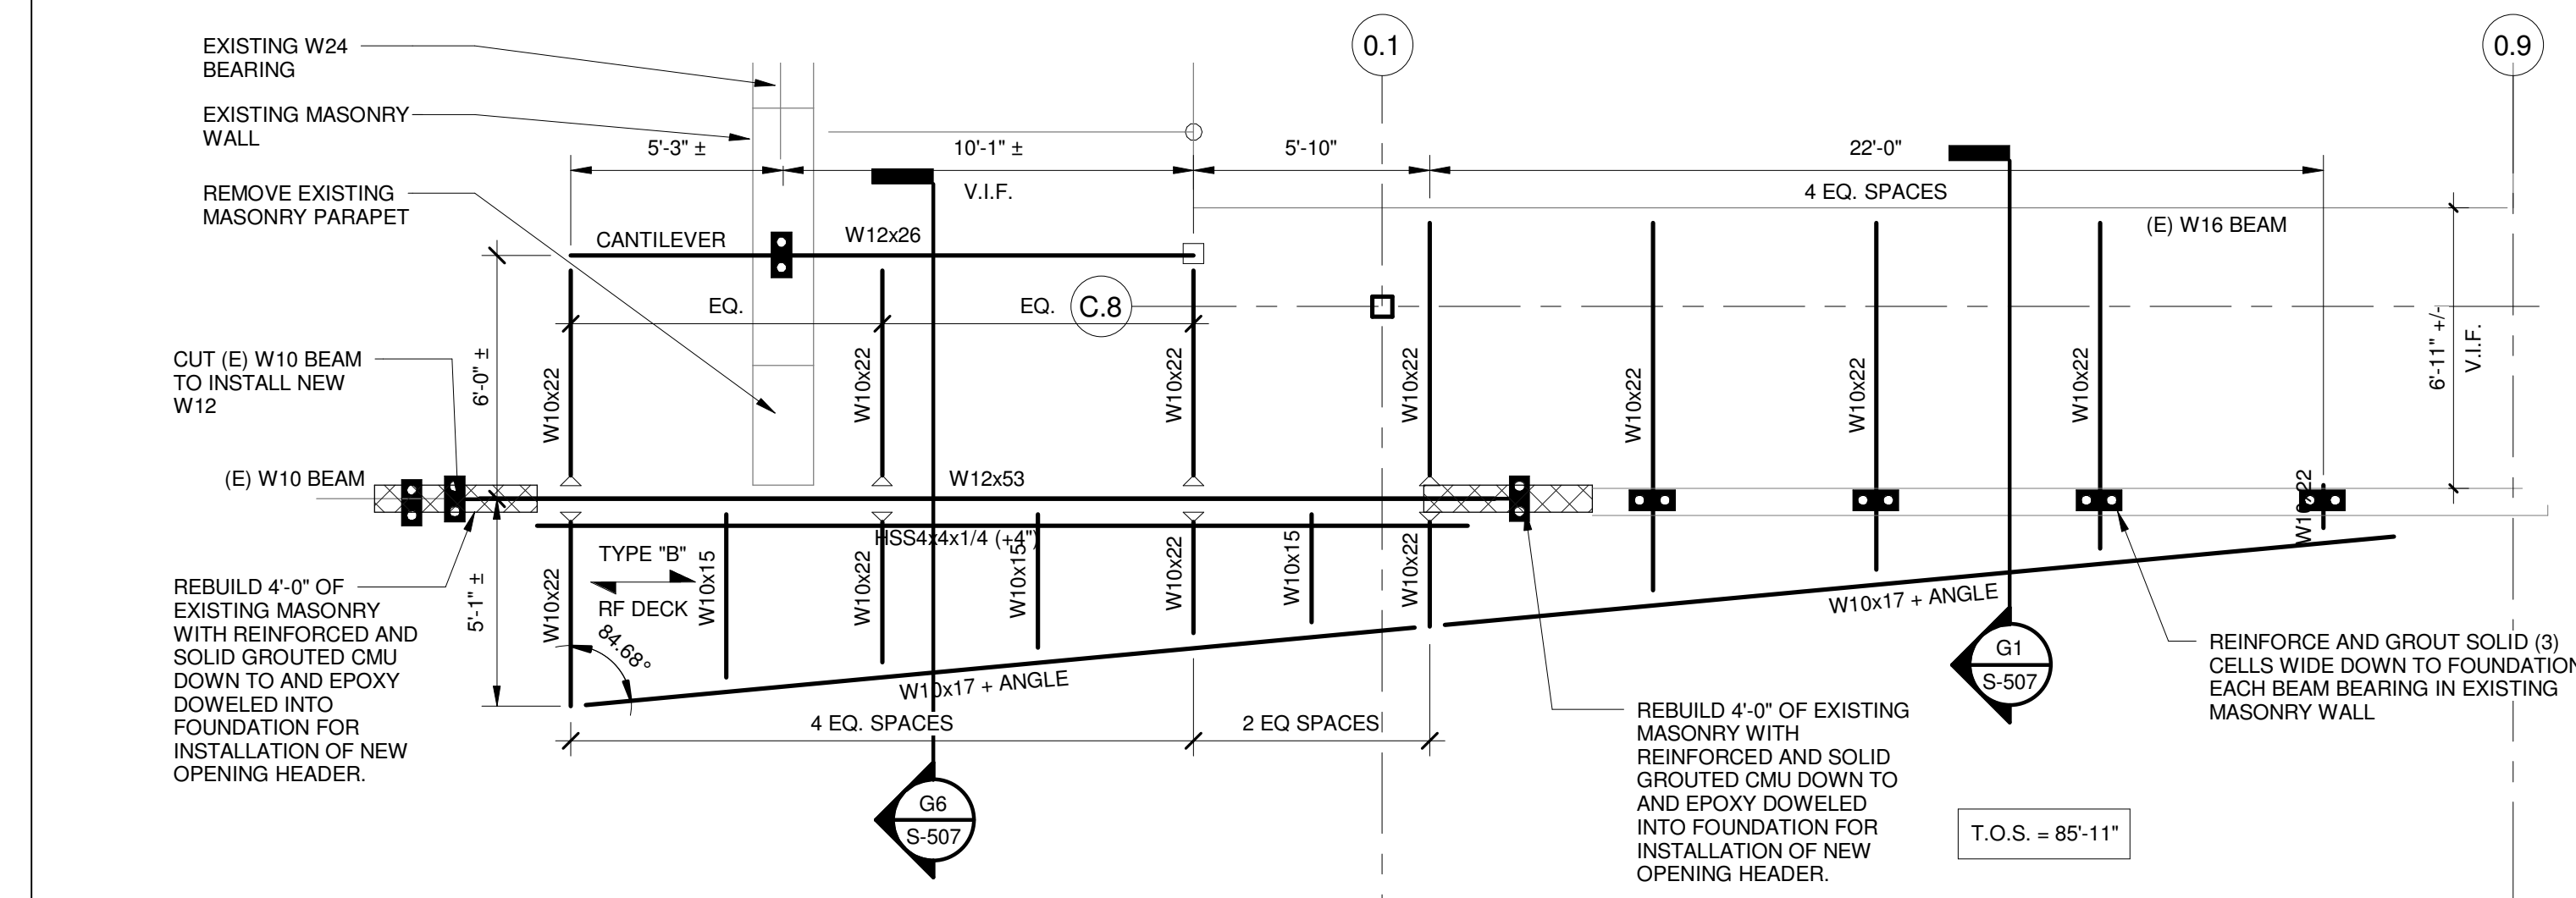


K6 MAIN ENTRY CANOPY FRAMING PLAN
1/4" = 1'-0"


CENTER STREET CANOPIES FRAMING PLAN NOTES:

- TOP OF STEEL = UNDERSIDE OF DECK. SEE PLANS FOR TOP OF STEEL ELEVATIONS. VERIFY EXISTING STEEL ELEVATIONS IN FIELD.
- SPAN DIRECTION OF METAL DECK CONSTRUCTION INDICATED AS FOLLOWS:
TYPE "B" 18 GAGE 1.5" DEEP (TYPE "B") METAL ROOF DECK
- SPECIAL CONNECTIONS INDICATED AS FOLLOWS:
 - FIELD & SHOP WELDED OUTRIGGER CONNECTION TO RESIST GRAVITY FORCES ONLY. SEE SECTIONS.
 - INDICATES STEEL BEAM BEARING PLATE CONNECTION TO CONCRETE MASONRY WALL. SEE TYPICAL DETAIL.
- INDICATES REINFORCED CMU WALL
- +ANGLE INDICATES CONT. L3x3x5/16 SHOP WELDED TO BEAM FOR WALL ANCHORAGE, U.N.O. IN SECTIONS


PROVIDE TEMPORARY SHORING OF EXISTING WALLS AND ROOF FOR INSTALLATION OF NEW CANOPY FRAMING

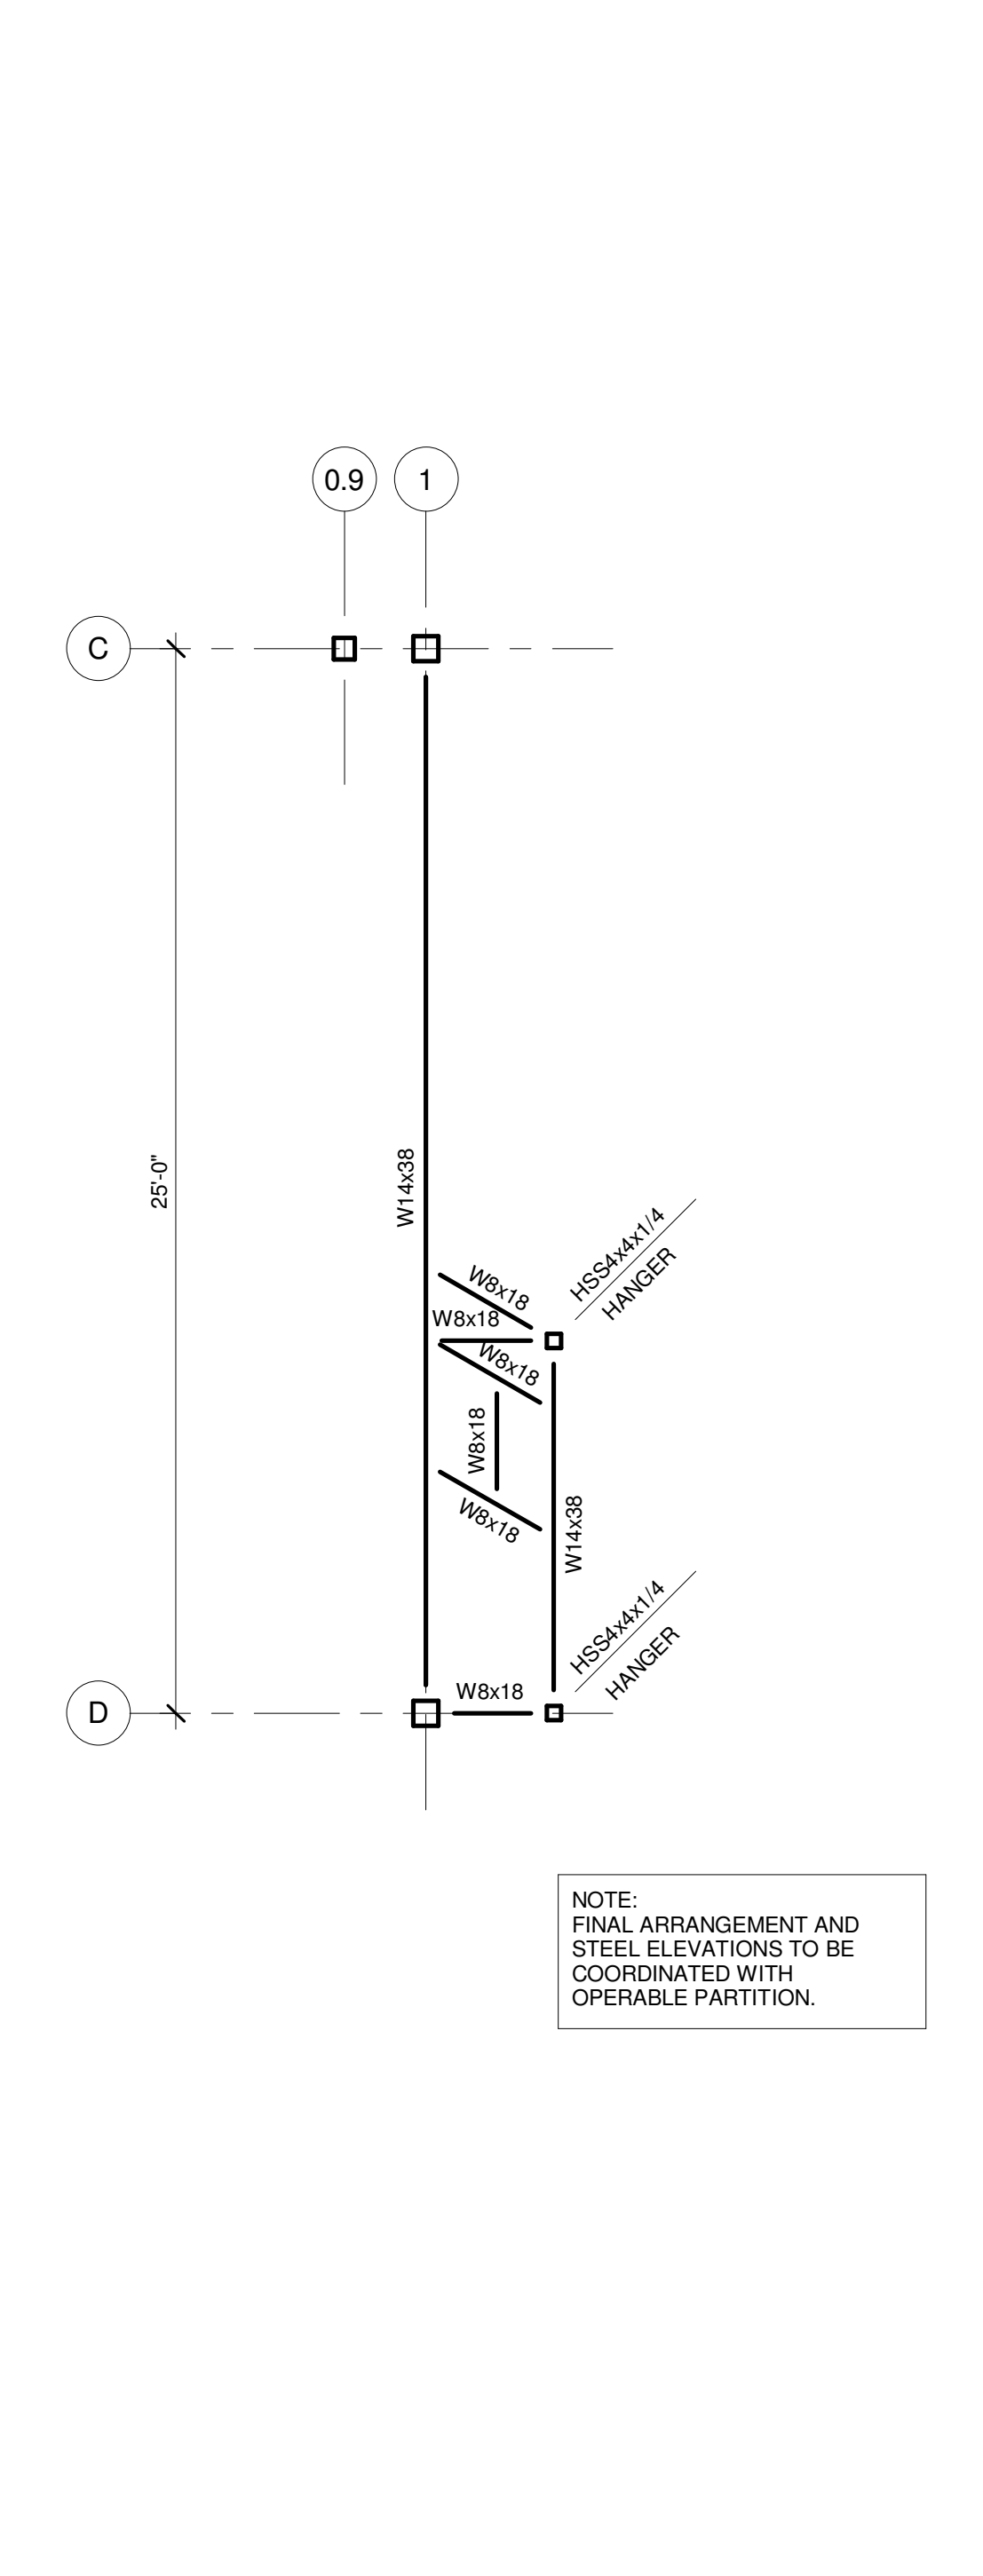


A1 OPERABLE PARTITION FRAMING
1/4" = 1'-0"

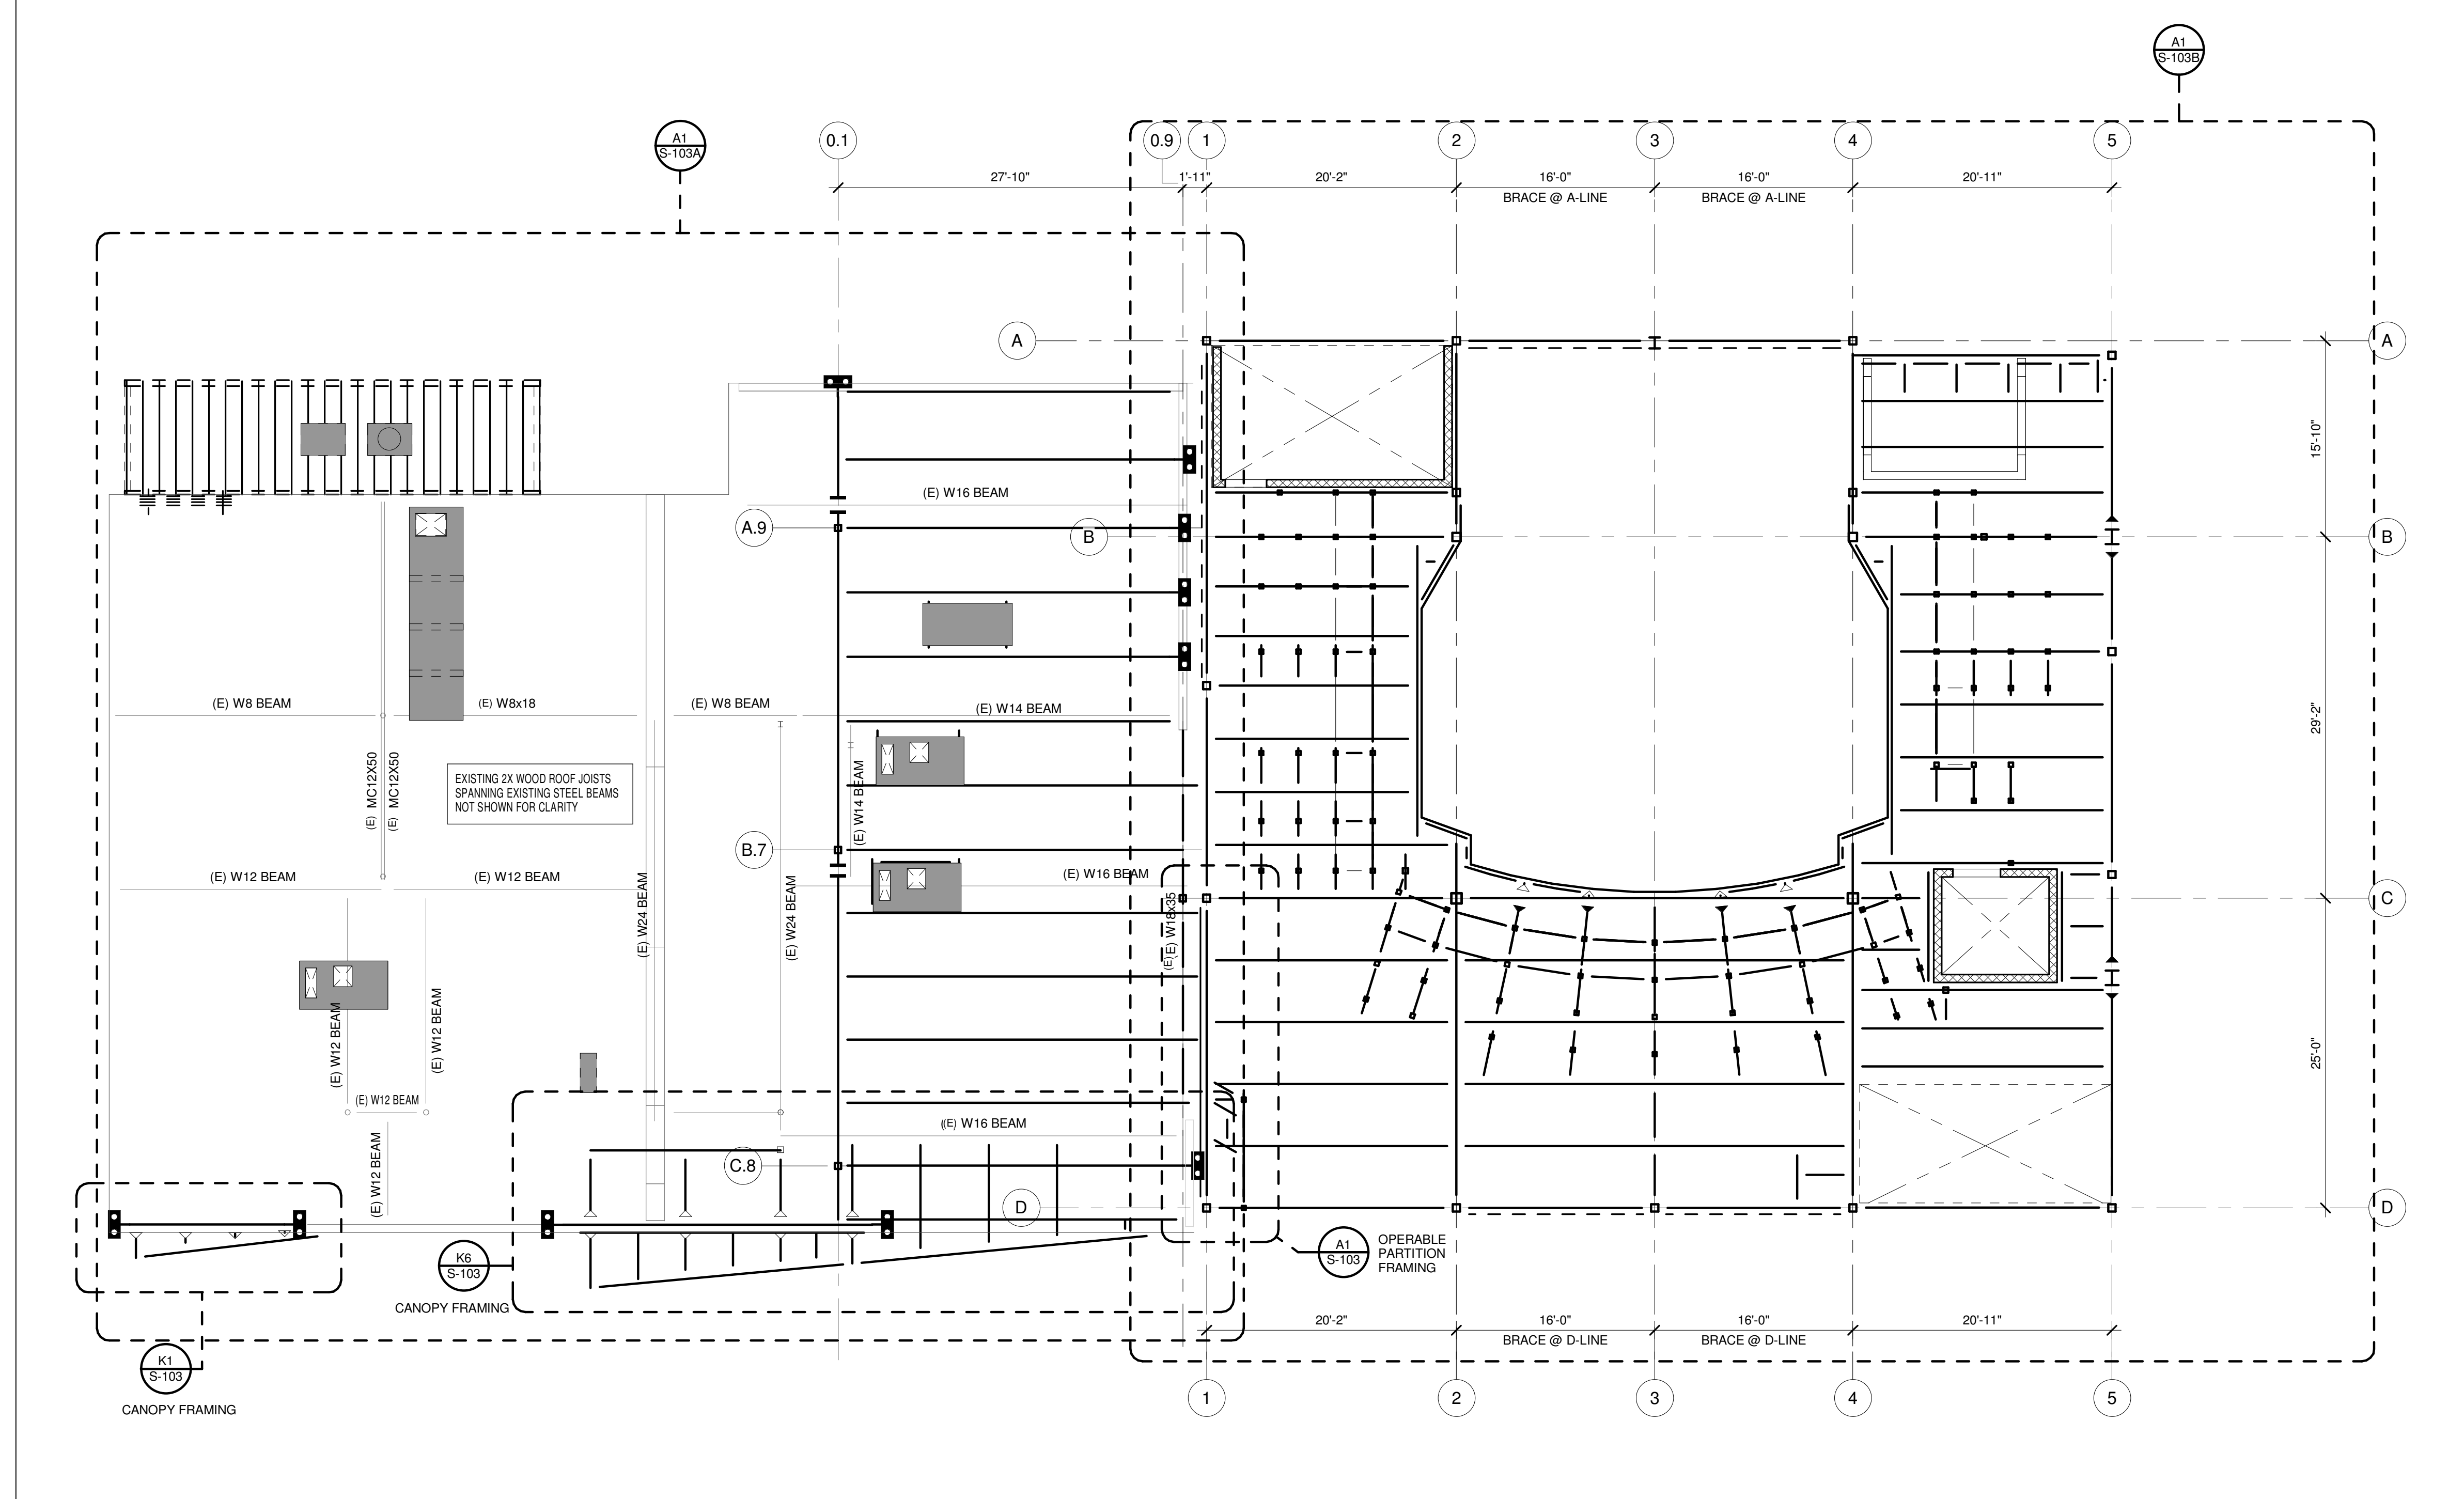

A4 EXISTING ROOF AND LOWER BALCONY FLOOR FRAMING PLAN
1/8" = 1'-0"

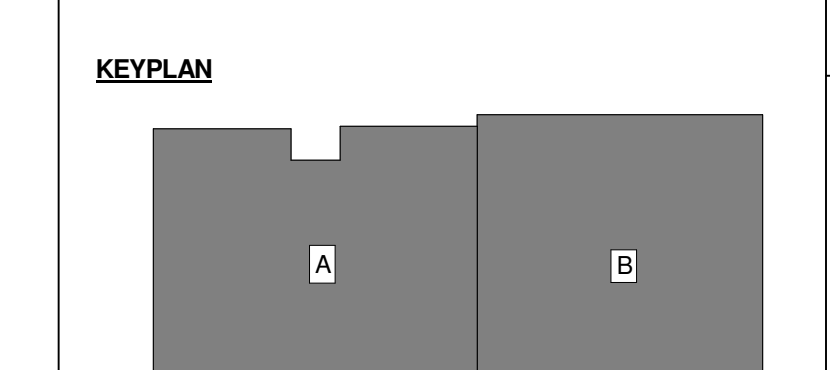

REV.	DESCRIPTION	DATE
0	ISSUED FOR BID	06 JUNE 2016

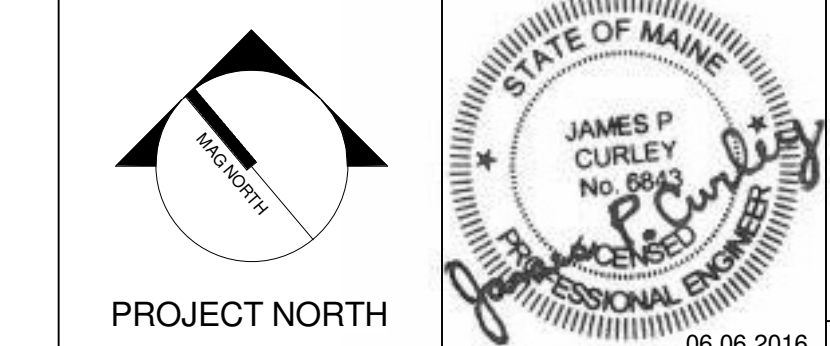

WBRC
ARCHITECTS • ENGINEERS
WWW.WBRCAE.COM
BANGOR, MAINE 207-947-4511
PORTLAND, MAINE 207-838-4511
SARASOTA, FLORIDA 241-556-0757

ASYLUM
EXISTING ROOF AND LOWER BALCONY FLOOR FRAMING PLAN

PROJECT No: 4071.10	GRAPHIC SCALE: 0" = 1"
SCALE: As indicated	SHEET No: S-103
PROJECT MANAGER: JRB	DRAWN BY: ADG/RAD/JHW
CHECKED BY: JPC	