

1/8" = 1'-0"

PROJECT NOTES

- SCOPE OF WORK SHALL INCLUDE INTERIOR TENANT FIT-UP FOR SUR LIE. WORK TO INCLUDE NEW INTERIOR PARTITIONS, NEW CEILING AND NEW MILLWORK AS
- HISTORIC PRESERVATION NOT REQUIRED. NO EXTERIOR WORK PROPOSED. EXTERIOR SIGNAGE NOT PART OF THIS PERMIT.
- ALL NEW WORK SHALL CONFORM TO THE CITY OF PORTLAND INSPECTION, FIRE AND ZONING REQUIREMENTS.
- THE GENERAL CONTRACTOR (GC) SHALL BE RESPONSIBLE FOR ALL INTERIOR WORK. GC TO OBTAIN ALL NECESSARY PERMITS FOR THE CONSTRUCTION, INCLUDING BUT NOT LIMITED TO, STREET CLOSINGS, ELECTRICAL, MECHANICAL. SPRINKLER SYSTEMS, AS REQUIRED. GC TO MODIFY MECHANICAL, ELECTRICAL, PLUMBING AND SPRINKLER SYSTEMS ACCORDING TO ARCHITECT'S/ENGINEER'S
- BASED ON ARCHITECT'S FLOOR PLAN, LIFE SAFETY SYSTEM INSTALLER SHALL SUBMIT LIFE SAFETY PLANS TO THE STATE OF MAINE AND THE CITY OF PORTLAND FOR APPROVAL.
- FIRE ALARM WORK SHALL BE INSTALLED BY A STATE CERTIFIED CONTRACTOR. FIRE ALARM WORK TO MEET NFPA 72, CITY OF PORTLAND AND STATE FIRE MARSHAL REQUIREMENTS.
- ALL FIRE RATED PENETRATIONS SHALL BE FIRE STOPPED WITH UL APPROVED SYSTEMS. ALL INTERIOR FINISHES TO MEET NFPA 701.
- CONTRACTOR SHALL ADHERE TO BUILDING RULES AND REGULATIONS AGREEMENT FOR INTERIOR CONSTRUCTION AS PROVIDED BY THE BUILDING'S PROPERTY MANAGEMENT
- CONTACT THE ARCHITECT PRIOR TO WORK SHOULD DISCREPANCIES BE DISCOVERED DURING THE BUILDING PROCESS.
- 10. RECONFIGURE SPRINKLER SYSTEM PER NEW PLAN & PER NFPA 13

PROJECT DIRECTORY

TENANT SUR LIE

11 FREE STREET Portland, Maine 04101

ARCHITECT MARK MUELLER ARCHITECTS 100 COMMERCIAL STREET

SUITE #207 PORTLAND, MAINE 04101 P: 207.774.9057 F: 207.773.3851 Email: matt@muellerarchitects.com

P: 207.299.2367 Email: kristalee64@yahoo.com

GENERAL LANDMARC CONSTRUCTION 415 CONGRESS STREET, SUITE 202 CONTRACTOR PORTLAND, ME 04102 P: 207.**699.2572**

F: 207.699.1380

Email: mgagnon@landmarccorp.com

GENERAL NOTES

- 1. THE BUILDING SHALL BE CONSTRUCTED TO CONFORM WITH ALL CURRENT APPLICABLE CODES INCLUDING, BUT NOT LIMITED TO, THE LATEST EDITIONS OF IBC, IECC, NFPA 101, ANSI, UFAS, HUD/AG, ADA/AG, MPS.
- 2. ALL WOOD IN CONTACT WITH CONCRETE SHALL BE TREATED WITH PRESSURE PRESERVATIVE.
- 3. CONTRACTOR SHALL WORK FROM GIVEN DIMENSIONS AND LARGE SCALE DETAILS ONLY. DO NOT SCALE THE DRAWINGS
- 4. INSTALL BLOCKING FOR SURFACE APPLIED FIXTURES, TRIM, CABINETS, COUNTER TOPS, AND GRAB BARS WHEN MOUNTED ON STUD WALLS, INCLUDING ALL FUTURE INSTALLATIONS.
- 5. ALL GRAB BARS SHALL BE ABLE TO SUPPORT A DEAD WEIGHT OF 250 LBS AT ANY POINT
- 6. INSTALL MOISTURE RESISTANT GYPSUM BOARD IN HOUSEKEEPING, UTILITY, STORAGE, SPRINKLER AND ALL OTHER HIGH HUMIDITY AREAS, INCLUDING UNIT BATHROOMS. MOISTURE RESISTANT FIRECODE G.W.B. @ ALL FIRE RATED WALLS COMMON WITH HOUSE UTILITY AND UNIT BATH ROOMS. IF APPLICABLE TO THIS PROJECT, SHOWERS TO HAVE DURAROCK BACKING ALL SIDES. ALL CAULKING AROUND WINDOWS SHALL BE NON-HARDENING TYPE SEALANT.
- 7. INSTALL U.L. SLEEVE FIRE-STOPPING SYSTEM & FIRE RATED SEALANTS EQUAL TO THE FIRE RATED FLOOR, CEILING AND WALL ASSEMBLY.
- 8. FIRESTOP VERTICAL MECHANICAL CHASES @ FLOOR & CEILING U.L. RATED PENETRATIONS. CAULK JOINTS. COORDINATE AND FLASH ALL ROOF/WALL PENETRATIONS WITH THE SUB-TRADES.
- 9. CONTINUE SEPARATION WALLS TO UNDERSIDE OF FLOOR/CEILING ABOVE. UNIT TO UNIT, UNIT TO CORRIDOR, CORRIDOR WALLS, STORAGE WALLS, ELEVATOR, STAIRWELL WALLS, ETC.
- 10. PROJECT ASSUMES ALL EXISTING HAZARDOUS MATERIALS HAVE BEEN REMOVED PRIOR TO THE COMMENCEMENT OF WORK. ALL HAZARDOUS MATERIAL REMOVAL IS THE RESPONSIBILITY OF THE OWNER.
- 11. DESIGNATED EGRESS WINDOWS IN SLEEPING ROOMS SHALL MEET THE FOLLOWING MINIMUM CLEAR OPENING REQUIREMENTS OF 22" WIDE, 24" HIGH & 5.7 SF CLEAR OPENING. ALL BEDROOMS SHALL CONTAIN A MINIMUM OF (1) EGRESS OPENING. (NOT APPLICABLE TO THIS PROJECT).
- 12. WINDOW SAFETY GLAZING SHALL BE LOCATED AS FOLLOWS, BUT NOT LIMITED TO:
 - ALL WINDOWS WITHIN 60" HORIZ. & VERT. DIMENSION OF STAIRS MUST BE TEMPERED.
 - ALL WINDOWS WITHIN 24" OF A DOOR SWING MUST BE TEMPERED. ALL WINDOWS WITHIN A SHOWER ENCLOSURE MUST BE TEMPERED
- 13. BUILDING INSULATION SHALL BE PROVIDED AS INDICATED & NOTED IF NOT SHOWN IN ITS ENTIRETY THROUGHOUT THE DRAWING SET. INSULATE AND ROOF DRAINS THRU BUILDING. BEAM, JOIST OR OTHER STRUCTURAL MEMBER PENETRATIONS NOT SHOWN OR INDICATED ON DRAWINGS MUST BE CONSULTED WITH THE ARCHITECT &/OR ENGINEER PRIOR TO WORK.
- 14. ANY CHANGE DURING CONSTRUCTION OF USE, OCCUPANCY OR CONSTRUCTION TYPE MUST BE DISCUSSED WITH ARCHITECT PRIOR TO ANY WORK PERFORMED AND SUBSTANTIAL TIME ALLOWED FOR REQUIRED CODE RESEARCH AND DRAWING MODIFICATIONS OR ADDITIONS.
- 15. REPORT ANY AND ALL DISCREPANCIES TO THE ARCHITECT PRIOR TO PROCEEDING WITH WORK

- WHERE APPLICABLE, SHALL REMAIN OPERATIONAL UNLESS PERMITTED BY THE CITY BUILDING INSPECTOR. FIRE ALARM SYSTEMS TO REMAIN FULLY OPERATIONAL DURING DEMOLITION
- 2. DUST BARRIER PARTITIONING SHALL BE INSTALLED @ TENANT SEPARATIONS.
- 3. ALL DEMOLITION SHALL BE REMOVED FROM THE REAR/ SIDE OF THE BUILDING
- 4. ALL FIRE PROTECTION (IF EXISTING), GYPSUM DRYWALL &/ OR FIRESPRAY ON STRUCTURAL MEMBERS SHALL REMAIN. BEARING WALLS, FIRE SEPARATION WALLS, BEAMS, COLUMNS & FIRE RATED FLOOR/ CEILING ASSEMBLIES SHALL NOT BE REMOVED.
- 5. PROTECT ALL FINISHES, MATERIALS AND EQUIPMENT NOTED AS EXISTING TO REMAIN.
- 6. DIMENSIONS INDICATED +/- ARE EXISTING CONDITION DIMENSIONS TO BE FIELD VERIFIED.
- 7. REMOVE EXISTING PLUMBING FIXTURES IF ANY, VENTING AND ASSOCIATED EXHAUST FANS. CAP PLUMBING FLUSH WITH FLOOR. (NOT APPLICABLE TO THIS PROJECT).
- 8. GC TO VERIFY WITH 'DIG SAFE' PRIOR TO ANY SITE WORK. (NOT APPLICABLE TO THIS PROJECT).
- 9. FIELD VERIFY ALL STRUCTURAL COMPONENTS PRIOR TO DEMOLITION. REPORT ANY DISCREPANCIES IMMEDIATELY TO ARCHITECT.

— (1) LAYERS OF **%**" TYPE 'X' G.W.B. - STOVE HOOD EXHAUST DUCT 3M FIRE BARRIER DUCT WRAP 15A - (ALLOWS DUCT WRAP, MUST PROVIDE 18" CLEARANCE ETWEEN DUCT AND COMBUSTIBLES) FOLLOW MANUFACTURER'S COMMENDATIONS AT FLOOR AND WALL PENETRATIONS 3" LAYER OF SPECIFIED DUCT WRAP DUCT FOR STOVE HOOD REQUIRED IN KITCHEN TO MEET NFPA 96 FIRE STOP SHAFT @ FLOOR LINE

SHAFT WALL (1 HR. RATED) (UL DESIGN: U 415) CAULK PERIMETER


DOOR NOTES:


- ALL NEW DOORS SHALL BE 3'-0" x 7'-0" W/ LEVER 'ADA' HARDWARE, FINISH T.B.D. BY OWNER

LEGEND:

EXIT

- ALL EXISTING DOORS SHALL HAVE LEVER 'ADA'
- HARDWARE, FINISH T.B.D. BY OWNER
- ALL EXIT DOORS SHALL BE PUSH/PULL OR EXIT HARDWARE W/ CLOSERS

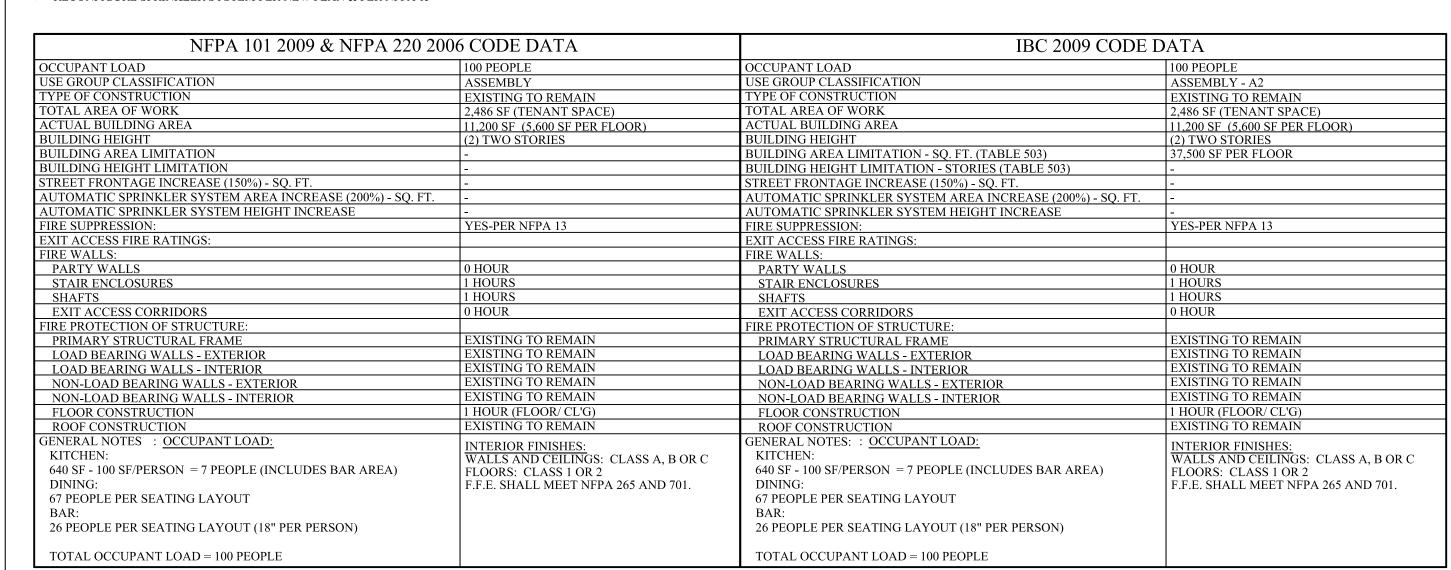

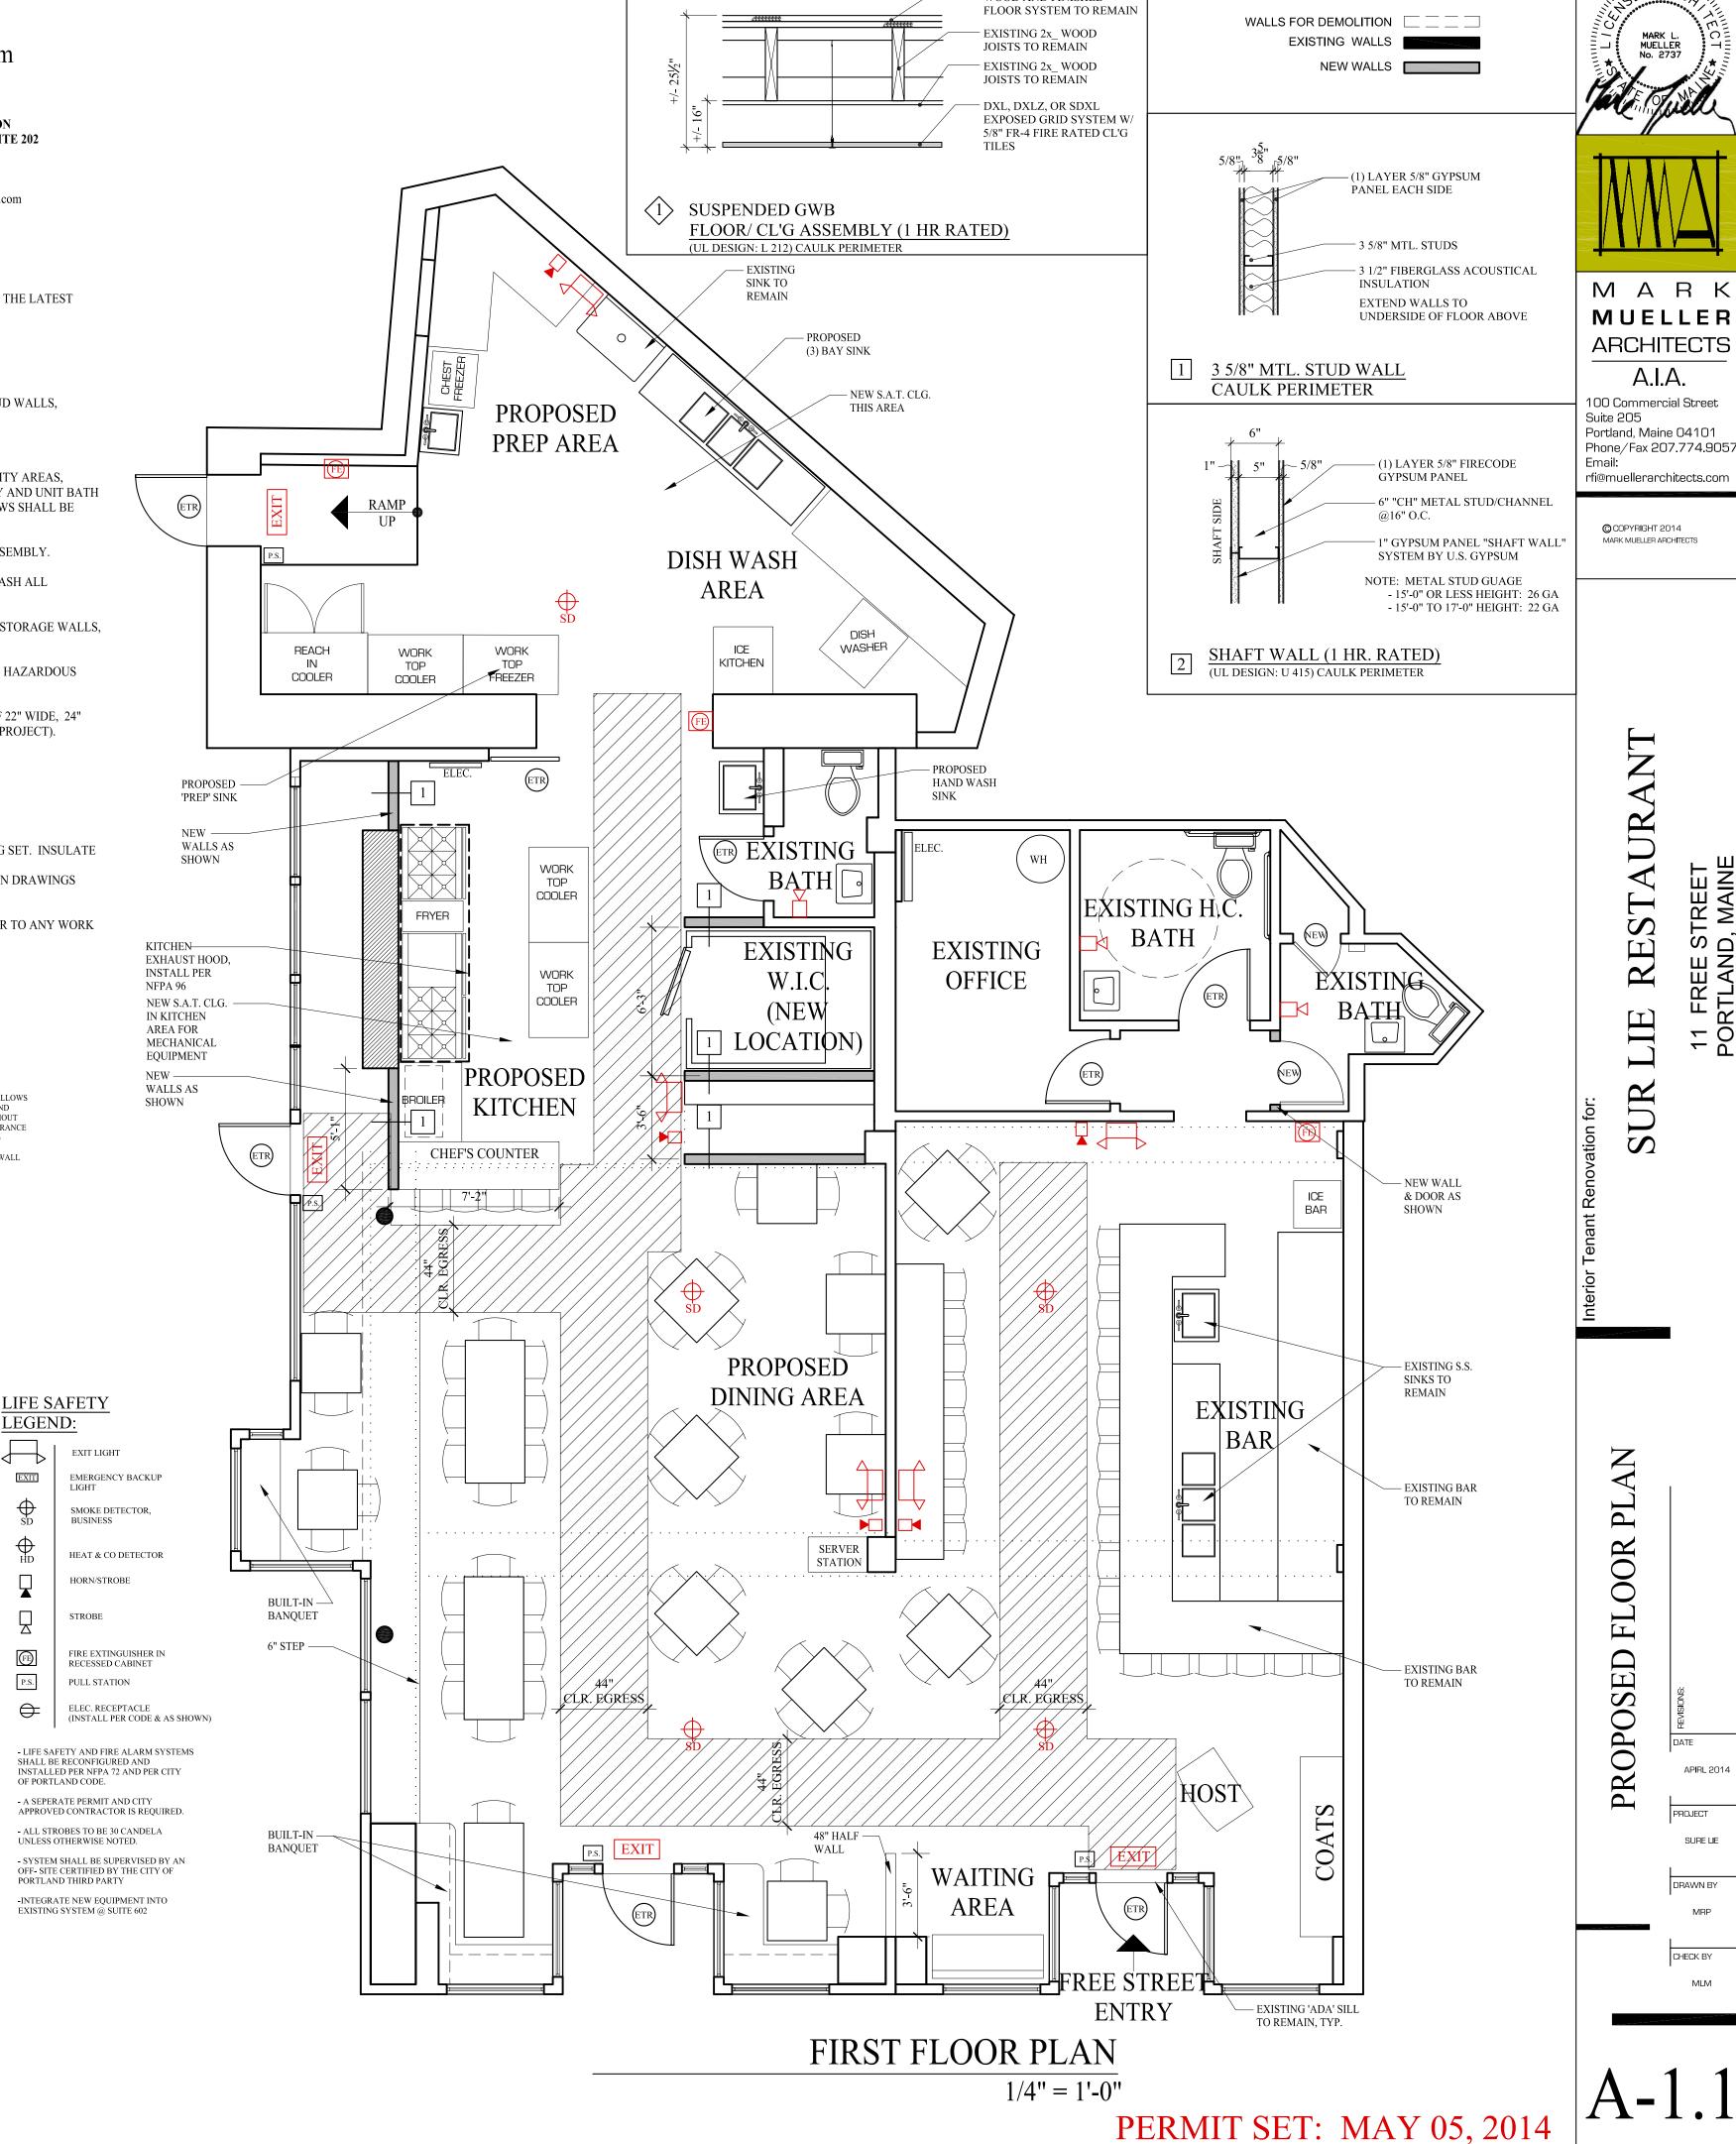

EXISTING 1" NOMINAL

WOOD AND FINISHED

WALL LEGEND

A.I.A.

COPYRIGHT 2014

S

PO

APIRL 2014

PROJECT

SURE LIE

DRAWN BY

CHECK BY

MARK MUELLER ARCHITECTS