


	A-1 B-1 C-1	A-16 D-2-1 D-2-2 D-2-3 E-2.2 E-2.6	D-2-3 D-2-5 (UPPER ONLY)	D-2-5	D-3	A-3	B-6 C-6	A-6	A-1 E-1	B-3 C-3	B-1 C-1	E-4	E-6	A-2 B-2 C-2 D-2 D-6
TOP OF COLUMN ELEV.	67'-5"	67'-5"	UPPER 143'-4" LOWER 67'-5"	127'-5"	127'-5"	130'-4"	130'-4"	130'-4"	117'-5"	137'-7"	117'-5"	117'-5"	117'-5"	130'-4"
BOT. OF BASE PL ELEV.	55'-0"	56'-10 1/2"	UPPER 117'-3 1/2" LOWER 55'-0"	117'-5"	127'-5"	56'-10 1/2"	56'-10 1/2"	56'-10 1/2"	56'-10 1/2"	46'-11"	56'-10 1/2"	56'-10 1/2"	56'-10 1/2"	117'-2 1/2"
BASE PL TYPE	A	A	UPPER B LOWER A	A	A	E	E	C	C	F	D	D	C	B


COLUMN SCHEDULE

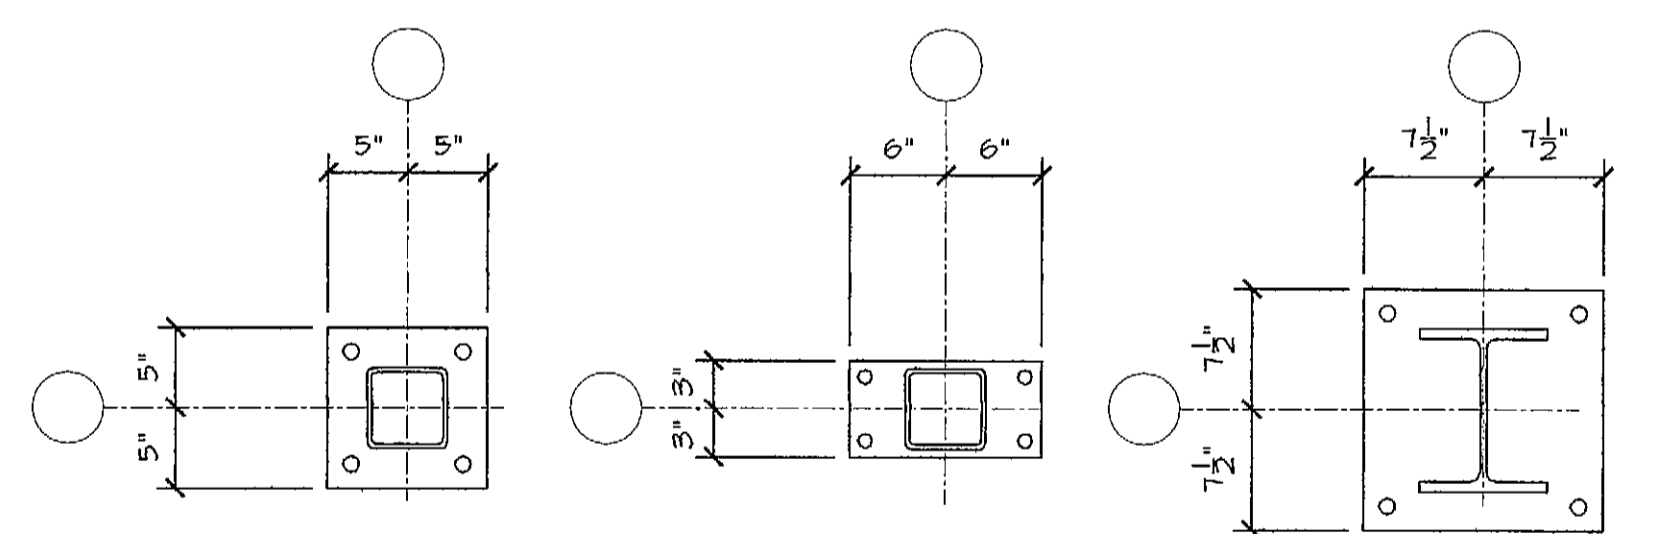

TYPE A
THICKNESS = 3/4"

TYPE B
THICKNESS = 1/2"
HOLE DIA. = 1/8"
EDGE DIST = 1"

TYPE C
THICKNESS = 1 1/2"

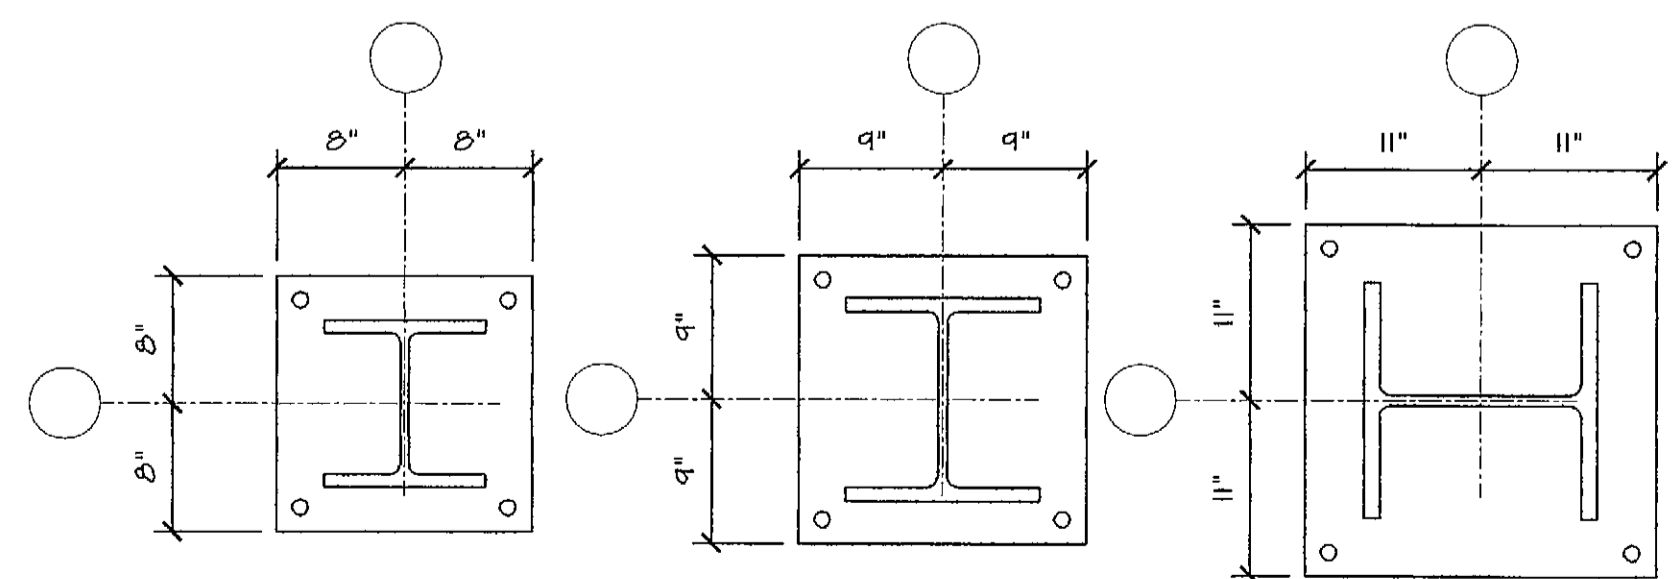


TYPE D
THICKNESS = 1 1/2"

TYPE E
THICKNESS = 2"

TYPE F
THICKNESS = 2"

BASE PLATE DETAILS

1"=1'-0"
HOLE EDGE DISTANCE = 1 1/2" UNLESS NOTED.
HOLE DIA. = 1/16" UNLESS NOTED.

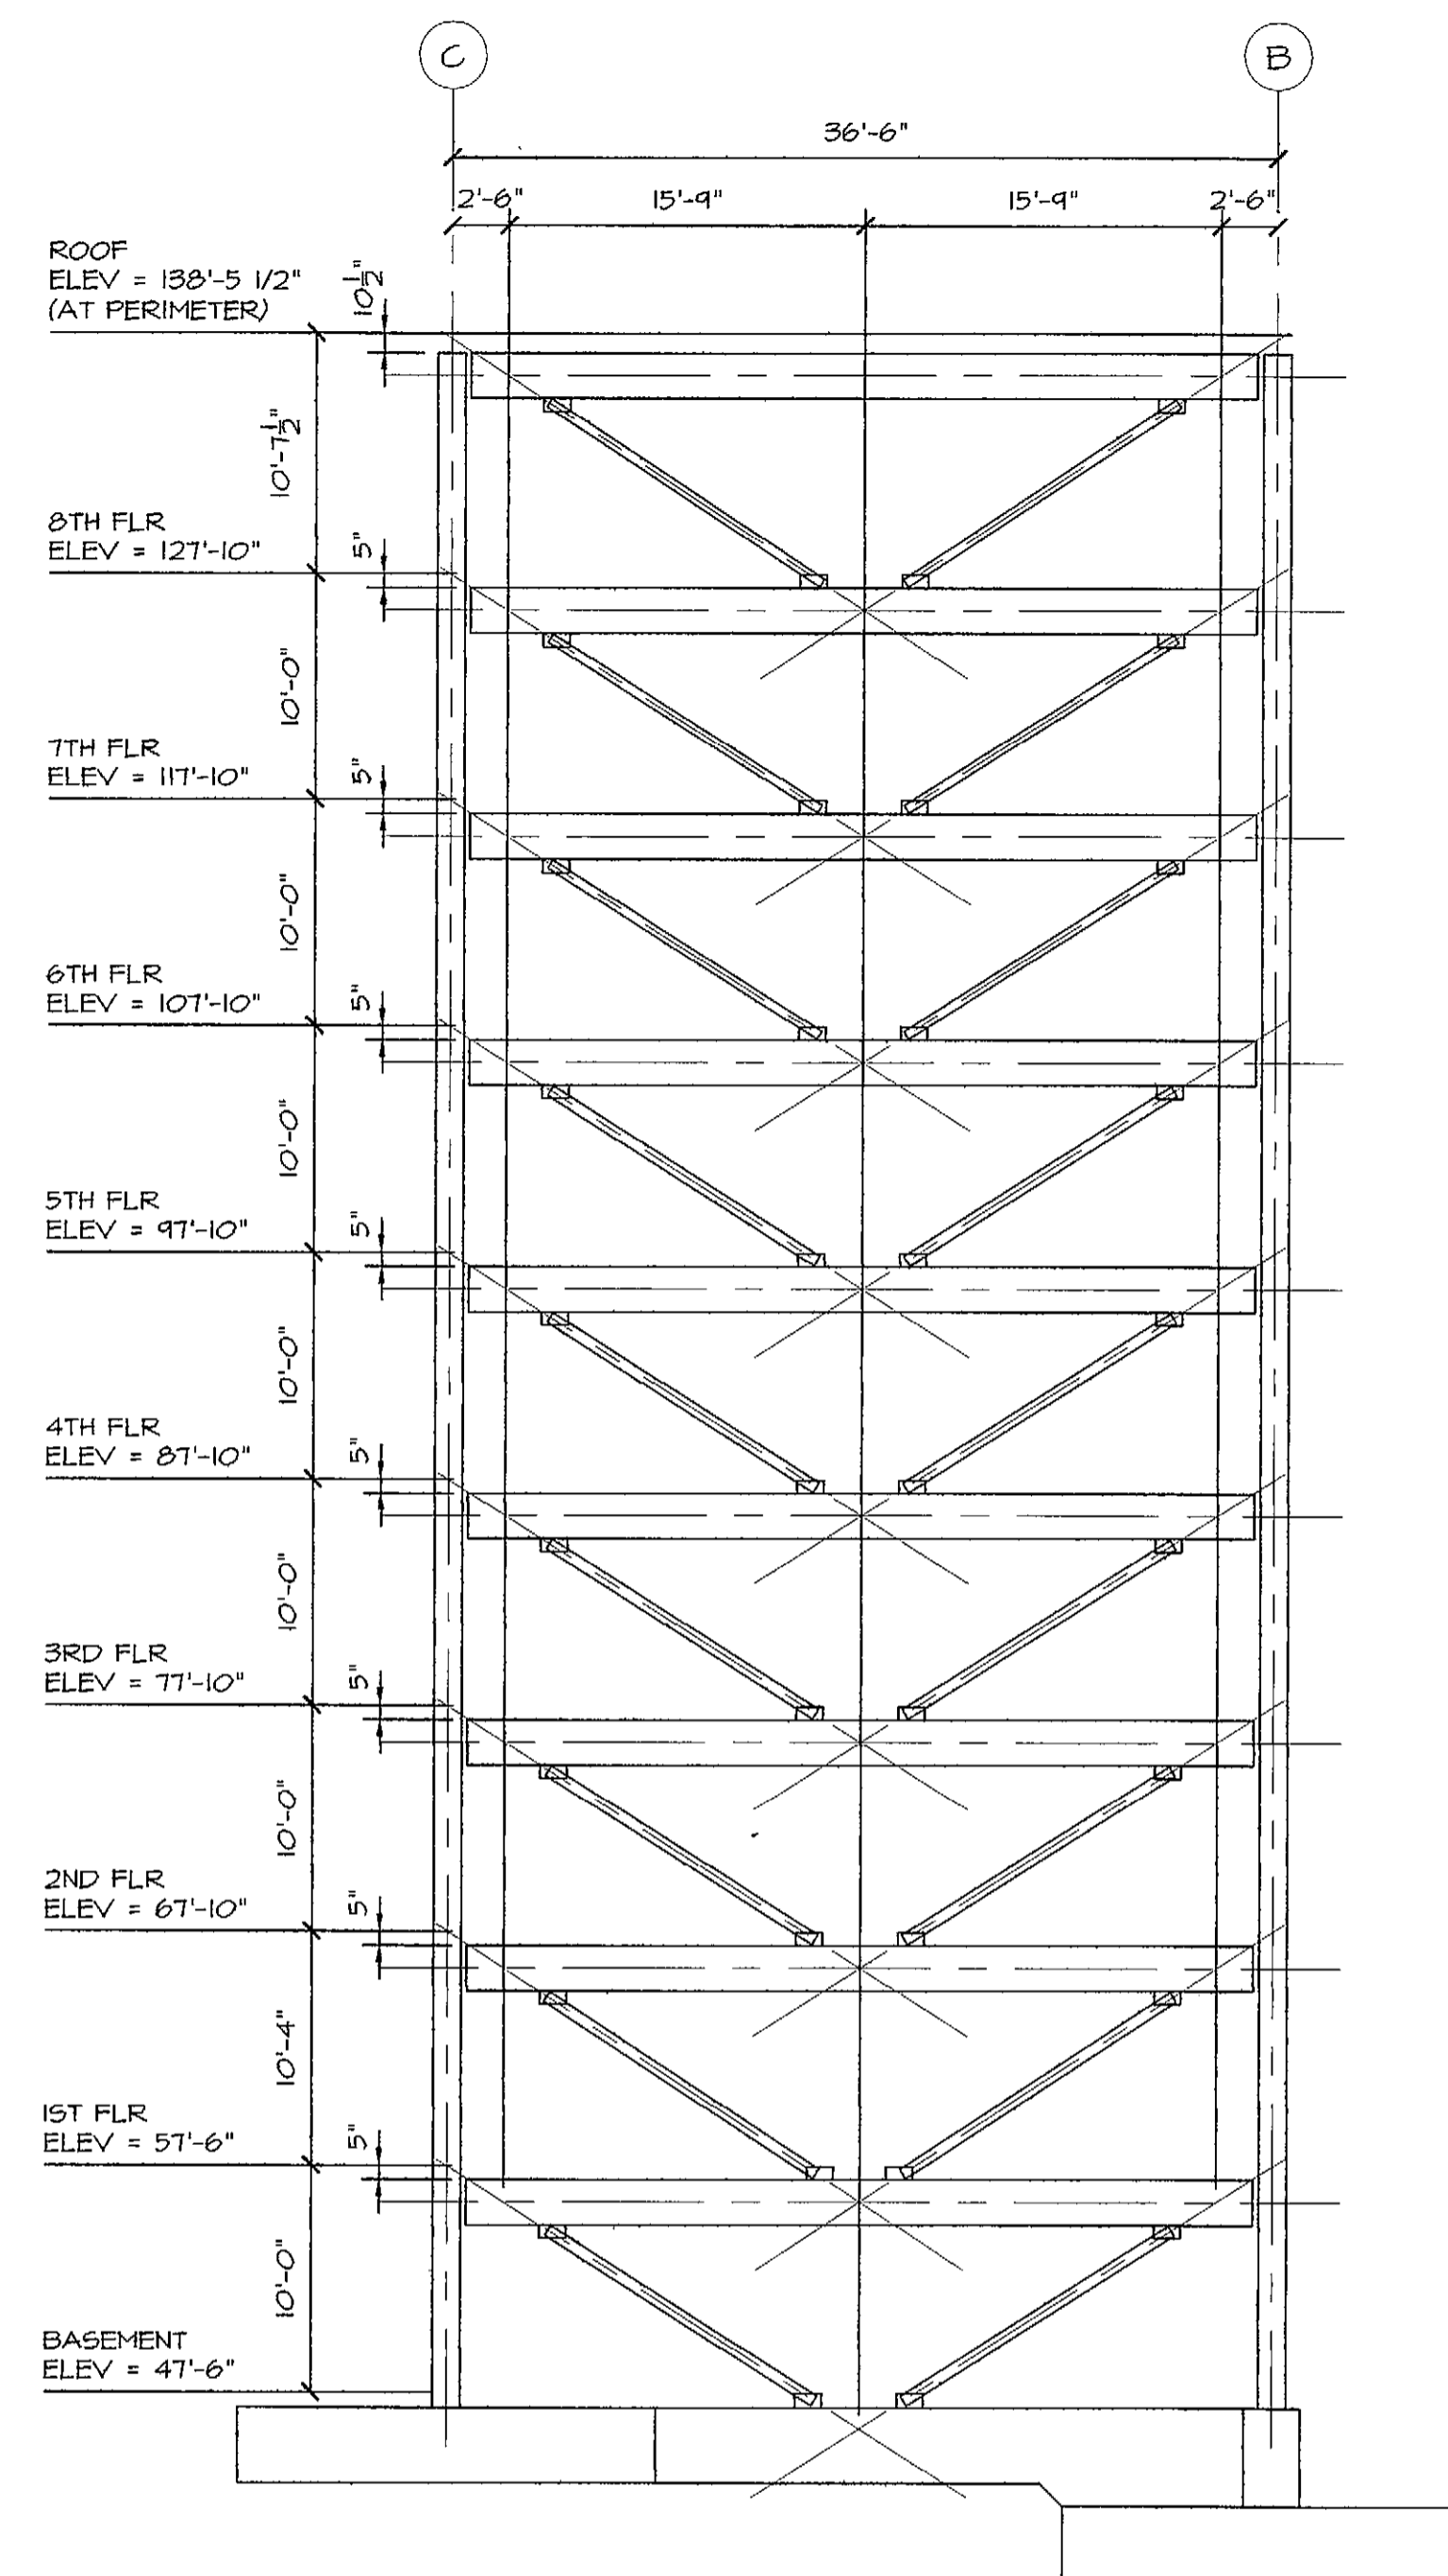


GRID 3 BRACING ELEVATION
1/8"=1'-0"

ALL BRACE MEMBERS FROM BASE TO 2ND FLOOR ARE H556x6x0.50
ALL BRACE MEMBERS FROM 2ND FLOOR TO 6TH FLOOR ARE H55 6x6x0.25
ALL BRACE MEMBERS ABOVE 6TH FLOOR ARE H555x5x0.25

ALL BRACING WORK POINTS ARE AT CENTERLINE OF BEAM AND COLUMN UNLESS NOTED OTHERWISE.

ALL ELEVATIONS ARE AT TOP OF CONCRETE FLOOR SLAB OR STEEL ROOF DECK.

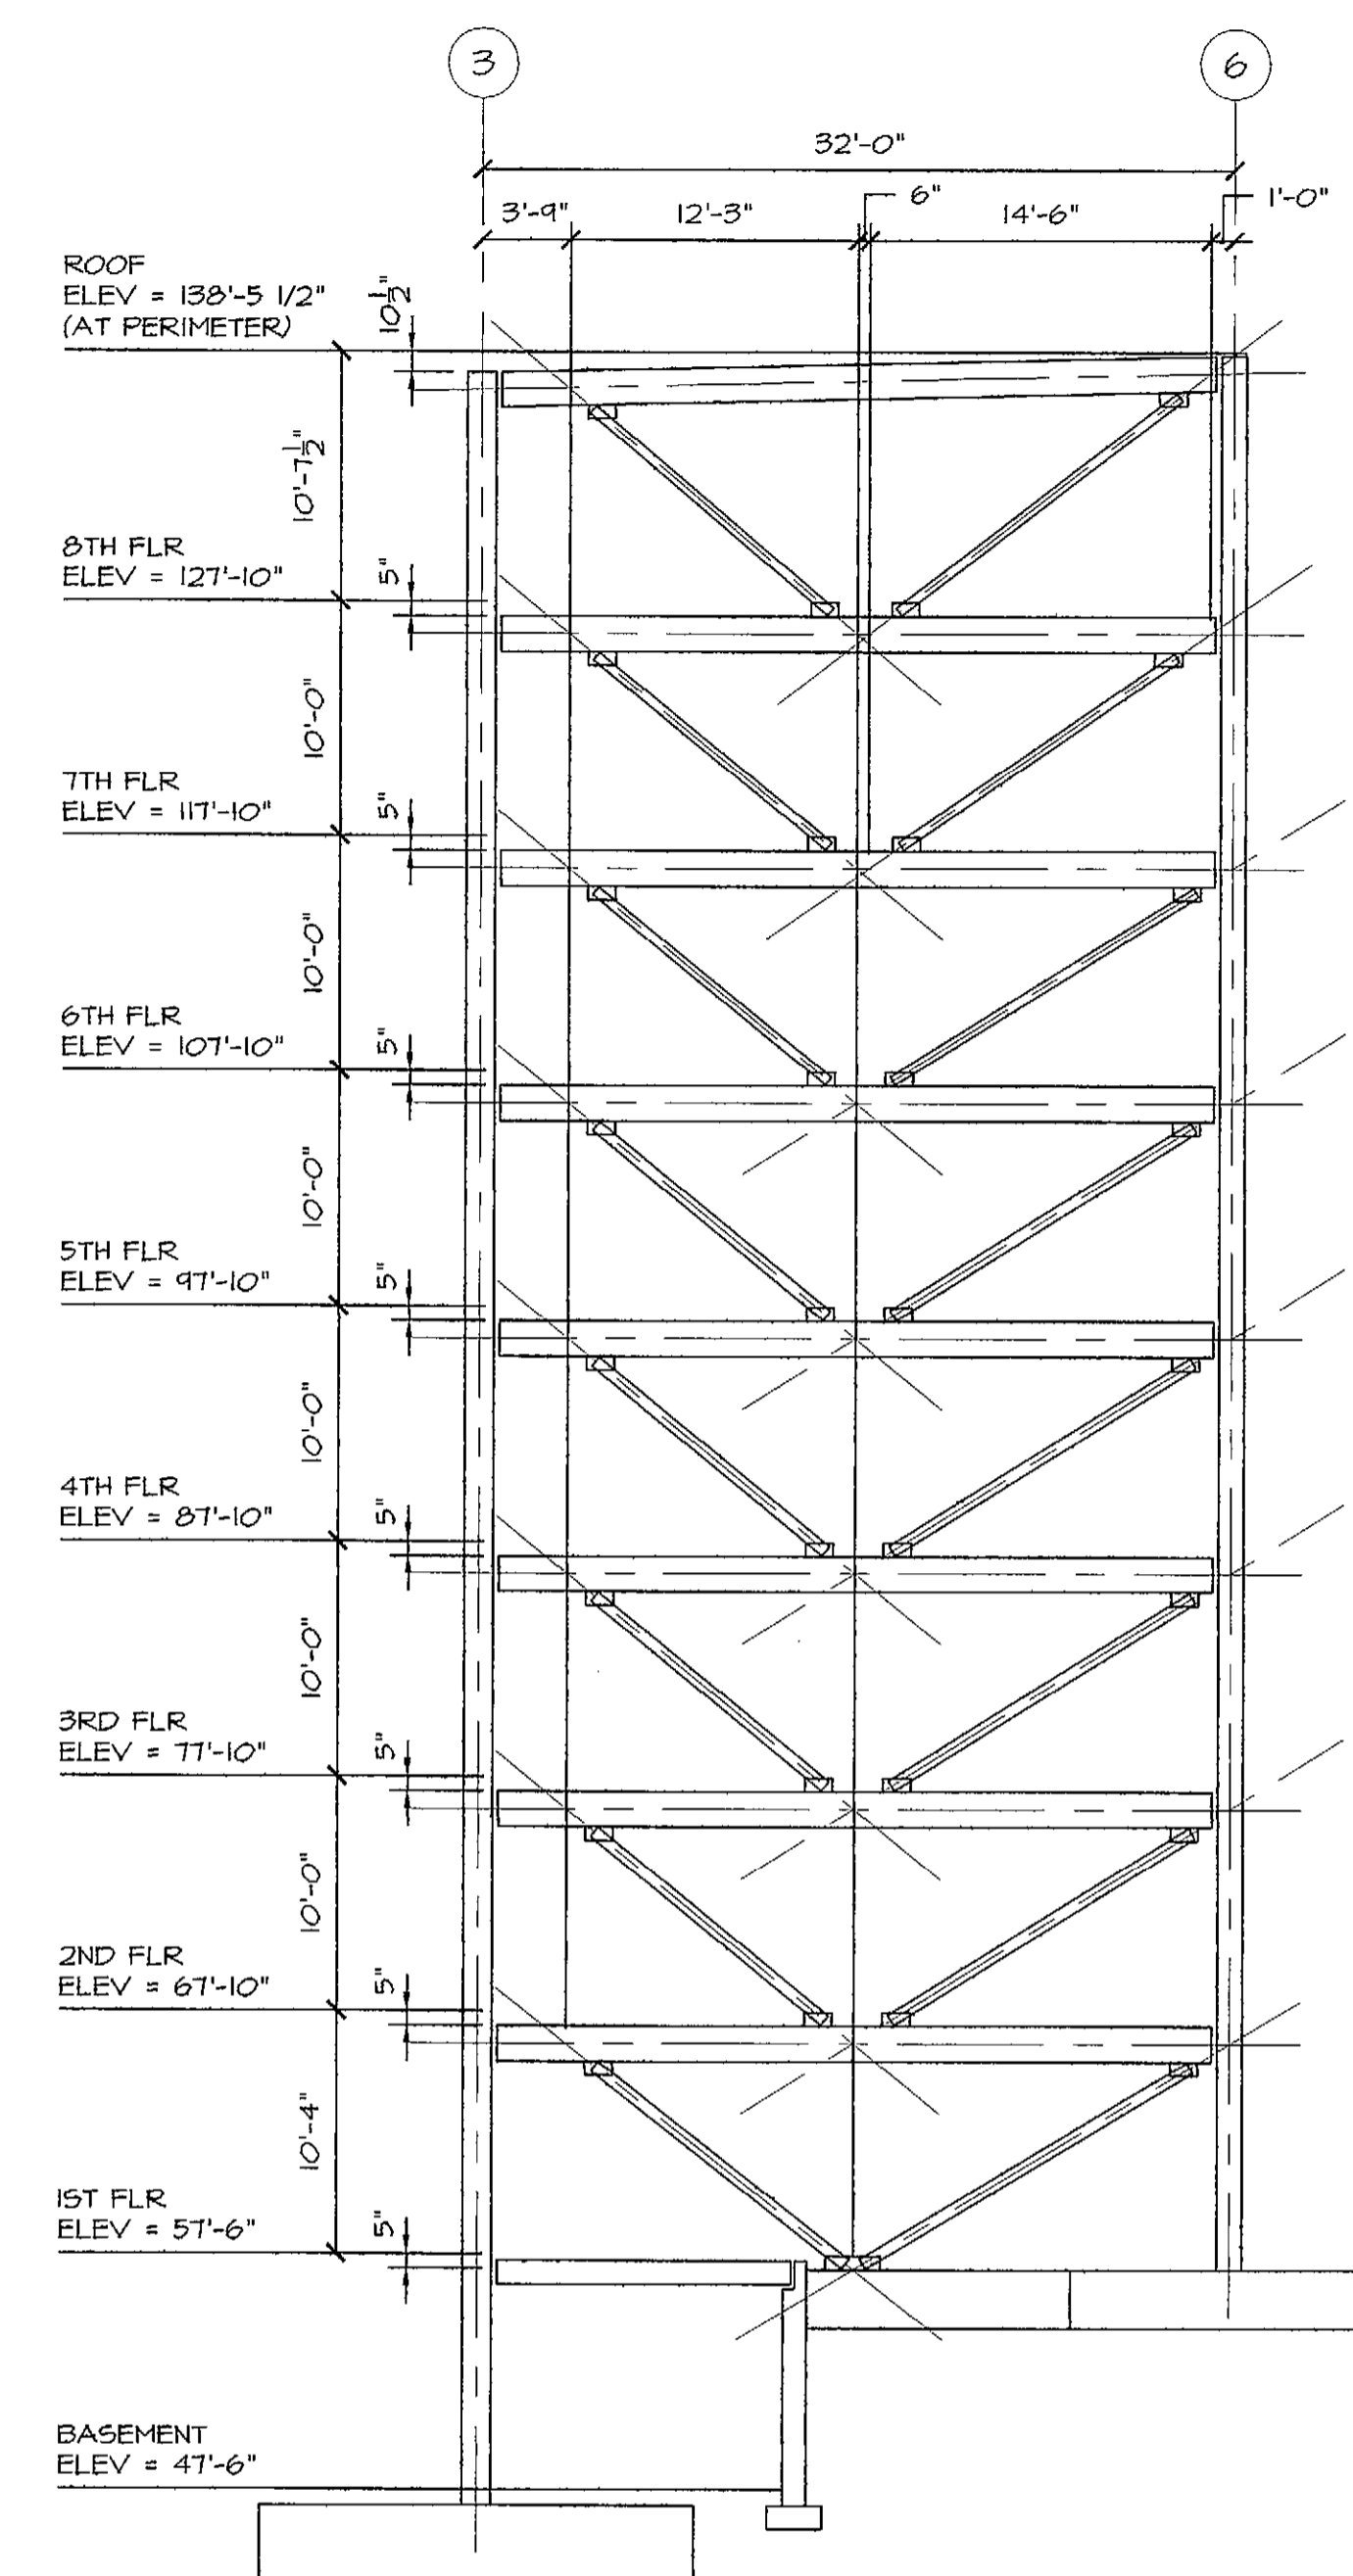


GRIDS B AND C BRACING ELEVATION
1/8"=1'-0"


ALL BRACE MEMBERS FROM BASE TO 2ND FLOOR ARE H556x6x0.50
ALL BRACE MEMBERS FROM 2ND FLOOR TO 6TH FLOOR ARE H55 6x6x0.25
ALL BRACE MEMBERS ABOVE 6TH FLOOR ARE H555x5x0.25

ALL BRACING WORK POINTS ARE AT CENTERLINE OF BEAM AND COLUMN UNLESS NOTED OTHERWISE.

ALL ELEVATIONS ARE AT TOP OF CONCRETE FLOOR SLAB OR STEEL ROOF DECK.

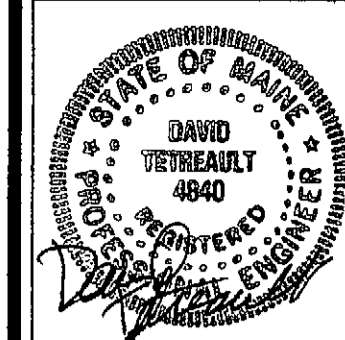

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CONSULTANTS:

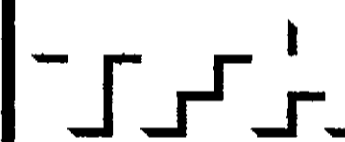REVISIONS:
100% CONST. DOC.

DATE: 02/24/06

PROJECT No. 0422

DRAWN BY: DJT

CHECKED BY: DJT

SCALE: 1/8"=1'-0"

SHEET TITLE:
COL. SCHEDULE
BRACING ELEV.
AND DETAILS

S2.0