




F1 FIRE PROTECTION PLAN - LEVEL 3 - PHASE II
1/16" = 1'-0"

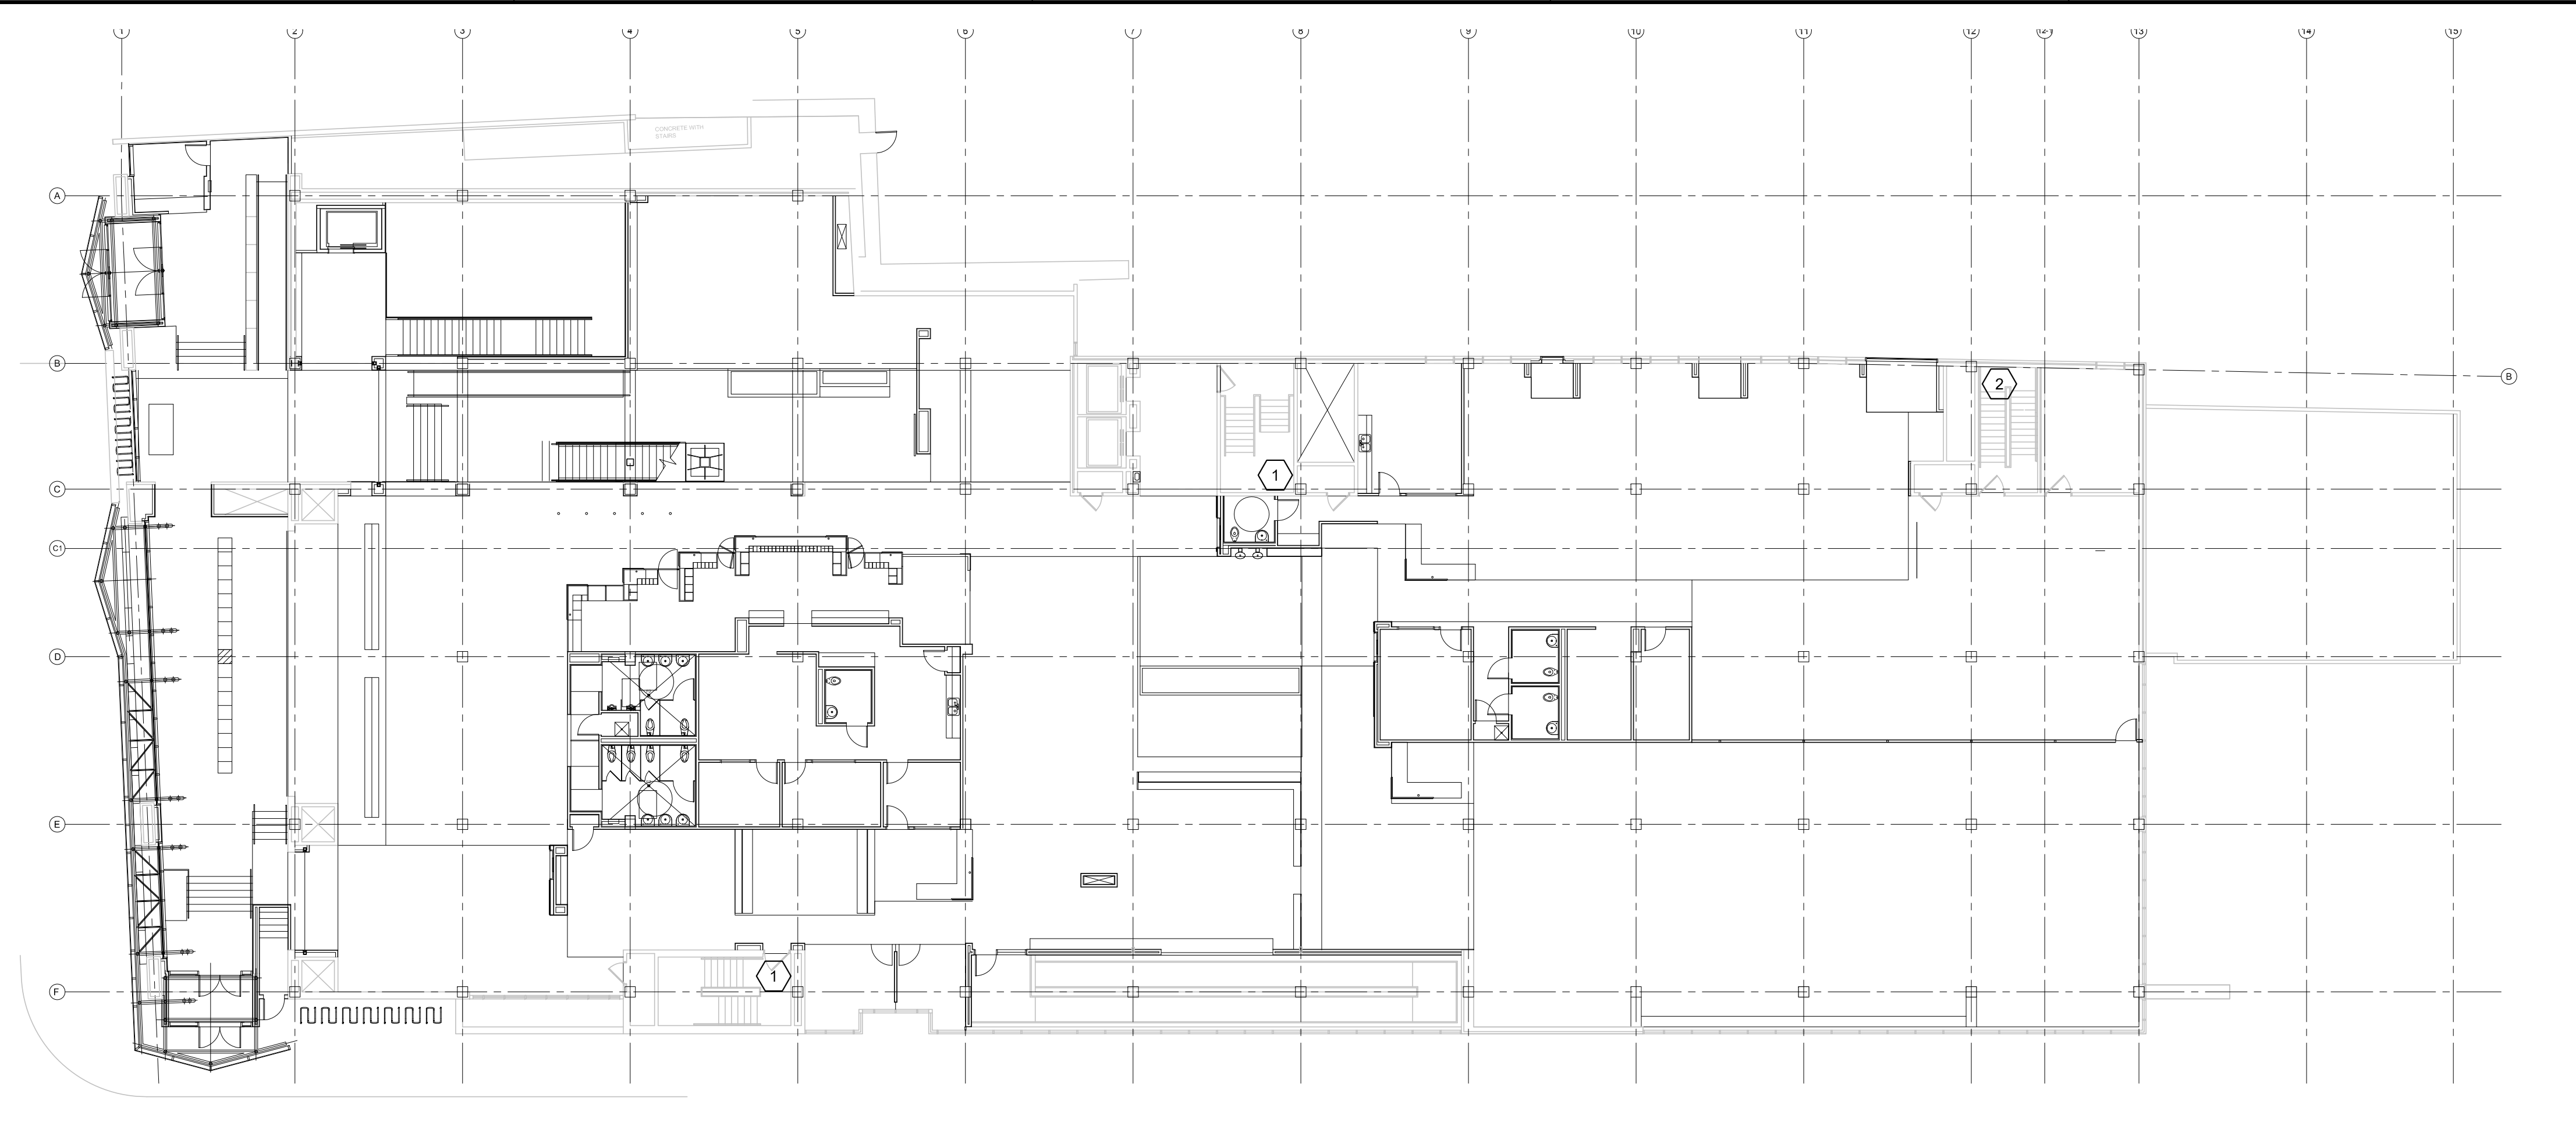


F6 FIRE PROTECTION PLAN - MAIN LEVEL - PHASE I - 100% COVERAGE OF THIS FLOOR
1/16" = 1'-0"

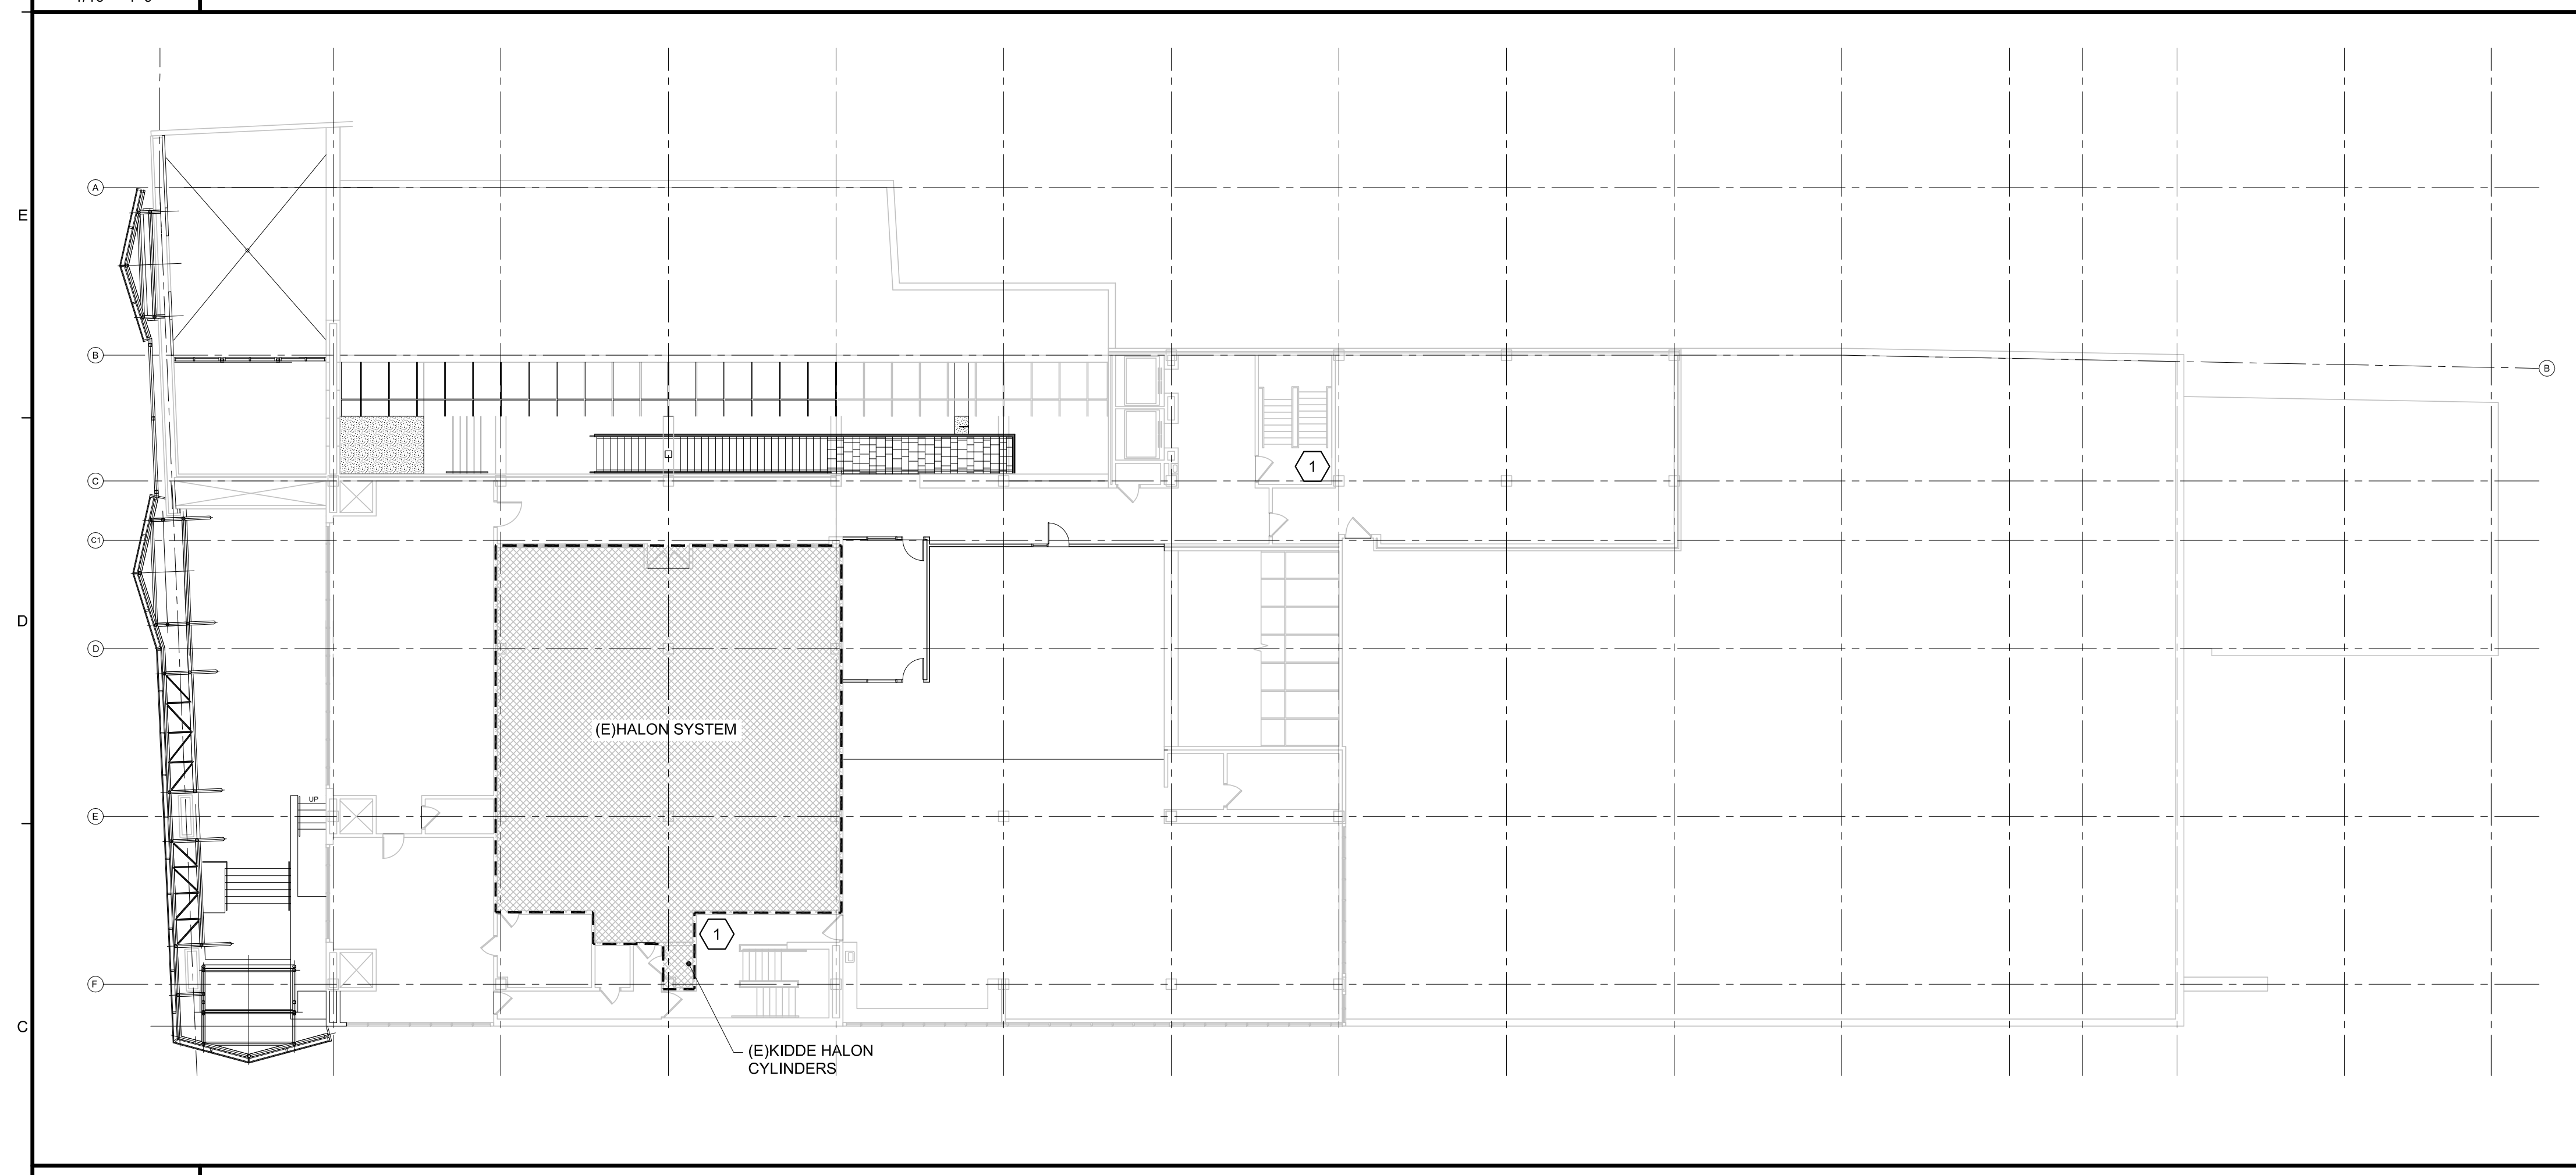

C1 FIRE PROTECTION PLAN - LEVEL 2 - PHASE II
1/16" = 1'-0"

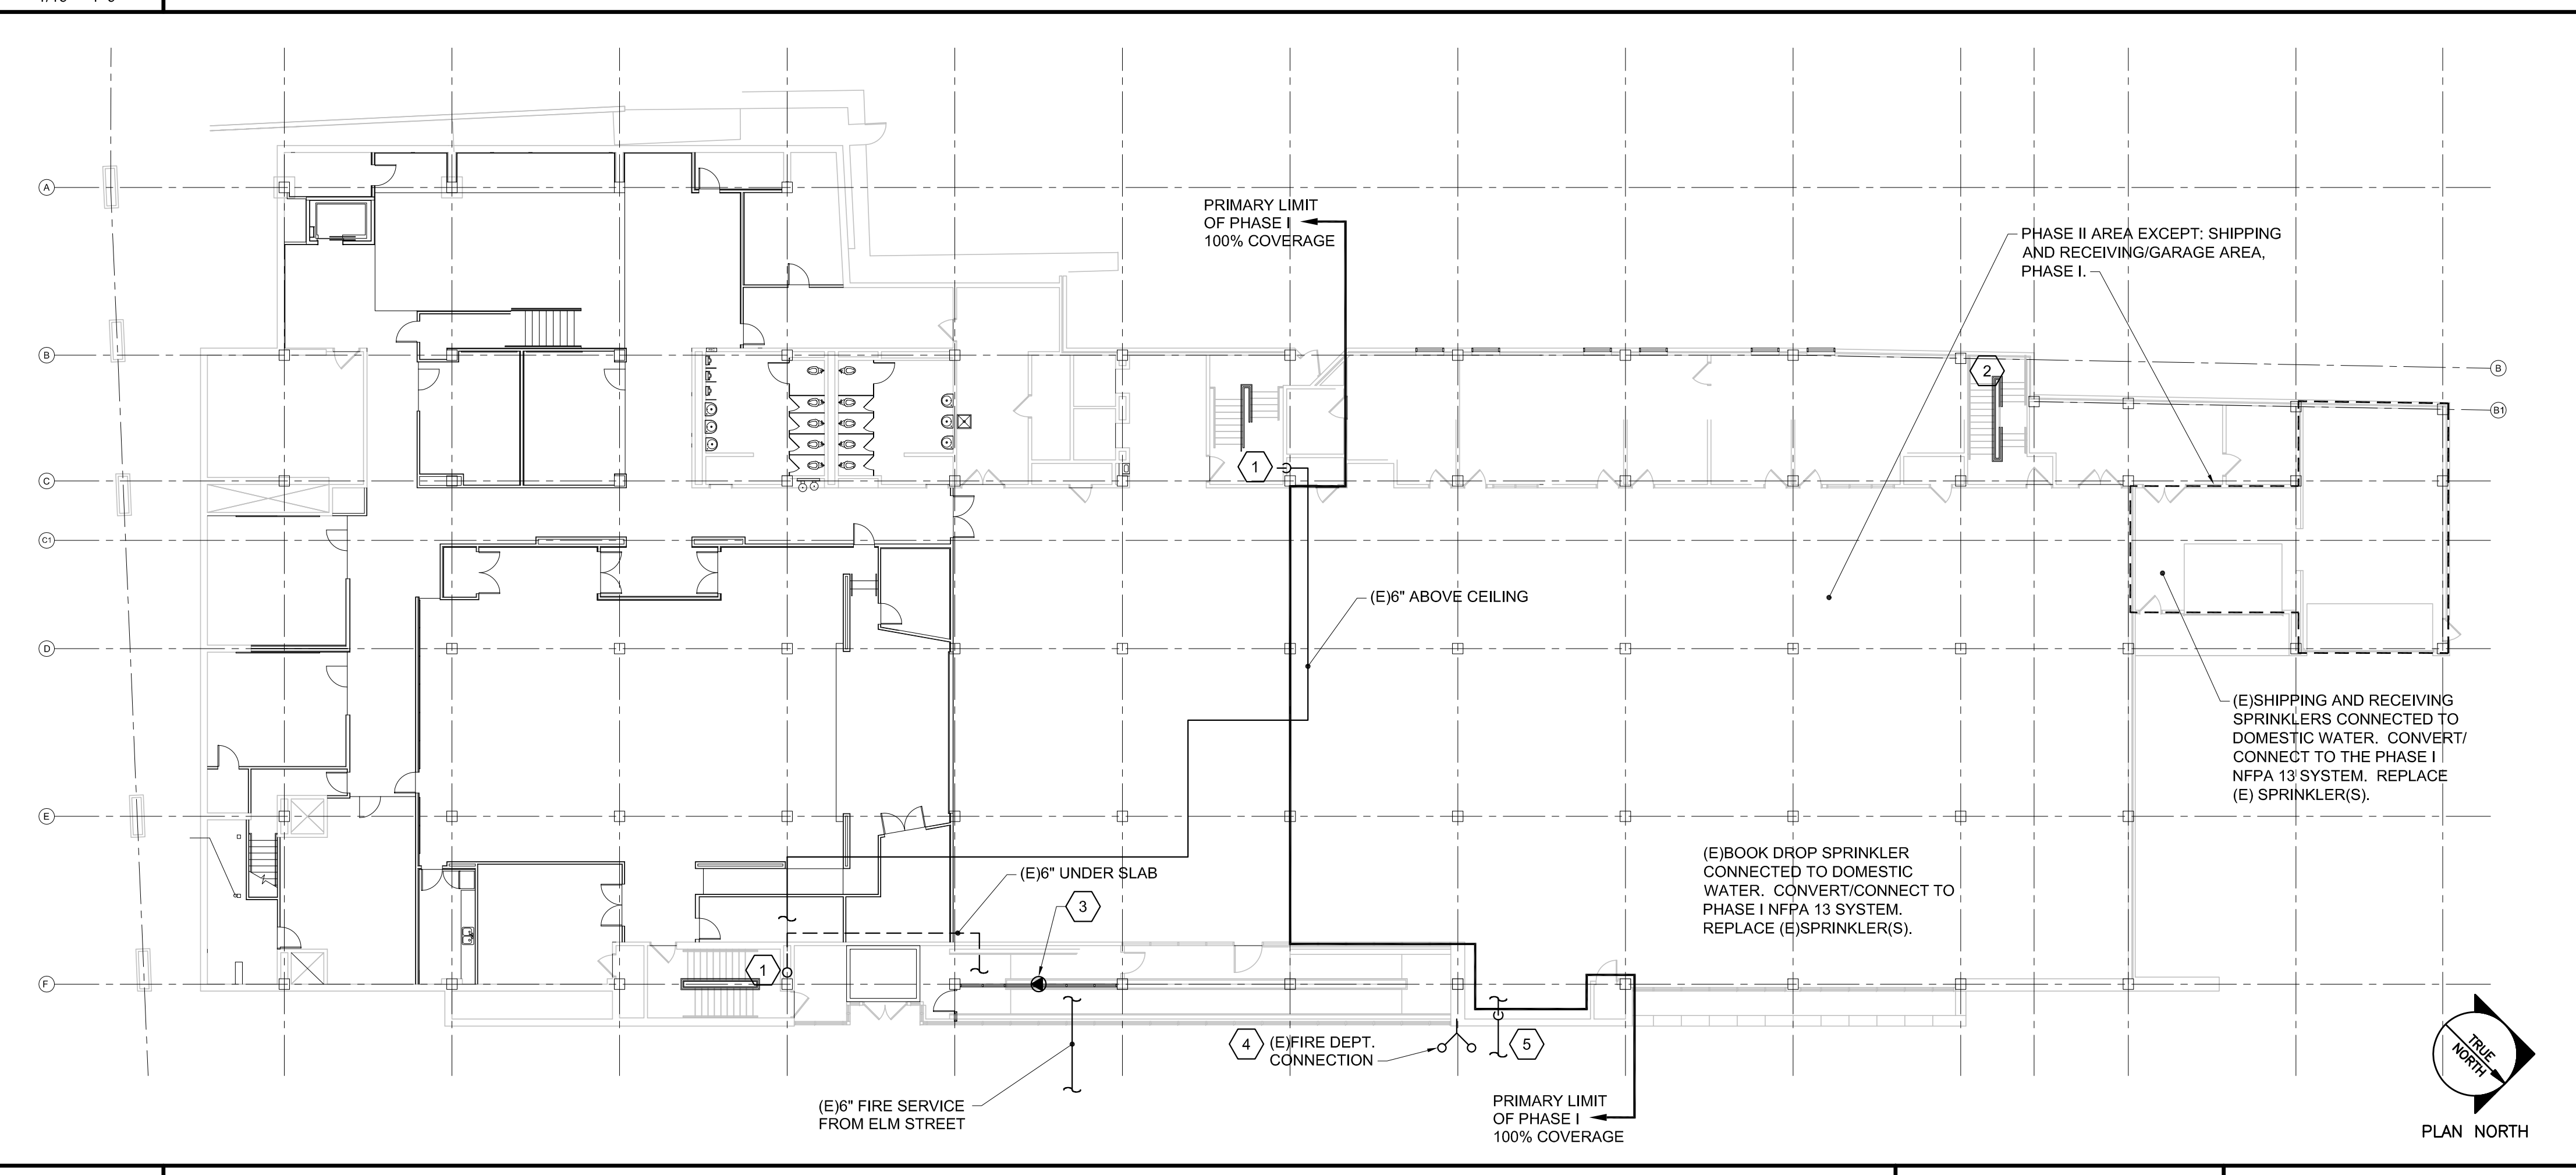

C6 FIRE PROTECTION PLAN - LOWER LEVEL - PHASE I & II
1/16" = 1'-0"

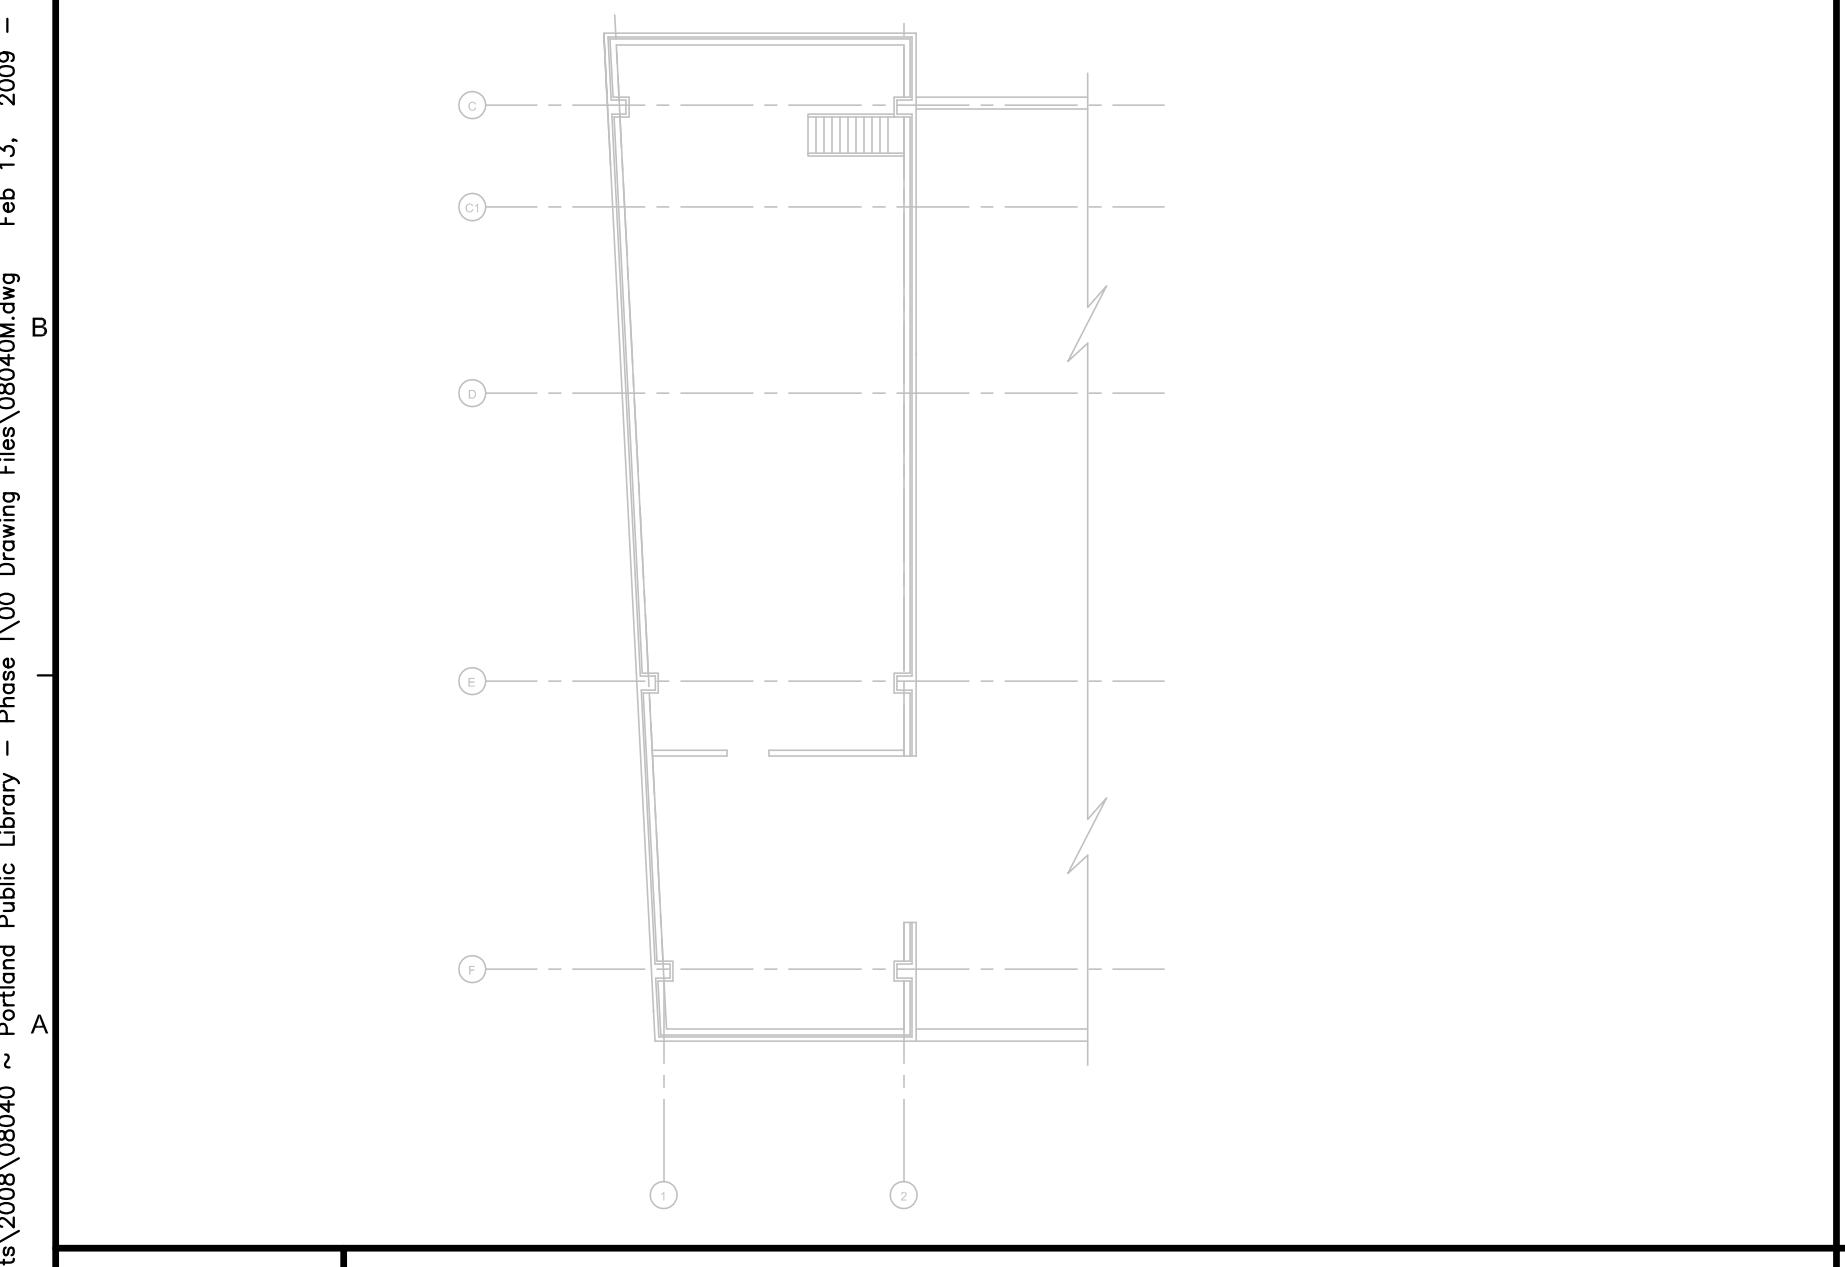

A1 FIRE PROTECTION PLAN - MECHANICAL PENTHOUSE - PHASE II
1/16" = 1'-0"



A3 -
1/16" = 1'-0"

- KEYED NOTE:**
- 1 CONVERT (E) CLASS III STANDPIPE TO A CLASS I MANUAL WET STANDPIPE.
 - 2 PROVIDE A CLASS I MANUAL WET STANDPIPE.
 - 3 REMOVE (E) AURORA MODEL No. 78-6672 ELECTRIC VERTICAL FIRE PUMP (750gpm @ 40psi)
 - 4 SERVICE/UPGRADE AS SPECIFIED.
 - 5 NFPA-13 STORZ CONNECTION.



THIS DRAWING IS THE PROPERTY OF SCOTT SIMONS ARCHITECTS AND IS NOT TO BE COPIED OR REPRODUCED IN PART OR WHOLE.



PROJECT
Portland Public Library
Renovation
PORTLAND, ME

TITLE
FIRE PROTECTION
PLANS

STATUS:
Issued for Bidding

DATE: 02-13-2009
SCALE: As Noted
PROJECT NO. 2008-0030
DRAWN BY: REW
DWG NO. FP-100

Allied Engineering
Structural Mechanical Electrical Commissioning
160 Veranda Street
Portland, Maine 04103
T: 307.221.2268
F: 307.221.2266
Web: www.allied-eng.com

Allied Project No: 08040 | Cad File: 08040M.DWG | Checked By: IAM

I:\Projects\2008\08040 - Portland Public Library - Phase I\08 Drawing Files\08040.dwg Feb 13, 2009 12:36pm